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**BAYSIDE VILLAGE - A STUDENT HOUSING COMPLEX**  
120 MARGINAL WAY  
PORTLAND, MAINE


Project No: 2006-425.BSV

Drawing Title:  
**THIRD FLOOR FRAMING PLAN**

Scale: NOTED  
Date: 09/14/2007  
Revisions:

Drawing Number:

**S1.4**

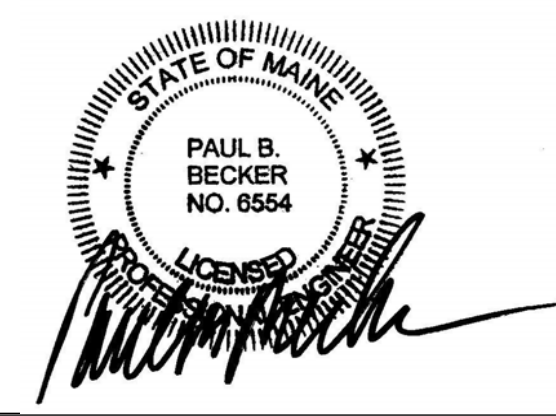

ISSUED FOR CONSTRUCTION.

HEADER SCHEDULE			
MARK	HEADER SIZE	JACK STUDS	KING STUDS
3H1	(3)2x12	(3)2x6	(2)2x6
3H2	(3)2x12	(4)2x6	(2)2x6
3H3	(2)2x8	(2)2x6	(2)2x6
3H4	(2)1 3/4x7 1/4 LVL	(3)2x6	(2)2x6
3H5	(2)1 3/4x9 1/2 LVL	(4)2x6	(3)2x6
3H6	(3)1 3/4x11 7/8 LVL	(4)2x6	(3)2x6


THIRD FLOOR BEAM SCHEDULE		
MARK	BEAM SIZE	POST (EA END, U.N.O.)
3B1	(2)1 3/4x11 7/8 LVL	SIMPSON HHUS410 JOIST HGR
3B2	(2)1 3/4x14 LVL	(2)2x6
3B3	(2)1 3/4x9 1/2 LVL	(2)2x6
3B4	(3)1 3/4x14 LVL	SEE PLAN

### THIRD FLOOR FRAMING PLAN

1/16"=1'-0"

NOTES:

- TOP OF SUBFLOOR EL 135'-2".
- INDICATES SPAN DIRECTION OF FLOOR SHEATHING.
- TYPICAL HEADER IN EXTERIOR WALL SHALL BE 3H3, U.N.O.
- G.C. RESPONSIBLE FOR COORDINATING FRAMING LAYOUT W/ MECHANICAL AND PLUMBING CHASES, DROPS, ETC. TRUSS SPACING MAY BE MODIFIED AS REQD WHILE MAINTAINING MAXIMUM TRUSS SPACING INDICATED.
- SWx INDICATES SHEARWALL. REFER TO SHEARWALL SCHEDULE FOR SHEATHING AND NAILING REQUIREMENTS.
- EXTERIOR WALLS SHALL BE SHEATHED WITH 1/2" APA RATED SHEATHING NAILED W/BD NAILS @ 4" O.C. AT PANEL EDGES, U.N.O.
- COORDINATE EXPANSION JOINT DETAILS W/ARCH.
- PROVIDE CMU LINTELS AT OPENINGS IN STAIR AND ELEVATOR SHAFTS. SEE TYP CMU DETAILS, DWG S2.1 FOR ADDL INFO.
- SP INDICATES STEEL POST. SEE DWG S1.2 FOR SIZE.

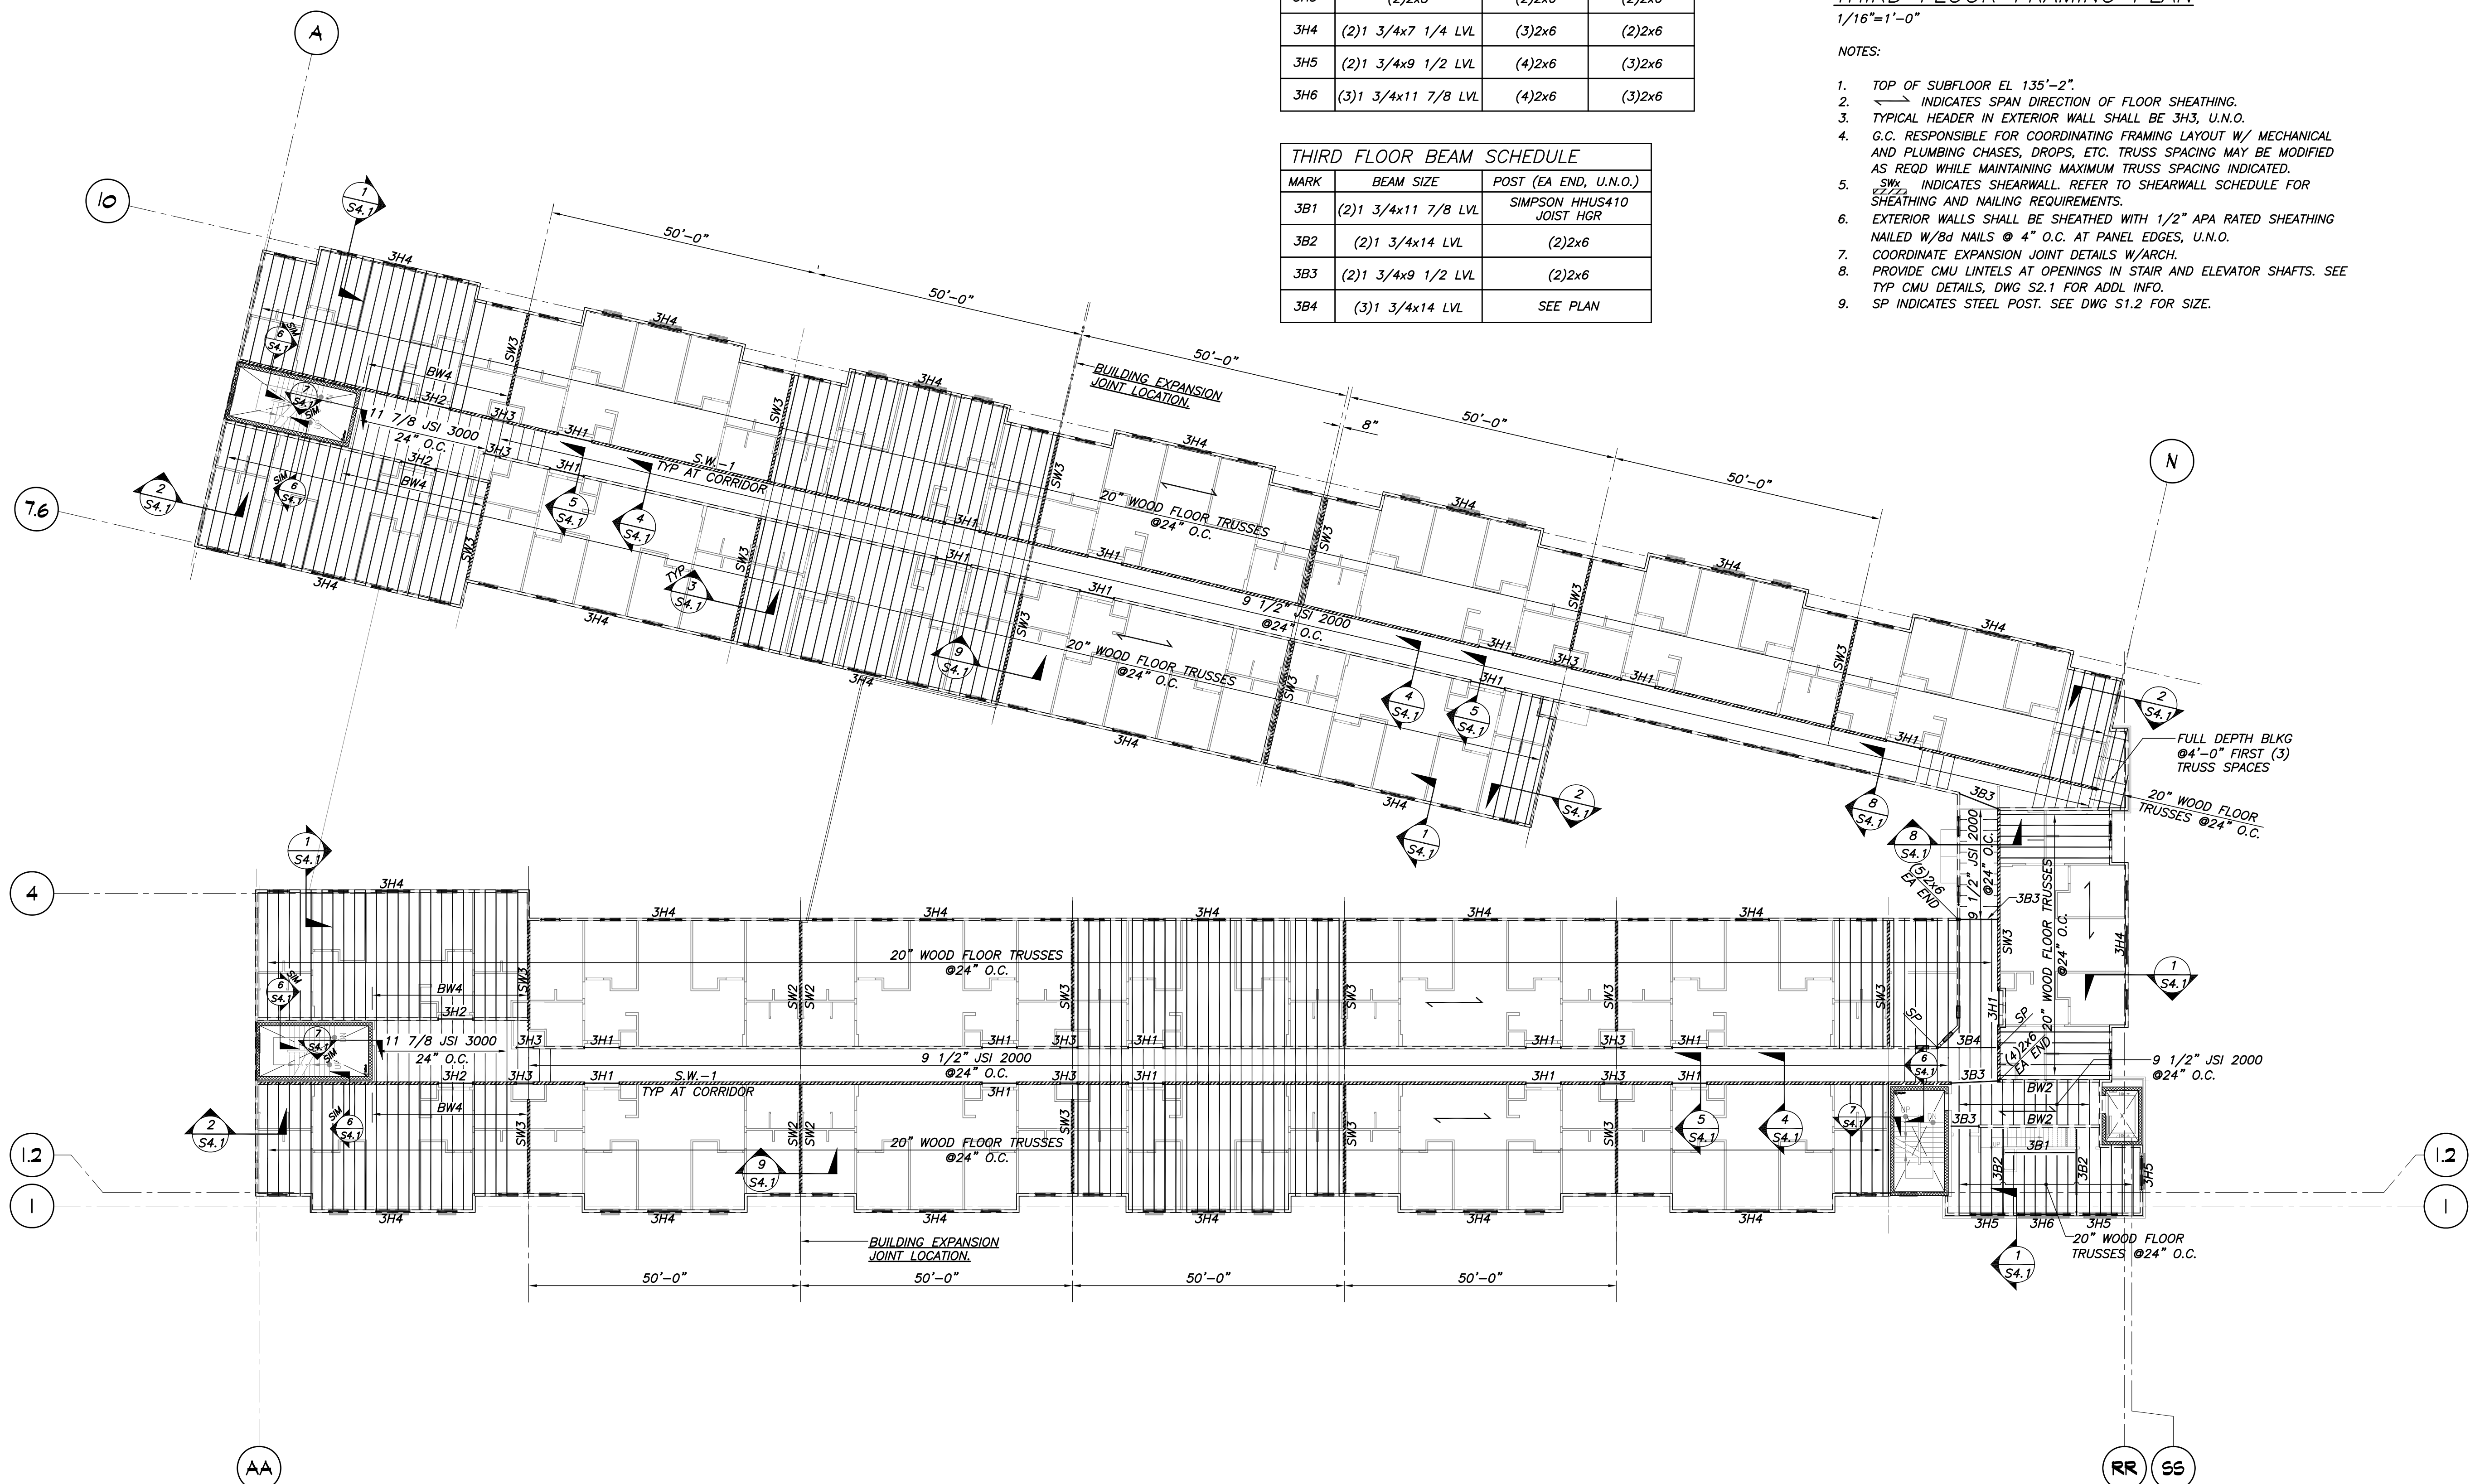

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3B1	(2)1 3/4x11 7/8 LVL	SIMPSON HHUS410 JOIST HGR
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3B4	(3)1 3/4x14 LVL	SEE PLAN