


TYPICAL ROOF ASSEMBLY:
 EPDM ROOFING MEMBRANE
 POLYISOCYANURATE INSULATION
 PLYWOOD SHEATHING
 WOOD ROOF TRUSS SYSTEM
 1/2" FURRING CHANNELS @ 16" O.C.
 5/8" TYPE 'X' GWB

TYPICAL EXTERIOR METAL PANEL SIDING:
 FIRESTONE SERIES 10 UNICORE PANEL OR EQUAL
 VERTICALLY ORIENTED HAT CHANNEL
 TYVEK BUILDING WRAP
 1/2" PLYWOOD SHEATHING
 2x6 FRAMING W/ CONT. INSULATION
 5/8" TYPE 'X' GWB

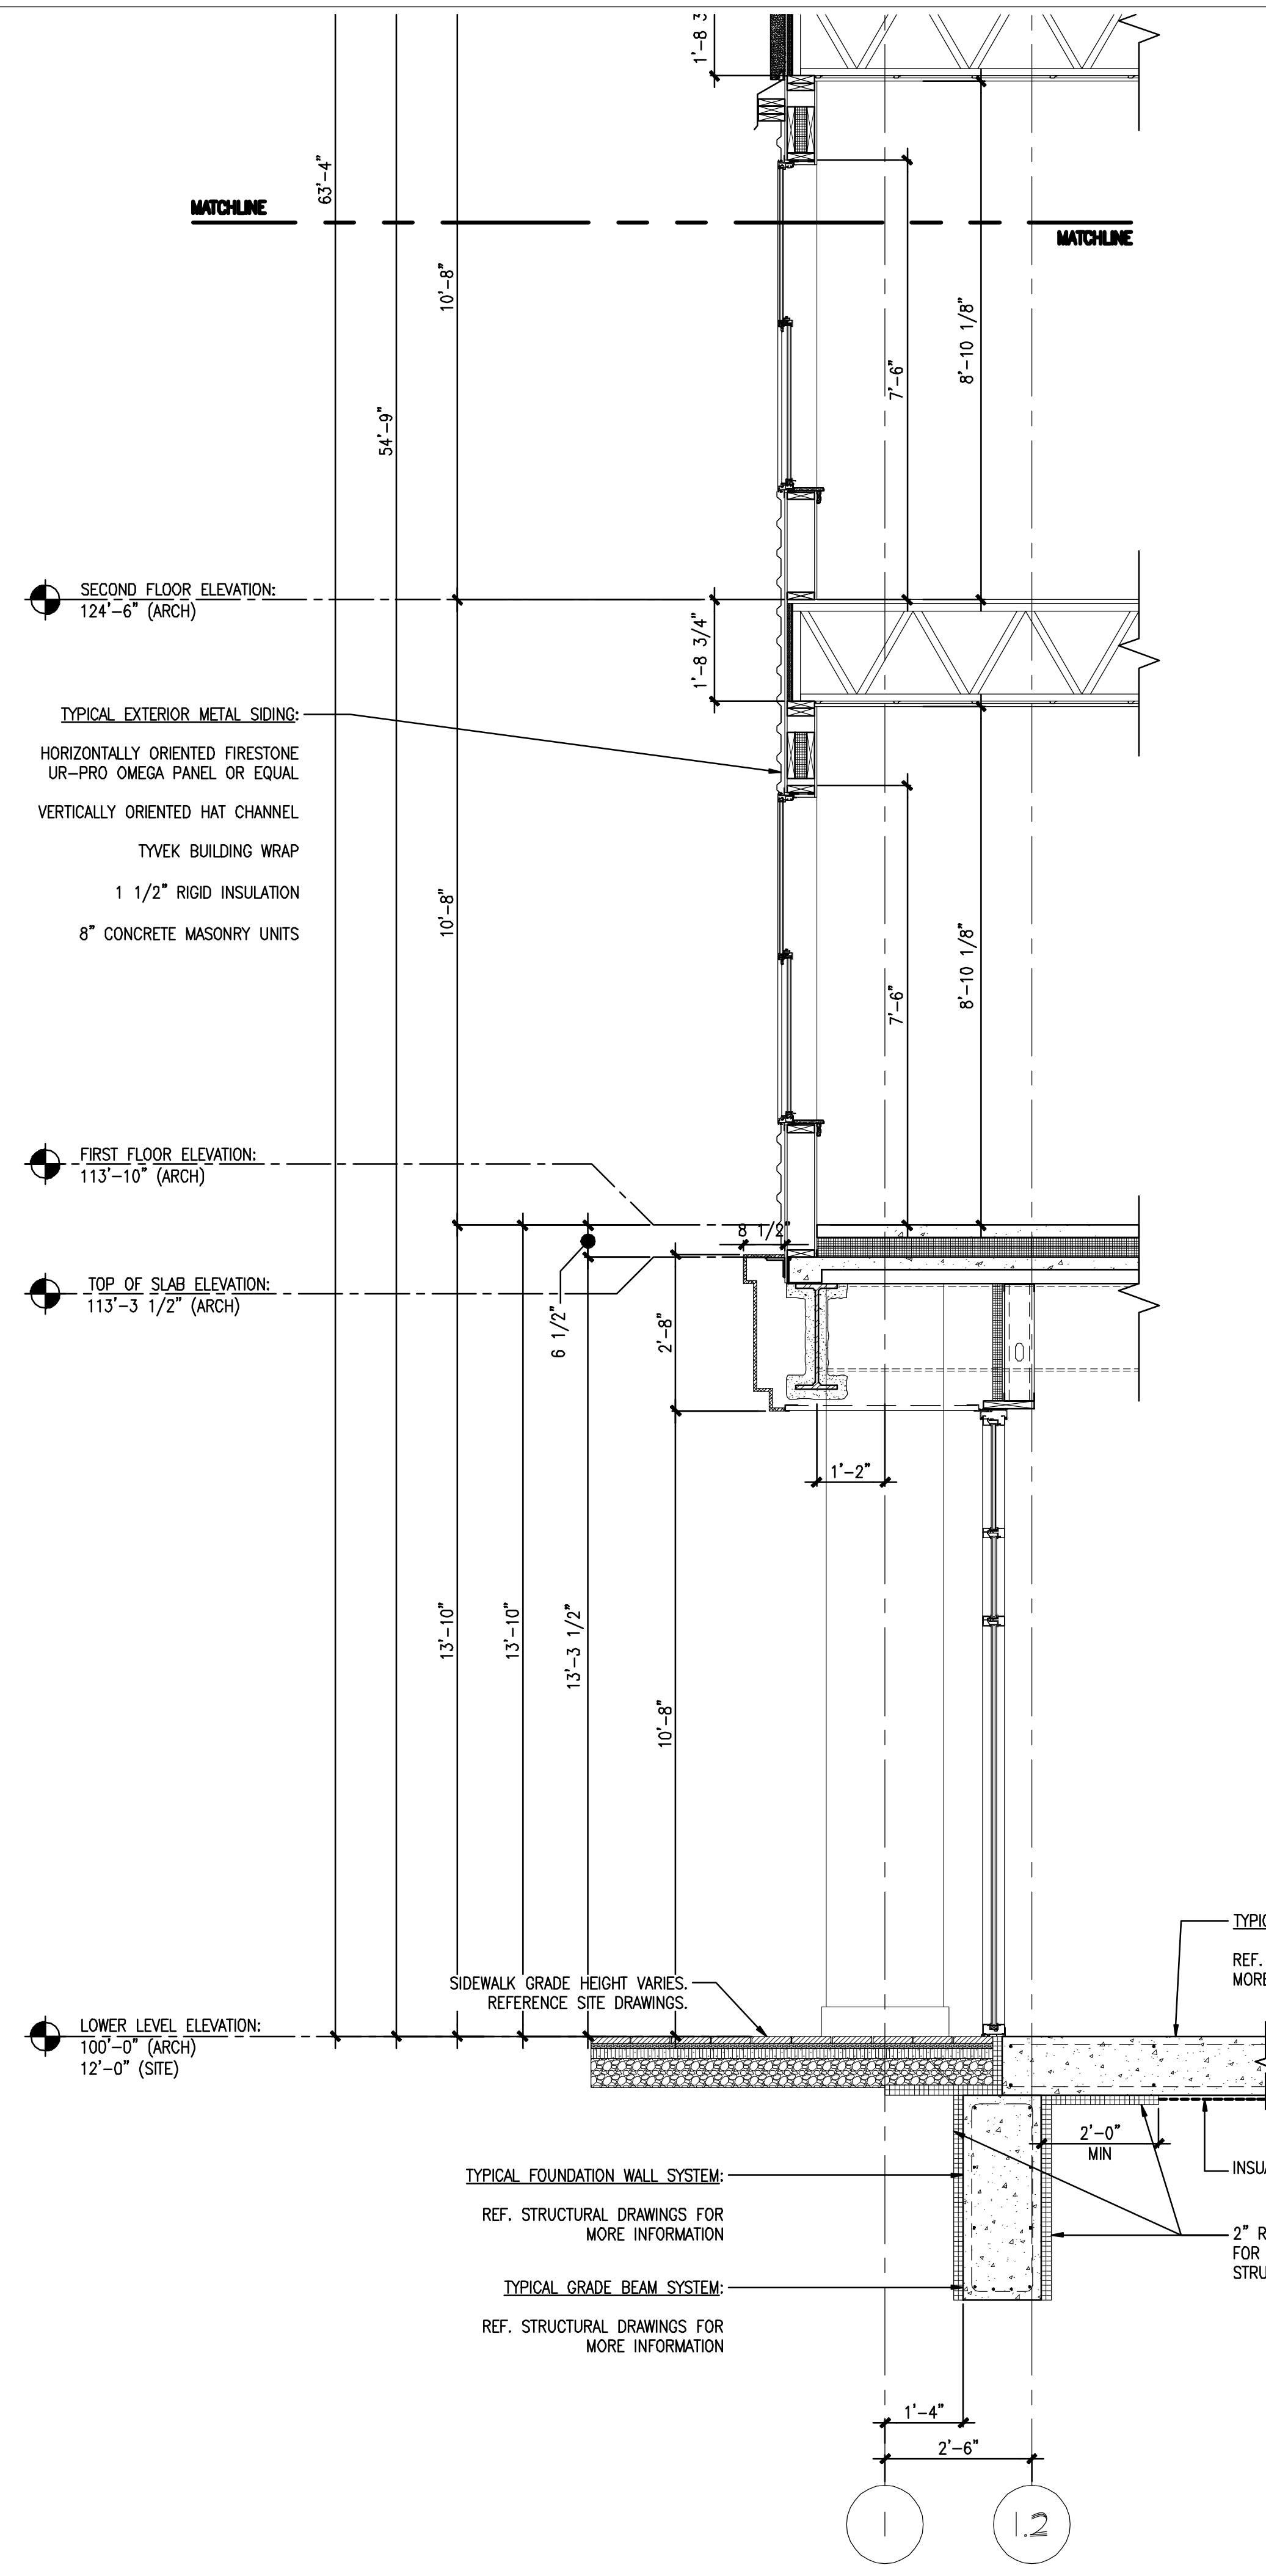

TYPICAL EXTERIOR METAL SIDING:
 HORIZONTALLY ORIENTED FIRESTONE UR-PRO OMEGA PANEL OR EQUAL
 VERTICALLY ORIENTED HAT CHANNEL
 TYVEK BUILDING WRAP
 1 1/2" RIGID INSULATION
 8" CONCRETE MASONRY UNITS

TYPICAL STRUCTURAL SLAB ASSEMBLY:
 REF. STRUCTURAL DRAWINGS FOR MORE INFORMATION

TYPICAL FOUNDATION WALL SYSTEM:
 REF. STRUCTURAL DRAWINGS FOR MORE INFORMATION

TYPICAL GRADE BEAM SYSTEM:
 REF. STRUCTURAL DRAWINGS FOR MORE INFORMATION

INSUAL-TARP AS SPECIFIED.

2" RIGID INSULATION CONTINUOUS FOR THE ENTIRE PERIMETER OF STRUCTURAL SLAB.

10 WALL SECTION
 REFERENCED FROM:

SCALE: 1/2" = 1'-0"

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 PORTLAND, MAINE

Project No: 2006-432/BVP
 Drawing Title: **WALL SECTION**

Scale: 1/2" = 1'-0"
 Date: SEPTEMBER 14, 2007
 Revisions:

Drawing Number: **A6.10**