


TYPICAL ROOF ASSEMBLY:
 EPDM ROOFING MEMBRANE
 POLYSOCYANURATE INSULATION
 PLYWOOD SHEATHING
 WOOD ROOF TRUSS SYSTEM
 1/2" FURRING CHANNELS @ 16"
 5/8" TYPE 'X' GWB

TYPICAL EXTERIOR METAL PANEL SIDING:
 FIRESTONE SERIES 10 UNICORE PANEL OR EQUAL
 VERTICALLY ORIENTED HAT CHANNEL
 TYVEK BUILDING WRAP
 1/2" PLYWOOD SHEATHING
 2x6 FRAMING W/ CONT. INSULATION
 5/8" TYPE 'X' GWB

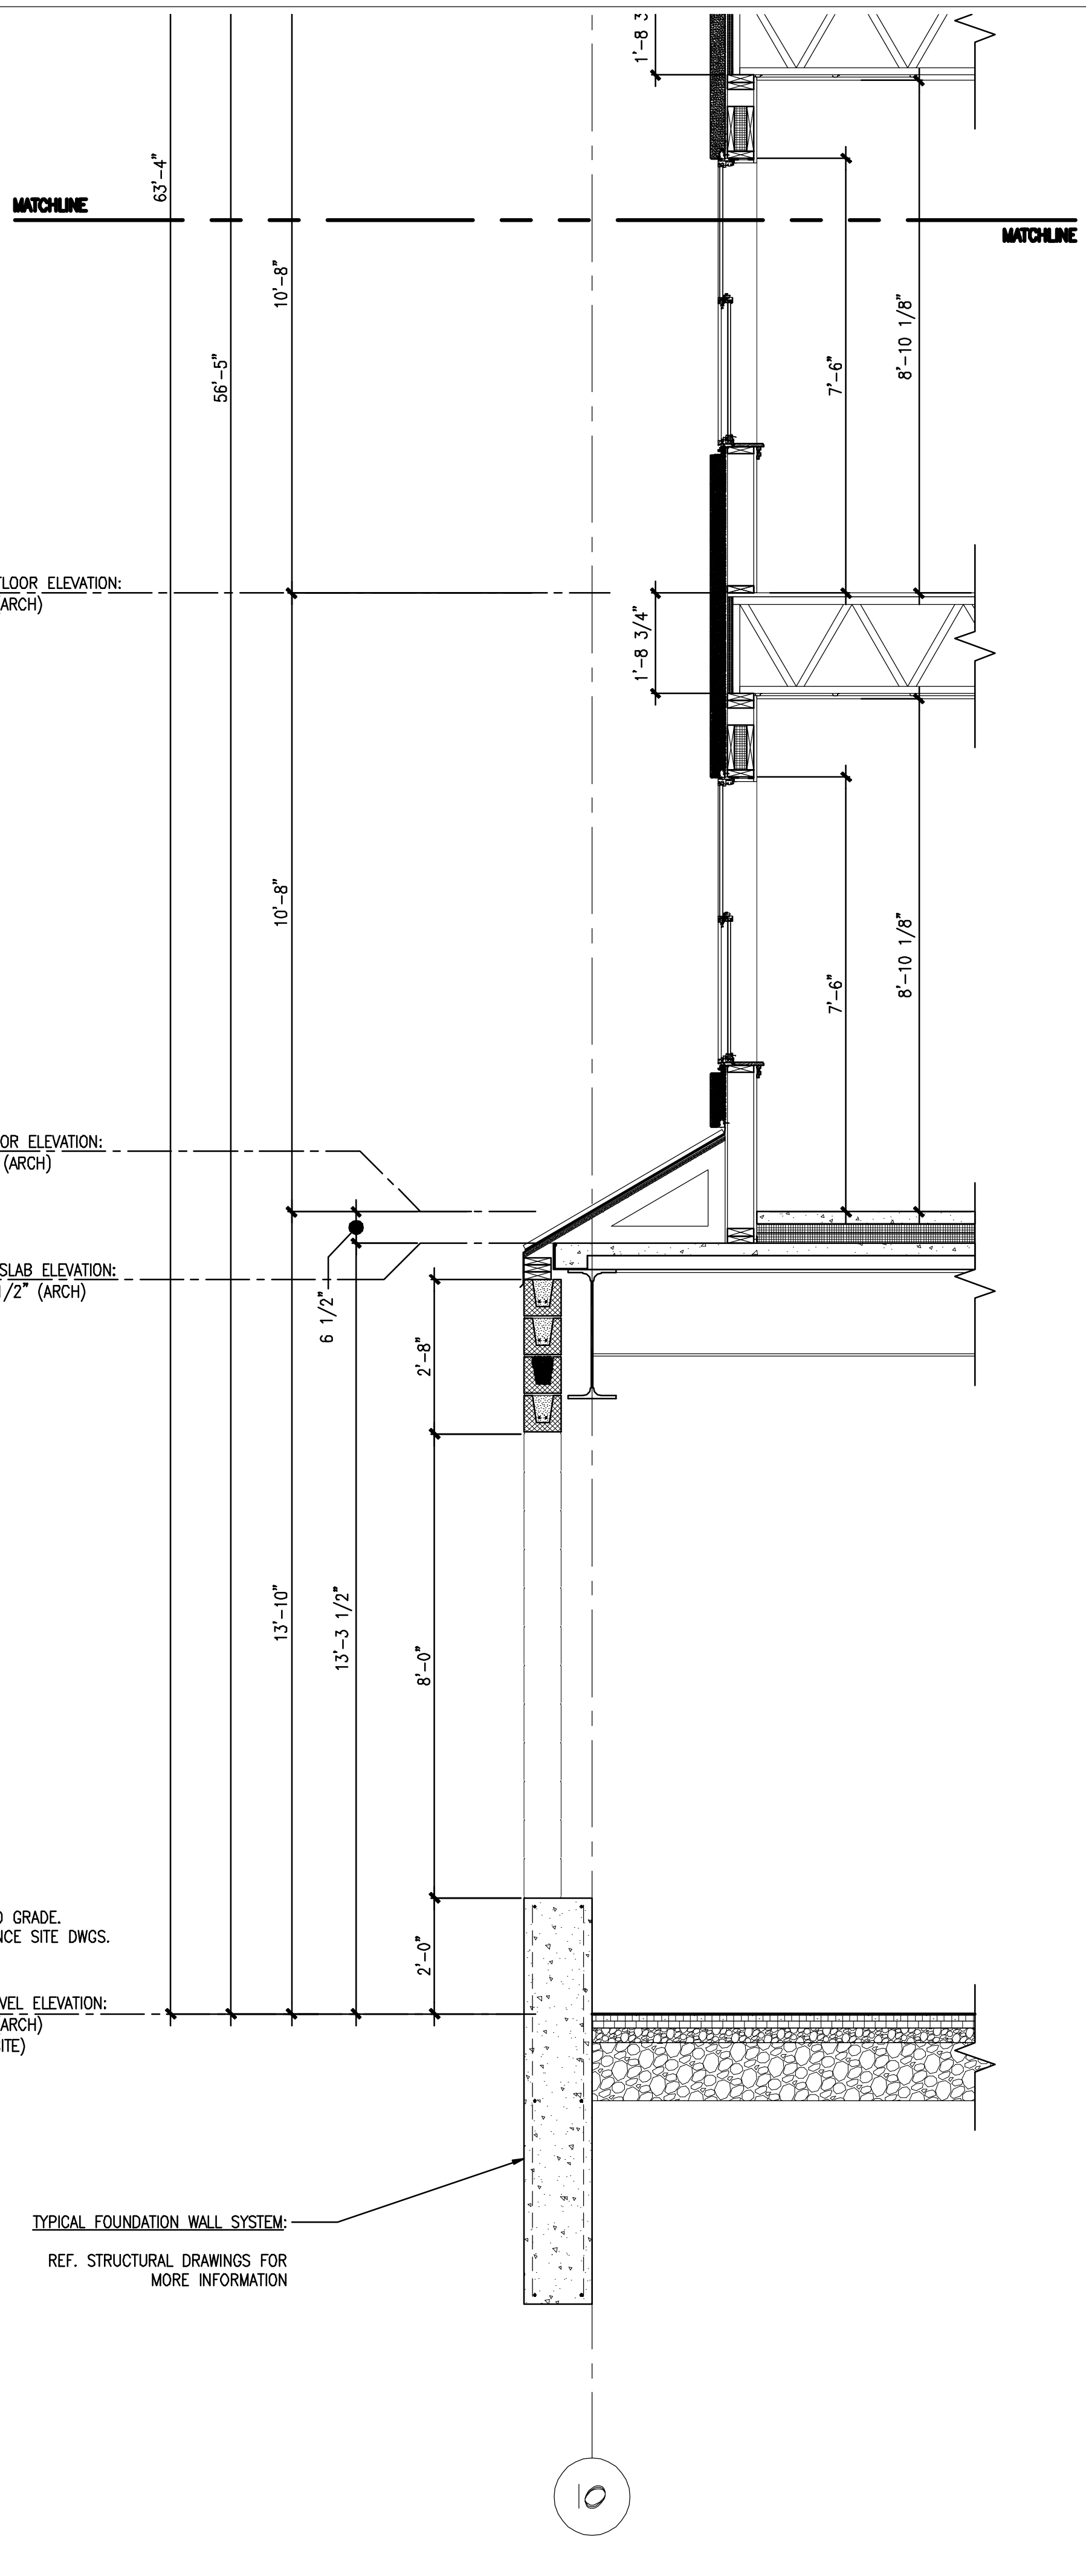

SECOND FLOOR ELEVATION:
 124'-6" (ARCH)

FIRST FLOOR ELEVATION:
 113'-10" (ARCH)

TOP OF SLAB ELEVATION:
 113'-3 1/2" (ARCH)

LOWER LEVEL ELEVATION:
 100'-0" (ARCH)
 12'-0" (SITE)


FINISHED GRADE.
 REFERENCE SITE DWGS.

TYPICAL FOUNDATION WALL SYSTEM:
 REF. STRUCTURAL DRAWINGS FOR MORE INFORMATION

2 WALL SECTION
 REFERENCED FROM:

SCALE: 1/2" = 1'-0"

CWS Architects
 Architecture
 Space Planning
 Value Design
 434 Cumberland Avenue
 Portland, ME 04101
 Phone: (207) 774-4441
 Fax: (207) 774-4016
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Owner: **SOUTHERN MAINE STUDENT HOUSING LLC**
 247 COMMERCIAL STREET
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 131 PRESUMPSCOT STREET
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 TEL: (207) 874-2323
 FAX: (207) 874-2727

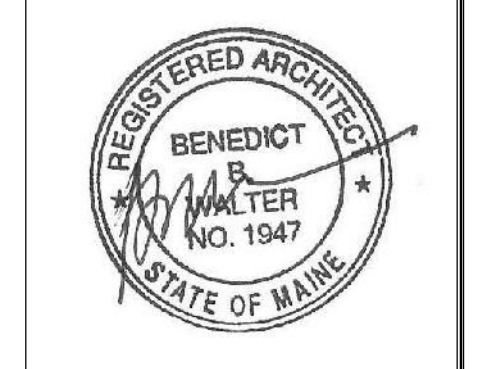BAYSIDE VILLAGE - A STUDENT HOUSING COMPLEX
 132 MARGINAL WAY
 PORTLAND, MAINE

Project No: 2006-432.BVP

Drawing Title:
WALL SECTION

Scale: 1/2" = 1'-0"
 Date: SEPTEMBER 14, 2007

- Revisions:
- △
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Drawing Number:
A6.02