




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BAYSIDE VILLAGE - A STUDENT HOUSING COMPLEX

132 MARGINAL WAY
PORTLAND, MAINE

Project No: 2006-432.BVP

Drawing Title:
ENLARGED PLAN - ROOF - AREA A

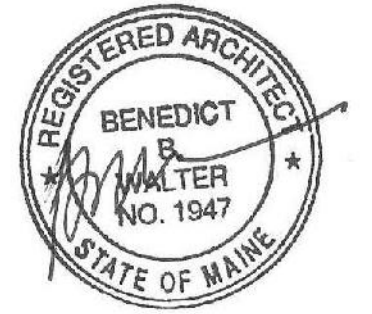
Scale: 1/8" = 1'-0"
Date: SEPTEMBER 14, 2007

Revisions:

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Drawing Number:


A1.R1

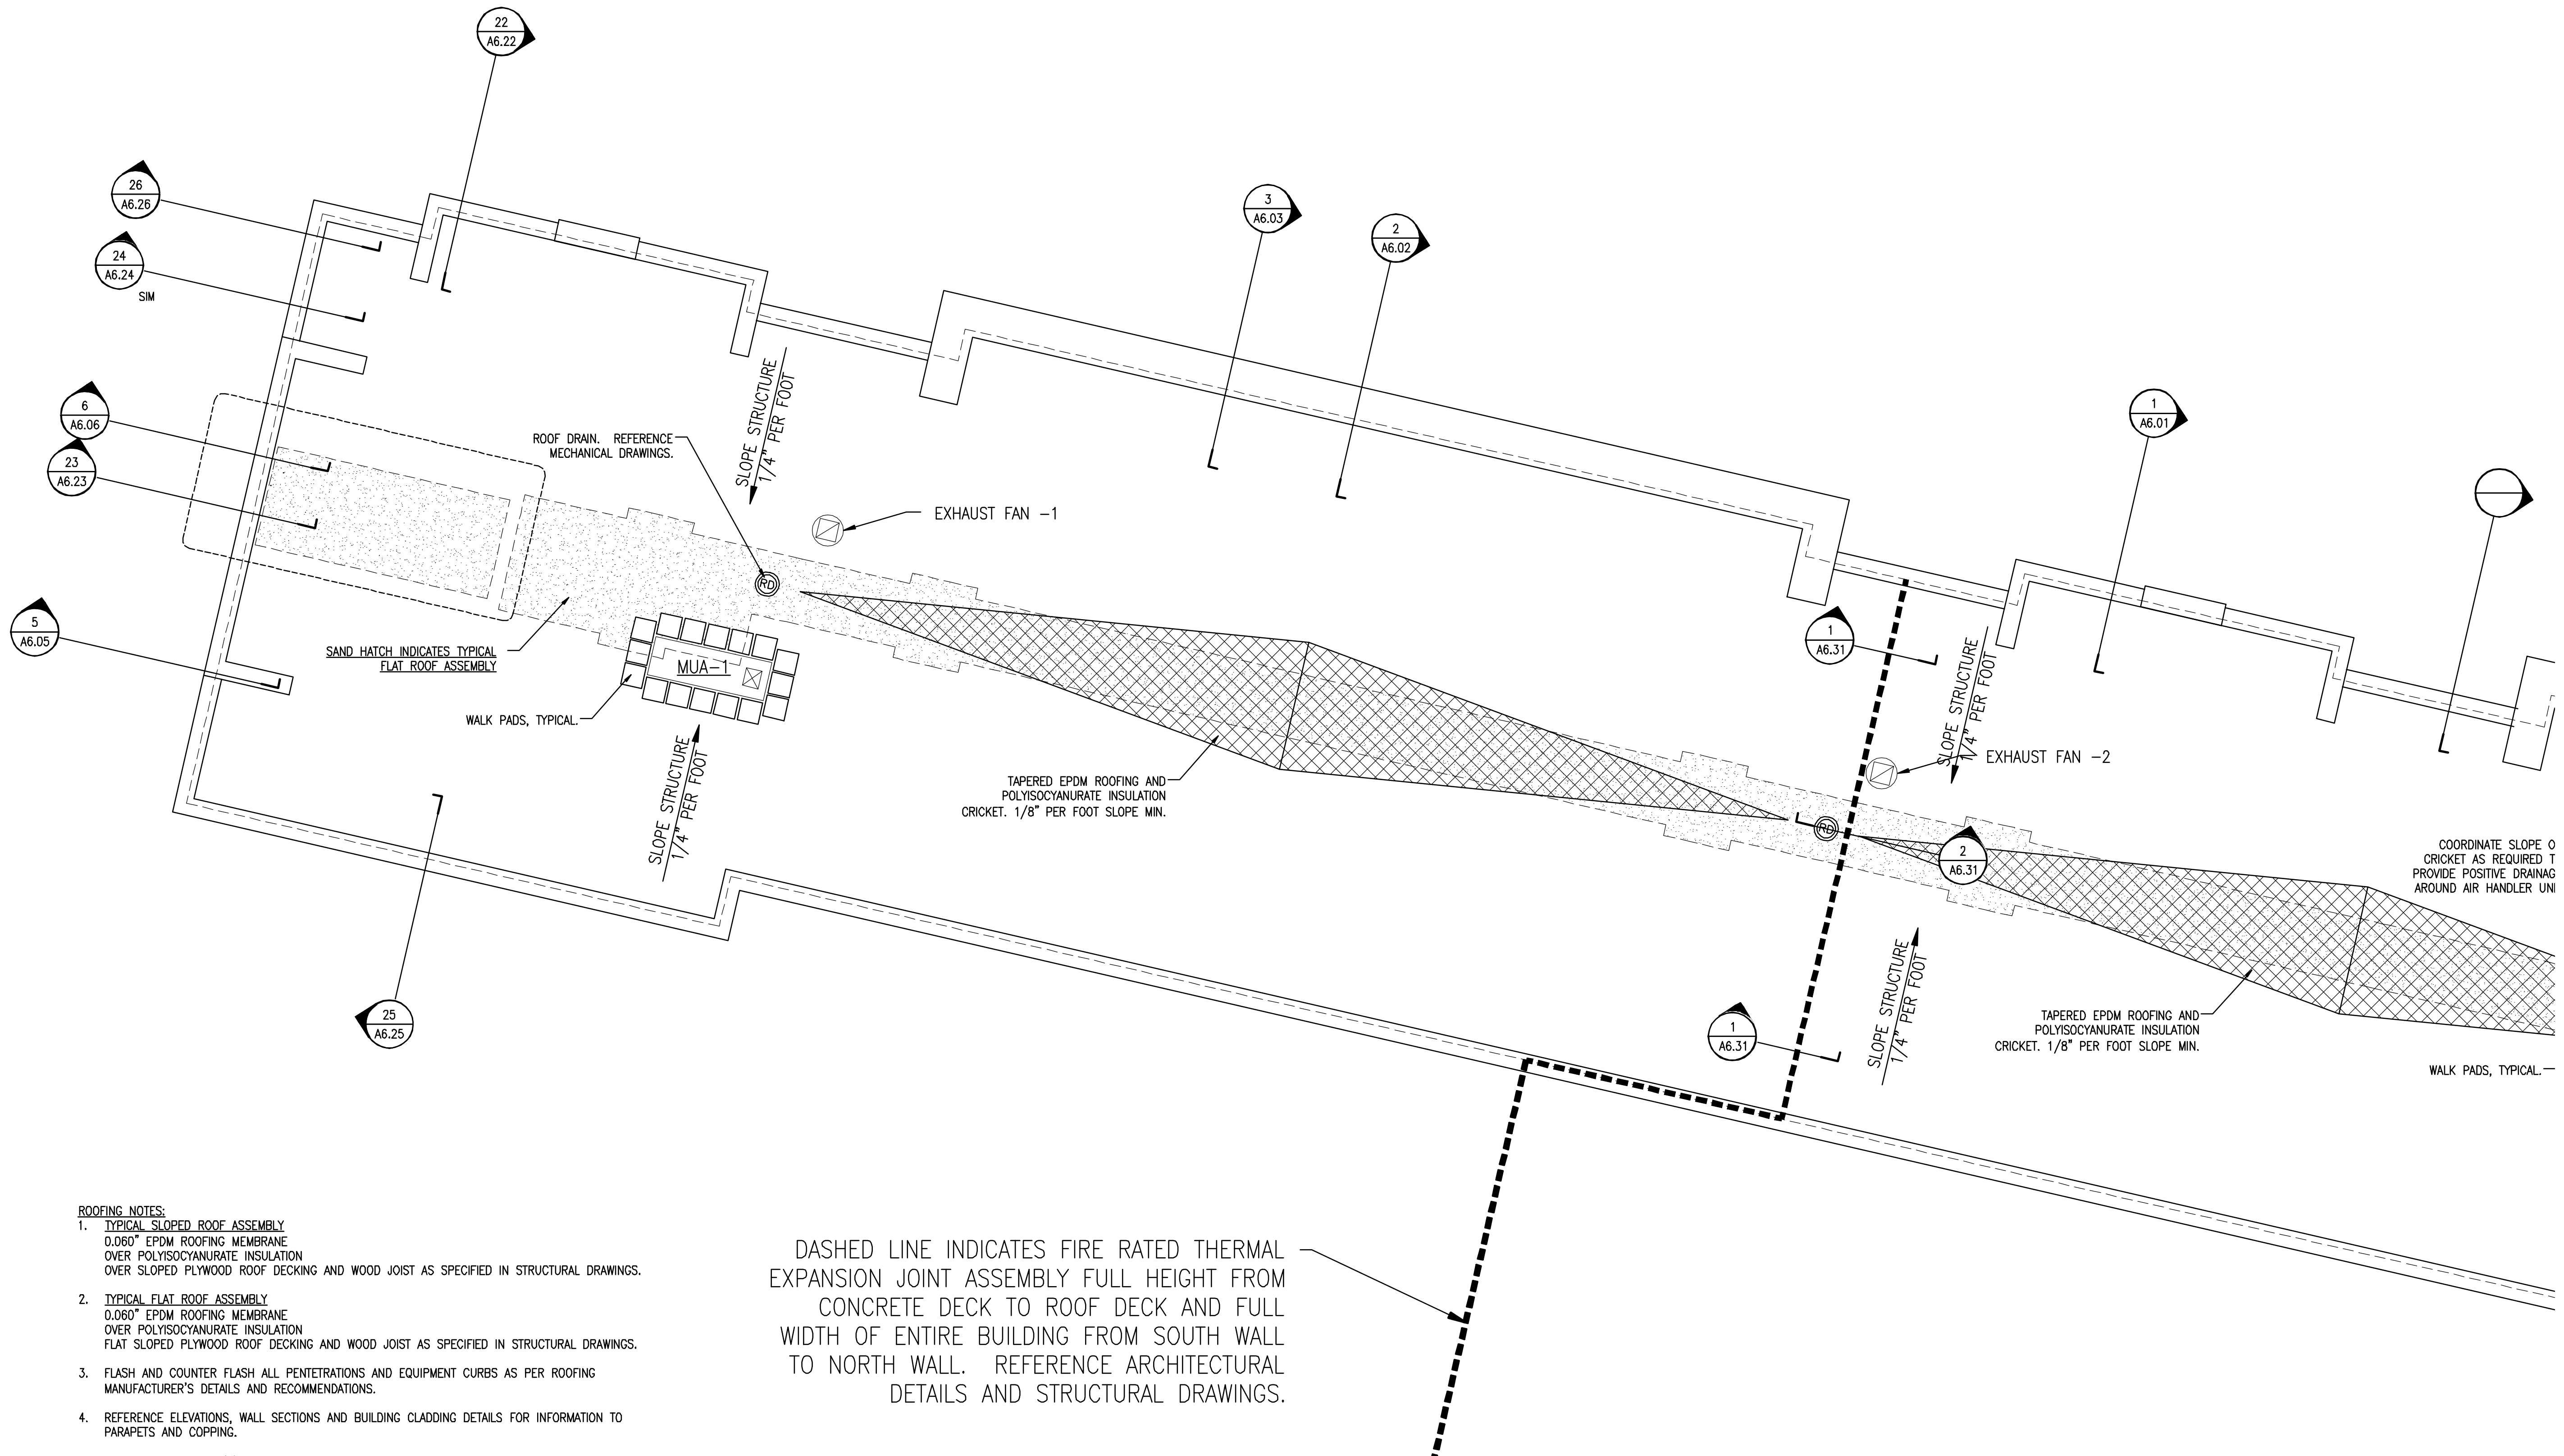

ROOFING NOTES:

1. TYPICAL SLOPED ROOF ASSEMBLY
0.060" EPDM ROOFING MEMBRANE
OVER POLYISOCYANURATE INSULATION
OVER SLOPED PLYWOOD ROOF DECKING AND WOOD JOIST AS SPECIFIED IN STRUCTURAL DRAWINGS.
2. TYPICAL FLAT ROOF ASSEMBLY
0.060" EPDM ROOFING MEMBRANE
OVER POLYISOCYANURATE INSULATION
FLAT SLOPED PLYWOOD ROOF DECKING AND WOOD JOIST AS SPECIFIED IN STRUCTURAL DRAWINGS.
3. FLASH AND COUNTER FLASH ALL PENETRATIONS AND EQUIPMENT CURBS AS PER ROOFING MANUFACTURER'S DETAILS AND RECOMMENDATIONS.
4. REFERENCE ELEVATIONS, WALL SECTIONS AND BUILDING CLADDING DETAILS FOR INFORMATION TO PARAPETS AND COPPING.
5. COORDINATE LOCATION(S) OF ROOF PENETRATIONS ASSOCIATED WITH MECHANICAL EQUIPMENT, PIPING, ETC. WITH ROOF FRAMING BELOW SUCH AS TO ELIMINATE THE NEED TO FOR CUTTING OF ROOF JOIST.
6. CONTACT ARCHITECT/STRUCTURAL ENGINEER PRIOR TO CUTTING OF ROOF FRAMING IF CUTTING OF STRUCTURAL FRAMING IS NECESSARY.

DASHED LINE INDICATES FIRE RATED THERMAL EXPANSION JOINT ASSEMBLY FULL HEIGHT FROM CONCRETE DECK TO ROOF DECK AND FULL WIDTH OF ENTIRE BUILDING FROM SOUTH WALL TO NORTH WALL. REFERENCE ARCHITECTURAL DETAILS AND STRUCTURAL DRAWINGS.

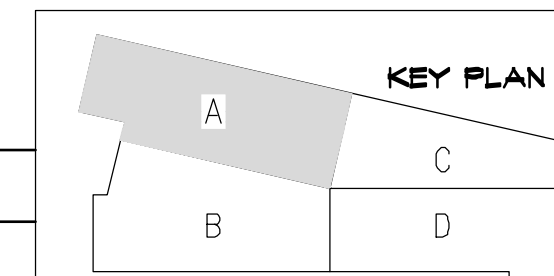

A ENLARGED PLAN - ROOF AREA A

REFERENCED FROM:

SCALE: 1/8" = 1'-0"

ISSUED FOR CONSTRUCTION