



FRONT ELEVATION  
1/4" = 1'-0"

CONSTRUCTION NOTE:  
CONTRACTOR IS TO VERIFY GRADE AND ALL DIMENSIONS IN FIELD BEFORE CONSTRUCTION. DESIGN SHOWN MAY DIFFER FROM ACTUAL FINISHED CONSTRUCTION. FINAL MATERIALS, WINDOW/DOOR SIZES, AND OR LOCAL CODES.

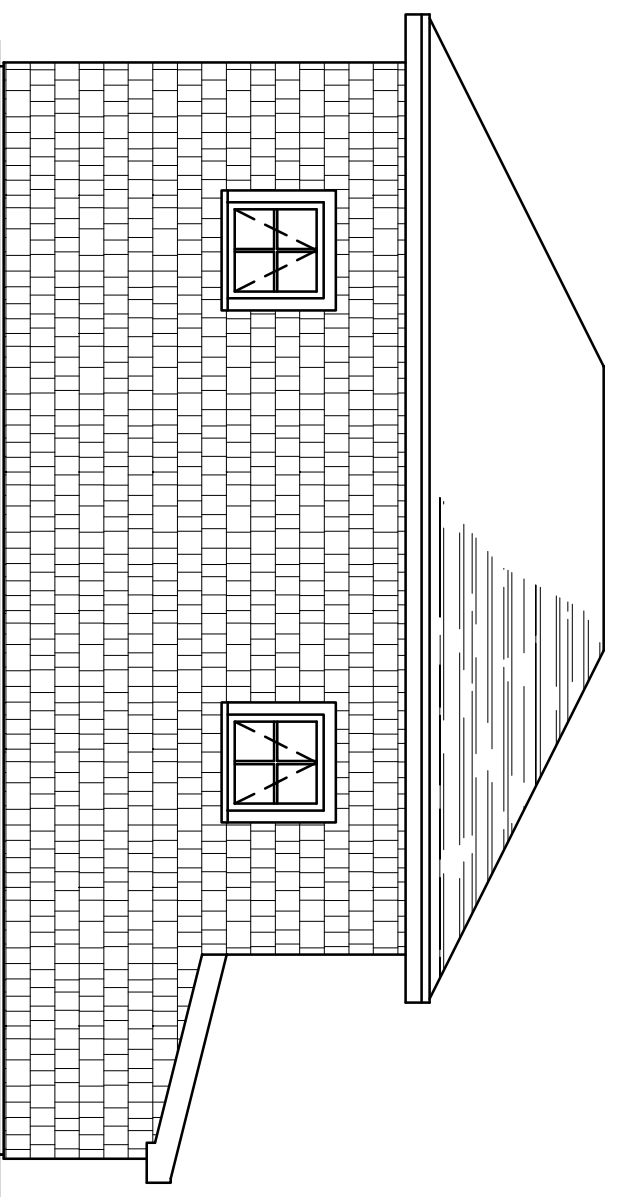


RIGHT ELEVATION  
1/4" = 1'-0"

CONSTRUCTION NOTE:  
CONTRACTOR IS TO VERIFY GRADE AND ALL DIMENSIONS IN FIELD BEFORE CONSTRUCTION. DESIGN SHOWN MAY DIFFER FROM ACTUAL FINISHED CONSTRUCTION. FINAL MATERIALS, WINDOW/DOOR SIZES, AND OR LOCAL CODES.

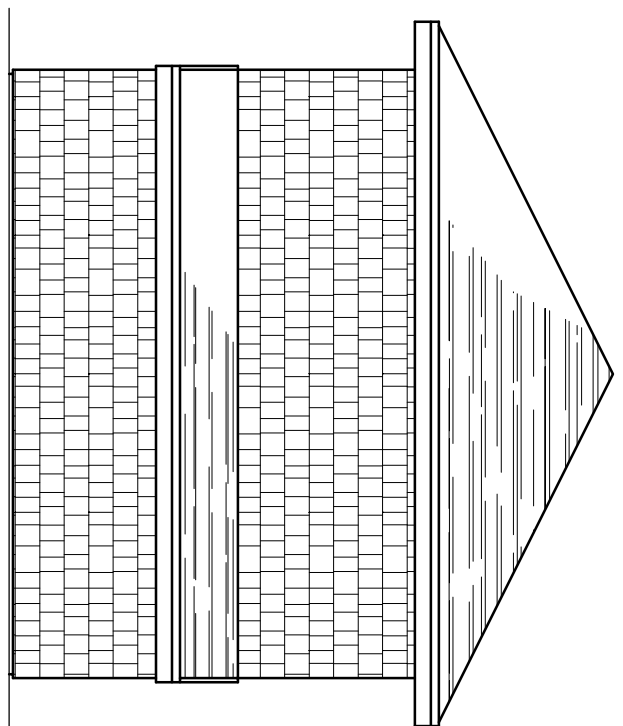


FRONT ELEVATION  
1/4" = 1'-0"

CONSTRUCTION NOTE:  
CONTRACTOR IS TO VERIFY GRADE AND ALL DIMENSIONS IN FIELD BEFORE CONSTRUCTION. DESIGN SHOWN MAY DIFFER FROM ACTUAL FINISHED CONSTRUCTION. FINAL MATERIALS, WINDOW/DOOR SIZES, AND OR LOCAL CODES.

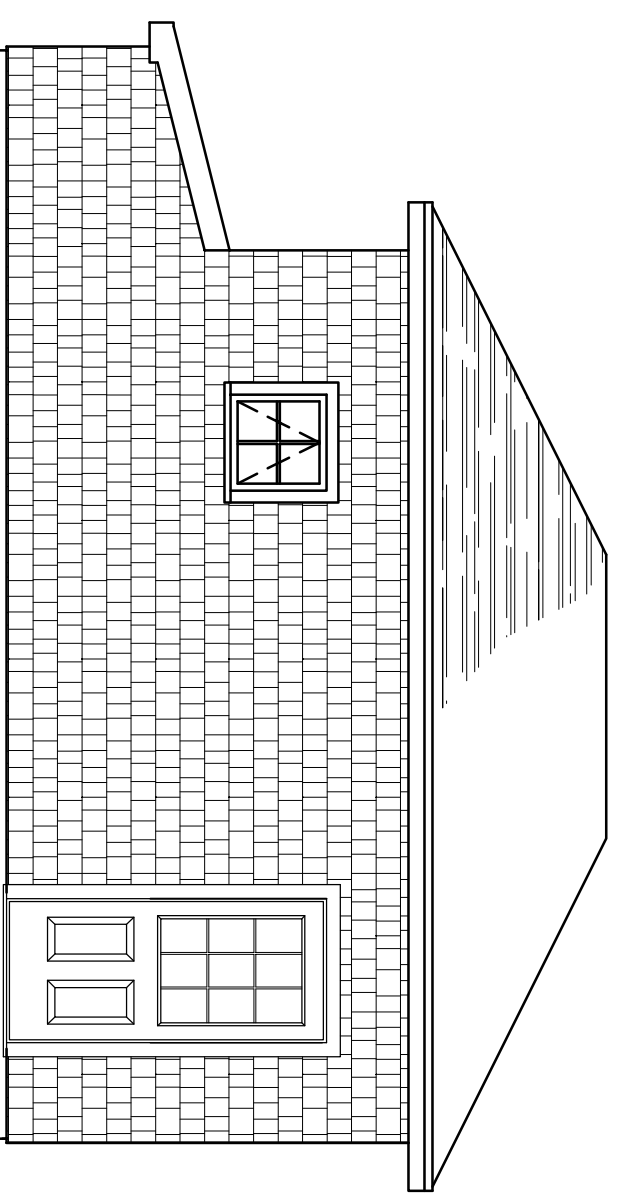

LEFT ELEVATION  
1/4" = 1'-0"

CONSTRUCTION NOTE:  
CONTRACTOR IS TO VERIFY GRADE AND ALL DIMENSIONS IN FIELD BEFORE CONSTRUCTION. DESIGN SHOWN MAY DIFFER FROM ACTUAL FINISHED CONSTRUCTION. FINAL MATERIALS, WINDOW/DOOR SIZES, AND OR LOCAL CODES.

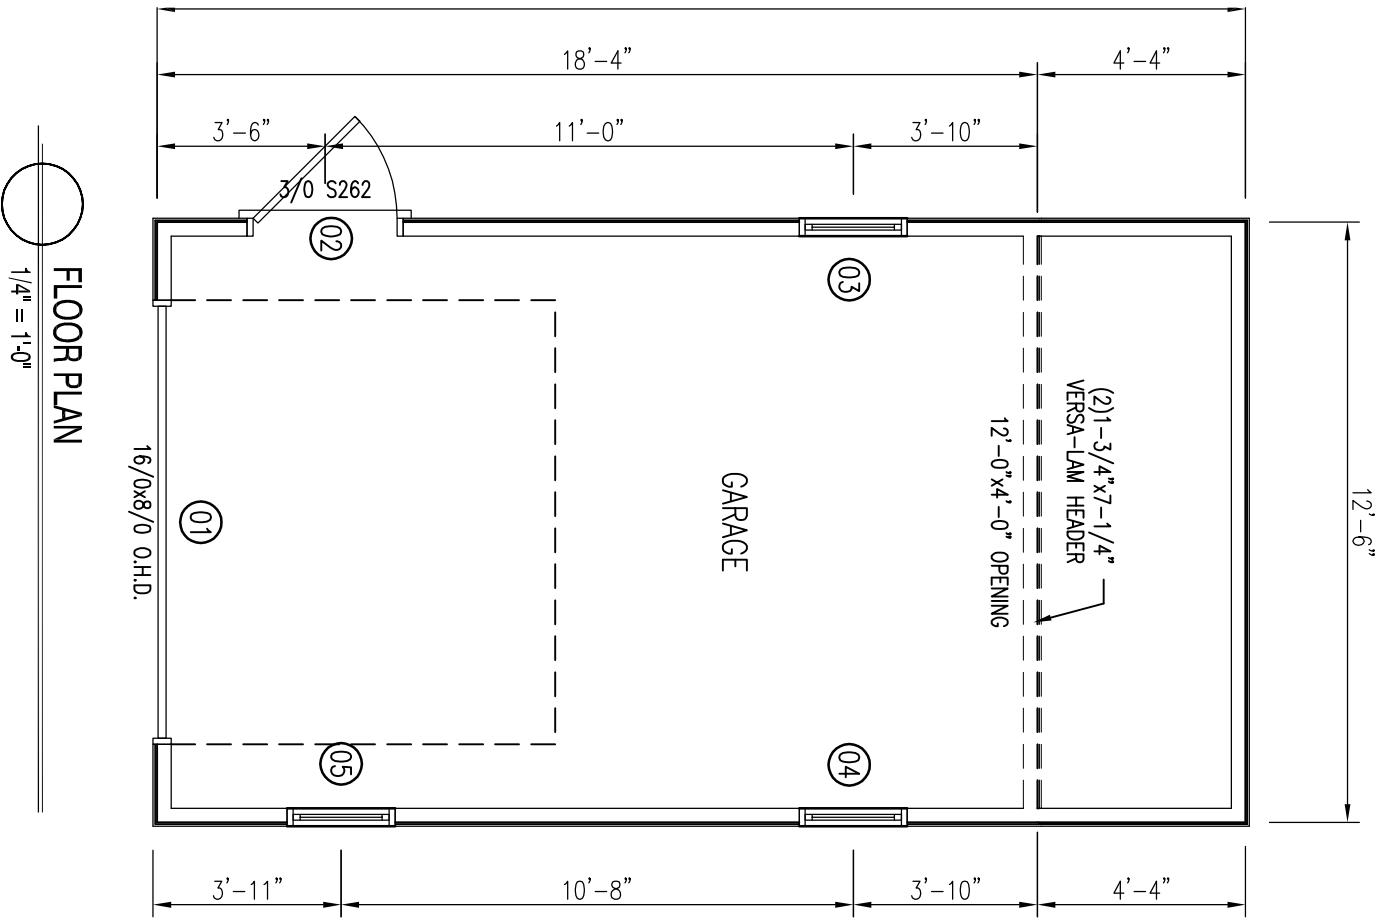


FLOOR PLAN  
1/4" = 1'-0"


DOOR #	SIZE	LABEL	HEADER	NOTES
01	3'-6" X 6'-0"	DOOR	STEEL W/ 2" X 4" SILL	VERIFY TO SILL
02	3'-0" X 6'-0"	WINDOW	STEEL W/ 2" X 4" SILL	VERIFY TO SILL
03	2'-0" X 2'-0"	WINDOW	STEEL W/ 2" X 4" SILL	VERIFY TO SILL
04	2'-0" X 2'-0"	WINDOW	STEEL W/ 2" X 4" SILL	VERIFY TO SILL
05	2'-0" X 2'-0"	WINDOW	STEEL W/ 2" X 4" SILL	VERIFY TO SILL

PRODUCT TYPE:	U-FACTOR	WITHOUT GLASS U-F
HANCOCK CLASSIC WINDOWS W/RC CERTIFIED UNIT PERFORMANCE		
CAJACENT	0.31	0.31
STANDARD DOUBLE-HUNG	0.35	0.35
PREMIUM DOUBLE-HUNG	0.46	0.46
TRANSOM	0.34	0.34
AWNING	0.31	0.31
GLIDER	0.33	0.33


CONSTRUCTION NOTE:  
CONTRACTOR IS TO VERIFY GRADE AND ALL DIMENSIONS IN FIELD BEFORE CONSTRUCTION. DESIGN SHOWN MAY DIFFER FROM ACTUAL FINISHED CONSTRUCTION. FINAL MATERIALS, WINDOW/DOOR SIZES, AND OR LOCAL CODES.

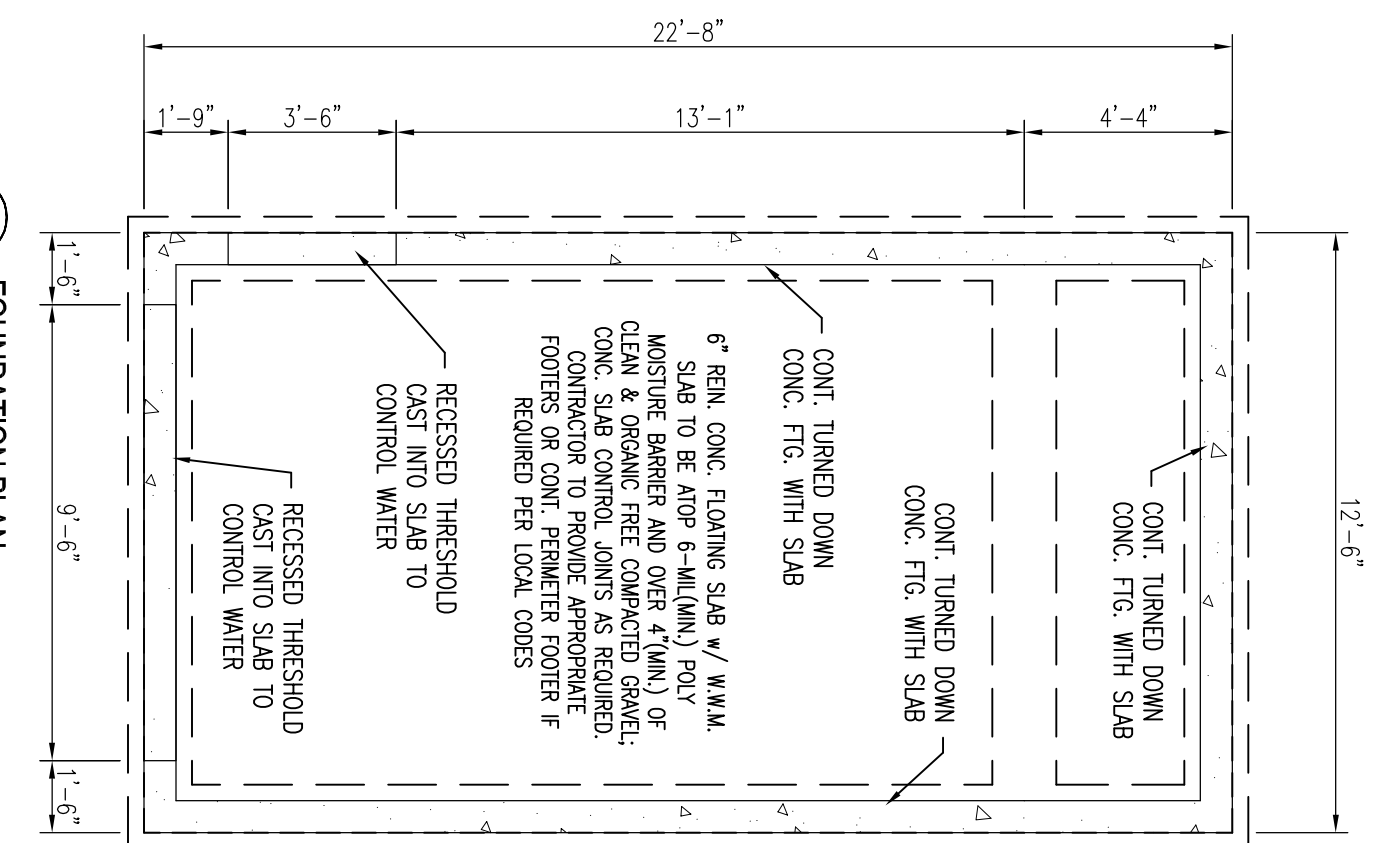

FOUNDATION PLAN  
1/4" = 1'-0"

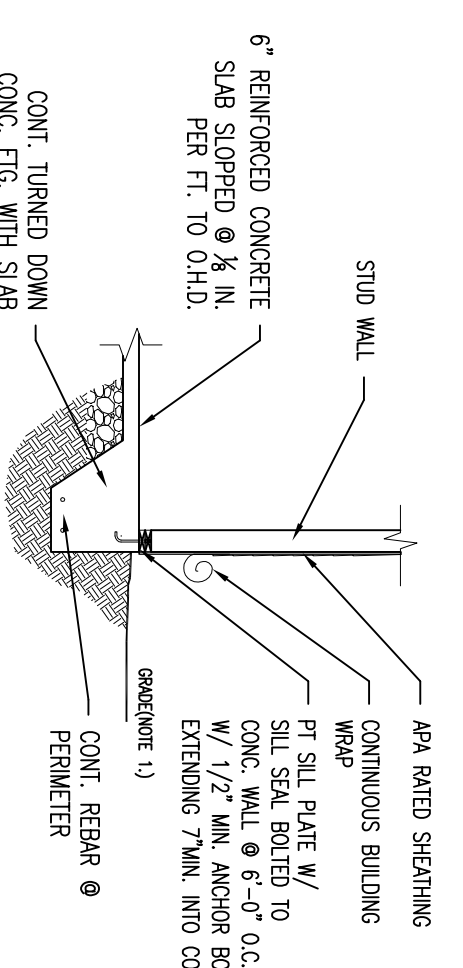

CONSTRUCTION NOTE:  
CONTRACTOR IS TO VERIFY GRADE AND ALL DIMENSIONS IN FIELD BEFORE CONSTRUCTION. DESIGN SHOWN MAY DIFFER FROM ACTUAL FINISHED CONSTRUCTION. FINAL MATERIALS, WINDOW/DOOR SIZES, AND OR LOCAL CODES.

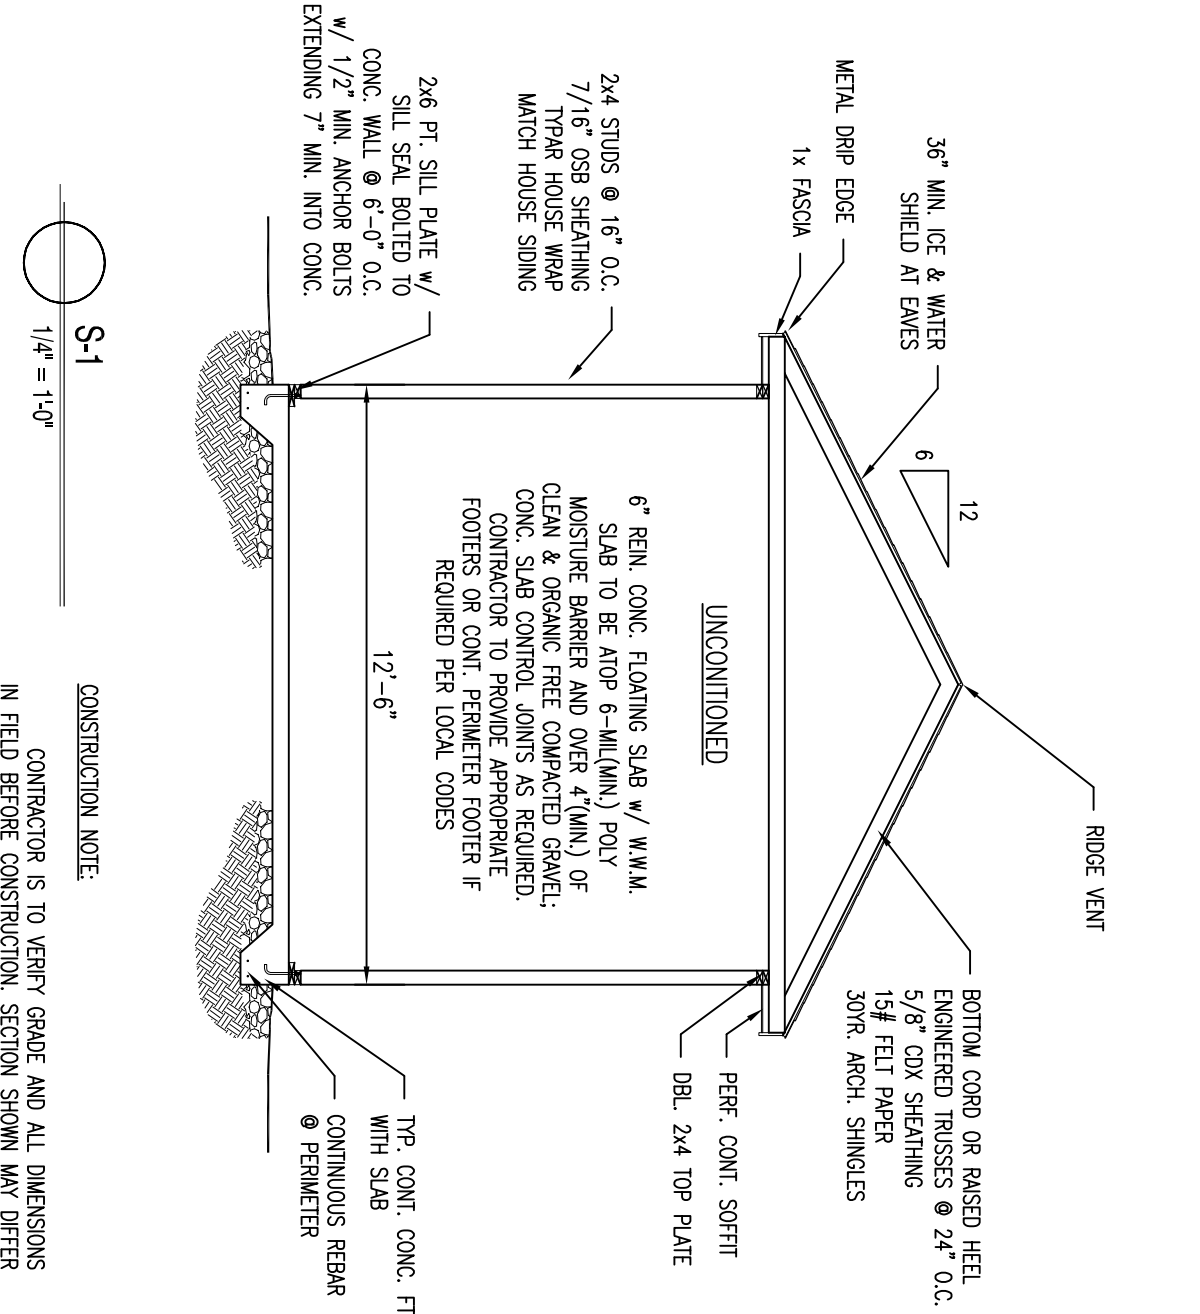

CONSTRUCTION NOTE:  
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Proposed Garage Plans  
Palmer, Garage  
Portland, ME

DRAWINGS ARE PROVIDED BY SOUTHERN MAINE DRAFTING & DESIGN AS A SERVICE TO HIS CUSTOMERS AND ARE INTENDED FOR INFORMATIONAL AND ILLUSTRATIVE PURPOSES ONLY. THE INFORMATION PRESENTED IN THESE DRAWINGS IS NOT TO BE USED AS A BASIS FOR CONSTRUCTION. SOUTHERN MAINE DRAFTING & DESIGN SUGGESTS THAT HIS CUSTOMERS SEEK THE SERVICES OF A LICENSED ARCHITECT OR REGISTERED ARCHITECT TO OBTAIN TECHNICAL BLUE PRINTS IF THEY ARE NOT TO PROCEED FURTHER. SOUTHERN MAINE DRAFTING & DESIGN SUGGESTS THAT HIS CUSTOMERS SEEK THE SERVICES OF A LICENSED OR REGISTERED ARCHITECT TO OBTAIN TECHNICAL BLUE PRINTS IF THEY ARE NOT TO PROCEED FURTHER. SOUTHERN MAINE DRAFTING & DESIGN SUGGESTS THAT HIS CUSTOMERS SEEK THE SERVICES OF A LICENSED OR REGISTERED ARCHITECT TO OBTAIN TECHNICAL BLUE PRINTS IF THEY ARE NOT TO PROCEED FURTHER. SOUTHERN MAINE DRAFTING & DESIGN SUGGESTS THAT HIS CUSTOMERS SEEK THE SERVICES OF A LICENSED OR REGISTERED ARCHITECT TO OBTAIN TECHNICAL BLUE PRINTS IF THEY ARE NOT TO PROCEED FURTHER. SOUTHERN MAINE DRAFTING & DESIGN SUGGESTS THAT HIS CUSTOMERS SEEK THE SERVICES OF A LICENSED OR REGISTERED ARCHITECT TO OBTAIN TECHNICAL BLUE PRINTS IF THEY ARE NOT TO PROCEED FURTHER. SOUTHERN MAINE DRAFTING & DESIGN SUGGESTS THAT HIS CUSTOMERS SEEK THE SERVICES OF A LICENSED OR REGISTERED ARCHITECT TO OBTAIN TECHNICAL BLUE PRINTS IF THEY ARE NOT TO PROCEED FURTHER.

DATE	REVISIONS
08/05/13	REVISIONS
08/05/13	REVISIONS

Date : 08/05/13  
 Scale : 1/4" = 1'-0"  
 Drawn By: JTM  
 Project: 0071813  
 Sheet Number:  
 1 of 1