



**SECOND FLOOR / LOW ROOF FRAMING PLAN**

SCALE: 1/4" = 1'-0"  
 Existing Conditions  
 Refer to Arch Dugs. for Doors & Windows

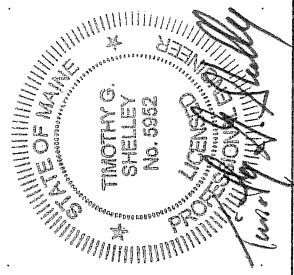


SEI <b>SHELLEY ENGINEERING, INC.</b> STRUCTURAL CONSULTANTS P.O. Box 1030 GRAY, MAINE 04039 PHONE (207) 657-8031 WWW.SHELLEYENGINEERING.COM	<b>74 WATSON STREET</b> <b>RENOVATIONS</b>		
	PORTLAND	MAINE	
	DRAWN BY: TGS	DATE: 8/31/12	SKETCH: S1 OF 3
	DESIGNED BY: TGS	SCALE: AS NOTED	JOB No.: 2012-114

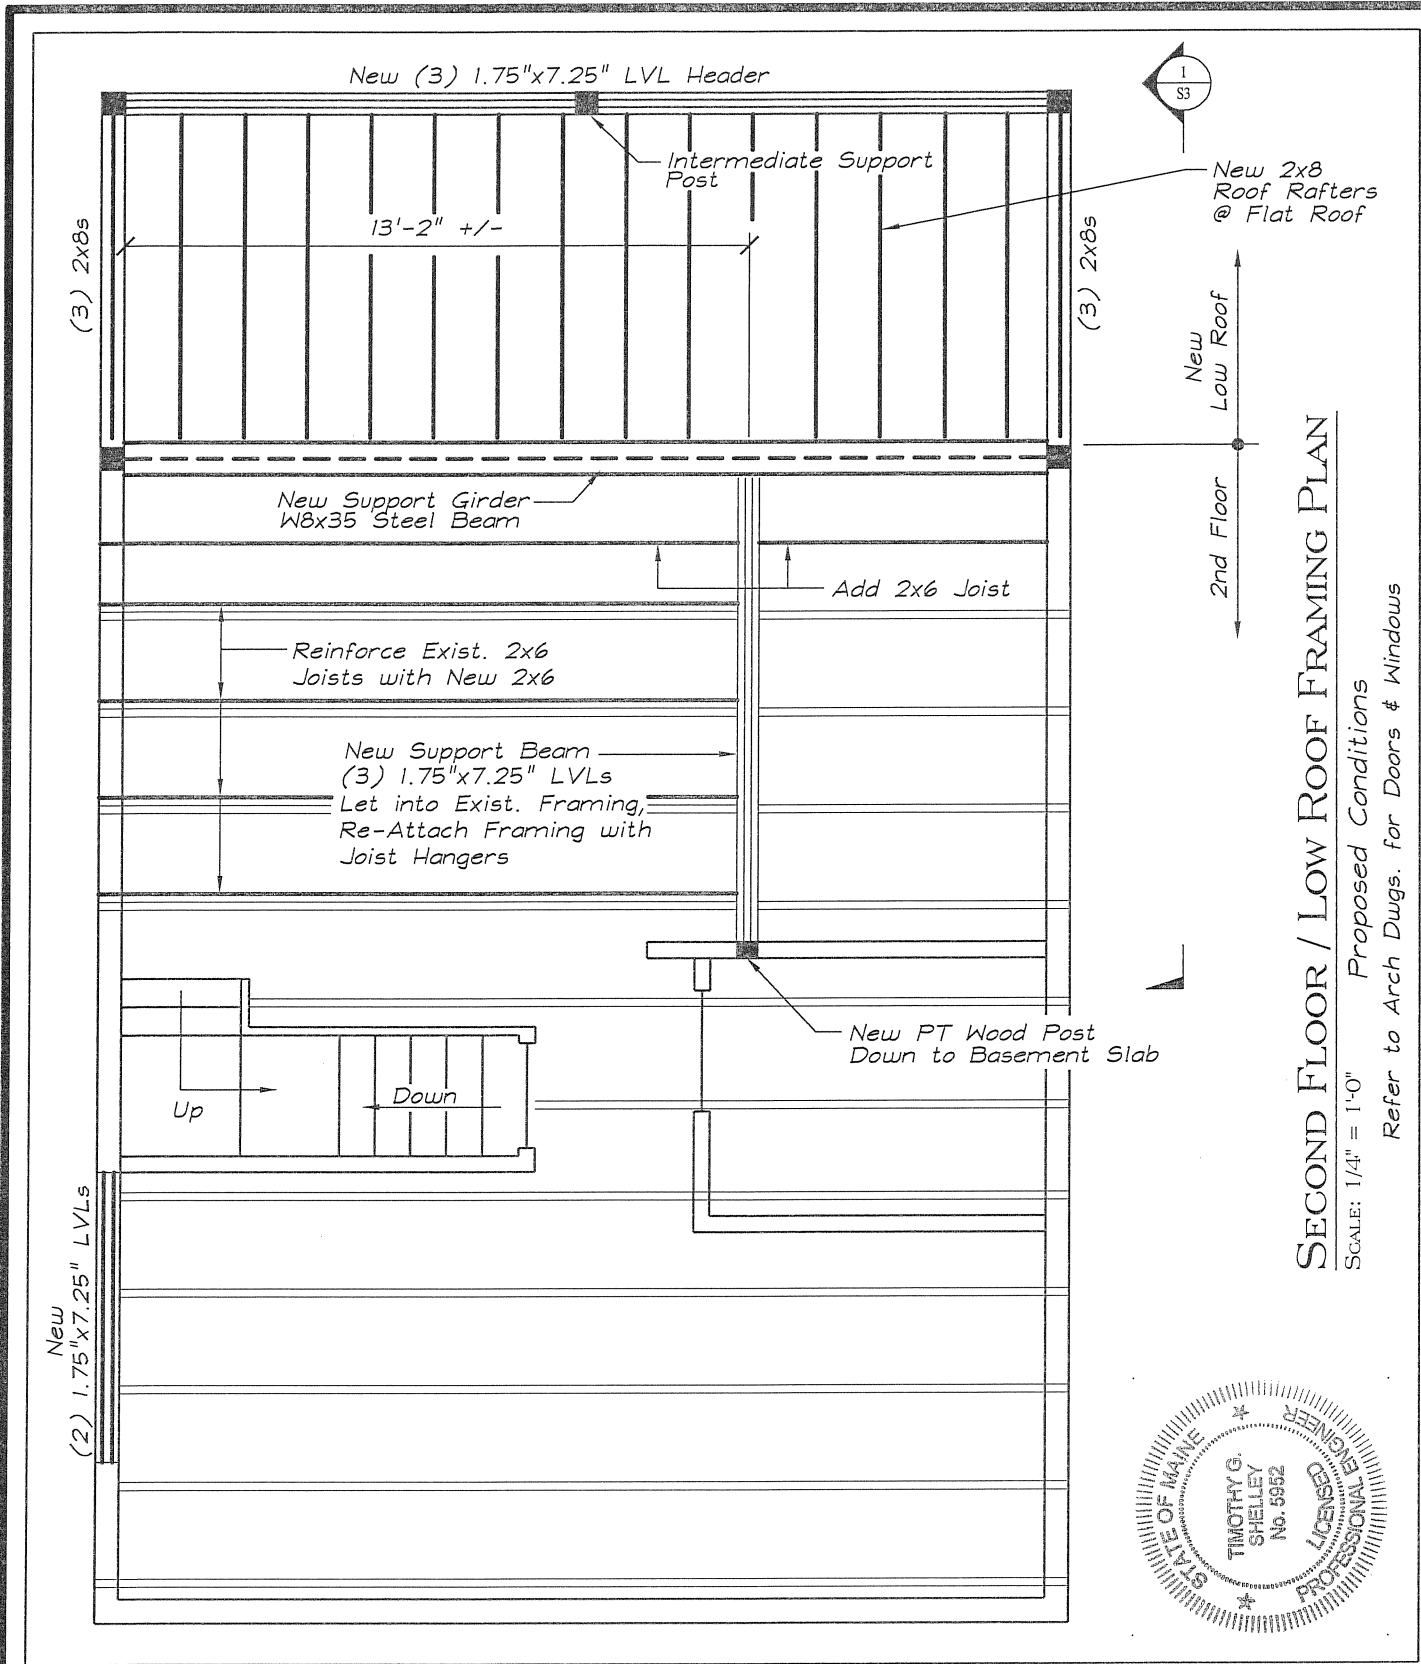


**SECOND FLOOR / LOW ROOF FRAMING PLAN**

SCALE: 1/4" = 1'-0"  
 Proposed Conditions  
 Refer to Arch Dwg. for Doors & Windows

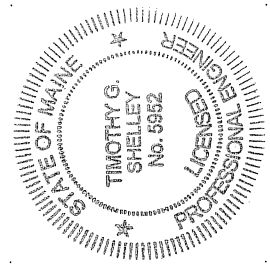

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DRAWN BY:	DATE:	9/12/12	SKETCH:
TGS	8/31/12	Rev.1	S2 OF 3
DESIGNED BY:	SCALE:	JOB No.:	
TGS	AS NOTED	2012-114	

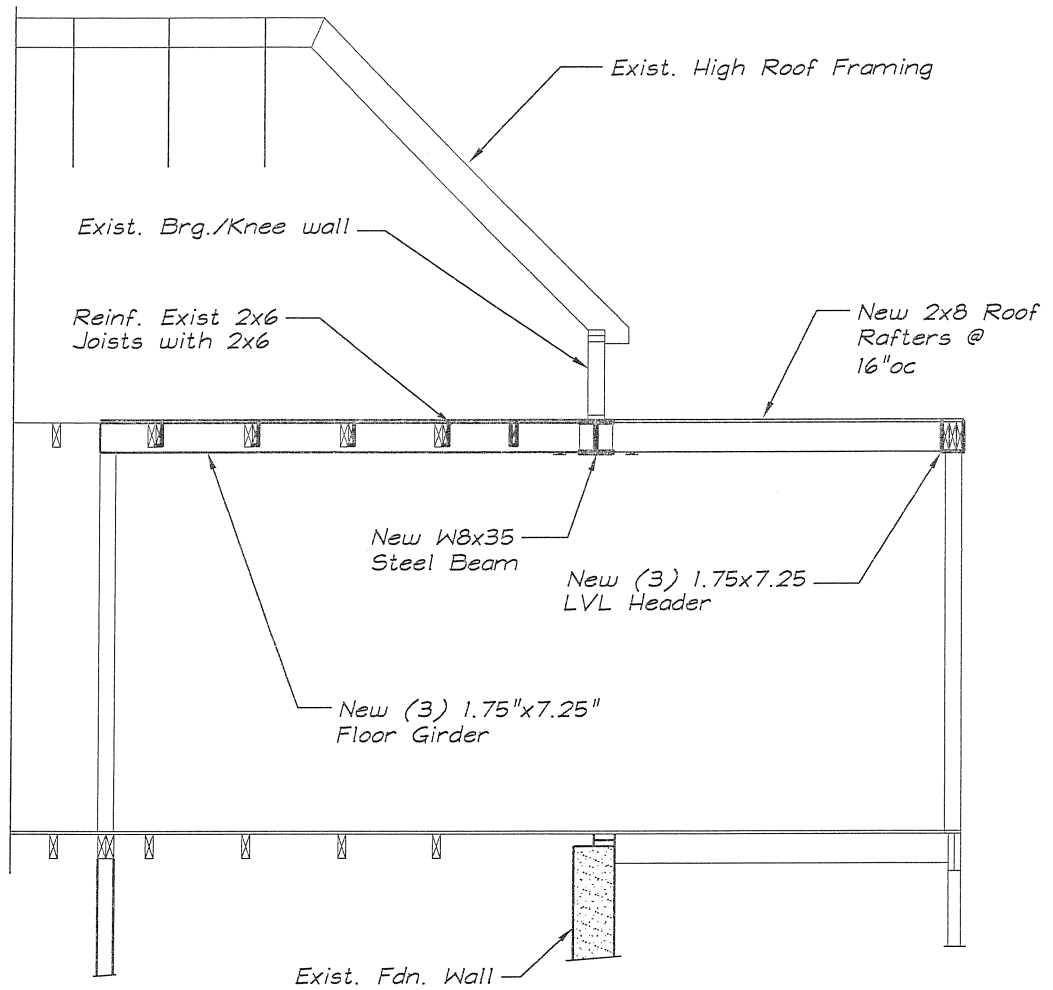


SECTION

SCALE: 1/4" = 1'-0"



Provide Temporary Shoring - by Contractor

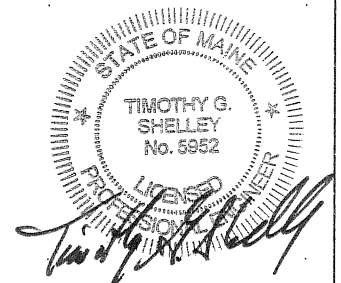

SEI

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74 WATSON STREET  
 RENOVATIONS

PORTLAND

MAINE

DRAWN BY:

TGS

DATE:

8/31/12

9/12/12

Rev.1

SKETCH:

S3 OF 3

DESIGNED BY:

TGS

SCALE:

AS NOTED

JOB No.:

2012-114