



## FIRST FLOOR FRAMING PLAN



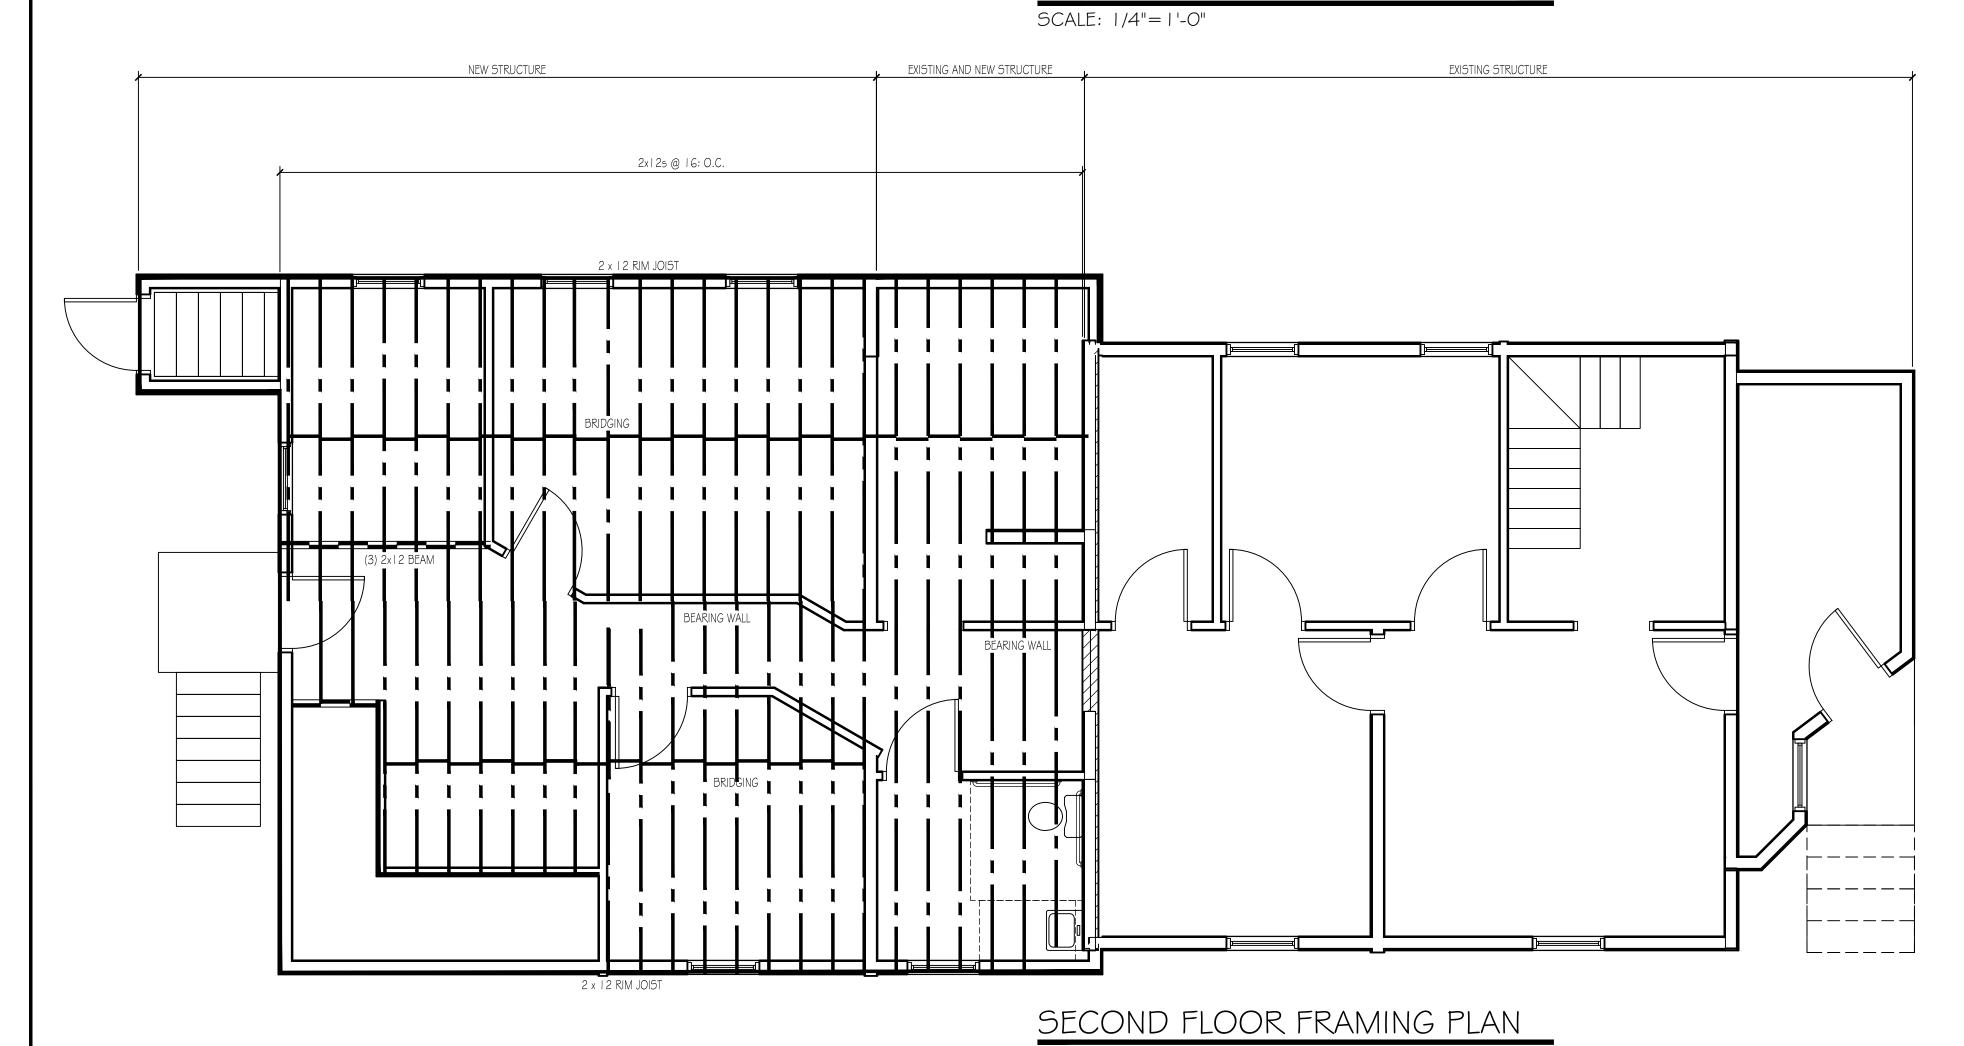

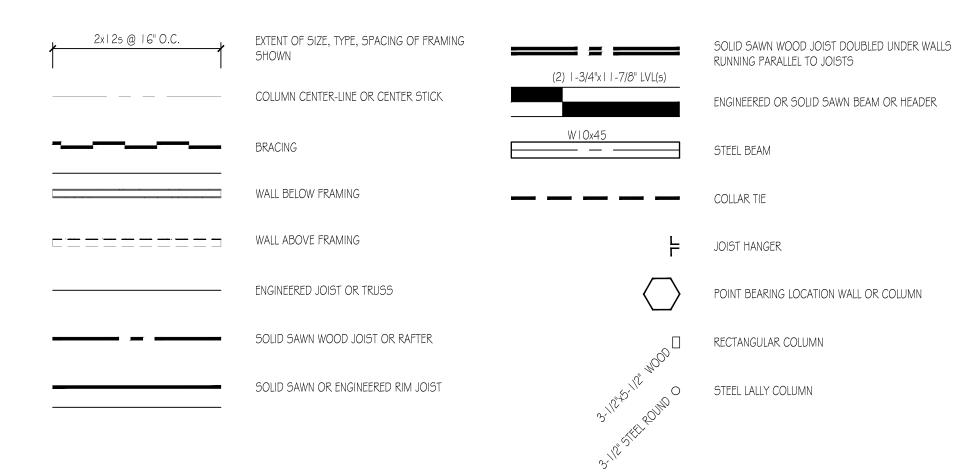

## STRUCTURAL DESIGN CRITERIA:

I. Building Code: This Building is Designed to Comply with the 2009 Edition of the International Building Code IBC 2009. The 2005 Edition of ASCE-7, "Minimum Design Loads for Buildings and Other Structures.

## Design Loads:

Design Wind: Location: Kennebunkport, Maine Wind Load (Per IBC Section 1609): Basic Wind Speed V = 110 MPHWind Exposure Factor = BImportance Factor I = 1.0Components and Cladding A. Net Design Wind Pressure For a Wall Element: I. at non-salient areas - Pnet =  $\pm 25$  psf 2. at salient areas - Pnet =  $\pm 29$  psf Live Load: 50 PSF Plus Snow Drift Loading Where Applicable (Per Section 1608) Snow Exposure Factor Ce = 1.0Snow Thermal Factor Ct = 1.1Importance Factor = 1.0Dead Load: - 12 PSF Deign Seismic: Occupancy Category = IISoil Site Class 'D' I(E) = 1.0S(DS) = .326S(D1) = .115Seismic Design Category = B Basic Seismic Force Resisting System : Light Framed Wall Systems Using Shear Panels.

- 12 PSF

1st Floor Area - 40 PSF 2nd Floor Area - 30 PSF

ALL DIMENSIONS AND CONDITIONS MUST BE VERIFIED IN THE FIELD. ANY DISCREPANCIES SHALL BE BROUGHT TO THE ATTENTION OF THE ENGINEER BEFORE PROCEEDING WITH THE AFFECTED PART OF THE WORK.

THE STRUCTURE IS DESIGNED TO BE SELF SUPPORTING AND STABLE AFTER THE BUILDING IS COMPLETE. IT IS THE CONTRACTOR'S SOLE RESPONSIBILITY TO DETERMINE ERECTION PROCEDURES AND SEQUENCE TO ENSURE SAFETY OF THE STRUCTURE AND PERSONNEL DURING ERECTION. THIS INCLUDES THE ADDITION OF THE NECESSARY SHORING, SHEETING, TEMPORARY BRACING, GUYS OR TIEDOWNS. SUCH MATERIAL SHALL REMAIN THE PROPERTY OF THE CONTRACTOR AFTER COMPLETION OF THE PROJECT.

ALL APPLICABLE FEDERAL, STATE, AND MUNICIPAL REGULATIONS SHALL BE FOLLOWED, INCLUDING THE FEDERAL DEPARTMENT OF LABOR OCCUPATIONAL SAFETY AND HEALTH ACT.

IT IS THE OWNER'S SOLE RESPONSIBILITY TO EMPLOY ONE OR MORE SPECIAL INSPECTORS (IF REQUIRED) TO PROVIDE INSPECTIONS IN COMPLIANCE WITH ALL APPLICABLE REQUIREMENTS OF IBC 2009.

THE CONTRACTOR SHALL BE RESPONSIBLE FOR ADEQUATE DESIGN AND CONSTRUCTION OF ALL FORMS, SHORING AND TEMPORARY BRACING DURING THE PROGRESS OF THE PROJECT.

ALL STRUCTURAL STEEL WORK SHALL CONFORM TO THE RECOMMENDATIONS AND REQUIREMENTS CONTAINED IN THE "MANUAL OF STEEL CONSTRUCTION, ALLOWABLE STRESS DESIGN", AISC NINTH EDITION (INCLUDING AISC CODE OF STANDARD PRACTICE FOR STEEL BUILDINGS AND BRIDGES), AND "STRUCTURAL STEEL WELDING CODE - STEEL", (AWS DI.I, LATEST EDITION).

STRUCTURAL STEEL ROLLED SHAPES, PLATES AND BARS SHALL CONFORM TO THE FOLLOWING: a) ASTM A992, GRADE 50: ALL WIDE FLANGE SECTIONS, FY=50 b) ASTM A36: OTHER ROLLED SHAPES, PLATES AND BARS, FY=36 ASTM A36: THREADED AND OTHER STEEL RODS

ation	Gırder	Number of		
		NUMBER OF	Number of	
	Members	Members	Jack Studs	
· Wall	2x6s	2	2	
· Wall	2x8s	2	2	
· Wall	2x10s	2	2	
· Wall	2x12s	2	2	
· Wall	2x12s	3	2	
Wall	2x6s	2	2	
Wall	2x8s	2	2	
Wall	2x10s	2	2	
Wall	2x12s	2	2	
Wall	2x12s	3	2	
	Wall Wall	Wall 2x   2s Wall 2x   2s	Wall 2x12s 2	

Opening Size Location		Gırder	Number of	Number of	
		Members	Members	Jack Studs	
0" to 4'-0"	Exterior Wall	2x6s	2	2	
4'-0" to 5'-0"	Exterior Wall	2x8s	2	2	
5'-0" to 6'-0"	Exterior Wall	2x10s	2	2	
6'-0" to 7'-0"	Exterior Wall	2x12s	2	2	
7'-0" to 8'-0"	Exterior Wall	2x12s	3	2	
0" to 3'-6"	Interior Wall	2x6s	2	2	
3'-6" to 5'-0"	Interior Wall	2x8s	2	2	
5'-0" to 6'-0"	Interior Wall	2x10s	2	2	
6'-0" to 7'-0"	Interior Wall	2x12s	2	2	
7'-0" to 8'-0"	Interior Wall	2v126	3	2	

THE CONTRACTOR/OWNER ASSUMES ALL RESPONSIBILITY FOR LOCAL CODE COMPLIANCE. ALL DRAWINGS, PLANS, SKETCHES ETC. ARE PROVIDED TO OUR CLIENTS BASED UPON INFORMATION PROVIDED BY THE CLIENT AND DRAWN IN ACCORDANCE WITH COMMON BUILDING PRACTICES AND LOCAL CODES. NONE OF THE EMPLOYEES OF CDT ARE NOT REGISTERED ARCHITECTS, ENGINEERS OR LAND BY CLIENT AND/OR CONTRACTOR BEFORE ACTUAL CONSTRUCTION BEGINS. IF DIMENSIONS AND SPECIFICATIONS ARE NOT VERIFIED BY CLIENT AND/OR CONTRACTOR BEFORE ACTUAL CONSTRUCTION

AND/OR REVISIONS MADE TO PLANS BY CLIENT AND/OR CONTRACTOR.

BEGINS CDT WILL BE HELD HARMLESS CDT ASSUMES NO LIABILITY FOR CHANGES

SURVEYORS. ALL DIMENSIONS AND SPECIFICATIONS SHOULD BE VERIFIED

1. Contractor/owner responsible for securing all necessary permits.

2. Contractor/owner will Comply with all applicable codes and ordinances.

3. Contractor/owner to verify all site grades and dimensions.

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	NO REMARKS	ISSUED FOR PERMIT	ISSUED FOR PERMIT				
	ON	А	В				
	DATE	09-24-15	05-23-16				
	CODE:				IRC 2009		
	TOWN			PORTLAND			
	DATE:			09-24-15			
	SCALE:				As Noted		

Building Add 522 Washingt Schneider Pro

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TITLE: FIRST & SECOND FLOOR ADDITION FRAMING PLANS

SHEET: A1-04

DRAWN:

SCALE: 1/4"=1'-0" G:\CI\T Projects\Schneider\Washington Ave Revised 09-13-16.dwg, 9/18/2016 8:03:00 AM, AutoCAD PDF (High Quality Print).pc3