


- Note:**
1. Posts & rails will be 1-1/4" standard steel pipe (1-5/8" o.d.).
 2. Base plts will be 6"x6"x 1/4" stl.
 3. Kick plts will be 1/4"x 4" stl flat bar.
 4. Gate will be self closing and stopped so as not to open out.



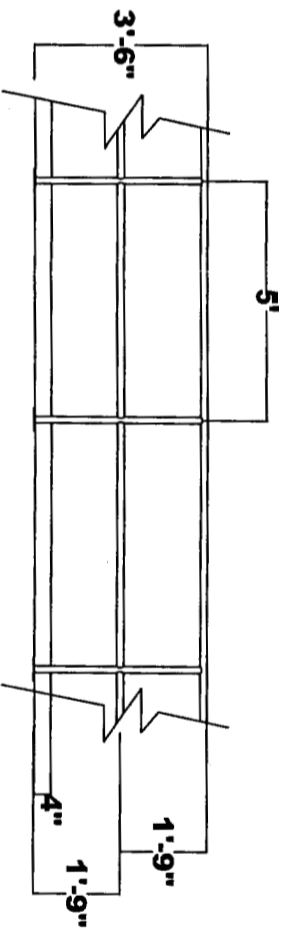


142 Pennington St
 RAILINGS
 YGSI Y

RECEIVED
 DEC 23 2004
 DEPT. OF BUILDING INSPECTION
 CITY OF PORTLAND, ME



SECTION
THRU STAIRS
SCALE 3/4" = 1'-0"

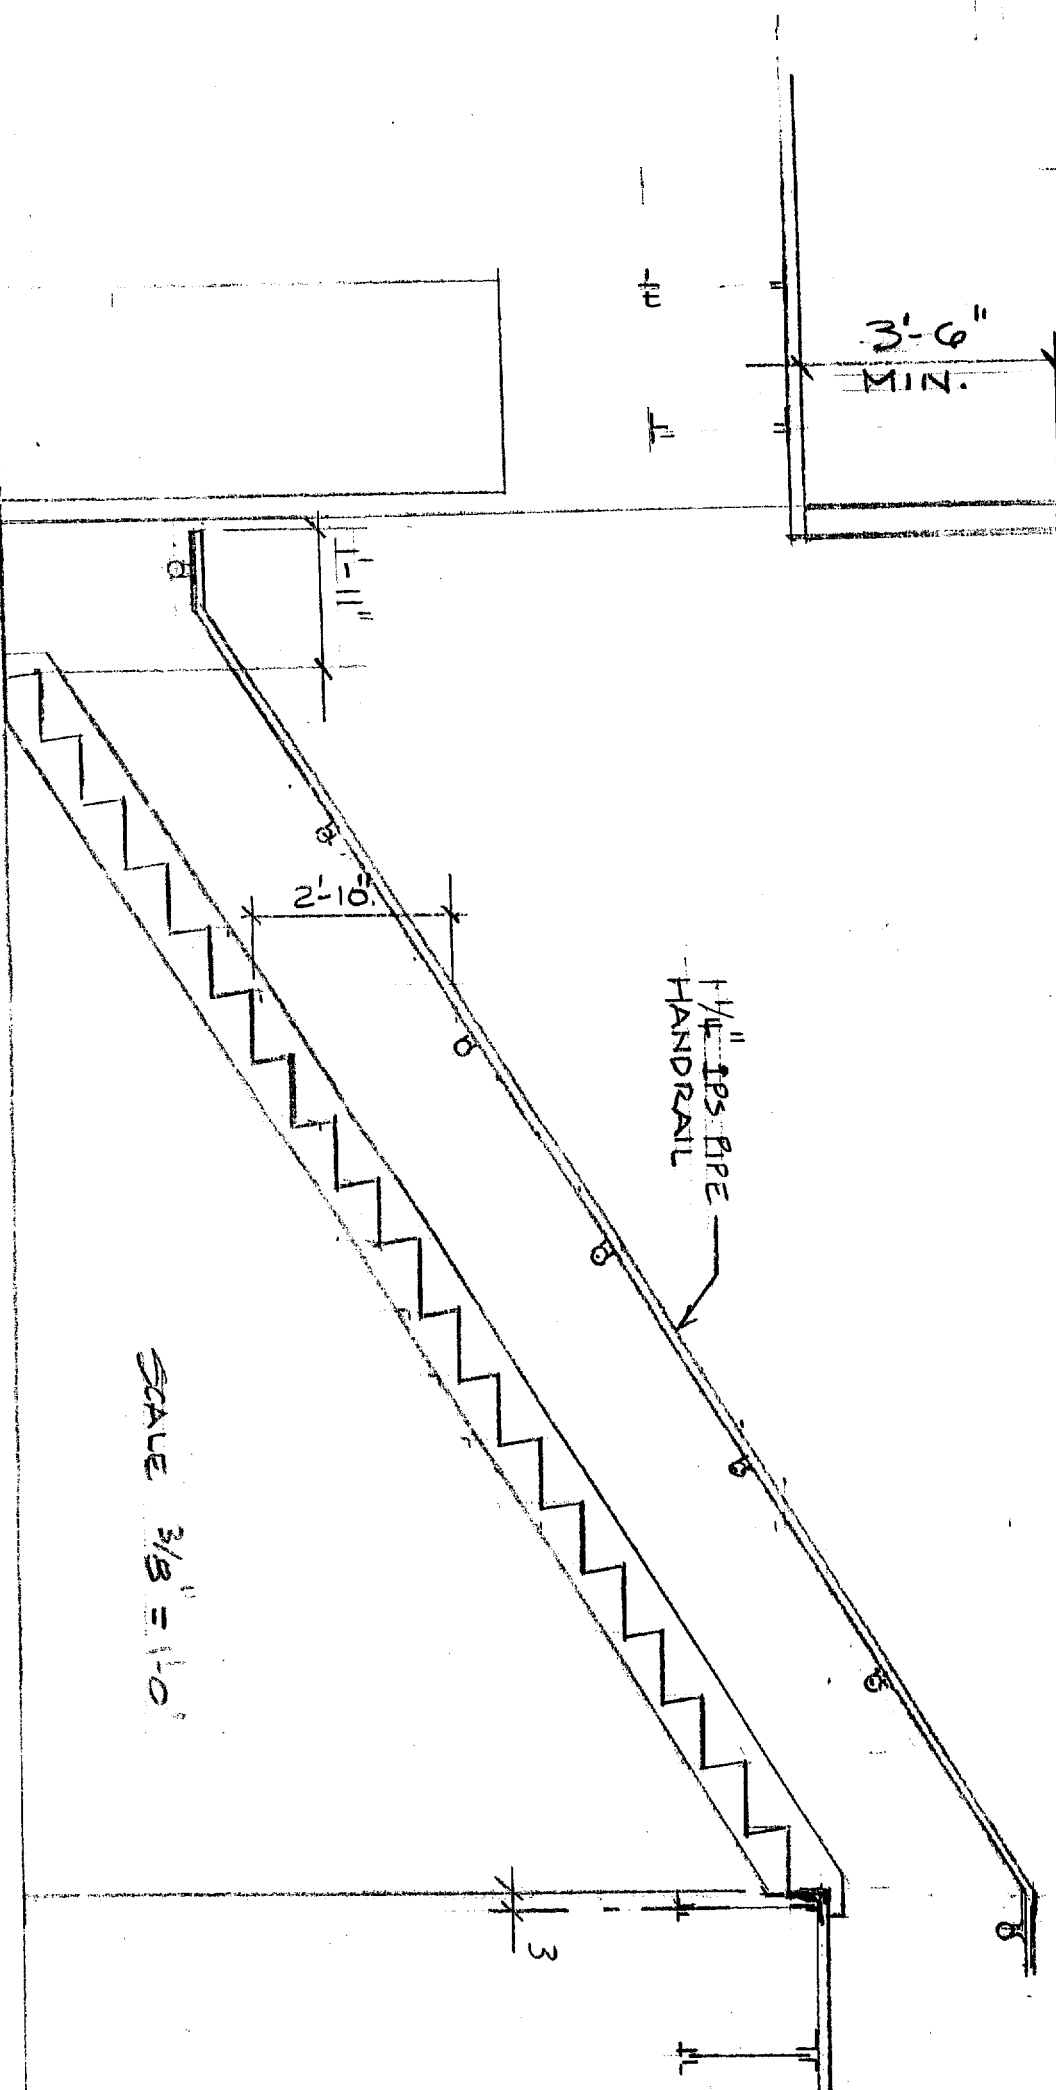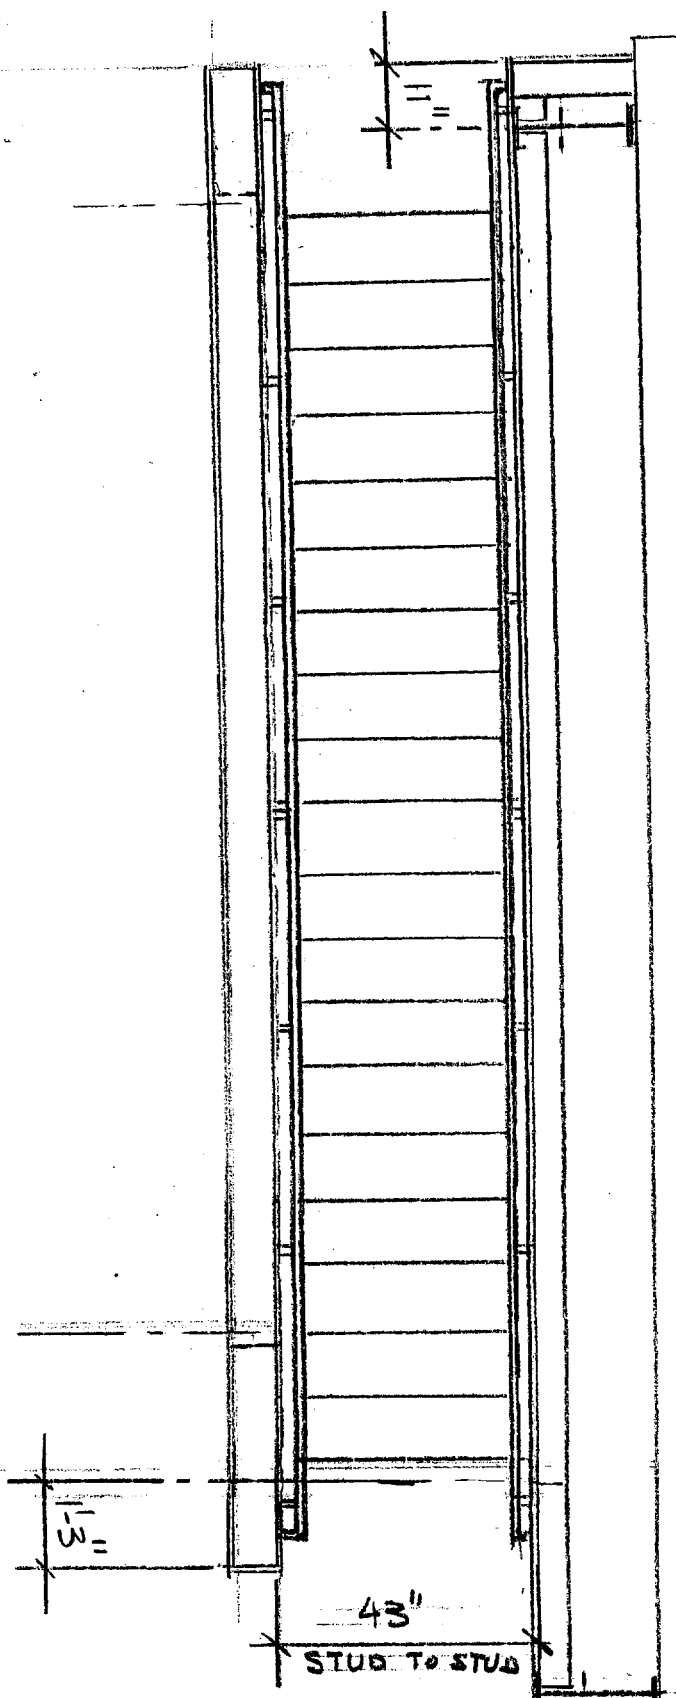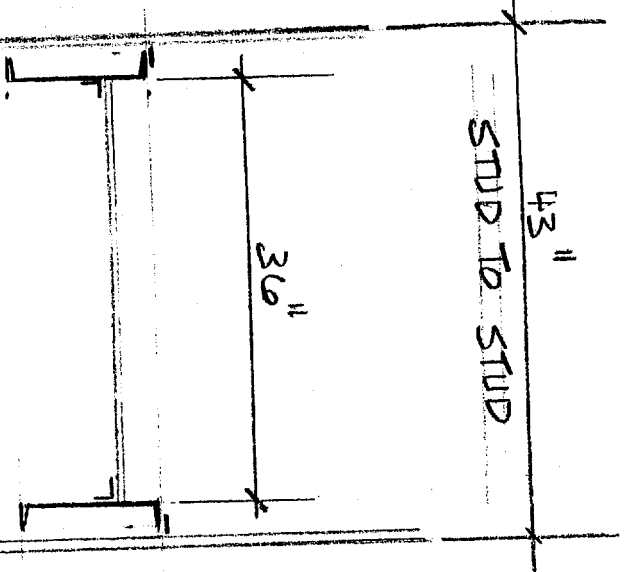

20 EQUAL RISER @ 6 3/4" = 11'-4"

SCALE 3/8" = 1'-0"

TOP OF STUD WALL

3'-6"
MINIMUM

142 Pleasant St
Stairway

DEPT. OF BUILDING INSPECTION
CITY OF PORTLAND, ME
DEC 23 2004
RECEIVED

REVISIONS
 DATE: 11/14/04
 SCALE: AS SHOWN
 APPROVED BY: [Signature]
 DRAWN BY: RTB


MEZZANINE FRAMING PLAN & SECTIONS

INDICATES C LOAD BEARING METAL STUDS @ 24" OC
 STUDS SHALL BE H GAGE CSD STUDS (CSD 1/8")
 PROVIDE CONTINUOUS TS 2X6 X 3/16 TOP PLATE
 LOCATE STUD UNDER JOISTS

DESIGN LIVE LOAD = 125 PSF


MEZZANINE FRAMING PLAN

1/8" = 1'-0"
 11/14/04

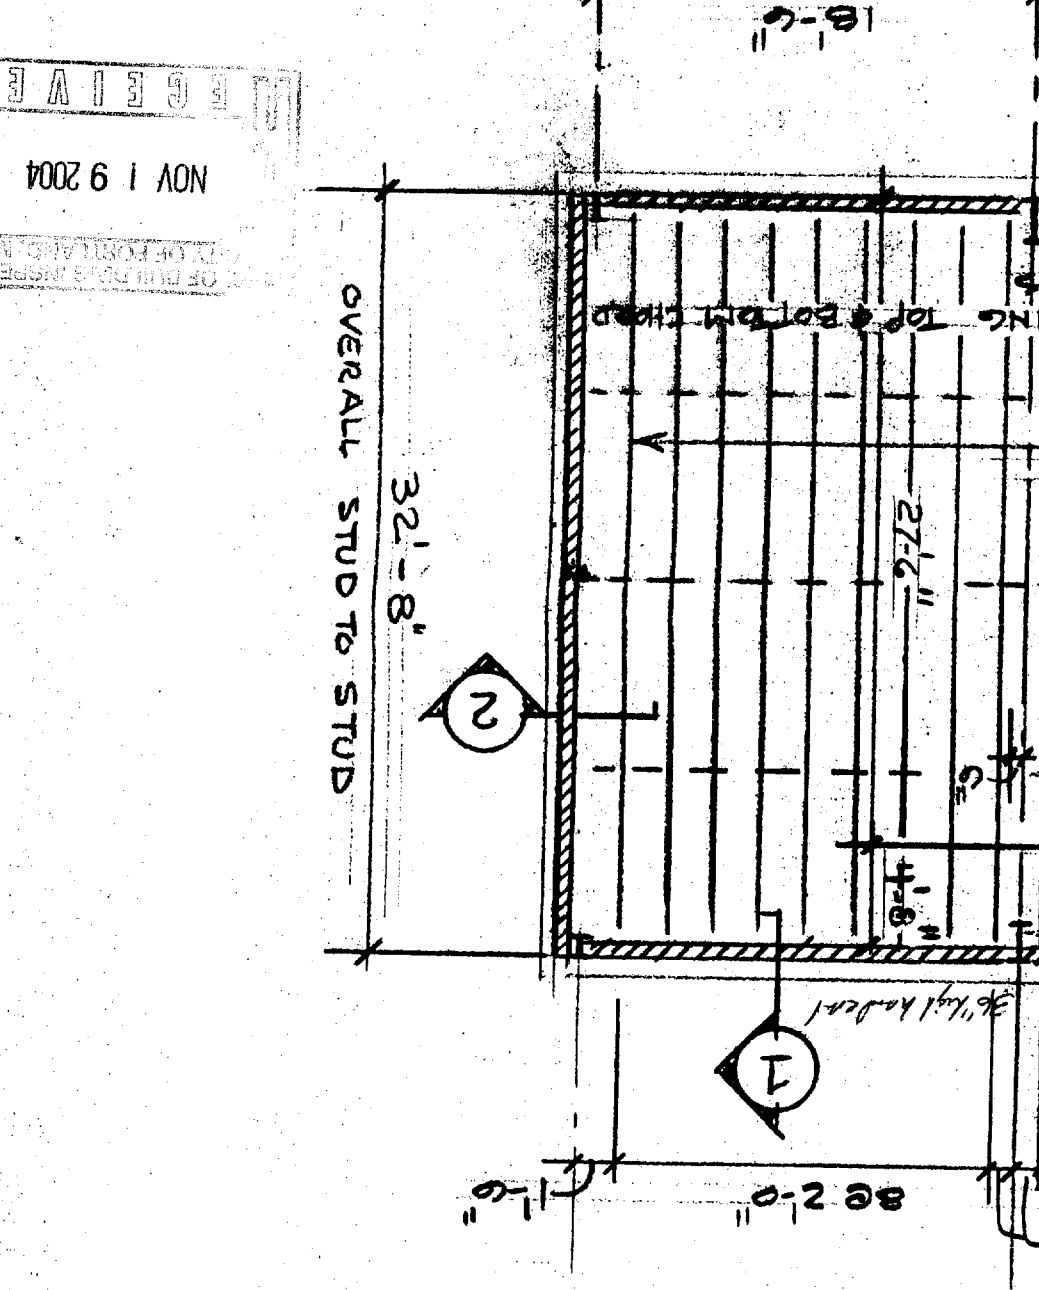

3/4" = 1'-0"

SECTION 4

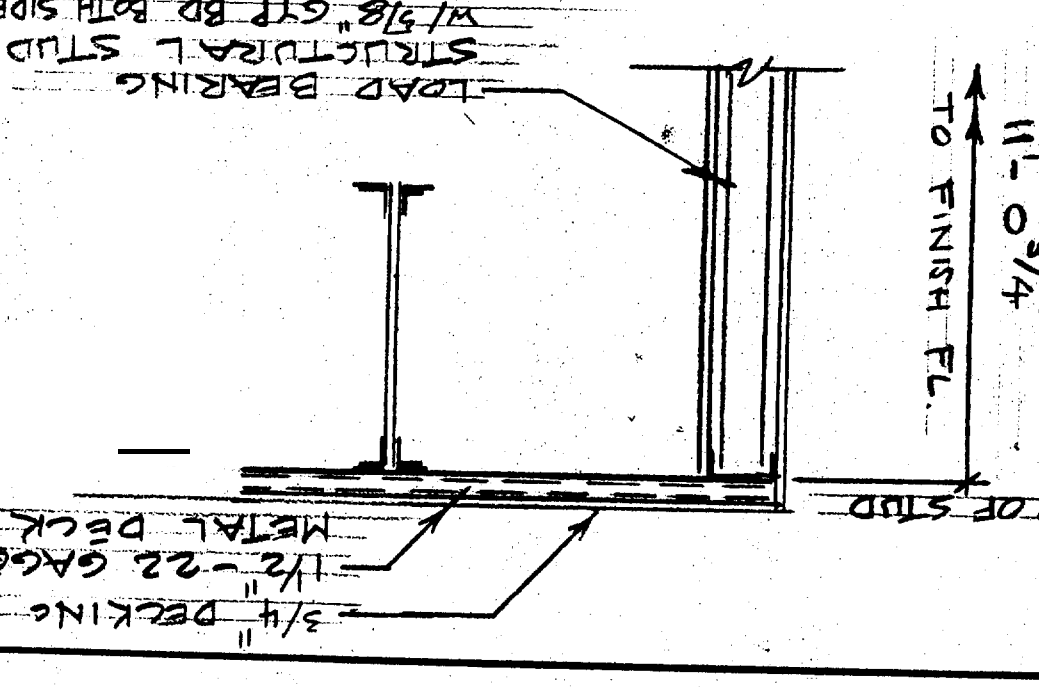

TO FINISH FL.


NOTE:
 1. PROVIDE HORIZONTAL STUD

INDICATES C LOAD BEARING METAL STUDS @ 24" OC
 STUDS SHALL BE H GAGE CSD STUDS (CSD 1/8")
 PROVIDE CONTINUOUS TS 2X6 X 3/16 TOP PLATE
 LOCATE STUD UNDER JOISTS

DESIGN LIVE LOAD = 125 PSF


MEZZANINE FRAMING PLAN

1/8" = 1'-0"
 11/14/04

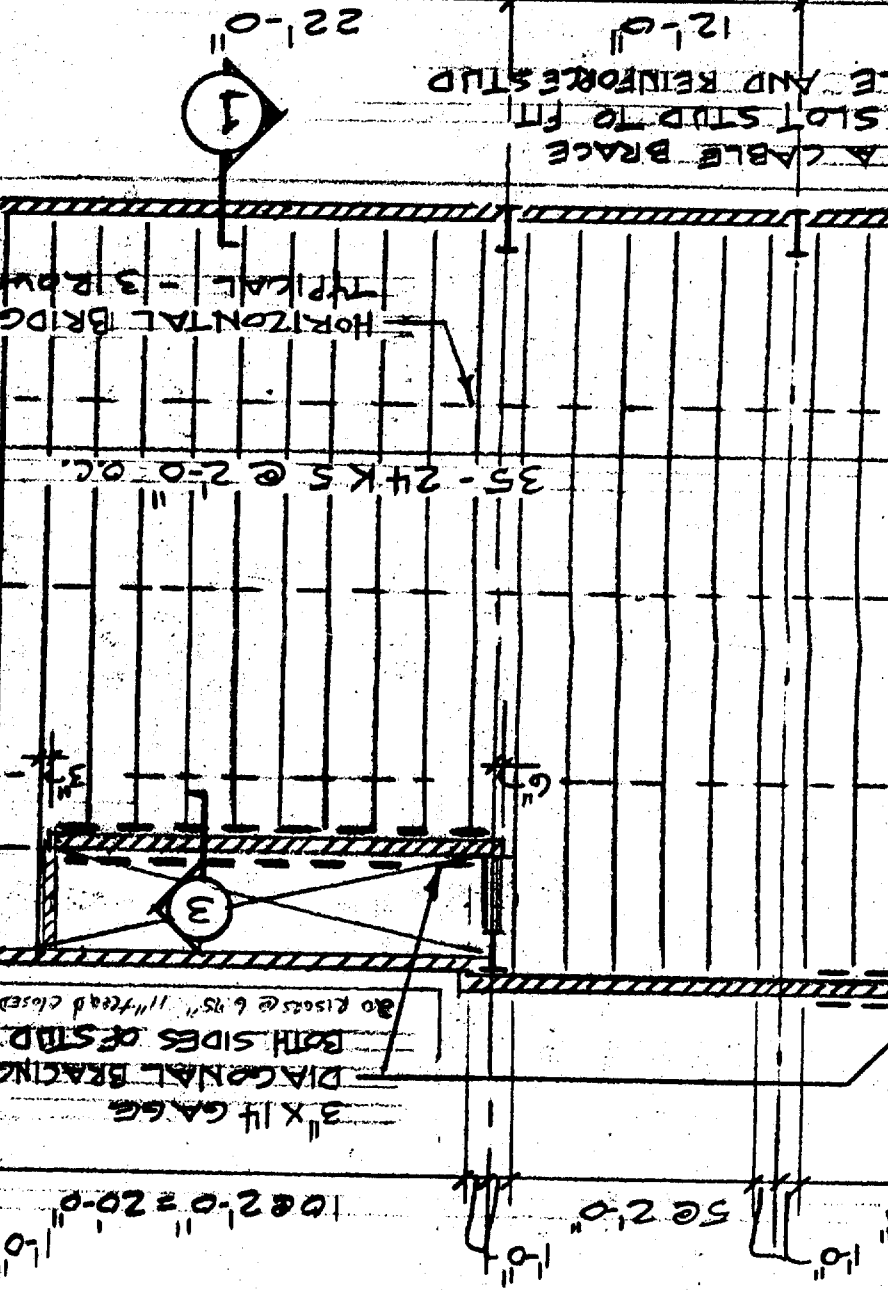


3/4" = 1'-0"

SECTION 3

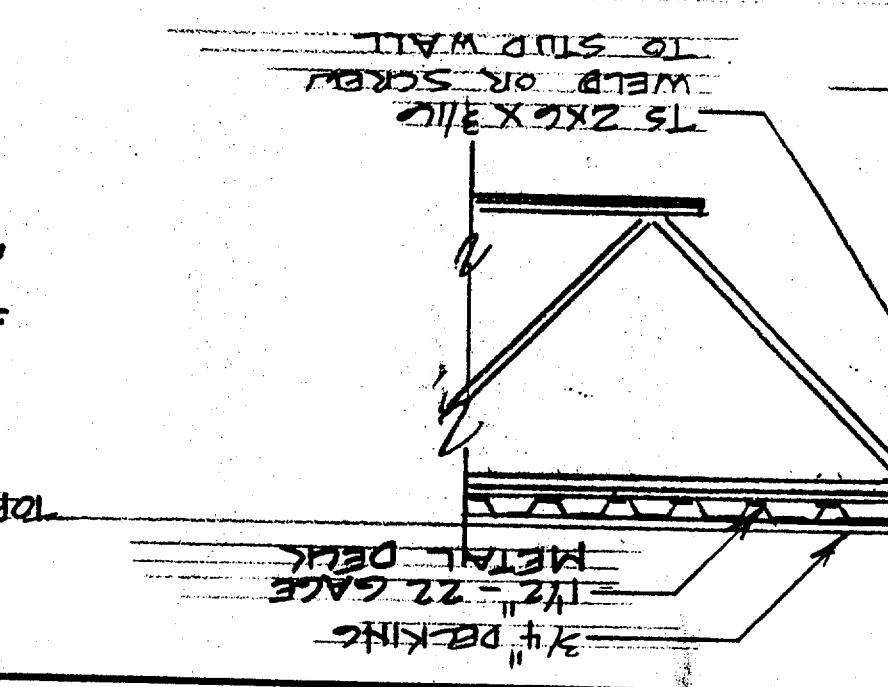


TO FINISH FL.

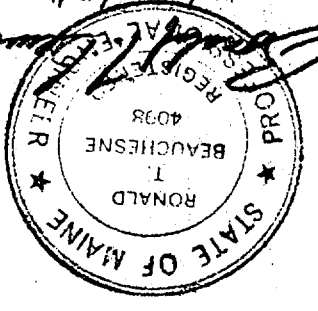

NOV 19 2004
 INSPECTION

3/4" = 1'-0"

SECTION 2

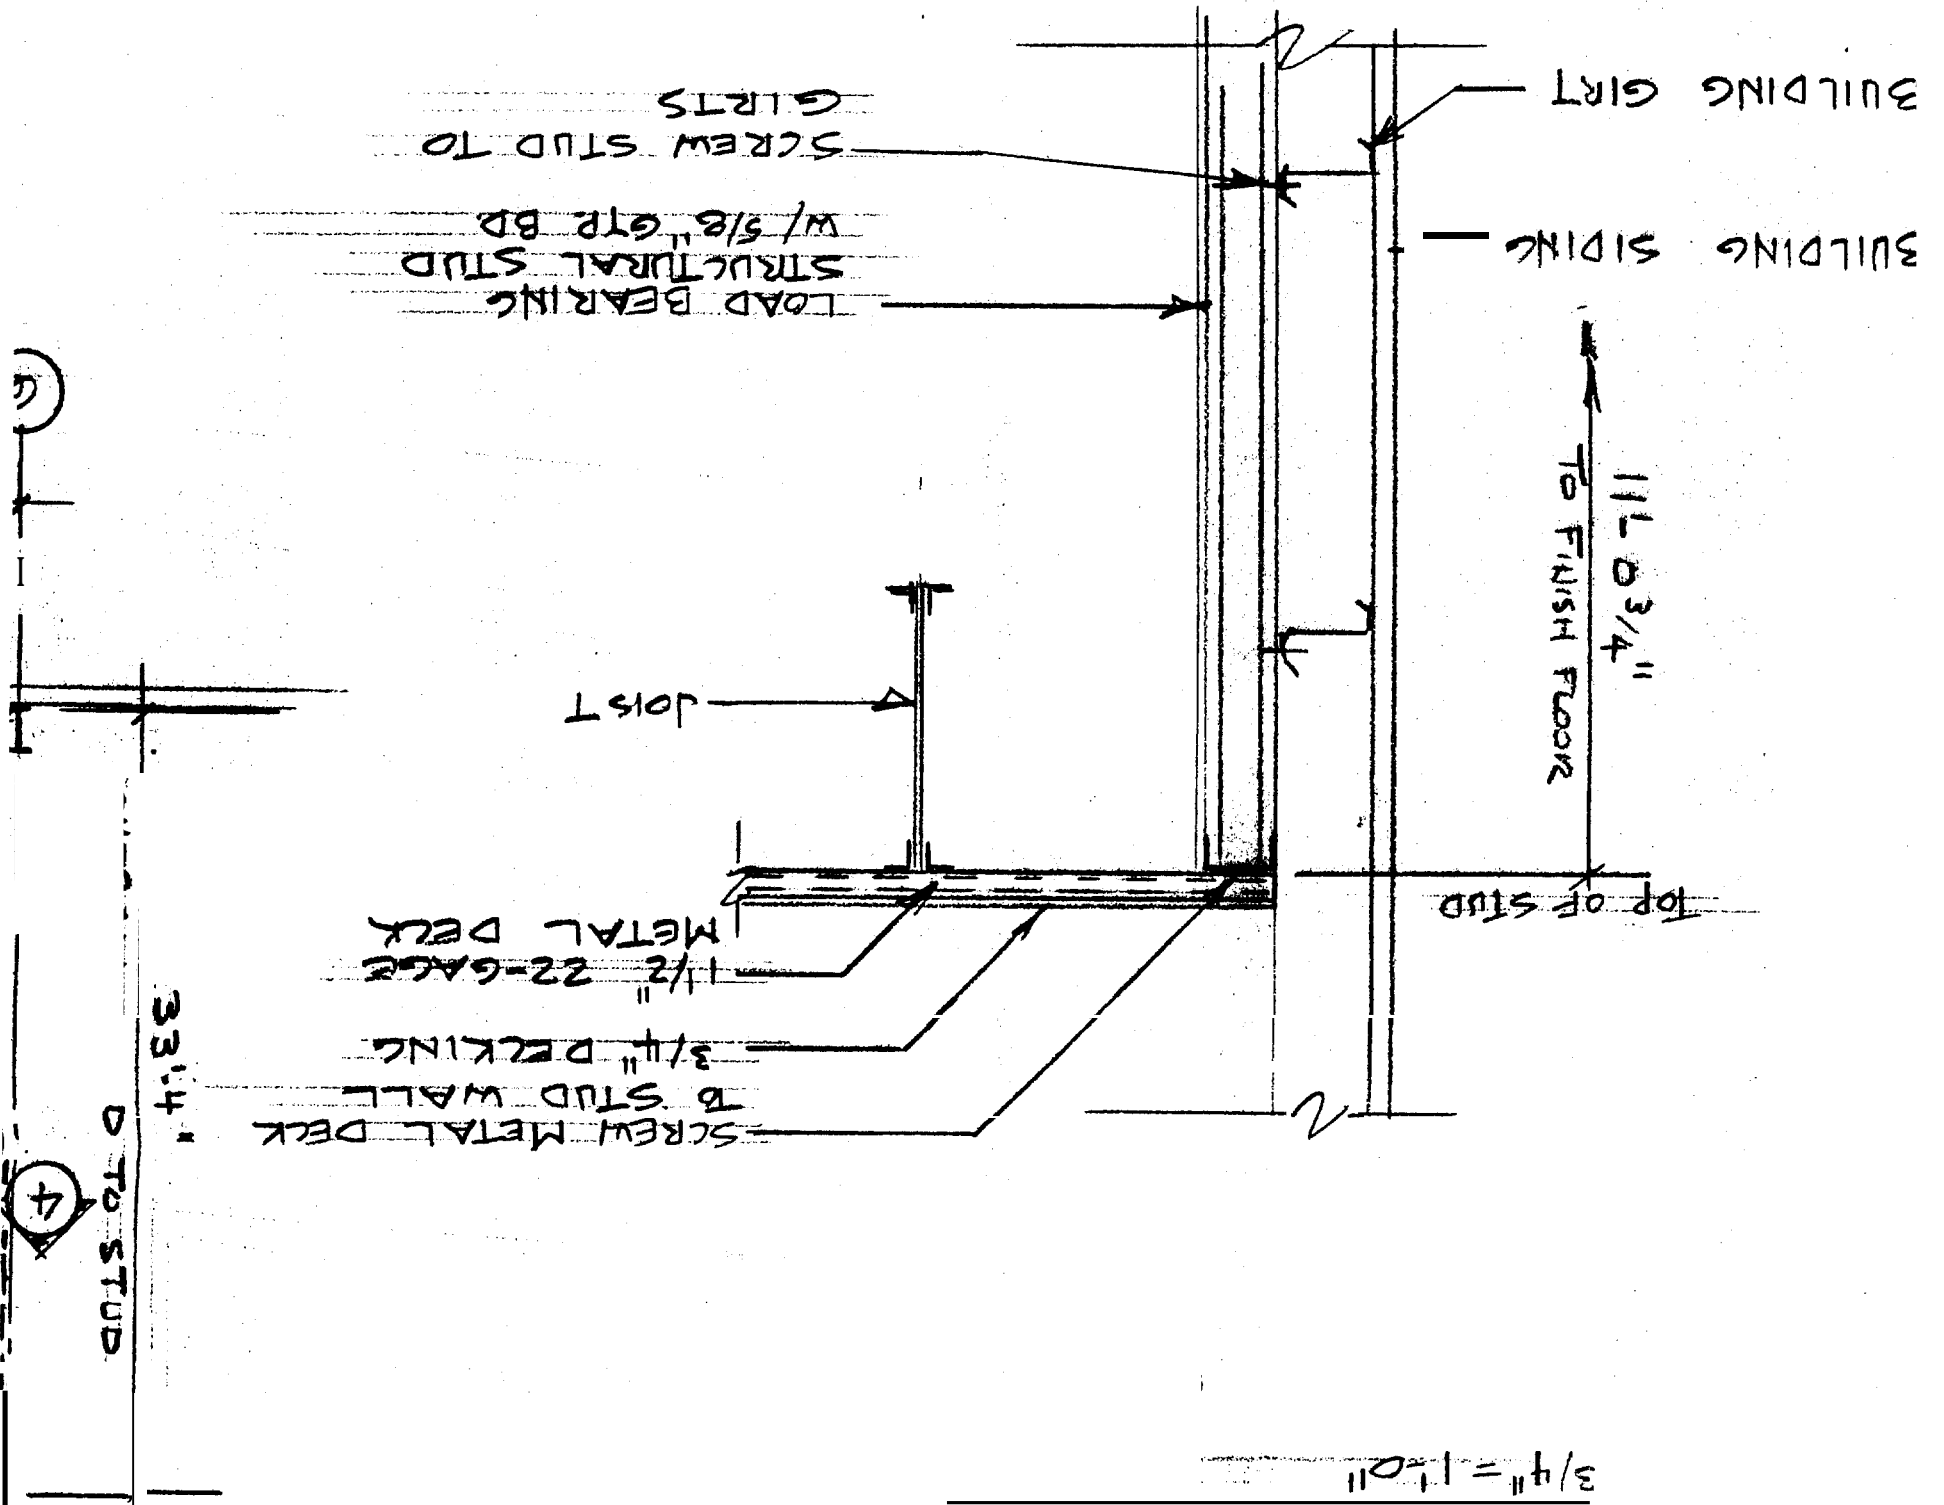

3/4" = 1'-0"

SECTION 1

