### SCOPE OF WORK

- A. THE INTENT OF THIS DRAWING SET IS TO PROVIDE SUFFICIENT INFORMATION FOR THE RENOVATION OF PC CONSTRUCTION CURRENT OFFICE \$ ADJACENT EXPANSION SPACE.
- B. THE CONSTRUCTION PROCESS SHALL PROCEED UNDER THE DIRECTION OF THE TENANT.
- C. MECHANICAL, PLUMBING, ELECTRICAL & FIRE PROTECTION SYSTEMS SHALL BE DESIGNED BY THE APPROPRIATE ENGINEERS AND/OR VENDORS AND REVIEWED BY THE TENANT/OWNER. PERMITS SHALL BE APPLIED FOR BY THE APPROPRIATE CONTRACTORS.

### WALL TYPES/KEY

| = = = = Indicated existing partition or element to be removed

INDICATES PARTITION TO REMAIN

NEW FULL HEIGHT PARTITION TO EXTEND TO UNDERSIDE OF DECK ABOVE PROVIDE ALL NEW TYPE A PARTITIONS WITH SOUND BATT INSULATION METAL STUDS SHALL BE 3-5/8", 20 GAUGE - 16" ON CENTER GYPSUM BOARD BOTH SIDE, 5/8" TYPE X

> NEW PARTITION TO EXTEND 6" ABOVE SUSPENDED ACOUSTICAL CEILING GRID. PROVIDE ALL NEW TYPE B PARTITIONS WITH SOUND BATT INSULATION METAL STUDS SHALL BE 3-5/8", 20 GAUGE - 16" ON CENTER GYPSUM BOARD BOTH SIDE, 5/8" TYPE X

> NEW PARTITION TO EXTEND 6" ABOVE SUSPENDED ACOUSTICAL CEILING GRID. METAL STUDS SHALL BE 3-5/8", 20 GAUGE - 16" ON CENTER GYPSUM BOARD BOTH SIDE, 5/8" TYPE X (SAME AS ABOVE, NO INSULATION)

## CONSTRUCTION NOTES

- THE CONSTRUCTION MANAGER/SUB-CONTRACTORS SHALL BE RESPONSIBLE FOR APPLICABLE BUILDING PERMITS.
- ALL EXISTING CONDITIONS AND DIMENSIONS TO BE FIELD VERIFIED BY CONTRACTOR PRIOR TO STARTING ALL WORK. ANY DISCREPANCIES IN THE FIELD TO BE BROUGHT TO OWNER AND DESIGNER'S ATTENTION.
- THE CONSTRUCTION MANAGER/CONTRACTOR SHALL FORWARD SUBMITTALS AND CUT SHEETS TO STIBLER ASSOCIATES (SA) FOR REVIEW AND APPROVAL.
- 4. SUPPLY AND INSTALL BLOCKING AS NEEDED FOR WALL LCDs, MILLWORK, SHELVING, ETC.

### MECHANICAL, ELECTRICAL, PLUMBING:

- LIFE SAFETY EQUIPMENT INCLUDING FIRE EXTINGUISHERS, PULL STATIONS, ETC. TO BE REVIEWED BY THE LOCAL BUILDING OFFICIALS. THE CURRENT BUILDING HAS A FIRE ALARM SYSTEM AND HAS AN AUTOMATIC FIRE SUPPRESSION SYSTEM.
- MECHANICAL SYSTEMS TO BE REVIEWED AND MODIFIED PER THE NEW PLAN AND COORDINATED/DESIGNED BY APPROPRIATE ENGINEER. BALANCE HVAC SYSTEMS TO ACCOMMODATE NEW LAYOUT AND COORDINATE LOCATIONS OF HVAC SUPPLY AND RETURN
- 7. SUPPLY AND INSTALL NEW LIGHTING FIXTURES AS NOTED.

RETAIN EXISTING MILLWORK CABINETS IN COFFEE NICHE 107 \$ 118.

3. PROVIDE & INSTALL HANGING ROD & SHELF IN COAT CLOSET 132.

4. PROVIDE (5) 15" DEEP ADJUSTABLE SHELVES IN EXECUTIVE CLOSETS.

5. PROVIDE BUILD-IN PLAM COUNTER \$ SOLID SURFACE LEDGE AT ADMIN 120.

SPECIFIC MILLWORK NOTES

8. REFER TO FURNITURE/ELECTRICAL PLAN FOR MORE INFORMATION ON POWER/DATA/VOICE.

2. SAVE \$ REUSE EXISTING CABINETS FROM OPEN AREA 104 TO REUSE IN BUS CENTER 122.

# DEMOLITION NOTES

DRAWING KEY

- THE CONTRACTOR, OR HIS SUBCONTRACTORS SHALL PROVIDE ALL DEMOLITION AS INDICATED ON DRAWINGS, OR AS REQUIRED FOR THE COMPLETE AND PROPER EXECUTION OF THE WORK.
- ALL METHODS, TECHNIQUES, AND PROCEDURES OF SAFETY, SHORING, BARRICADING, FENCING.PROTECTION. DEMOLITION. REMOVAL AND DISPOSAL ARE THE RESPONSIBILITY OF THE CONTRACTOR.
- THE CONTRACTOR SHALL PROVIDE PROPER DUST, FUME AND NOISE CONTROL THROUGHOUT ALL DEMOLITION.
- IT OCCURS. ALL MATERIALS SHALL BE PROPERLY DISPOSED OF OFF-SITE IN ACCORDANCE WITH APPLICABLE RULES, LAWS AND REGULATIONS. RECYCLE MATERIALS WHERE POSSIBLE.

4. ALL DEMOLITION WASTE, DEBRIS AND RUBBISH SHALL BE REMOVED FROM THE PREMISES AS

- 5. THE CONTRACTOR SHALL BE RESPONSIBLE FOR ALL PERMITS FOR DEMOLITION AND REMOVAL OF DEBRIS FROM SITE.
- REMOVE ALL EXISTING FINISHES, CARPET/VINYL BASE AND RELATED ADHESIVE, FLOORWALL TILE, GROUT, ETC AS NOTED ON PLAN. PREPARE EXISTING FLOOR, WALLS AND OTHER SURFACES FOR NEW FINISH MATERIALS.
- REMOVE THE EXISTING CEILING TILES AND GRID IN SELECT AREAS AND PROPERLY DISPOSE.
- 8. REMOVE AND PROPERLY DISPOSE OF LIGHT FIXTURES WHERE NOTED.

(EX) re-use existing doors where possible.

RE-USE EXISTING WINDOWS WHERE POSSIBLE.

9. PROTECT INTERIOR DOORS, INTERIOR WINDOWS & WINDOW TREATMENTS (VERTICAL BLINDS, WOOD BLINDS) DURING CONSTRUCTION. THESE WILL BE RETAINED/REUSED.

INDICATED DOOR TAG. NEW DOORS TO MATCH BUILDING STANDARD.

INDICATES INTERIOR WINDOW, MATCH BUILDING STANDARD.

## GLAZING

- PROVIDE GLASS TRANSOMS AT OFFICES TO MATCH EXISTING. HOLLOW METAL FRAME, MATCH BUILDING STANDARD, ALIGN HEADERS WITH DOORS.
- 2. REUSE EXISTING TRANSOM LIGHTS AT OFFICES WHERE POSSIBLE.
- 3. SEE WINDOW TYPES FOR MORE INFORMATION.

### DOORS

- PROVIDE NEW DOORS TO MATCH BUILDING STANDARD. SAME QUALITY & FINISH. ALL DOORS TO HAVE DOOR STOPS WITH WALL BUMPERS OR FLOOR STOPS WHERE REQUIRED.
- 2. REUSE DOORS WHERE POSSIBLE. KEEP LIKE DOORS TOGETHER WHERE POSSIBLE.
- 3. HARDWARE TO MATCHING EXISTING, LEVER HANDLE, ADA COMPIANT, COMMERCIAL. FINISH: US26D FOR ALL HARDWARE INCLUDING HANDLES, HINGES AND BUMBERS.
- 4. REFER TO DOOR SCHEDULE FOR LOCATIONS.
- 5. ALL DOORS TO BE LOCATED 4-6" FROM CORNER.
- 6. LOCKING/SECURITY INFORMATION SHALL BE PROVIDED BY TENANT.

INTERIOR DOOR TYPES WINDOW TYPES TYPE D2

SAME AS DI
WITH GLASS
VISION PANEL
IN DOOR
(TEMPERED) TYPE D3 TYPE WI TYPE W2


# DOOR SCHEDULE SIZE



3 Executive Park Drive Suite 106 Bedford, NH 03 1 10 www.stibler.com

(603) 623-8952

Copyright © 2017 by Stibler Associates No reproduction without permission

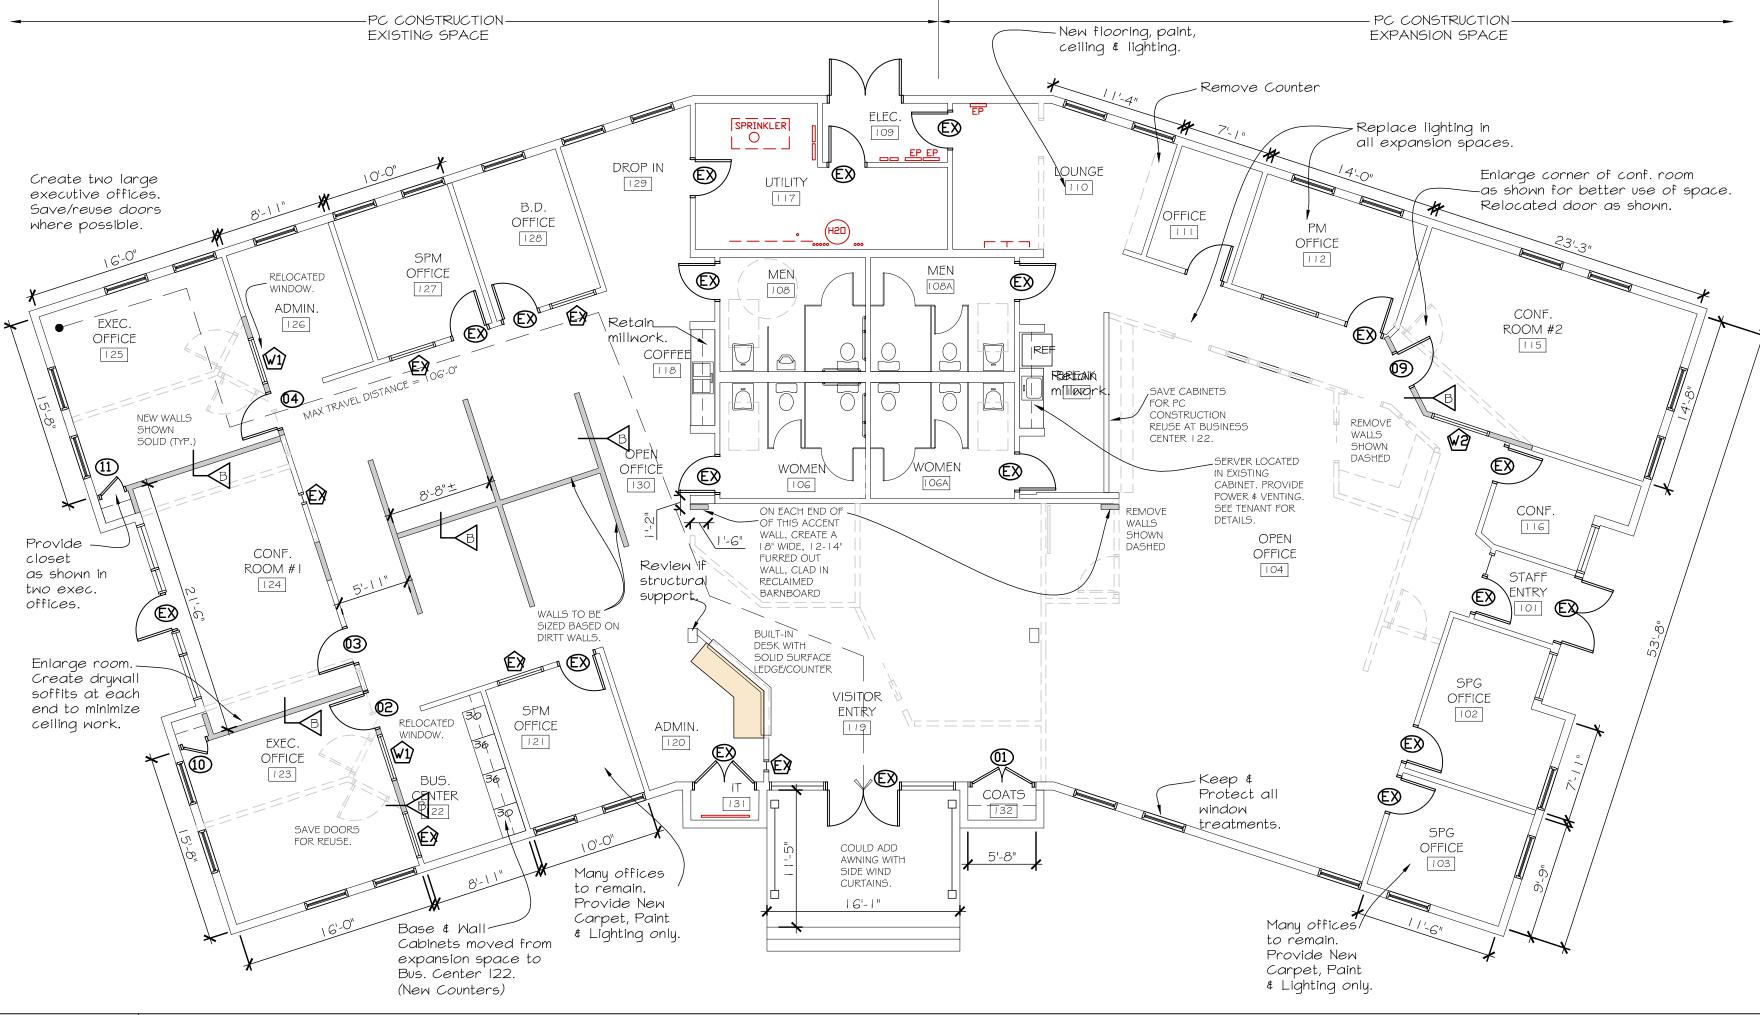

### CODE REVIEW BASED ON MAINE UNIFORM BUILDING CODE (MUBC) / IEBC 2009 / IBC 2009 / NFPA 101(2009) ALLOWABLE EXISTING BUILDING NEW CONSTRUCTION USE GROUP **B-BUISNESS B-BUISNESS** NO CHANGE IN USE PROPOSED SECTION 304. **BUILDING AREA** 18,000 SQ.FT 7,042 SQ.FT NO ADDITIONAL AREA TABLE 503 PROPOSED **BUILDING HEIGHT** NO ADDITIONAL HEIGHT 3 STORIES STORY TABLE 503 PROPOSED TYPE OF CONSTRUCTION TABLE 60 I TYPE VA - FIRE RESISTANT WOOD NO CHANGE PROPOSED FRAMED CONSTRUCTION FIRE PROTECTION EXISTING BUILDING IS FULLY EXISTING SYSTEM TO REMAIN SPRINKLERED IN ACCORDANCE WITH NFPA 13 300'-0" IN FULLY SPRINKLERED TRAVEL DISTANCE 106'-0" FROM EXEC. OFFICE 125 PER NFPA TABLE A7.6 TO EXIST. VISITOR ENTRY DOOR BUILDING OCCUPANCY LOAD BUSINESS USE (B): 100 SQ.FT. GROSS / OCCUPANT TABLE 1004.1.1 TOTAL AREA: 7,042 SQ. FT. / 100 SQ.FT. PER OCCUPANT = 70 OCCUPANTS ALLOWABLE PLUMBING FIXTURE COUNT BUSINESS OCCUPANCY: 70 ALLOWABLE OCCUPANTS (SEE ABOVE) PER UNIFORM PLUMBING ASSUMES 35 WOMEN / 35 MEN CODE TABLE 4-1 ALLOWABLE EXISTING BUILDING **NEW CONSTRUCTION** 16-35 FEMALE = 3 TOILETS REQ'D. 4 WOMEN'S TOILET NO CHANGE PROPOSED 2 WOMEN'S LAVATORY I LAVATORY REQUIRED 16-35 MALE = 2 TOILETS REQ'D. 3 MEN'S TOILETS IURINAL I LAVATORY REQUIRED 2 MEN'S LAVATORY

				E	
00 FOR PERMIT		03/06/2017			
REV.	v. DESCRIPTION		DATE		
Relian		D			



PC CONSTRUCTION OFFICE RENOVATION 131 PRESUMPSCOT ST.

SPACE PLAN, SCHEDULES, AND NOTES

PORTLAND, ME

SHEET TITLE:					
WBRC CAD FILE:			415700	_	A-1
PROJECT No.	415700	GRAPHIC SC.	ALE: O"		1
SCALE:	AS NOTED				
PM:	N/A	SHEET No.			
DRAWN BY:	AMC		A-1		
	DDD	1			

NEW SPACE PLAN (SHOWN WITH DEMO)

1/8" = 1'-0"