




ELEVATION VIEW OF SUGGESTED DETAIL FOR OPENINGS WITH JAMBS TO FINISH FLOOR IN THE PRESENCE OF A RAISED FOUNDATION WALL.

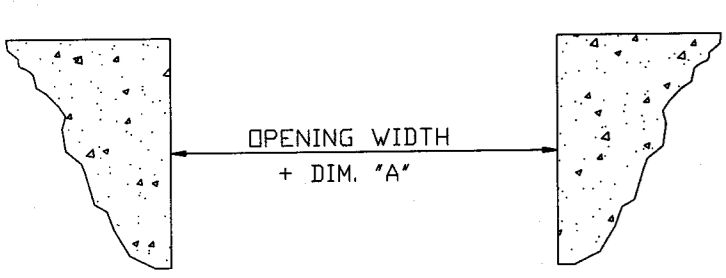


- \*A\* = 4 1/2' FOR PRE-ASSEMBLED PERSONNEL DOORS
- = 5 1/2' FOR KNOCK-DOWN PERSONNEL DOORS
- = 7 1/2' FOR OPENINGS WITH COLD-ROLLED JAMBS
- = 8' FOR OPENINGS WITH STRUCTURAL JAMBS

ROUGH OPENING SIZES ABOVE ARE FOR PASS DOORS AND FRAMED OPENINGS FURNISHED BY PSS.

FOUNDATION ENGINEER TO VERIFY WITH BUILDER ALL DOOR TYPES AND ASSOCIATED ROUGH OPENING SIZES. FOR DOORS NOT FURNISHED BY PSS, CONSULT DOOR SUPPLIER FOR OPENING DETAILS.



CLEARANCES SHOWN ARE MINIMUM REQUIRED FOR BASE CLIP. THERE MAY BE SMALL VOIDS BETWEEN JAMB FLANGES AND FOUNDATION WALL.

PLAN VIEW OF SUGGESTED DETAIL FOR FRAMED OPENINGS WITH JAMBS TO THE TOP OF A RAISED FOUNDATION WALL.







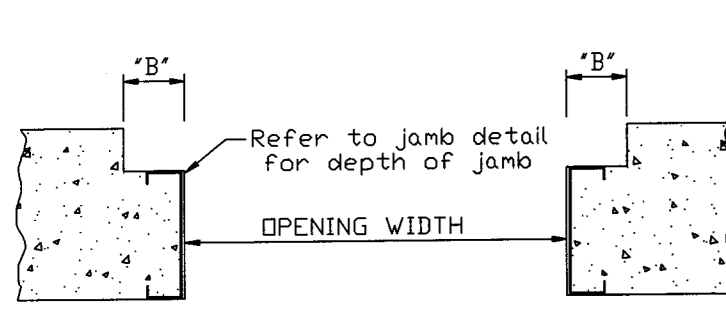


\*B\* = NOTCH FOR DOOR TRACK NOT BY PACKAGE STEEL SYSTEMS, INC. SEE MANUFACTURER RECOMMENDATIONS

\* SEE COLUMN BASE DETAILS

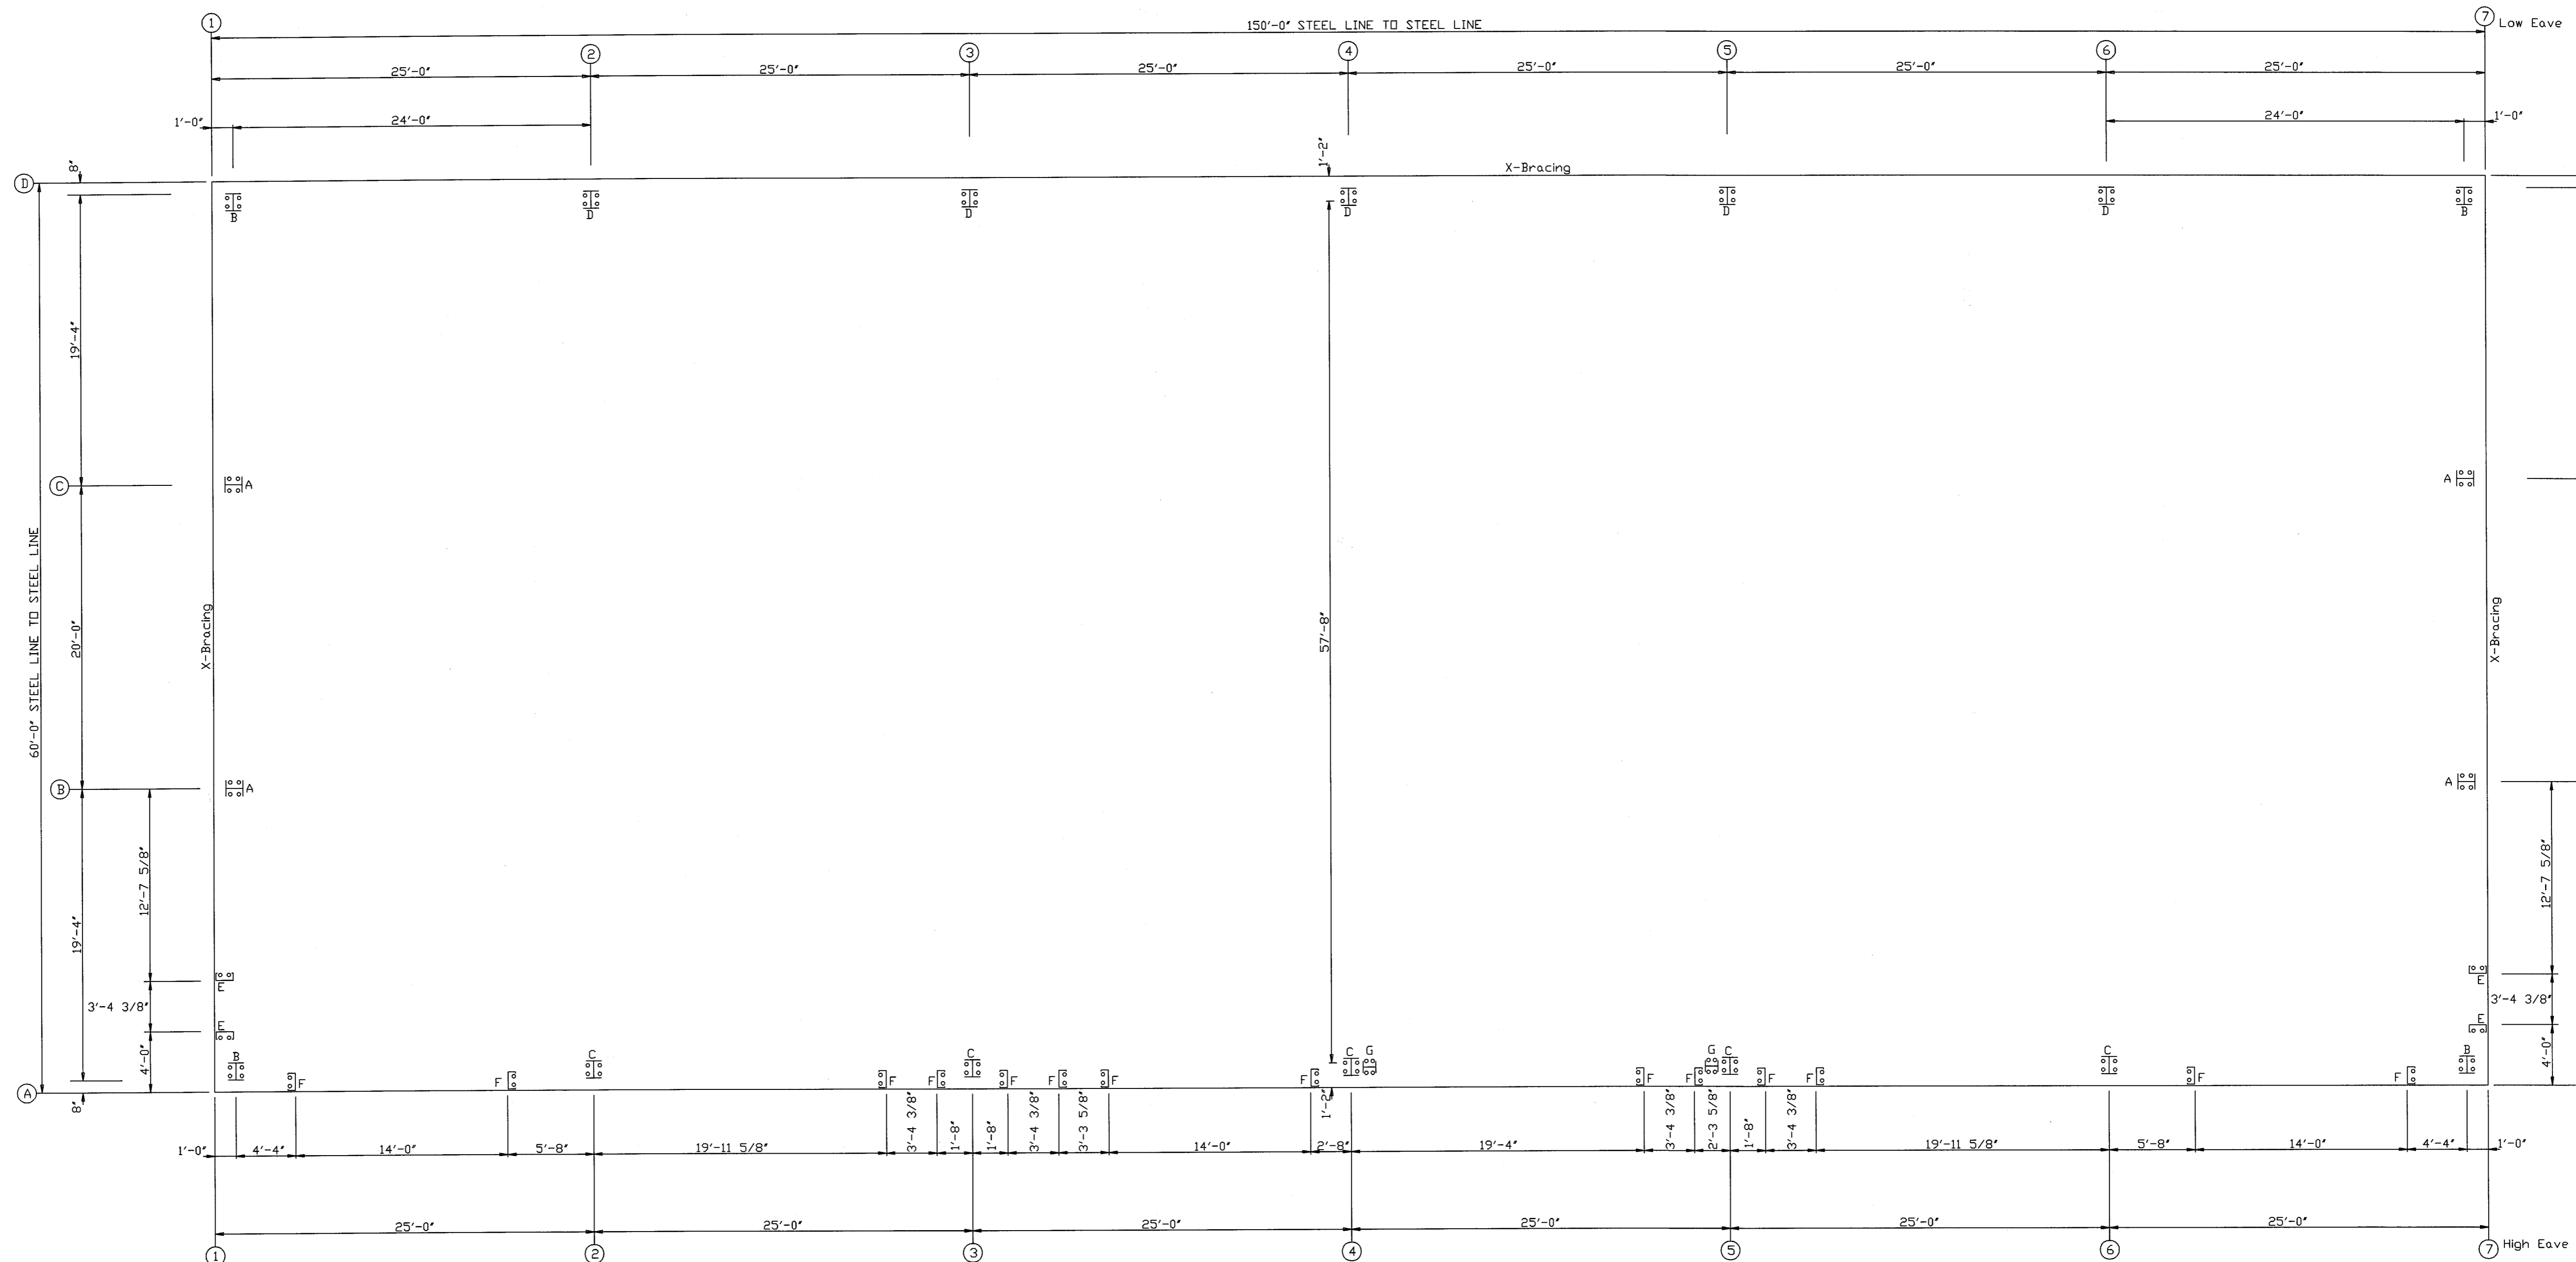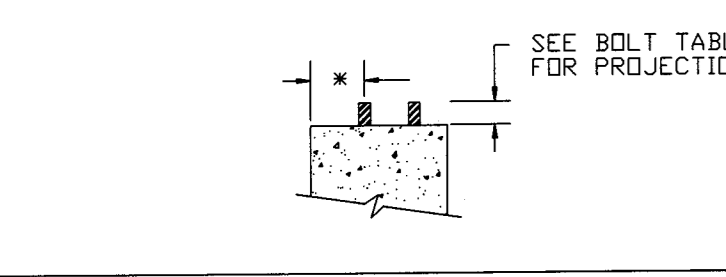

ANCHOR BOLT PLAN  
 NOTE: All Base Plates @ 100'-0" (UN.)

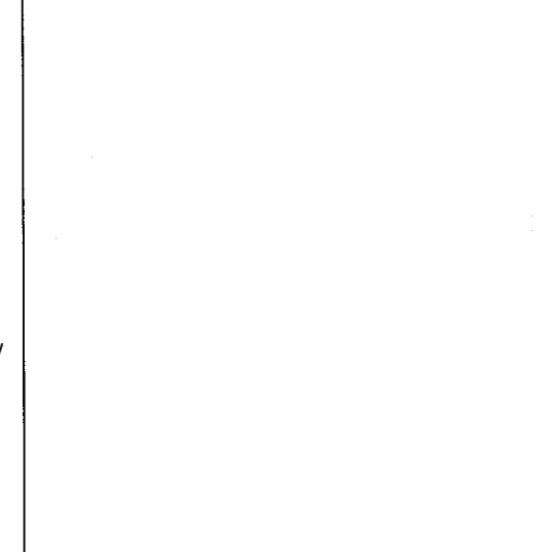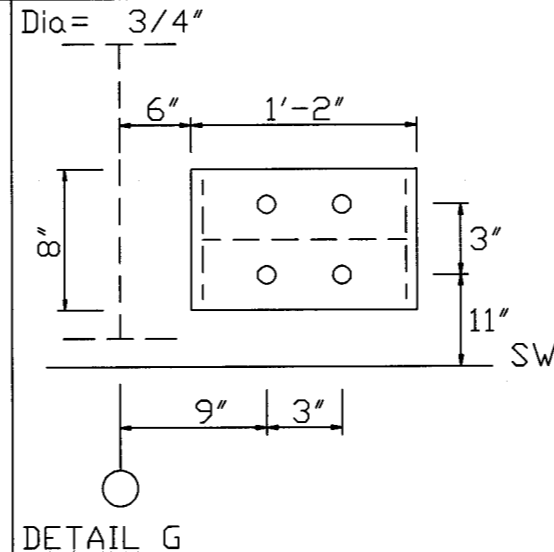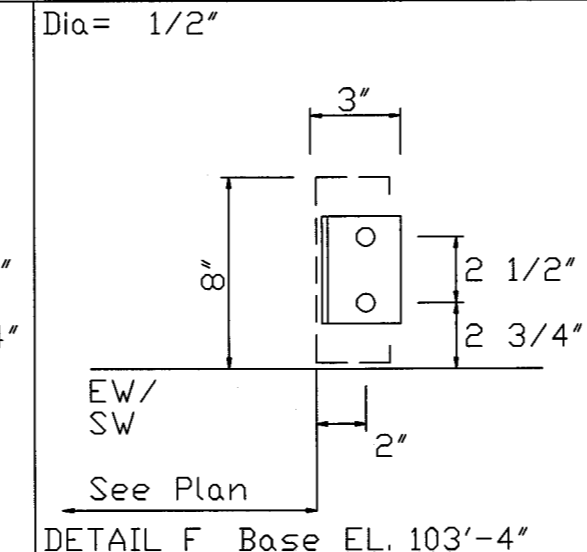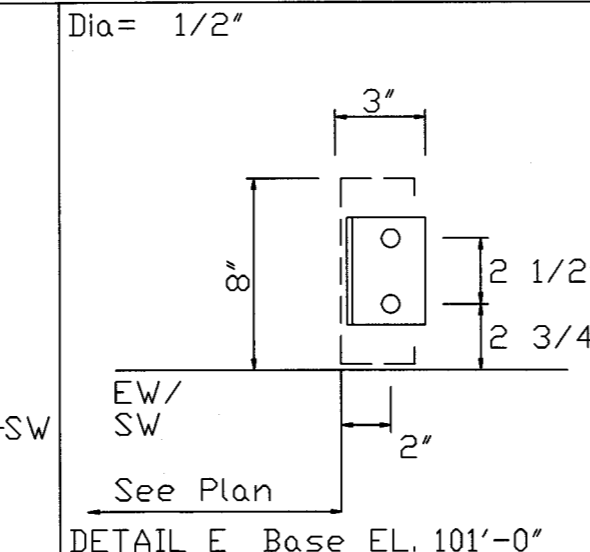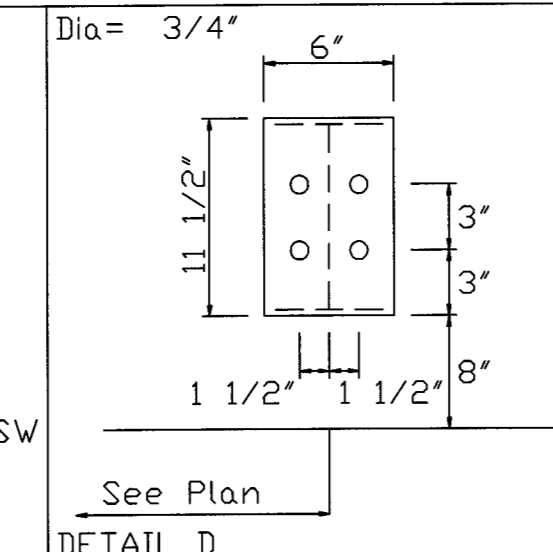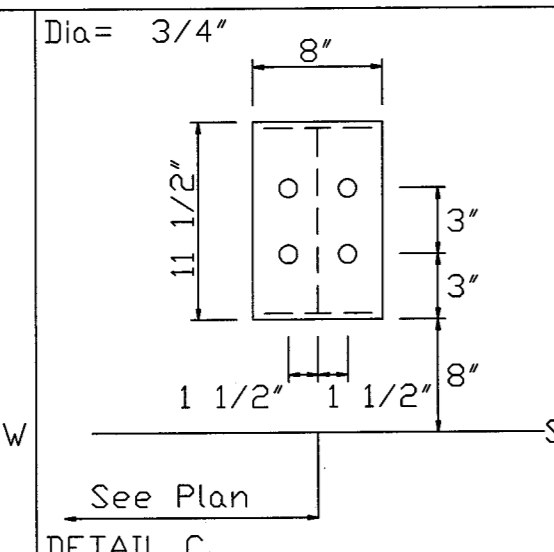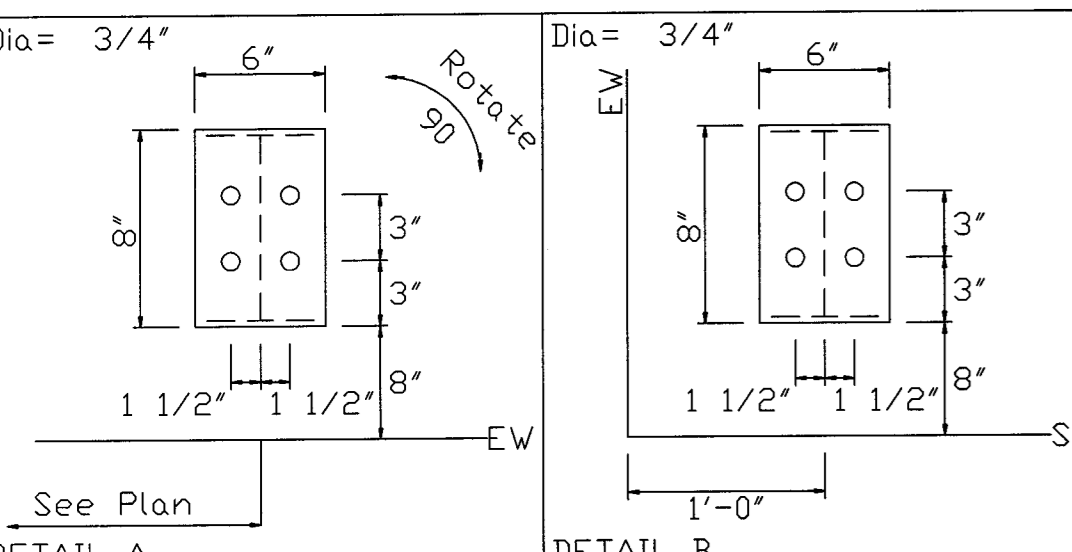


REV.	DESCRIPTION	DATE	DRAFT	ENG.
3				
2				
1				
▲	INITIAL DRAWING RELEASED FOR CONSTRUCTION			CURRENT REVISION: 0
PACKAGE STEEL SYSTEMS, INC.		Biskup Construction Inc.		
PROJECT	320 P Street LLC	ANCHOR BOLT PLAN & DETAILS		
ID	1805-076	DESIGN: ZRM	DESIGN CHECK: ZRM	
PROJECT	314 Presumpscott St.	DRAFT: TMZ	DRAFT CHECK: TMZ	
ADDRESS	Portland, ME 04103	DATE: 5/30/18	DRAWING: ABLT-1	





Reviewed for Code Compliance  
Permitting and Inspections Department  
Approved with Conditions  
07/23/2018

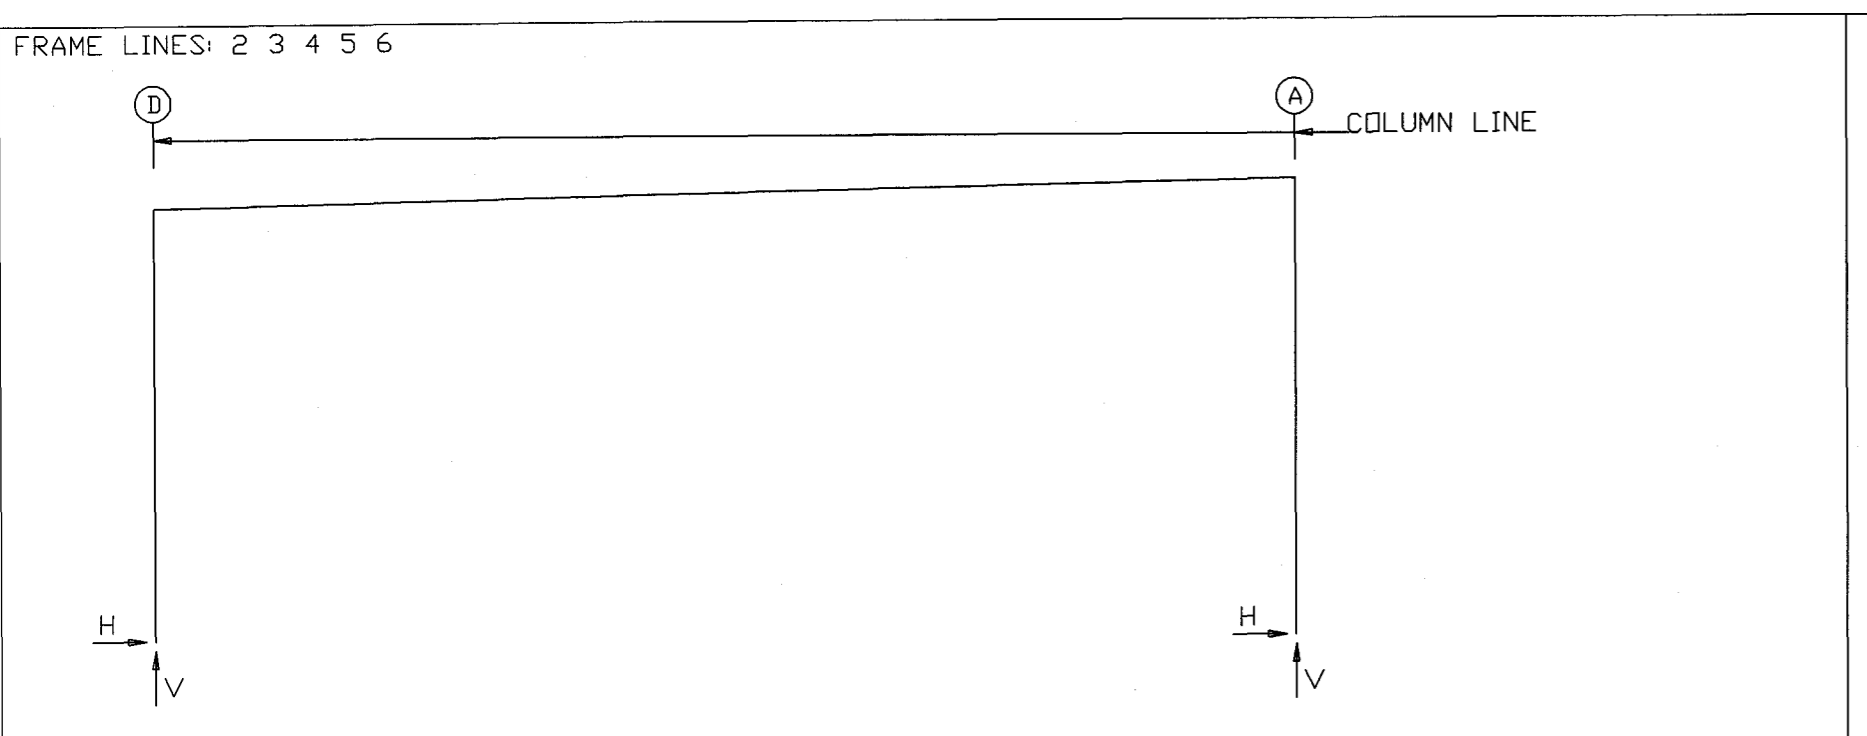

**RIGID FRAME: MAXIMUM REACTIONS, ANCHOR BOLTS, & BASE PLATES**

Frm Line	Col Line	Load Id	Column Reactions (k)			Bolt Qty	Base Plate (in)			Base EL. (in)	
			Hmax	Vmax	Hmin		Width	Length	Thick		
2*	D	1	17.5	39.6	2	4	0.750	6.000	11.500	0.375	0.0
2*	A	3	4.6	-5.0	5	4	0.750	8.000	11.500	0.375	0.0
2*		Frame Lines: 2 3 4 5 6									

**RIGID FRAME: BASIC COLUMN REACTIONS (k)**

Frm Line	Column Line	Dead		Live		Snow		Wind Left		Wind Right	
		Horz	Vert	Horz	Vert	Horz	Vert	Horz	Vert	Horz	Vert
2*	D	-2.1	5.4	1.1	2.7	6.8	15.0	14.4	31.4	-12.5	-20.4
2*	A	-2.1	5.7	-1.1	2.3	-6.8	15.0	-14.4	31.6	3.2	-16.4
2*		Frame Lines: 2 3 4 5 6									

**ENDWALL COLUMN: BASIC COLUMN REACTIONS (k)**

Frm Line	Col Line	Dead Vert	Collat Vert	Live Vert	Snow Vert	Wind Left		Wind Right		Wind Press Horz
						Horz	Vert	Horz	Vert	
1	D	0.9	0.3	2.2	4.6	0.0	-3.5	0.0	-2.1	-2.5
1	C	1.9	0.8	5.6	11.8	3.5	-13.0	0.0	-0.5	-4.7
1	B	2.0	0.8	5.6	11.8	0.0	-5.4	4.3	-10.1	-4.8
1	A	0.9	0.3	2.2	4.6	0.0	-3.5	0.0	-2.1	-2.6

**ENDWALL COLUMN: MAXIMUM REACTIONS, ANCHOR BOLTS, & BASE PLATES**

Frm Line	Col Line	Load Id	Column Reactions (k)			Bolt Qty	Base Plate (in)			Base EL. (in)	
			Hmax	Vmax	Hmin		Width	Length	Thick		
1	D	6	1.7	-1.6	7	4	0.750	6.000	8.000	0.375	0.0
1	C	9	3.1	-6.7	7	4	0.750	6.000	8.000	0.375	0.0
1	B	11	3.2	-4.9	7	4	0.750	6.000	8.000	0.375	0.0
1	A	6	1.8	-1.6	7	4	0.750	6.000	8.000	0.375	0.0
7	A	6	1.8	-1.6	7	4	0.750	6.000	8.000	0.375	0.0
7	B	9	3.2	-4.9	7	4	0.750	6.000	8.000	0.375	0.0
7	C	11	3.1	-6.7	7	4	0.750	6.000	8.000	0.375	0.0
7	D	6	1.7	-1.6	7	4	0.750	6.000	8.000	0.375	0.0

**NOTES FOR REACTIONS**

- The following Design Data is per Package Steel Systems, Inc.'s standard design practices and established procedures and recommendations of the following Organizations and/or Specifications:  
American Institute of Steel Construction (AISC 2005)  
American Welding Society Structural Welding Code (AWS D11)  
North American United States (NAUS07)
- For maximum reactions tables, all loading conditions are examined and only the maximum/minimum horizontal or vertical reactions along with the corresponding horizontal or vertical for each load ID are reported.
  - Positive reactions are shown in the sketch. Foundation loads are in the opposite directions.
  - Bracing reactions are in the plane of the brace with the horizontal pointing away from the braced bay. The vertical reaction can be downward or upward.
  - Reactions given are based on the design data below. Reactions are not furnished for loads not listed.
  - The endwall column reaction tables include wind and seismic reactions from the endwall bracing. Horizontal reactions shown in the tables, except for "Wind Press" and "Wind Suct" are in the plane of the wall, perpendicular to the web of the columns.
  - The rigid frame reaction tables include the vertical component of the wind and seismic reaction from the sidewall bracing. The horizontal component of the sidewall bracing from wind and seismic is in the plane of the wall, perpendicular to the web of the columns and should be combined with the appropriate basic column reactions to determine the maximum reactions for foundation design.
  - Foundation construction and design is not the responsibility of Package Steel Systems, Inc. The embedment of the anchor bolts in concrete is the responsibility of the foundation designer.
  - Suggested anchor rod diameter, quantity, minimum projection and placement are shown. All anchor rods are assumed to be ASTM F1544 Grade 36 or equal. Anchor rods (not by PSS) shall be set to a tolerance of  $\pm 1/8"$  in both elevation and location.
  - Column base plates are designed not to exceed a bearing pressure of 1050 pounds per sq. inch ( $0.35F_c$  where  $F_c = 3000$  psi) unless noted otherwise.
  - Basic design wind pressure is furnished for components and cladding not specifically designed and/or furnished by PSS, the design pressures and suction shall be increased based on tributary area and location. Confirmation of the design loads and adequacy to resist such loads shall be the responsibility of a licensed design professional by others.

Building Reactions are based on the following information:

<b>Governing Code:</b> IBC 15	<b>Building Risk Category:</b> II - Normal
<b>Occupancy Classification:</b> Mixed, Group B Business & F-1 Moderate Hazard Factory Industrial	
<b>Building Size:</b>	<b>Snow Loads:</b>
Width (ft): 60'-0"	Ground Snow (Pg): 60.00 psf
Length (ft): 150'-0"	Flat Roof Snow (PF): 42.00 psf
Back Side Eave Height (ft.): 22'-9"	Minimum Uniform Snow: 4.20 psf
Front Side Eave Height (ft.): 24'-9"	Snow Exposure Factor (Ce): 1.00
Back Side Roof Slope: 0.25:12	Snow Thermal Factor (Ct): 1.00
Front Side Roof Slope:	Snow Importance Factor (Is): 1.00
	Sloped Roof Factor (Cs): 1.00

**Roof Dead, Collateral, & Live Loads:**

Dead Load	5.00 psf	<b>Seismic Importance (Ie)</b>	1.00
Collateral Load	3.00 psf	<b>Seismic Design Category (A/B/C/D)</b>	B
Live Load	20.00 psf	<b>Site Class/Type</b>	D
Live Load Reduction Taken	No	<b>Seismic Response Coeff. (Sds)</b>	0.259
		<b>Seismic Response Coeff. (Sd1)</b>	0.126
		<b>Response Modification (Rf)</b>	3.50
		<b>Response Modification (Rm)</b>	5.00
<b>Wind Loads:</b>		<b>Design Base Shear (V) = Longit.</b>	11.36 kips
Ultimate Wind Speed	118 mph	<b>Design Base Shear (V) = Transv.</b>	12.70 kips
Serviceability Wind	76 mph(10yrMRD)	<b>Analysis Procedure: Equivalent Lateral Force</b>	
Wind Exposure	C	<b>Auxiliary Loads:</b>	
Building Enclosure (D/C/P)	Closed	(3) 250# Unit Heaters Hung From Roof Purlins	
Internal Pressure Coeff. (GCp)	+0.18		

**WIND BENT REACTIONS**

Wall Loc	Col Line	Reactions (k)		Seismic (k)		Bolt Qty	Bolt Dia	Base Plate (in)	
Line	Line	Horz	Vert	Horz	Vert	Qty	Dia	Width	Length
F_SW	A	4	3.8	7.4	3.3	6.5	4	0.750	8.000
F_SW	A	5	3.8	7.4	3.3	6.5	4	0.750	8.000

**BUILDING BRACING REACTIONS**

Wall Loc	Col Line	Reactions (k)		Panel Shear (lb/ft)	
Line	Line	Horz	Vert	Note	
L_EW	C,B	4.3	4.7	0.9	1.0
F_SW	A	4.5	4.7	0.9	1.0
R_EW	B,C	4.3	4.7	0.9	1.0
B_SW	D	5.4	7.4	6.2	4.7

(a) Wind bent in bay

**ANCHOR BOLT SUMMARY**

Qty	Locate	Dia (in)	Type	Proj (in)
0 36	Jamb	1/2"	A307	1.50
0 32	Endwall	3/4"	A307	2.00
0 40	Frame	3/4"	A307	2.00
0 8	WindCol	3/4"	A307	2.00

**General Notes**

**Design Responsibility:**  
Package Steel Systems, Inc. (PSS) is responsible only for the structural design of the Metal Building System it sells to the Builder. Neither PSS nor PSS's Engineer is the Design Professional or the Engineer of Record for the Construction Project. PSS is not responsible for the design of any components or materials manufactured or supplied by others or their interaction and connection to the Metal Building System unless such design responsibility is specifically required by the Order Documents.

**Close Proximity Structures:**  
PSS is not responsible for loads (Seismic, Snow, etc.) imposed by, field modifications needed on, or structures in close proximity to this structure. It is the Builder's responsibility to verify that close proximity structures, together with their foundations, are capable of resisting all additional loads that may result from this structure.

**Bracing:**  
Metal building brace rods and cables work in pairs to balance the forces caused by initial tensioning. Care must be taken when tightening brace rods or cables so as not to cause accidental damage or misalignment of building components. All rods/cables must be installed loose and then tightened sequentially and equally to maintain proper alignment of components. When properly tightened, rods and cables should not exhibit excessive sag. For long or large rod bracing it may be necessary to support the rod at mid-bay by suspending it from a purlin at the appropriate elevation.

A qualified professional engineer must design bracing for seismic or wind loading of suspended objects that are not part of the PSS structure. The design must meet code requirements and safely deliver the lateral loads to one of the PSS primary bracing systems. In addition, the bracing must be designed and erected in a manner that will not impose torsional or minor axis loads, or cause local failures in any PSS structural components. No material may be cut, drilled, or otherwise removed from any part of this building without the written consent of PSS. The engineer CANNOT rely on the roof deck to act as a diaphragm. PSS accepts no responsibility for the design and installation of bracing for objects that are not furnished or specified by PSS.

**Field Work:**  
All local, state, and federal safety regulations are to be strictly followed. Temporary supports or bracing required for the building erection is the responsibility of the erector to determine, furnish and install. It is the responsibility of the Builder/Contractor to obtain appropriate approvals and necessary permits from city, county, state, or federal agencies, as required.

PSS provides complete components to erect all projects with minimal modifications. However, minor fieldwork of structural, secondary, panel, and trim items may be necessary to ensure proper fit. Such work is considered a normal part of metal building erection. Back charges for minor fieldwork will not be honored.

Welds shall be made only by operators certified by the standard qualifications procedure of the American Welding Society for the type of weld required. All field welds to be done using E70XX electrodes and in accordance with the American Welding Society Structural Welding Code.

**A325 Bolt Tightening Requirements**  
All high strength bolts are A325-N unless specifically noted otherwise. Structural bolts shall be tightened by the TURN-OF-THE-NUT method in accordance with the ninth-edition AISC "Specifications for Structural Joints using ASTM A325 or A490 Bolts" per section 8D.1. A325 bolts may be installed without washers when tightened by the TURN-OF-THE-NUT method. All high strength bolts, except as noted otherwise, are subject to direct tension and may require inspection as defined by AISC/RCS "Specifications for Structural Joints using ASTM A325 or A490 Bolts and the applicable building code or standard. It is the responsibility of the erector to assure proper tightness.

PSS accepts no responsibility for the consequences of any additions or alterations to this structure. Modifications to this structure must be performed under the supervision of a qualified licensed professional engineer who accepts responsibility for the adequacy and consequences of the additions or alterations.

The primary and secondary framing of this building may have been designed to support additional collateral loads (These loads may include sprinkler systems, mechanical equipment, ducts, ceilings, etc.). Care must be exercised however, to prevent local overstress of light gauge secondary members supporting concentrated loads.

**Masonry & Concrete:**  
PSS accepts no responsibility for the design of masonry walls, concrete walls, foundations, mezzanine slabs, and floor slabs. Also, the attachment to masonry or concrete is not designed or supplied by PSS (Masonry anchor sizes, spacing, and quantity, unless specifically stated will be designed and supplied by others). The engineer responsible for the design of the masonry and concrete is also responsible for ensuring that the design (including wall base details) is compatible with the deflection criteria for this building. Eave purlins and rake channels are not designed to support lateral loads from masonry or other walls not by PSS. Values given for bends and anchor bolt total lengths are suggested lengths only. It is the responsibility of the foundation engineer to determine these values since they are a function of concrete strength as well as other factors.

Base plates are designed assuming concrete has a minimum strength of 3000 psi at 28 days unless otherwise noted.

Jamb foundations should be designed for a shear of 2 kips unless otherwise stated.

**Independent Mezzanines:**  
Independent mezzanines must be designed by a qualified professional engineer to meet all code requirements. The engineer must also ensure that proper isolation from the PSS building has been provided to avoid contact with PEMB structure due to differential movement. PSS accepts no responsibility for the design of independent mezzanines.

**Parapets:**  
Buildings with parapet walls and internal gutters must be furnished with rainwater overflow mechanisms (such as scuppers) to prevent the accumulation of water in the event of a gutter blockage. It is the responsibility of the Builder to make sure that the scuppers are of the appropriate size, quantity, location, and design to prevent water accumulation on the roof. Failure to do so can result in building collapse. PSS accepts no responsibility for the design and installation of overflow mechanisms.

MATERIALS:	ASTM DESIGNATIONS:	YIELD STRENGTH:
Structural Steel Plate (Built-up Sections)	A529 Grades 50 & 55 A572 Grades 50 & 55 A1011 HSLAS Grades 50 & 55	50 ksi 50 ksi 50 ksi
Hot Rolled Mill Shapes (WF, Channels, Angles)	A36 A572 Grades 50 A992	36 ksi 50 ksi 50 ksi min.
Round Struct. Tubing - Pipe	A500 Grade B	42 ksi
Shaped Struct. Tubing- Tube	A500 Grade B	46 ksi
Cold Formed Shapes (Purlins, Girts, Eave Struts)	A653 (SS) Grade 50 Class 1, 2, 3 A653 (HSLAS) Grade 50, Types A or B	55 ksi min. 55 ksi min.
Roof and Wall Sheets	A653/A792 SS Grade 50 Class 1 or 2 (A255 Coating) A755/A792 SS Grade 50 Class 1 or 2 (A250 Coating)	50 ksi 50 ksi
Brace Rods	A529	50 ksi
Brace Angles	A36	36 ksi
Structural Cables (Cable Bracing)	A475 7-wire EHS Grade	
Cable Hardware	A536 Grade 65-45-12	45 ksi
Bolts	A307 Grade A SAE-J429 Grade 2 A325 Type 1	60 ksi (tensile strength) 120 ksi, 105 ksi
Nuts	A563 Grade A SAE-J995 Grade 2 A563 Grade C, D or DH (A325)	
Washers (Hardened)	F436 Type 1	
Washers (Plain)	F844	
Anchor Bolts	A307 unless otherwise noted	


REV.	DESCRIPTION:	DATE:	DRAFT	ENG.
3				
2				
1	REVISED WIND EXPOSURE TO "C"	6/05/18	TMZ	ZRM
	INITIAL DRAWING RELEASED FOR CONSTRUCTION			
PACKAGE STEEL SYSTEMS, INC.		CURRENT REVISION: 1		
PROJECT	320 P Street LLC	Biskup Construction Inc.		
ID	1805-076	DESIGN: ZRM	DESIGN CHECK: ZRM	
PROJECT	314 Presumpscott St.	DRAFT: TMZ	DRAFT CHECK: TMZ	
ADDRESS	Portland, ME 04103	DATE: 5/30/18	DRAWING: ARI T-2	





Reviewed for Code Compliance  
Permitting and Inspections Department  
Approved with Conditions  
07/23/2018

N/F  
OCEAN WOODS CONDOMINIUMS  
8584/75

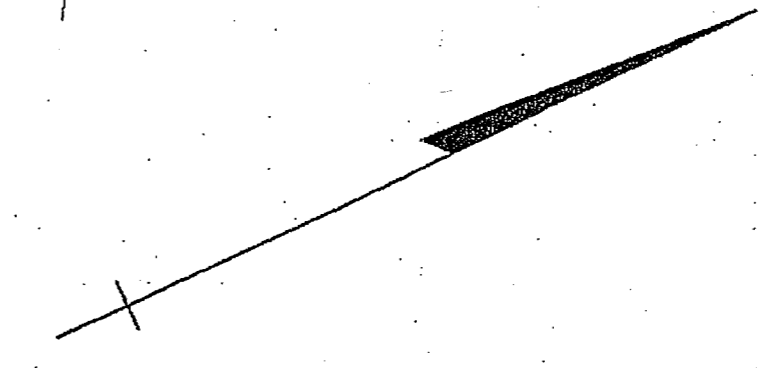

**NOTES**

- 1) BEARINGS ARE REFERENCED TO MAGNETIC NORTH 1994.

**OWNER OF RECORD**

JAKES DEVELOPMENT, INC.

**AREA**

AREA = 55,691.40 sq. ft.  
1.28 acres

**LEGEND**

- IRON PIN FOUND (3/4" solid unless noted)
- IRON PIN SET (5/8" rebar)
- N/F NON OR FORMERLY OF
- UTILITY POLE
- SEWER MANHOLE
- ⊗ WATER VALVE
- WOOD FENCE
- STONE WALL
- - - EDGE OF PAVEMENT
- - - EDGE OF GRAVEL
- ▭ EXISTING BUILDING

N/F  
TIMOTHY E. SANDERS  
ANNE S. MYERS  
MARION SANDERS  
6989/257

N/F  
ABRAHAM SHAPAZIAN  
6711/335

N/F  
JOHN D. Jr. & MARY E. MANCINI  
8298/106

N/F  
RUTH B. SLOCUM  
CLAYTON F. SLOCUM  
4393/242

N/F  
RONALD T. & DOROTHY L. LONG  
6544/63


N/F  
TIM O'DONOVAN  
11796/245  
AREA 16,239.09-sq. ft.

PRESUMPCOT STREET

This survey conforms to category I condition III as defined by the standards of the Maine State Board of Registration for Land Surveyors dated 1985. Except as noted.

KEVIN N. CULLENBERG PLS 1278

*Kevin N. Cullenberg*

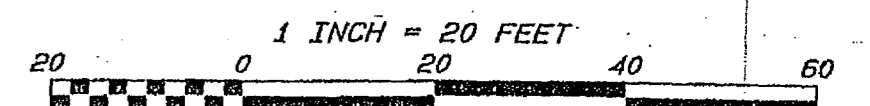

STANDARD BOUNDARY SURVEY  
**PLAN OF PROPERTY**  
PRESUMPCOT STREET PORTLAND, MAINE  
made for  
**TIM O'DONOVAN**  
30 LEDGEWOOD DRIVE FALMOUTH, MAINE  
May 4, 1995  
**CULLENBERG LAND SURVEYING**  
892 OLD DANVILLE ROAD  
AUBURN, MAINE 04210  
777-1150



LANDSCAPE NOTES:

- PRIOR TO THE START OF ANY EXCAVATION FOR THE PROJECT BOTH ON AND OFF THE SITE, THE CONTRACTOR SHALL NOTIFY DIGSAFE AND BE PROVIDED WITH A DIGSAFE NUMBER INDICATING THAT ALL EXISTING UTILITIES HAVE BEEN LOCATED AND MARKED.
- LANDSCAPE CONTRACTOR IS ENCOURAGED TO PROVIDE THE LANDSCAPE ARCHITECT WITH CONCERNS AND/OR SUGGESTIONS WITH REGARDS TO PROPOSED PLANT MATERIAL SELECTION PRIOR TO PLACING A PURCHASE ORDER.
- THE LANDSCAPE CONTRACTOR SHALL SUPPLY ALL PLANT MATERIALS IN QUANTITIES SUFFICIENT TO COMPLETE ALL PLANTINGS SHOWN GRAPHICALLY ON THIS DRAWING. CLARIFY ANY DISCREPANCIES WITH THE LANDSCAPE ARCHITECT PRIOR TO PRICING ANY PLANT MATERIAL.
- ALL PLANT MATERIALS SHALL CONFORM TO THE GUIDELINES ESTABLISHED BY THE LATEST EDITION OF THE AMERICAN ASSOCIATION OF NURSERYMEN'S "AMERICAN STANDARD OF NURSERY STOCK".
- ALL PLANT MATERIALS ARE SUBJECT TO THE APPROVAL OF THE OWNER'S REPRESENTATIVE AT THE SITE. PLANTS WHICH ARE REJECTED SHALL BE REMOVED FROM THE SITE IMMEDIATELY AND REPLACED AT NO ADDITIONAL COST TO THE OWNER.
- ALL TREES AND SHRUBS TO BE BALLED IN BURLAP OR CONTAINERIZED.
- MULCH FOR PLANTED AREAS TO BE AGED SPRUCE AND FIR BARK, PARTIALLY DECOMPOSED, DARK BROWN IN COLOR AND FREE OF WOOD CHIPS THICKER THAN 1/4 INCH.
- NO PLANTS SHALL BE PLANTED BEFORE ACCEPTANCE OF ROUGH GRADING AND BEFORE CONSTRUCTION HAS BEEN COMPLETED IN THE IMMEDIATE AREA.
- ALL SHRUB GROUPINGS SHALL BE INCORPORATED INTO BEDS. WHERE MULCHED PLANT BED ABUTS LAWN, CONTRACTOR SHALL PROVIDE A TURF CUT EDGE.
- ALL TREES ALONG SIDEWALK AND PARKING AREAS SHALL BEGIN BRANCHING AT 6' HT. MIN.
- ALL PLANT MATERIAL OR REPRESENTATIVE SAMPLES SHALL BE LEGIBLY TAGGED WITH PROPER COMMON AND BOTANICAL NAMES. TAGS SHALL REMAIN ON THE PLANTS UNTIL FINAL ACCEPTANCE.
- CONTRACTOR SHALL LOAM DISTURBED AREAS AS FOLLOWS:  
- LIMITED MAINTENANCE SEEDING AREAS 4" DEPTH OF TOPSOIL  
- LAWN AREAS 6" DEPTH OF TOPSOIL
- SEED MIXTURE FOR DISTURBED AREAS SHALL BE THE "PARK MIX" AS MIXED AND DISTRIBUTED BY ALLEN STERLING & LOTHROP OF FALMOUTH MAINE OR APPROVED EQUIVALENT. SEED AT THE RATE RECOMMENDED BY THE DISTRIBUTOR, BUT IN NO CASE LESS THAN 5LBS. PER 1,000 S.F.
- CONTRACTOR SHALL BEGIN MAINTENANCE IMMEDIATELY AFTER PLANTING AND WILL CONTINUE UNTIL FINAL ACCEPTANCE. CONTRACTOR SHALL BE RESPONSIBLE FOR ALL MEANS AND METHODS OF WATERING AND MAINTENANCE.
- THE LANDSCAPE CONTRACTOR SHALL GUARANTEE ALL PLANT MATERIALS FOR ONE (1) FULL YEAR FROM DATE OF FINAL ACCEPTANCE.
- SCREENED IMAGES SHOW EXISTING CONDITIONS. WHERE EXISTING CONDITIONS LIE UNDER OR ARE IMPINGED UPON BY PROPOSED BUILDINGS AND OR SITE ELEMENTS, THE EXISTING CONDITION WILL BE REMOVED, ABANDONED AND OR CAPPED OR DEMOLISHED AS REQUIRED.
- TREE SAVE MEASURES TO BE LOCATED IN THE FIELD AS PART OF THE PRECONSTRUCTION MEETINGS WITH THE CITY OF PORTLAND.

PLANT LIST:

SYMBOL	BOTANICAL NAME	COMMON NAME	QTY	SIZE	COMMENTS
TREES, SHRUBS, GROUNDCOVERS & HERBACEOUS MATERIALS					
AF	ACER X FREEMANII 'AUTUMN BLAZE'	AUTUMN BLAZE FREEMAN MAPLE	3	2" CAL.	SINGLE LEADER, B4B, SPECIMEN
AXG	AMELANCHIER X S. 'AUTUMN BRILLIANCE'	AUTUMN BRILLIANCE AMELANCHIER	3	6' HT.	CLUMP
BNH	BETULA NIGRA 'HERITAGE'	HERITAGE RIVER BIRCH	2	10' HT.	CLUMP, B4B
HM	HYDRANGEA M. 'BLOOMSTRUCK'	BLOOMSTRUCK HYDRANGEA	7	20" HT.	FULL & BUSHY
HS	HEMEROCALLIS STELLA D'ORO	STELLA D'ORO DAYLILY	19	1 GAL.	-
JCG	JUNIPERUS CHINENSIS 'CASINO GOLD'	CASINO GOLD CHINESE JUNIPER	19	20" HT.	FULL & BUSHY
PO	PICEA OMORICA	SERBIAN SPRUCE	2	6' HT.	B4B, FULL & BUSHY
RPC	RHODODENDRON P.J.M. CONTACT FORM	COMPACT P.J.M. RHODODENDROM	5	24" HT.	FULL & BUSHY
TOB	THUJA O. MR. BOWLING BALL	MR. BOWLING BALL ARBORVITAE	5	24" HT.	FULL & BUSHY




CITY LANDSCAPING REQUIREMENTS:

STREET TREES - 1 STREET TREE REQUIRED EVERY 30'-45' ON CENTER IN THE CITY R.O.W ALONG STREET FRONTAGE. FRONTAGE = APPROXIMATELY 127' (NOT INCLUDING THE ENTRANCE DRIVE)/45 = 2.8 OR 3 STREET TREES REQUIRED.

SITE LANDSCAPING, UNDERSTORY PLANTINGS - 6 SHRUBS PER 45' OF FRONTAGE 159'/45' = 3.5x6 = 21 SHRUBS REQUIRED.

PARKING LOT LANDSCAPING - WAIVER REQUESTED.

LEGEND:

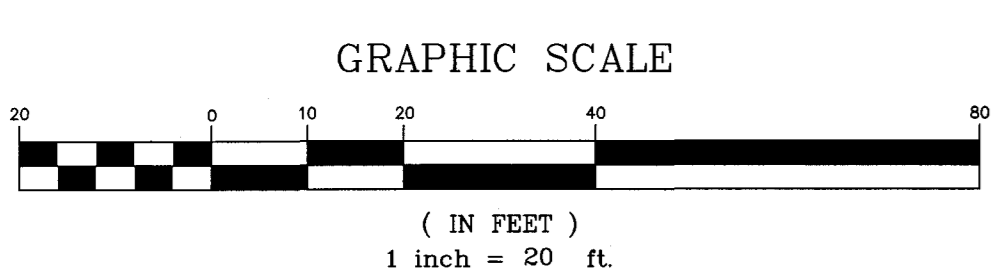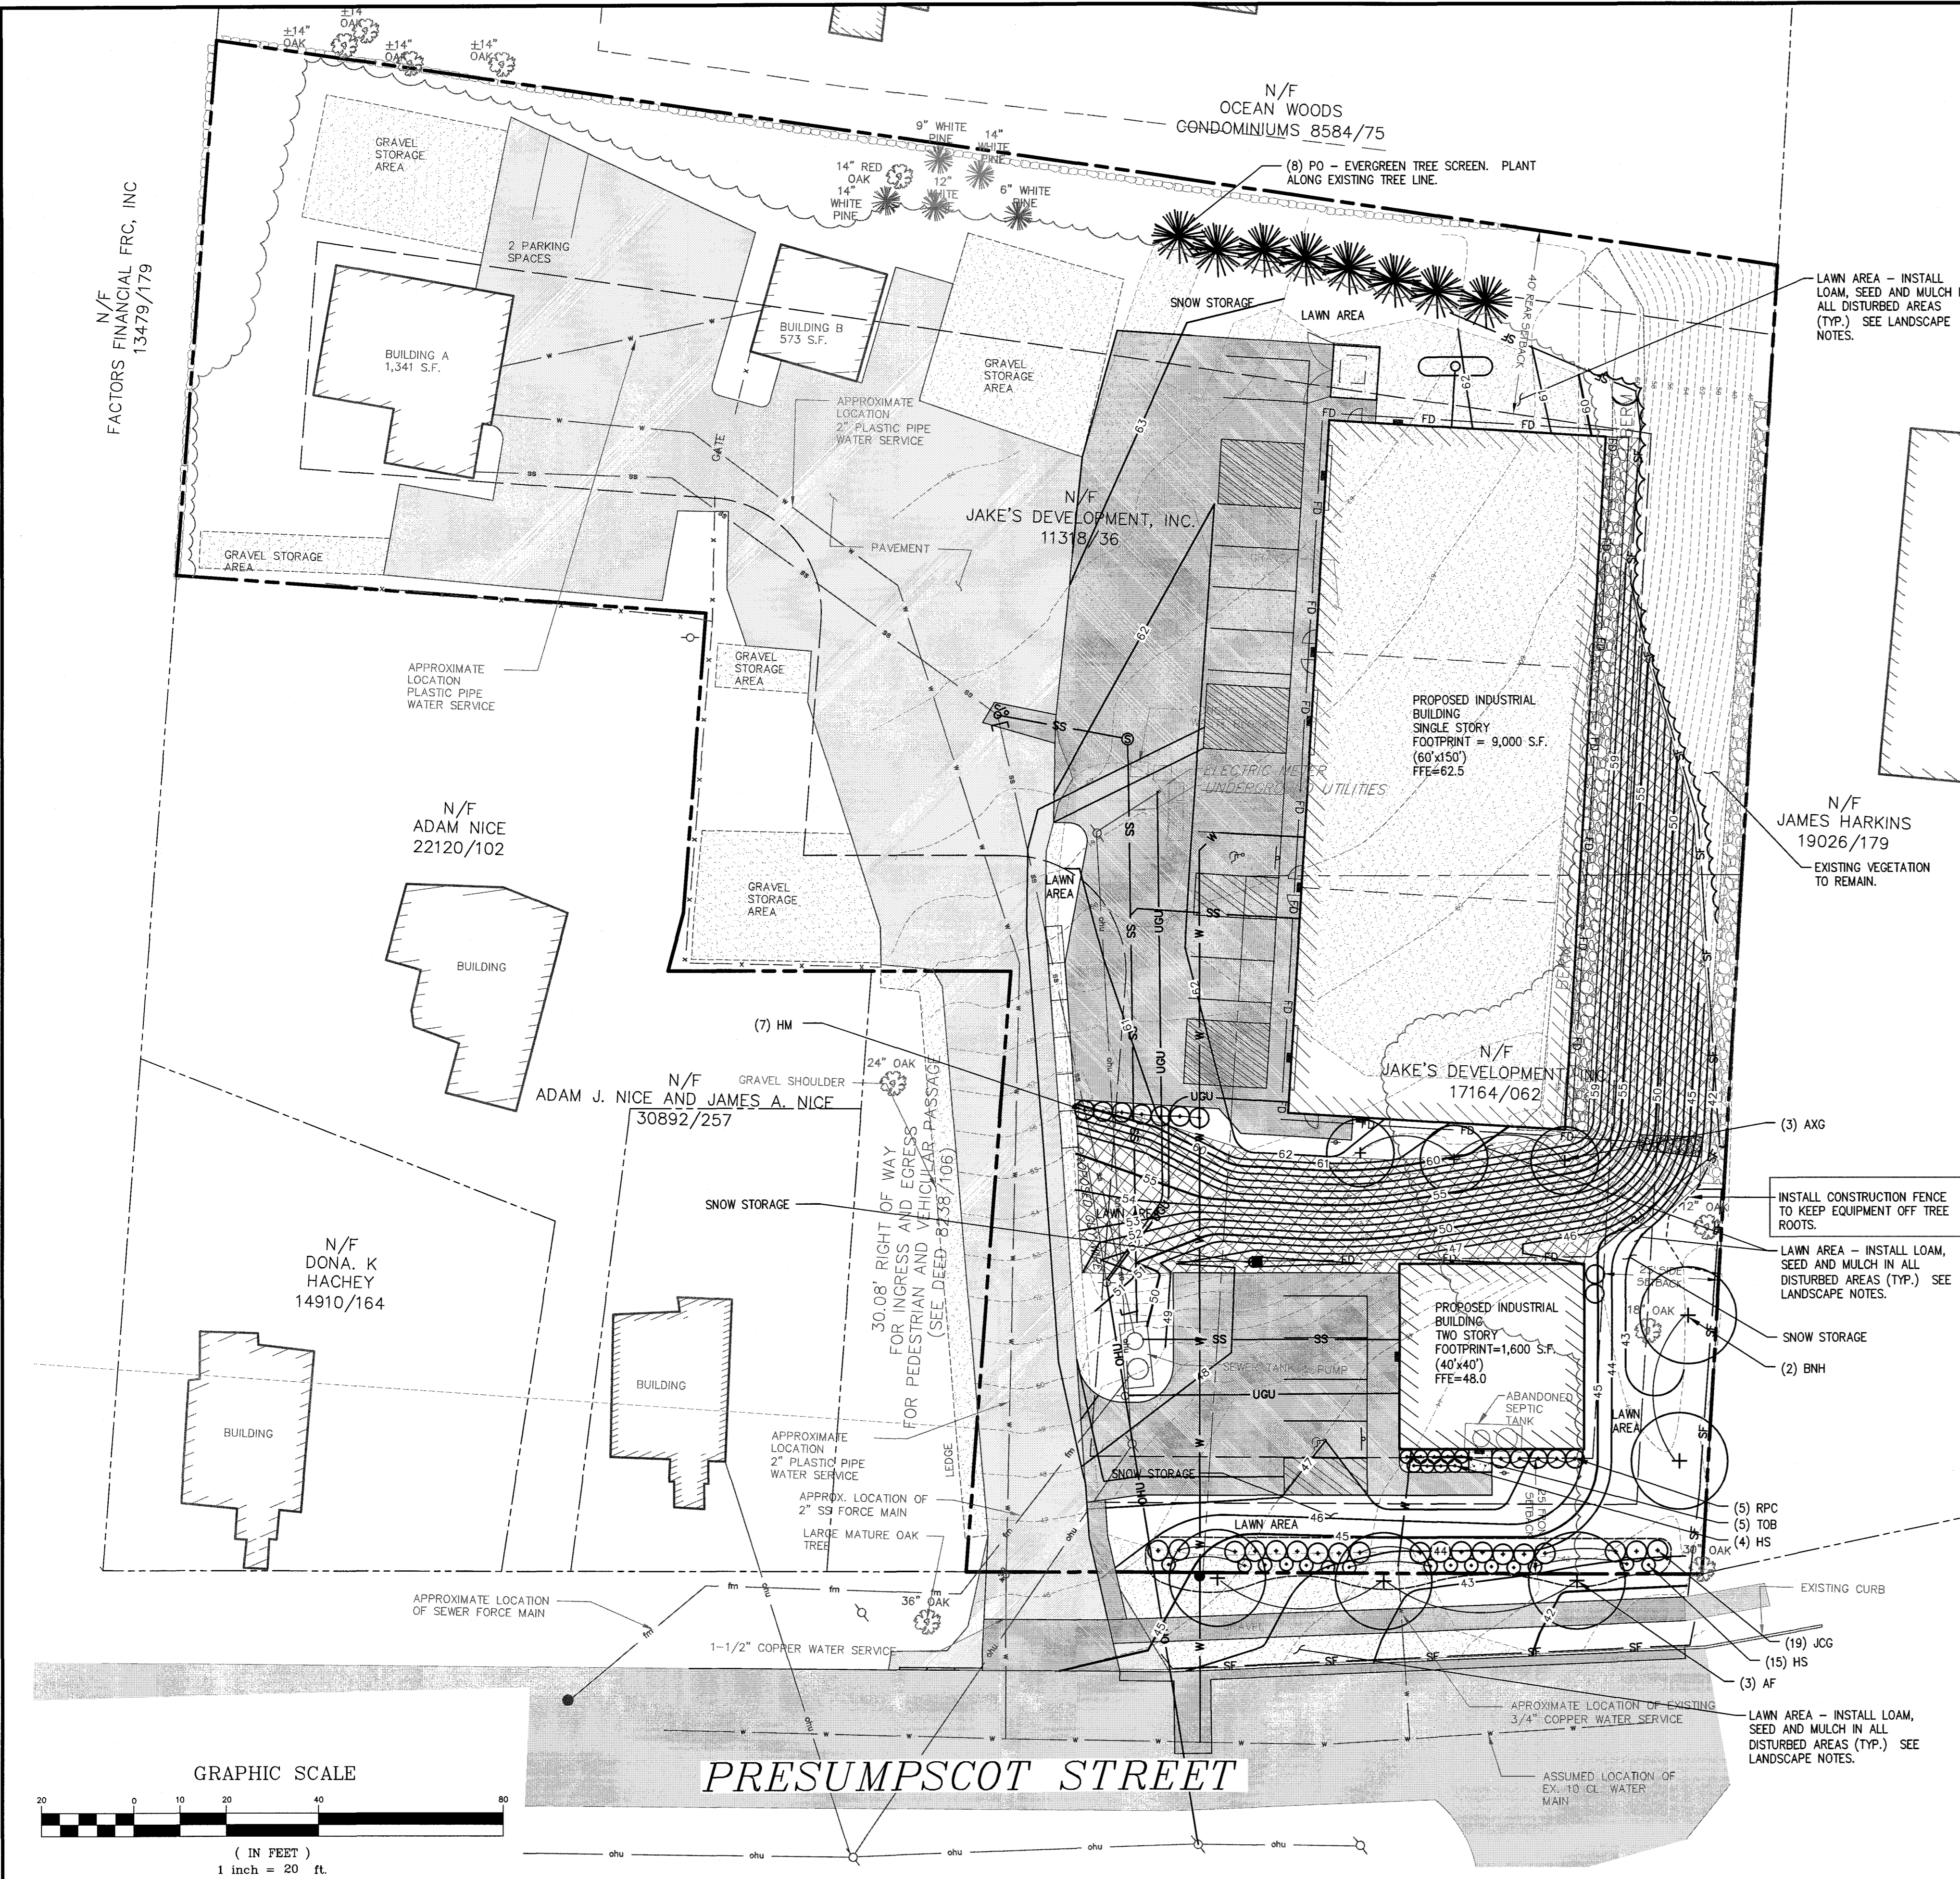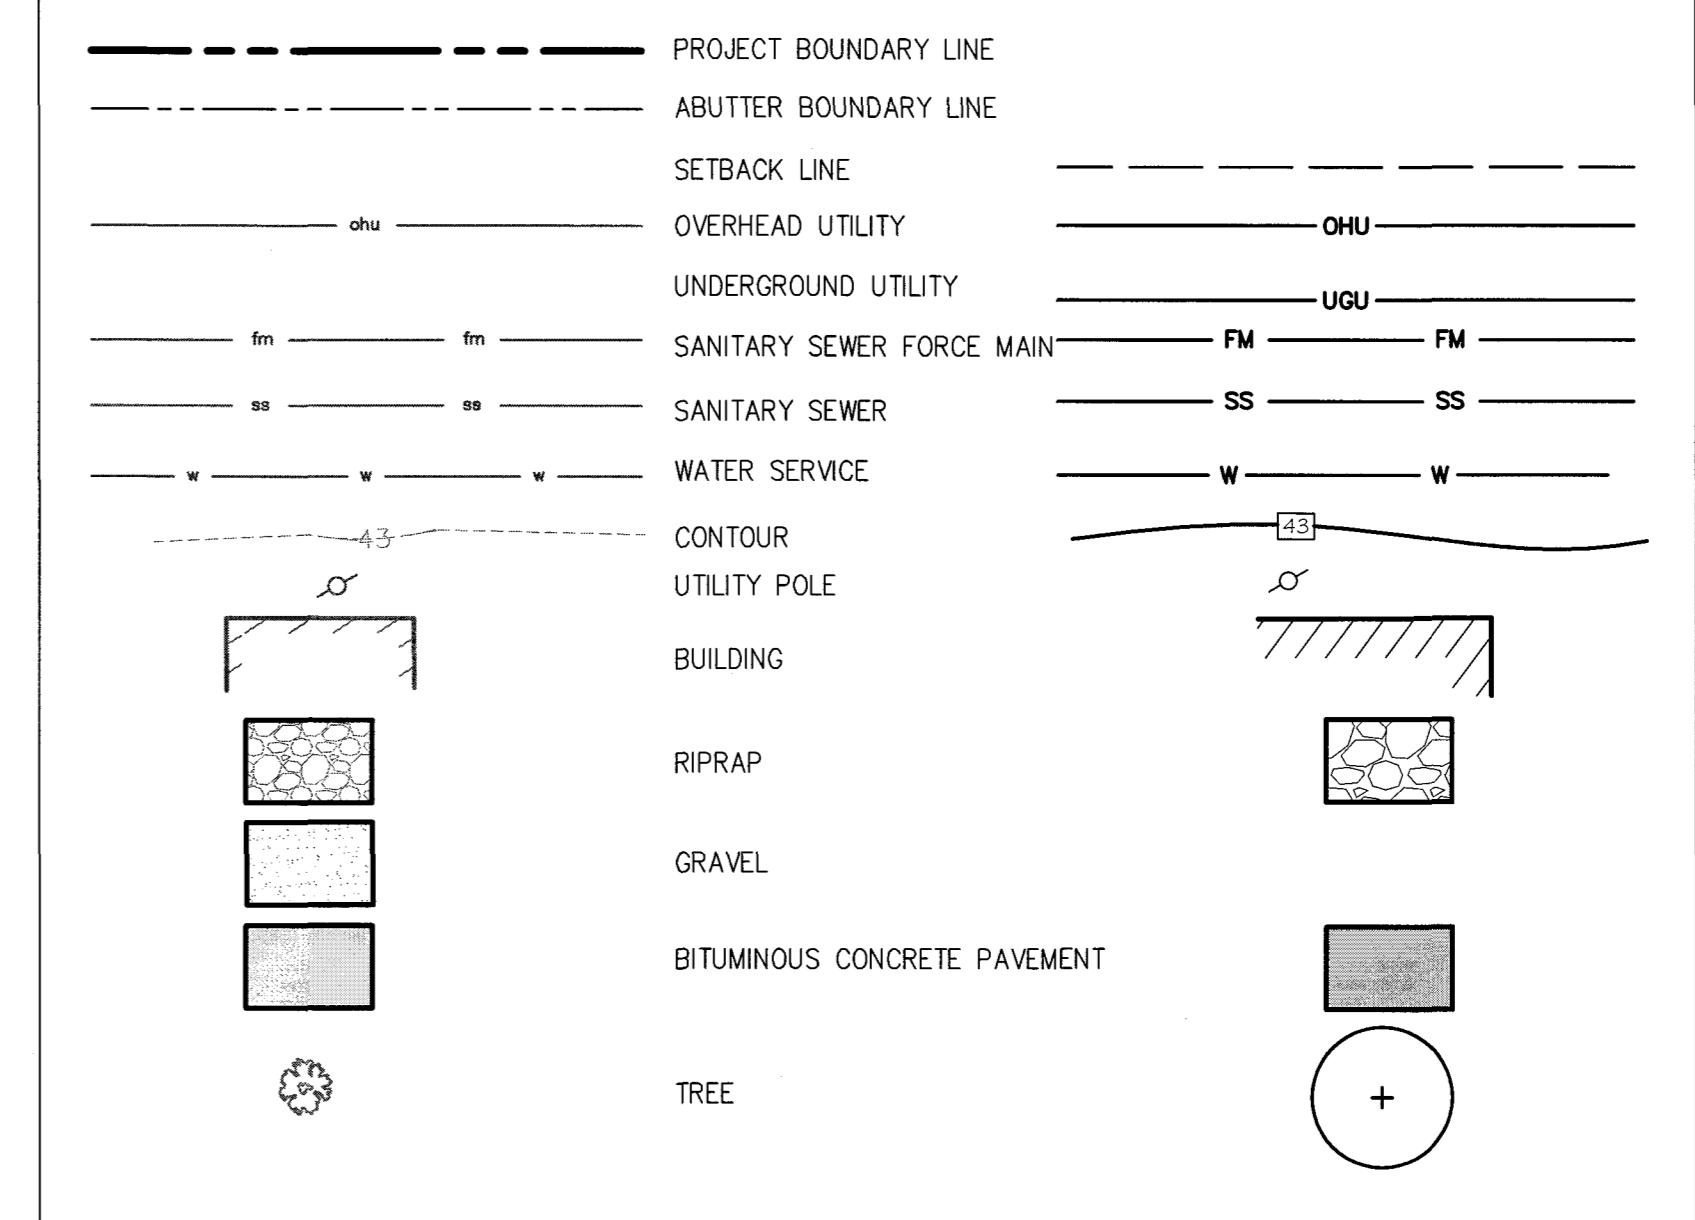

REV.	DATE	STATUS	BY	CHKD	APPD	REV.	DATE	STATUS	BY	CHKD	APPD
B	3/7/18	REVISED PER STAFF COMMENTS AND RESUBMITTED TO THE CITY OF PORTLAND	DEPT.	PBB	PBB						
A	11/30/17	SUBMITTED TO THE CITY OF PORTLAND FOR LEVEL 2 SITE PLAN APPLICATION	DEPT.	PBB	PBB						



**LAND DESIGN SOLUTIONS**  
LAND PLANNING, SITE PLANNING & LANDSCAPE ARCHITECTURE  
P.O. Box 316, 160 Longwoods Road, Cumberland, ME 04021 tel:(207) 434-1717  
APPLICANT & OWNER:  
**JAKE'S DEVELOPMENT, INC.**  
30 LEDGEWOOD DRIVE, FALMOUTH, MAINE 04105


DESIGN: PBB  
DRAWN: DEPT.  
CHKD: PBB  
DATE: NOV. 2017  
SCALE: 1"=20'

**PROPOSED PRESUMPCOT STREET BUSINESS PARK**  
314-316 PRESUMPCOT STREET, PORTLAND, MAINE


**LANDSCAPE PLAN**

PROJ. NO. 16-115  
DWG. NO. C-104

CONSTRUCTION MANAGEMENT PLAN NOTES:  
 1. REFER TO CONSTRUCTION MANAGEMENT PLAN NARRATIVE FOR ADDITIONAL INFORMATION.

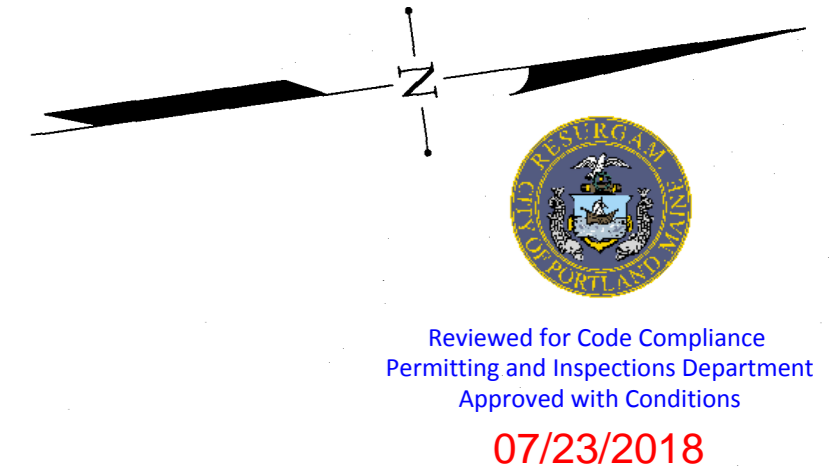


Reviewed for Code Compliance  
 Permitting and Inspections Department  
 Approved with Conditions  
 07/23/2018

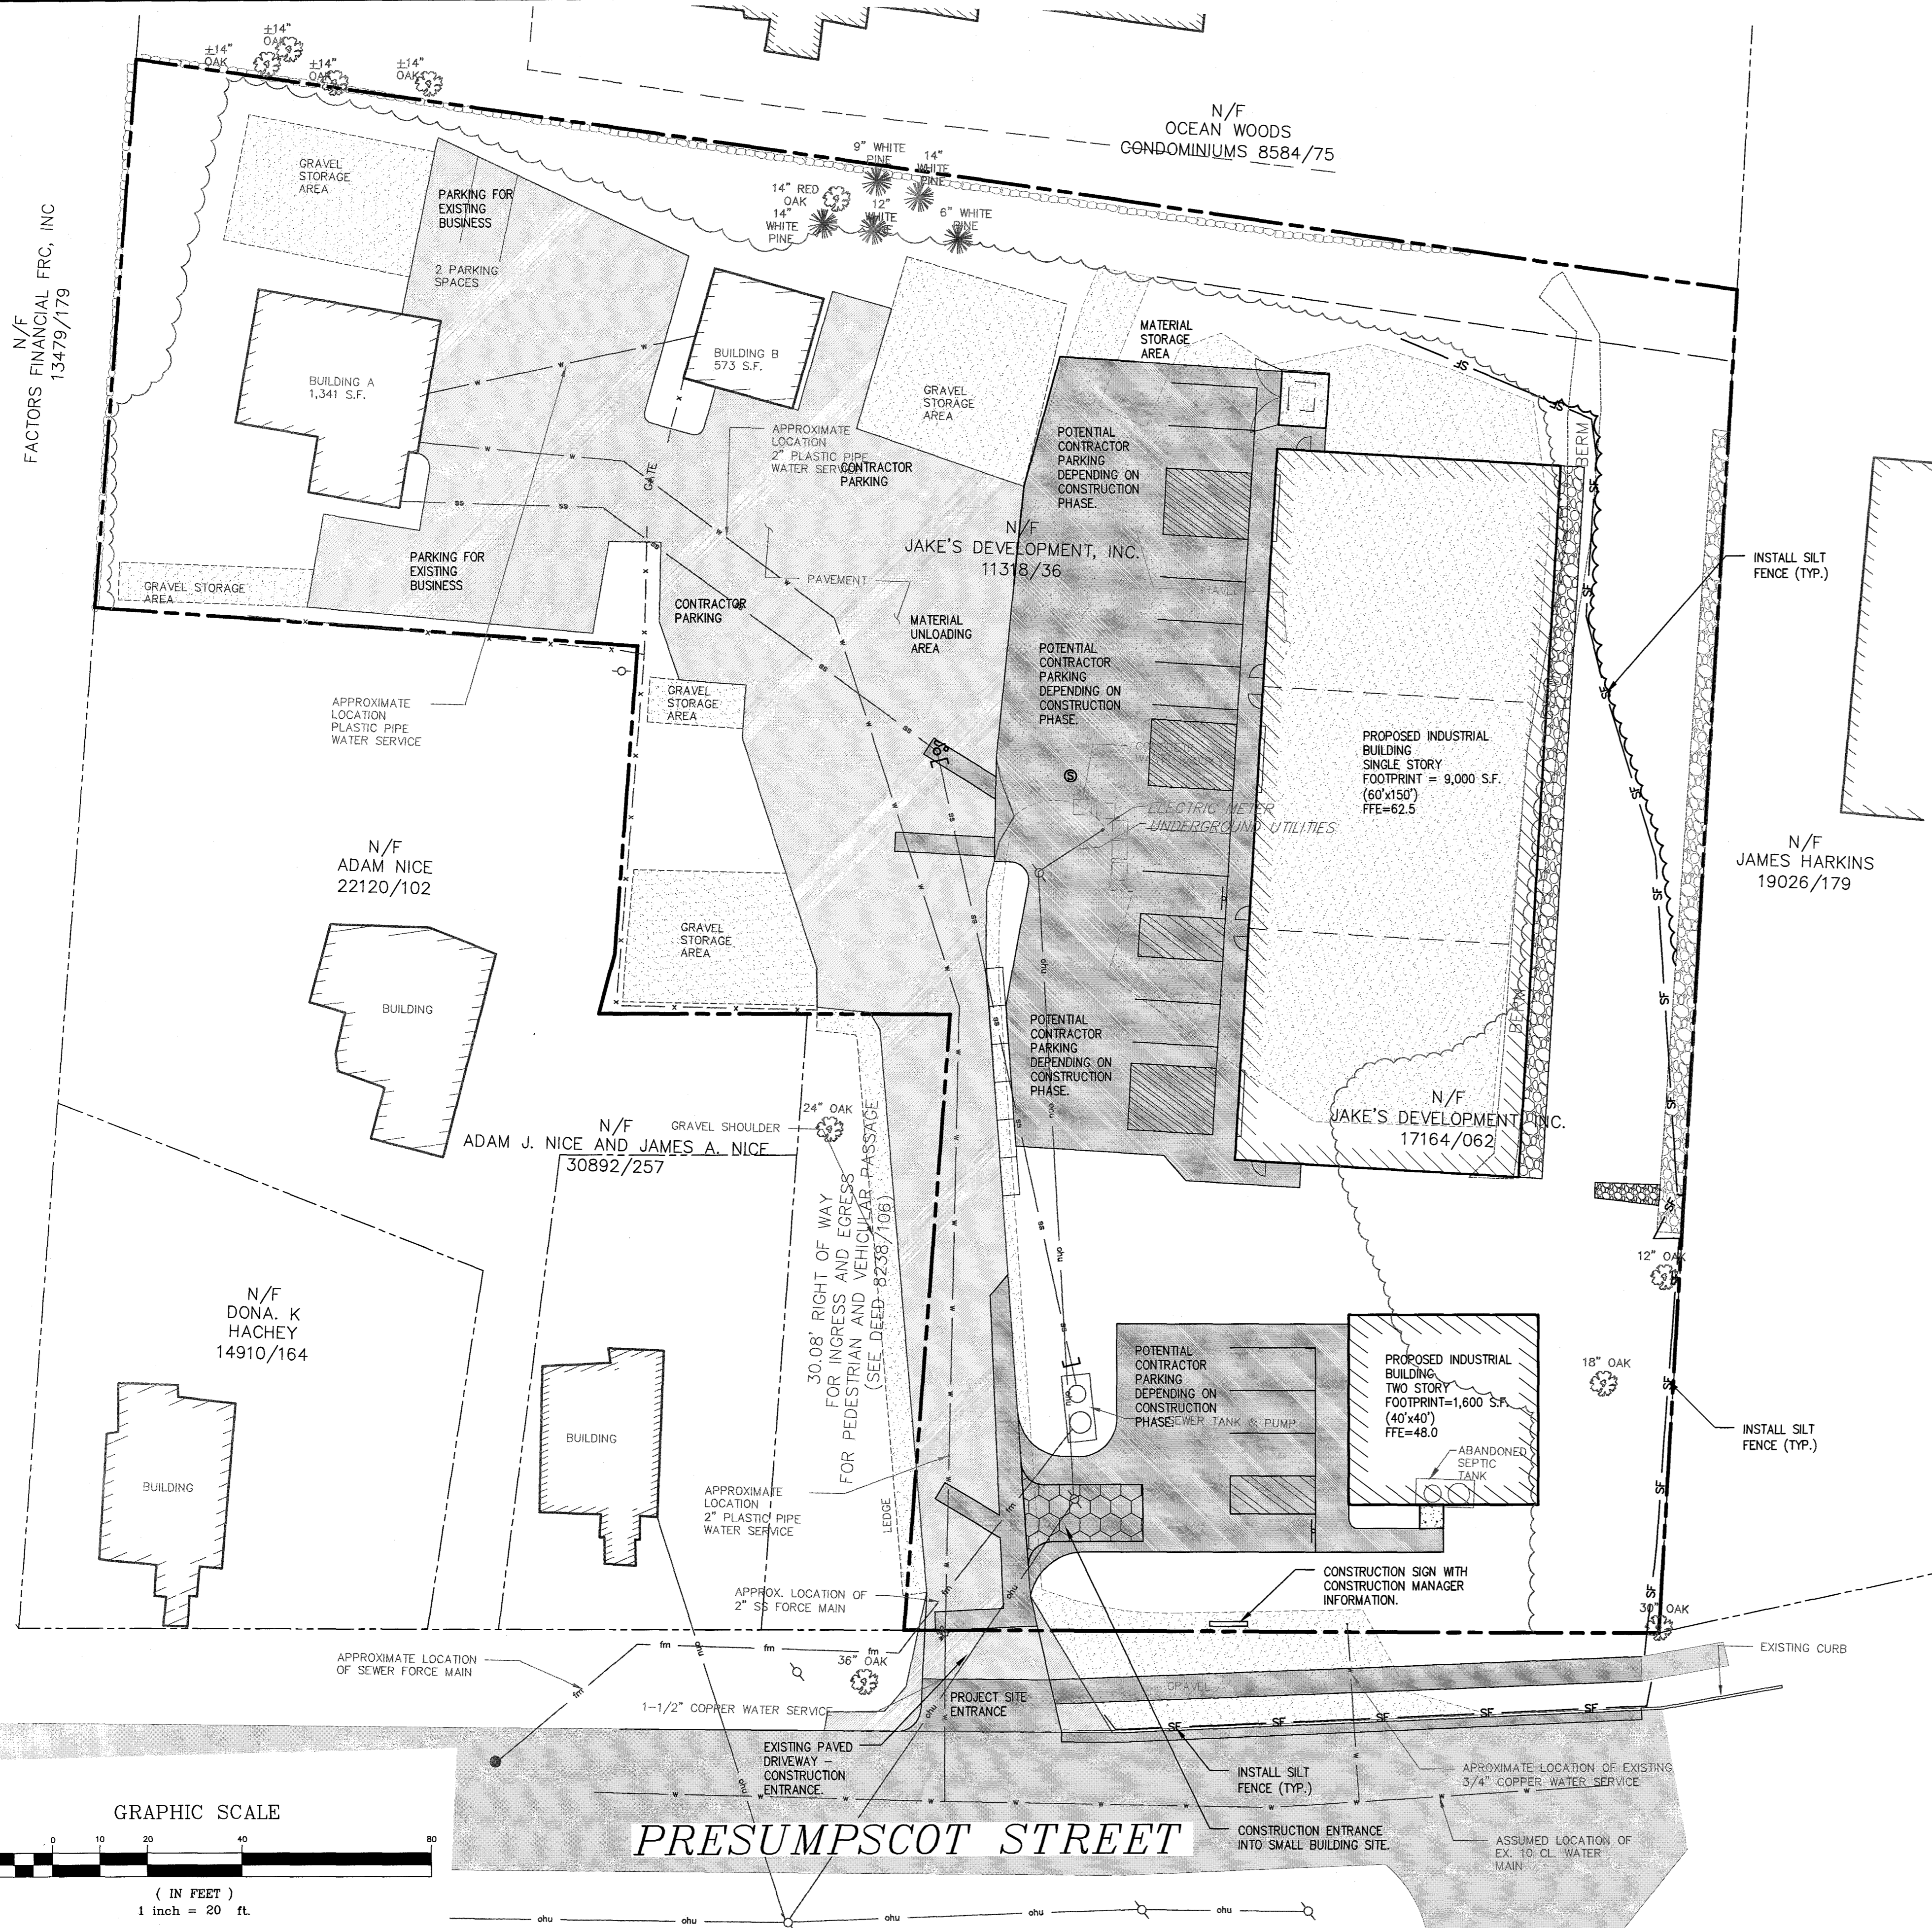

**LEGEND:**

	PROJECT BOUNDARY LINE		OVERHEAD UTILITY	
	ABUTTER BOUNDARY LINE		UNDERGROUND UTILITY	
	SETBACK LINE		SANITARY SEWER FORCE MAIN	
			SANITARY SEWER	
			WATER SERVICE	
			CONTOUR	
			UTILITY POLE	
			BUILDING	
			RIPRAP	
			GRAVEL	
			BITUMINOUS CONCRETE PAVEMENT	
			TREE	
			WALL MOUNTED LIGHT FIXTURE	

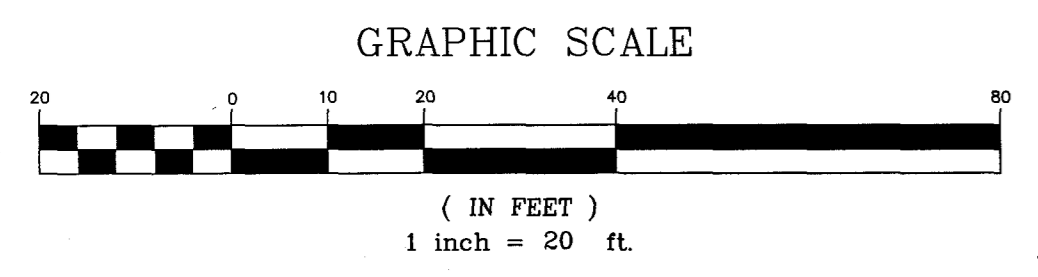


**PRESUMPCOT STREET**

BISKUP CONSTRUCTION INC.  
 16 Danielle Drive  
 Winthrop, ME 04092  
 207-892-9800 Fax 207-892-9895

RECEIVED MAR 15 2018

REV.	DATE	STATUS	BY	CHKD.	APPD.	REV.	DATE	STATUS	BY	CHKD.	APPD.
A	12/20/17	SUBMITTED TO THE CITY OF PORTLAND WITH CONSTRUCTION MANAGEMENT PLAN	DEPT.	PBB	PBB						

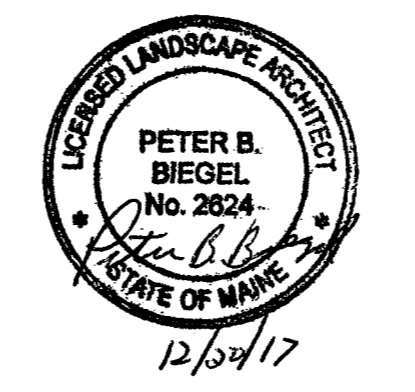

**LAND DESIGN SOLUTIONS**  
 LAND PLANNING, SITE PLANNING & LANDSCAPE ARCHITECTURE  
 P.O. Box 316, 160 Longwoods Road, Cumberland, ME 04021 tel:(207) 434-1111  
 APPLICANT & OWNER:  
**JAKE'S DEVELOPMENT, INC.**  
 30 LEDGEWOOD DRIVE, FALMOUTH, MAINE 04105

DESIGN: PBB  
 DRAWN: DEPT.  
 CHKD: PBB  
 DATE: NOV. 2017  
 SCALE: 1"=20'

**PROPOSED PRESUMPCOT STREET BUSINESS PARK**  
 314-316 PRESUMPCOT STREET, PORTLAND, MAINE  
**CONSTRUCTION MANAGEMENT PLAN**  
 PROJ. NO. **16-115**  
 DWG. NO. **C-105**  
 REV. **A**



### GENERAL NOTES

- CROSS SECTION HEIGHT IS BASED UPON A PLAN ENTITLED "GRADING, DRAINAGE AND EROSION CONTROL PLAN", REVISION DATED NOVEMBER 30, 2017, PREPARED BY LAND DESIGN SOLUTIONS.
- IT IS THE RESPONSIBILITY OF THE OWNER, CONTRACTOR OR THEIR RESPECTIVE REPRESENTATIVES TO ENSURE THAT CONSTRUCTION OF THE WALL AND MATERIALS USED IN THE CONSTRUCTION OF THE WALL ARE IN ACCORDANCE WITH THESE SPECIFICATIONS AND/OR THE CONTRACT SPECIFICATIONS WHICH EVER ARE MORE STRINGENT.
- SUMMIT GEOENGINEERING SERVICES (SGS) ACCEPTS NO RESPONSIBILITY NOR LIABILITY IN THE DETERMINATION OF THE ADEQUACY OF SITE MATERIALS AND WALL LAYOUT.
- PRIOR TO THE START OF CONSTRUCTION THE CONTRACTOR SHALL VERIFY THAT THE WALL HEIGHT DOES NOT EXCEED 6' FROM BOTTOM OF WALL TO TOP OF WALL. ANY DISCREPANCY SHALL BE BROUGHT TO THE ATTENTION OF SGS PRIOR TO THE START OF CONSTRUCTION.
- THE FOLLOWING PARAMETERS WERE USED IN THE DESIGN ARE BASED ON A GEOTECHNICAL INVESTIGATION PERFORMED BY SGS:
  - SLOPE AT TOP : 4°
  - MAXIMUM SLOPE AT BASE = LEVEL
  - GROUNDWATER CONTROLLED TO BELOW BASE OF WALL
  - MAXIMUM CONTACT PRESSURE AT WALL BASE IS LESS THAN 1,000 psf
  - RETAINED (EXISTING FILL) -  $u_w = 130$  pcf,  $\phi = 32^\circ$
  - FOUNDATION SOIL -  $u_w = 120$  pcf,  $\phi = 30^\circ$
 IF ACTUAL CONDITIONS VARY FROM THOSE LISTED ABOVE, SGS SHALL BE NOTIFIED IMMEDIATELY.
- WALL INSPECTION AND CERTIFICATION ARE NOT PART OF THE SGS SCOPE OF DESIGN SERVICES. IT IS THE OWNERS RESPONSIBILITY TO CONFIRM WITH THE JURISDICTIONAL AUTHORITY PRIOR TO CONSTRUCTION OF THE WALL WHETHER A CONSTRUCTION CERTIFICATION IS REQUIRED. A CONSTRUCTION CERTIFICATION WILL REQUIRE ON-SITE INSPECTIONS, MATERIAL TESTING, PHOTOGRAPHIC DOCUMENTATION AND OTHER QUALITY CONTROL MEASURES AND AS-BUILT DOCUMENTATION. SGS CAN PROVIDE CERTIFICATION, IF REQUIRED, UNDER A SEPARATE CONTRACT.
- THE OWNER IS RESPONSIBLE TO RETAIN THE SERVICES OF A QUALIFIED CONSTRUCTION MATERIALS FIRM TO PERFORM COMPACTION TESTS ON WALL BACKFILL TO CONFIRM THAT THE MINIMUM COMPACTION REQUIREMENTS ARE MET.

### WALL INSTALLATION

- THE STONE STRONG WALL SYSTEM SHALL BE INSTALLED IN ACCORDANCE WITH THE STONE STRONG MANUALS ([www.stonestrong.com](http://www.stonestrong.com)).
- FOUNDATION EXCAVATION SHALL EXTEND TO COMPETENT SOIL. ALL EXISTING TOPSOIL, LOOSE MATERIAL, ORGANIC SOIL AND OTHER SOFT OR UNSTABLE FOUNDATION SOILS SHALL BE REMOVED FROM THE AREA TO BE OCCUPIED BY THE WALL AND REPLACED WITH GEOTEXTILE AND 3/4" CRUSHED STONE IN ACCORDANCE WITH THESE PLANS AND AS OTHERWISE DIRECTED BY THE ENGINEER.
- UPON COMPLETION OF THE EXCAVATION, THE WALL BASE SUBGRADE SHALL BE PROOF ROLLED BY MAKING A MINIMUM OF 6 PASSES USING A LARGE VIBRATORY PLATE COMPACTOR.
- INSTALL A 9" (MINIMUM THICK) LAYER OF COMPACTED 3/4" CRUSHED STONE ON TOP OF THE GEOTEXTILE LAYER FOR BLOCK WALL LEVELING PAD. EXTEND LEVELING PAD (1) ONE FOOT HORIZONTALLY IN ALL DIRECTIONS BEYOND LIMITS OF THE STONE STRONG BLOCKS.
- INSTALL THE BASE COURSE OF BLOCKS ON A PREPARED FOUNDATION LEVELING PAD. ENSURE THAT THE BASE COURSE IS LEVEL SIDE TO SIDE AND PLUMB. ADJUST BLOCKS AS REQUIRED TO PROVIDE A STRAIGHT AND LEVEL BASE COURSE. PLACE AND BACKFILL ONLY ONE COURSE OF BLOCKS AT A TIME. DO NOT STACK BLOCKS PRIOR TO BACKFILLING.
- PLACE CRUSHED STONE AND WALL BACKFILL WITH A MAXIMUM LIFT THICKNESS OF 18", COMPACT WALL BACKFILL TO A MINIMUM OF 95% OF ASTM D1557. FIELD DENSITY TESTS SHALL BE PERFORMED AT A MINIMUM RATE OF 1 TEST PER EVERY OTHER LIFT FOR EVERY 100' OF WALL (3 TESTS PER EVERY OTHER LIFT, MINIMUM)
- AT THE END OF EACH WORKDAY, BACKFILL SURFACE SHALL BE GRADED AWAY FROM THE WALL FACE A MINIMUM OF 2% SLOPE. THE BACKFILL SURFACE SHALL BE COMPACTED WITH A SMOOTH DRUM ROLLER TO MINIMIZE PONDING OF WATER AND SATURATION OF THE BACKFILL. A TEMPORARY SOIL BERM SHALL BE CONSTRUCTED NEAR THE CREST OF THE GRAVITY STRUCTURES TO PREVENT SURFACE WATER RUNOFF FROM OVERTOPPING THE WALLS.

### MATERIAL SPECIFICATIONS


15) 3/4" CRUSHED DRAINAGE STONE SHALL BE CLEAN ANGULAR CRUSHED STONE MEETING THE FOLLOWING GRADATION AS DETERMINED IN ACCORDANCE WITH ASTM D422.

SIEVE SIZE	PERCENT PASSING
1"	100
1/4"	90 - 100
3/8"	20 - 55
No. 4	0 - 10
No. 8	0 - 5


16) WALL BACKFILL SHALL MEET THE FOLLOWING GRADATION SPECIFICATIONS (MDOT 103.06 TYPE D)

SIEVE SIZE	PERCENT PASSING
3"	100
1/2"	35 - 80
1/4"	25 - 65
No. 40	0 - 30
No. 200	0 - 7

- THE MAXIMUM PARTICLE SIZE SHALL BE LIMITED TO 6".
- BLOCKS SHALL BE 3 s.f., 6 s.f., 9 s.f. AND 24 s.f. "STONE STRONG", MANUFACTURED BY PRECAST CONCRETE PRODUCTS OF MAINE (NO. C-106) AND STARTED UNDER THE
- GEOTEXTILE SHALL CONSIST OF 180N OR APPROVED EQUIVALENT.
- UNDERDRAIN PIPE SHALL CONSIST OF 4" PERFORATED SDR 35 PVC OR APPROVED EQUIVALENT.

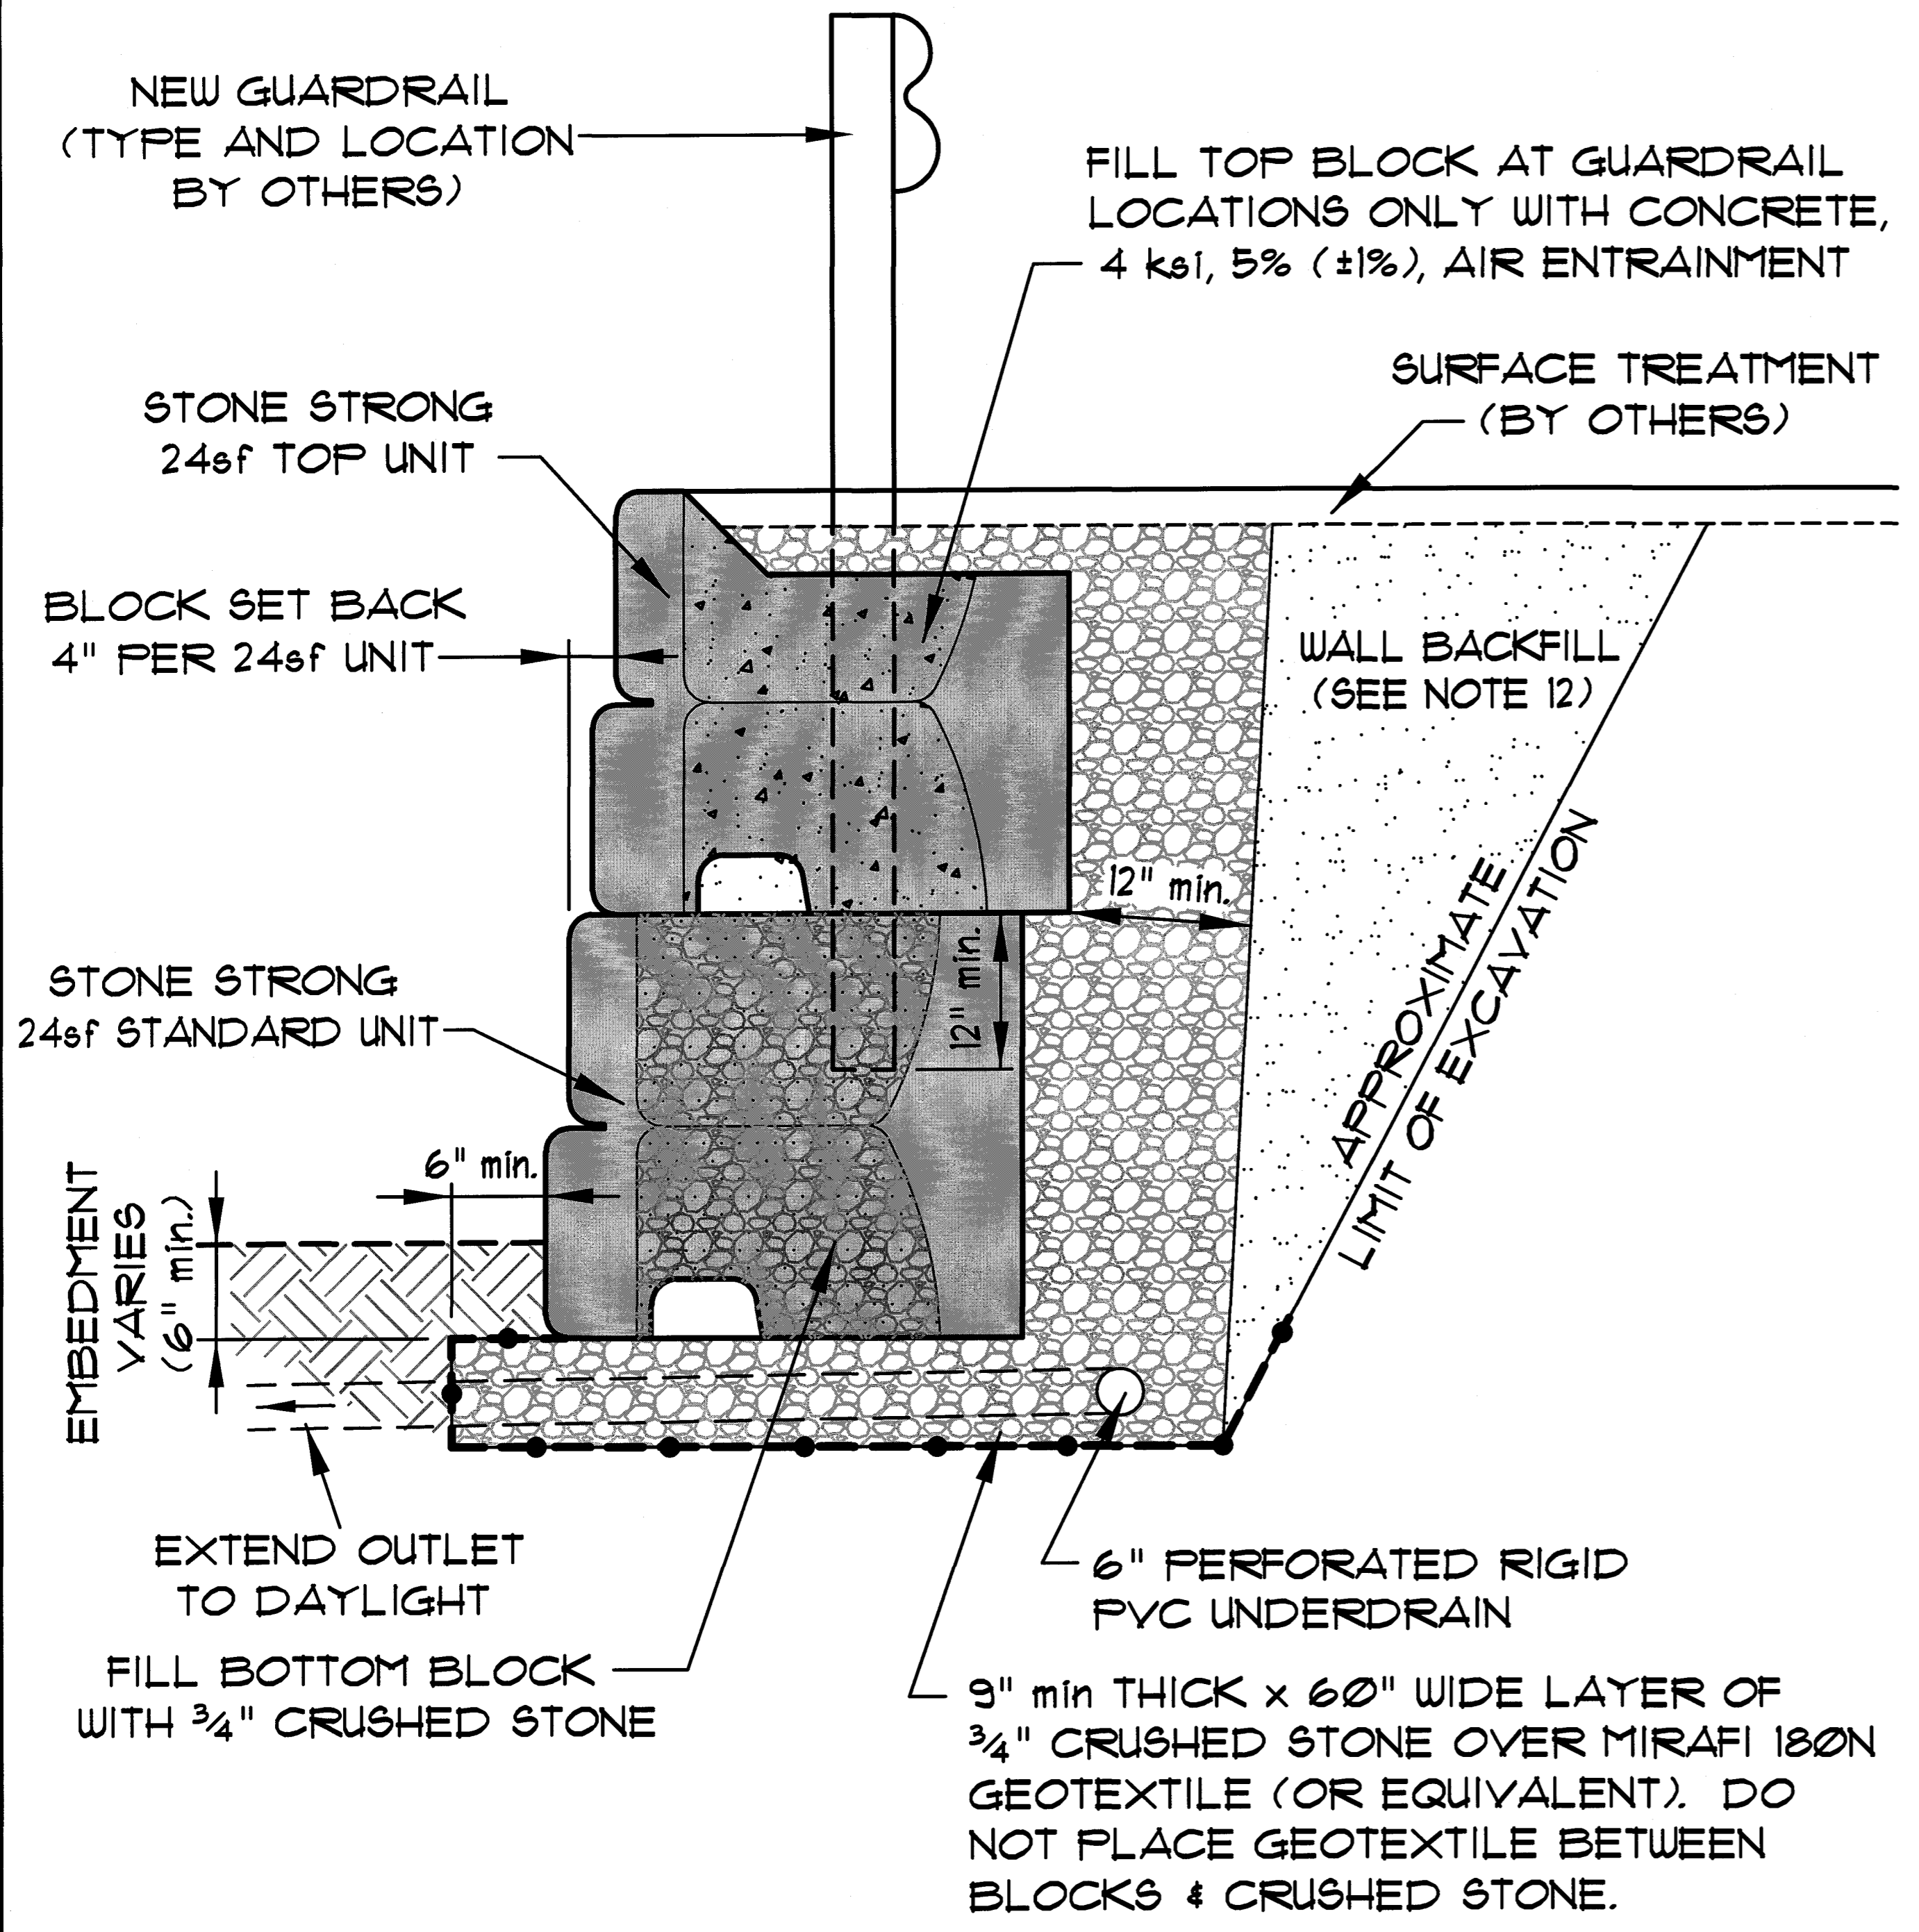

**GRAVITY WALL CROSS SECTION**  
NOT TO SCALE

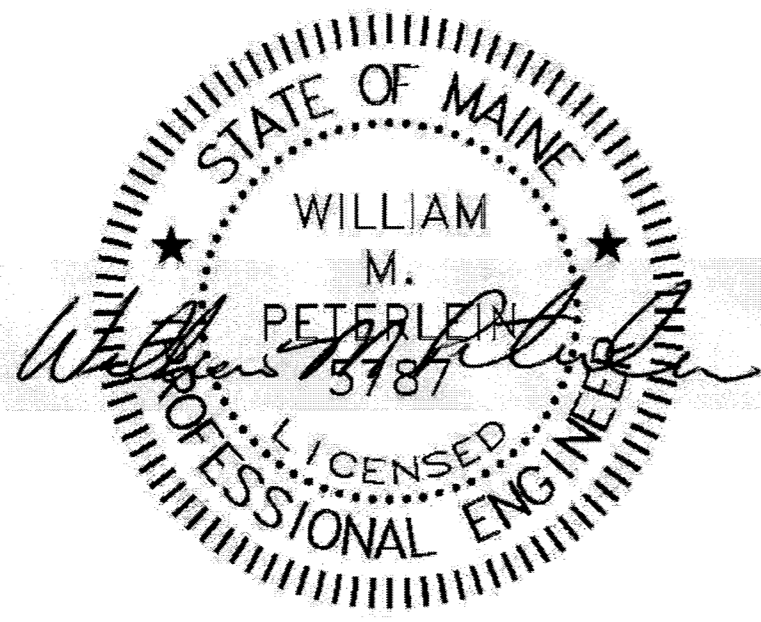

PROJECT: PRESUMPSCOTT STREET  
BUSINESS PARK  
PORTLAND, MAINE

CLIENT: LAND DESIGN SOLUTIONS

TITLE: STONE STRONG RETAINING WALL  
SECTION & CONSTRUCTION NOTES

SCALE: NOT TO SCALE  
DATE: MARCH 7, 2018

DRAWN BY: KRF  
APPR BY: UMP

113 PLEASANT STREET  
ROCKLAND, ME 04841  
Tel: (207) 318-1161

15 LISBON ST. - SUITE 101  
LISBON, ME 04240  
Tel: (207) 516-3313

**SUMMIT**  
GEOENGINEERING SERVICES

CITY OF PORTLAND  
APPROVED SITE PLAN


FIGURE: 18061

DATE OF APPROVAL: 3/14/2018  
APPROVED BY: Christian Rodman







Reviewed for Code Compliance  
Permitting and Inspections Department  
Approved with Conditions  
07/23/2018

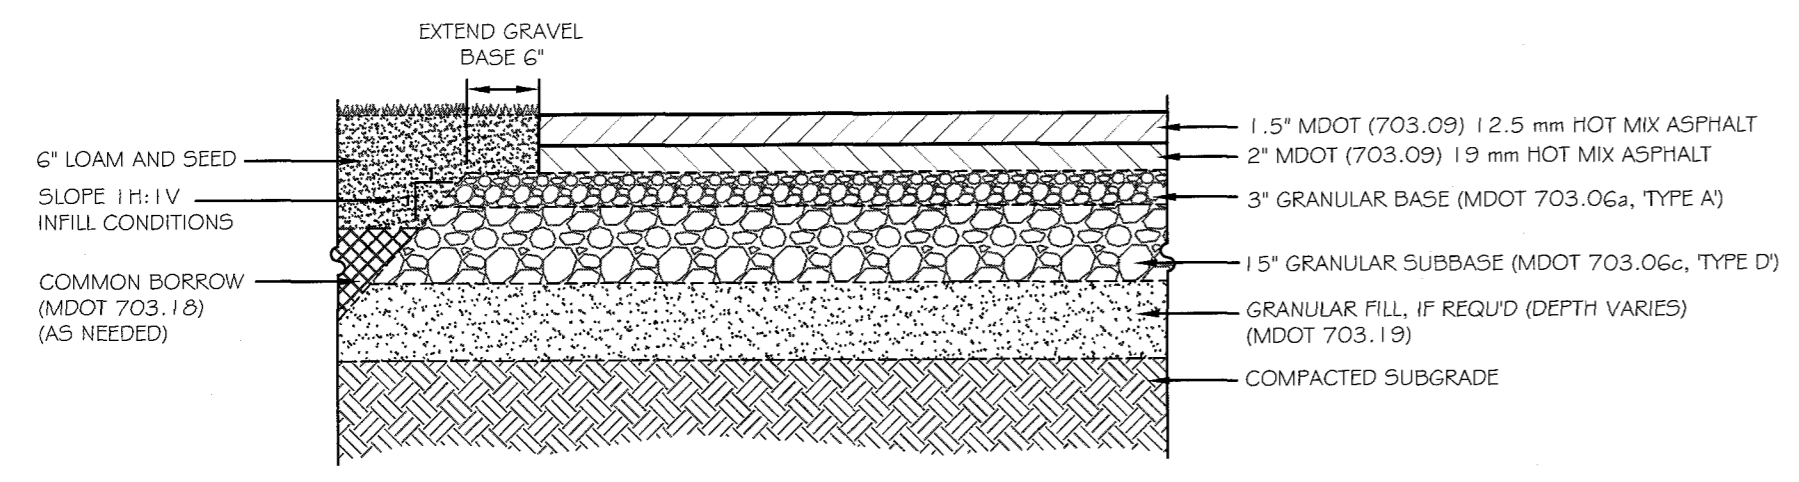


1  
C-201  
BITUMINOUS CONCRETE PAVEMENT SECTION  
NOT TO SCALE

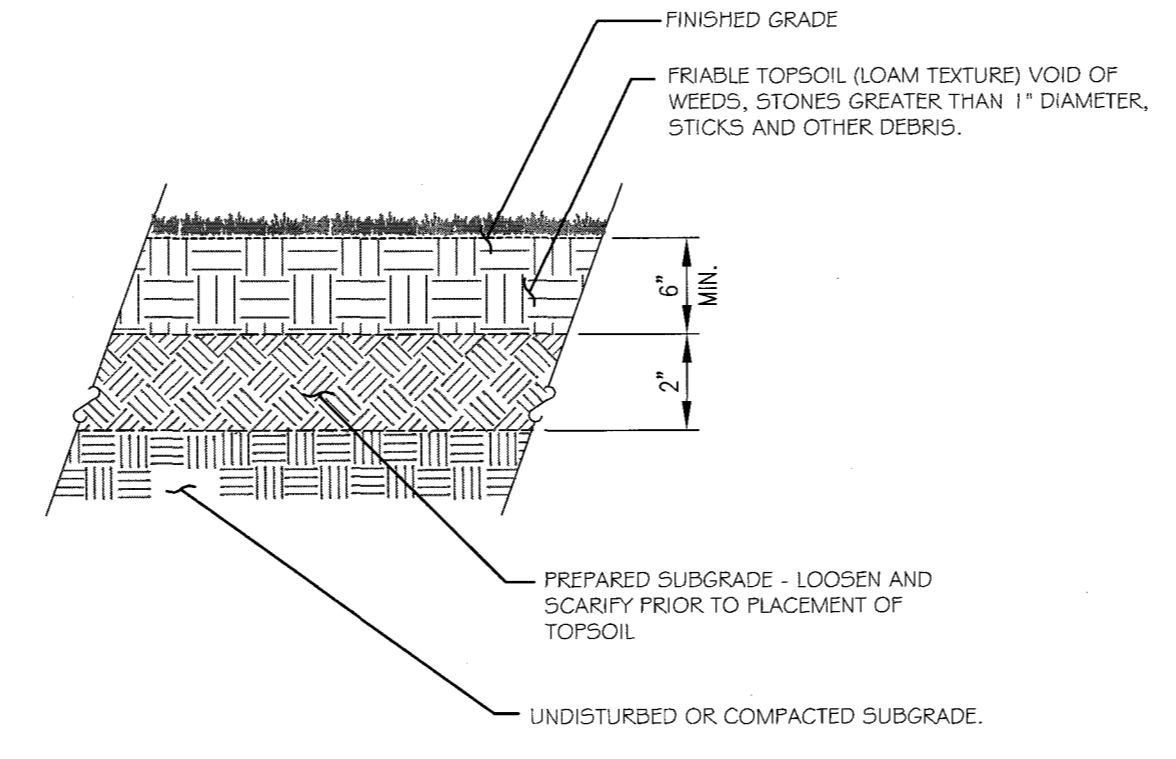

2  
C-201  
LAWN INSTALLATION DETAIL  
NOT TO SCALE

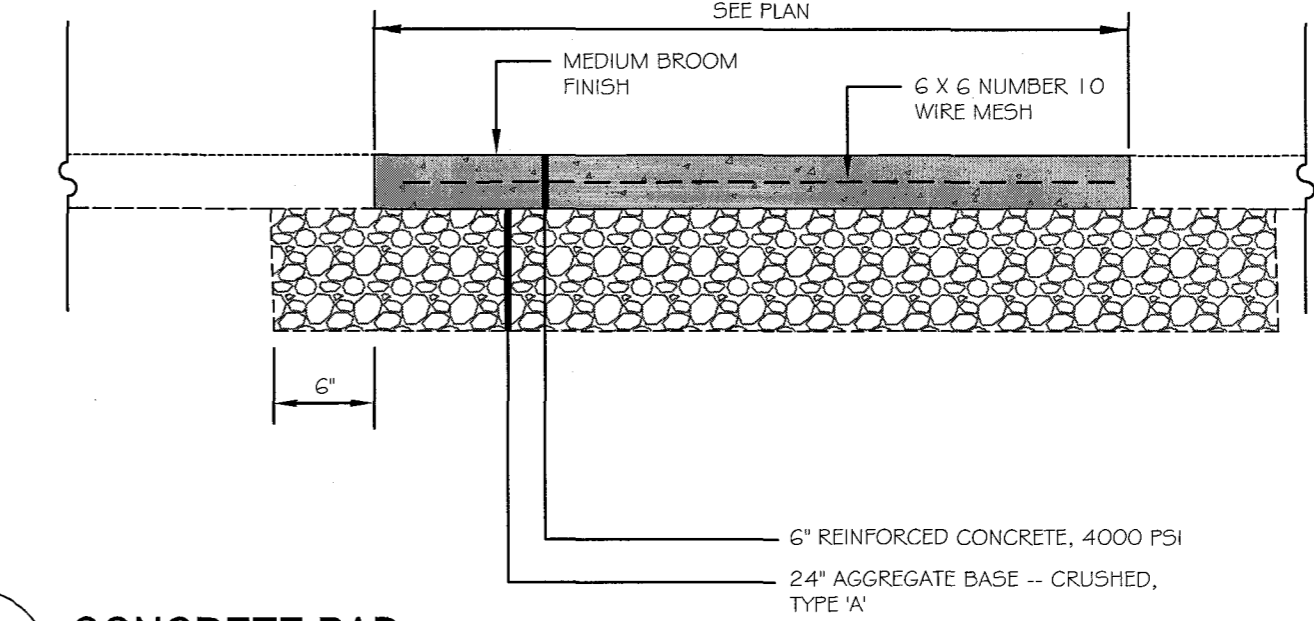


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C-201  
CONCRETE PAD  
NOT TO SCALE

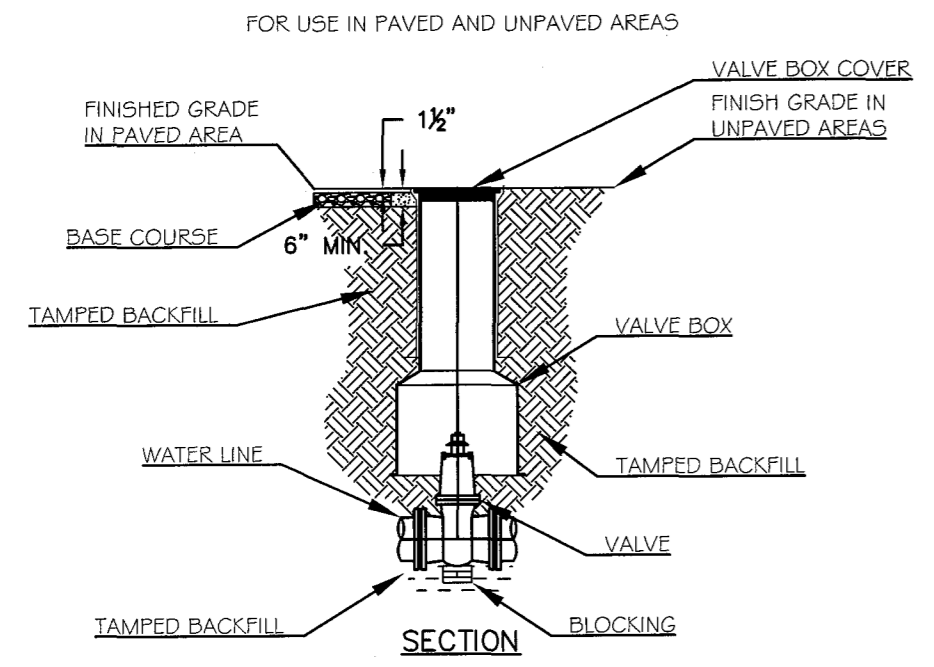


NOTES:  
1. ALL WORK TO CONFORM TO THE PORTLAND WATER DISTRICT STANDARDS AND REQUIREMENTS.  
2. D.I.P. MAY BE USED FOR VALVE BOX EXTENSIONS.  
3. VALVE BOX SHOULD NOT CONTACT WATER MAIN OR VALVE.  
4. CONCRETE PROTECTOR RING SHALL BE USED IN ALL UNPAVED AREAS.


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C-201  
VALVE AND VALVE BOX INSTALLATION DETAIL  
NOT TO SCALE

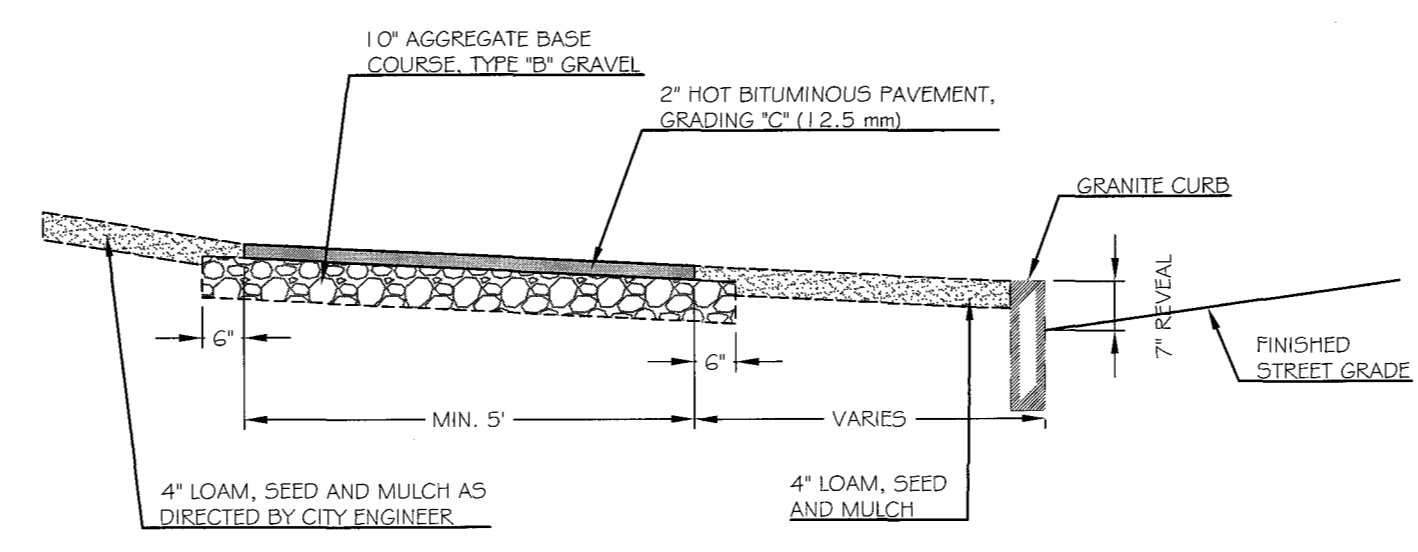


5  
C-201  
BITUMINOUS SIDEWALK  
NOT TO SCALE

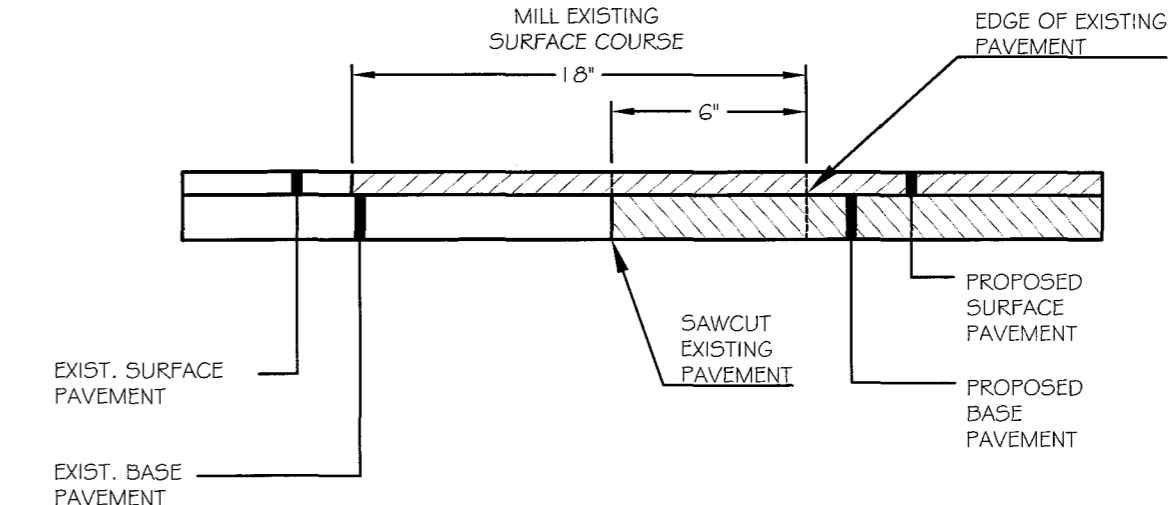

6  
C-201  
HMA PAVEMENT BUTT JOINT DETAIL  
NOT TO SCALE

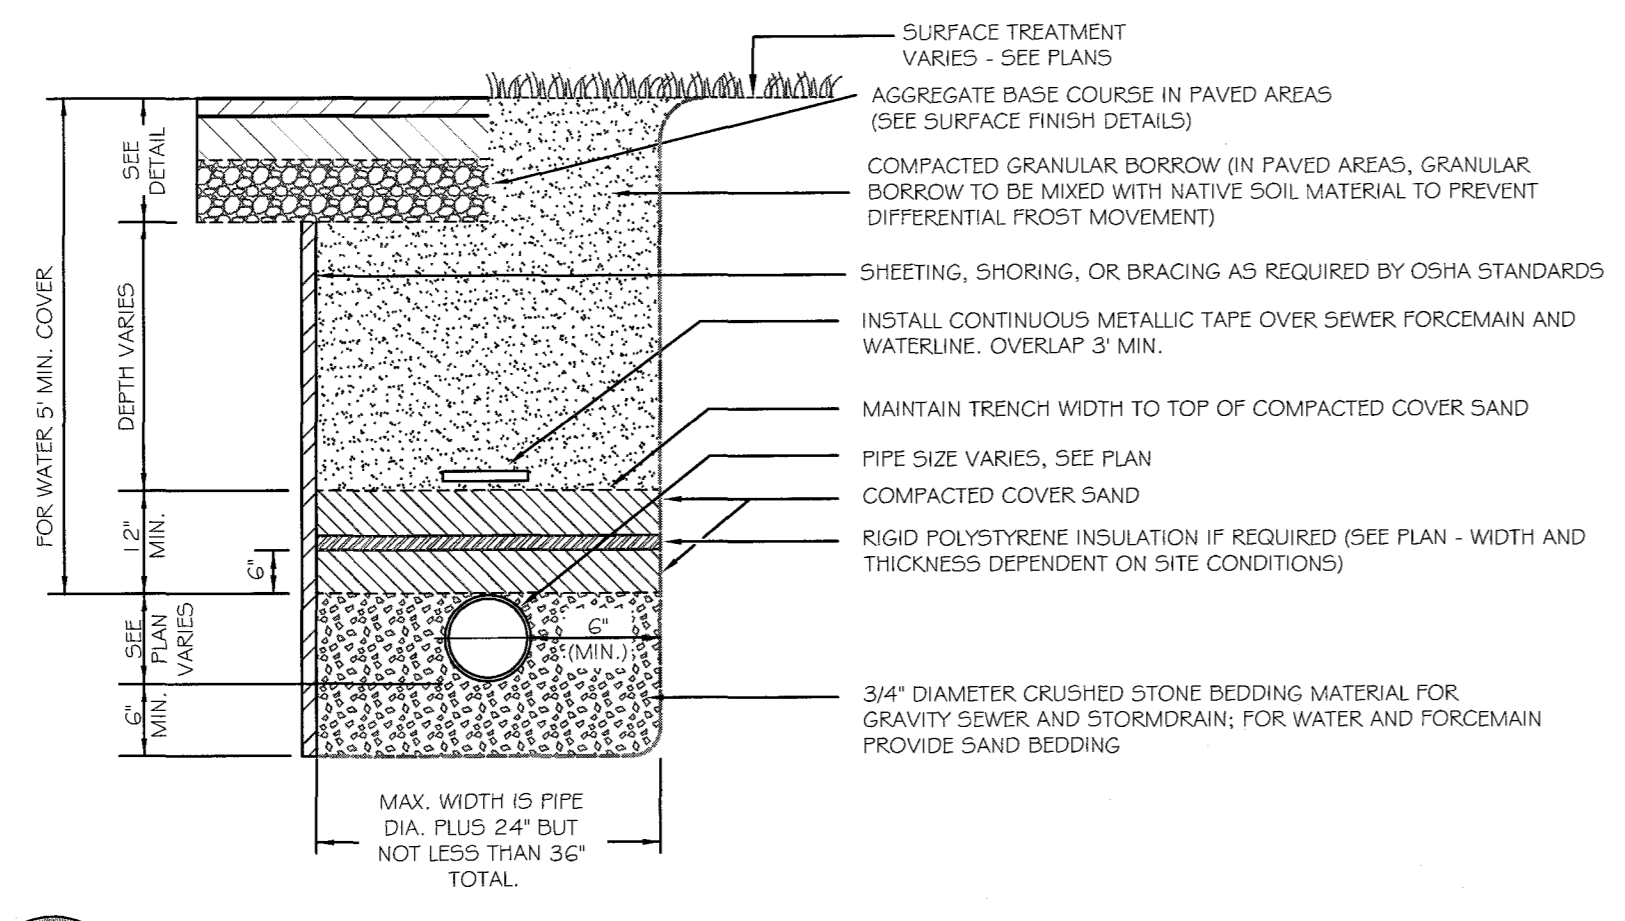


7  
C-201  
TYPICAL PIPE TRENCHING DETAIL  
NOT TO SCALE

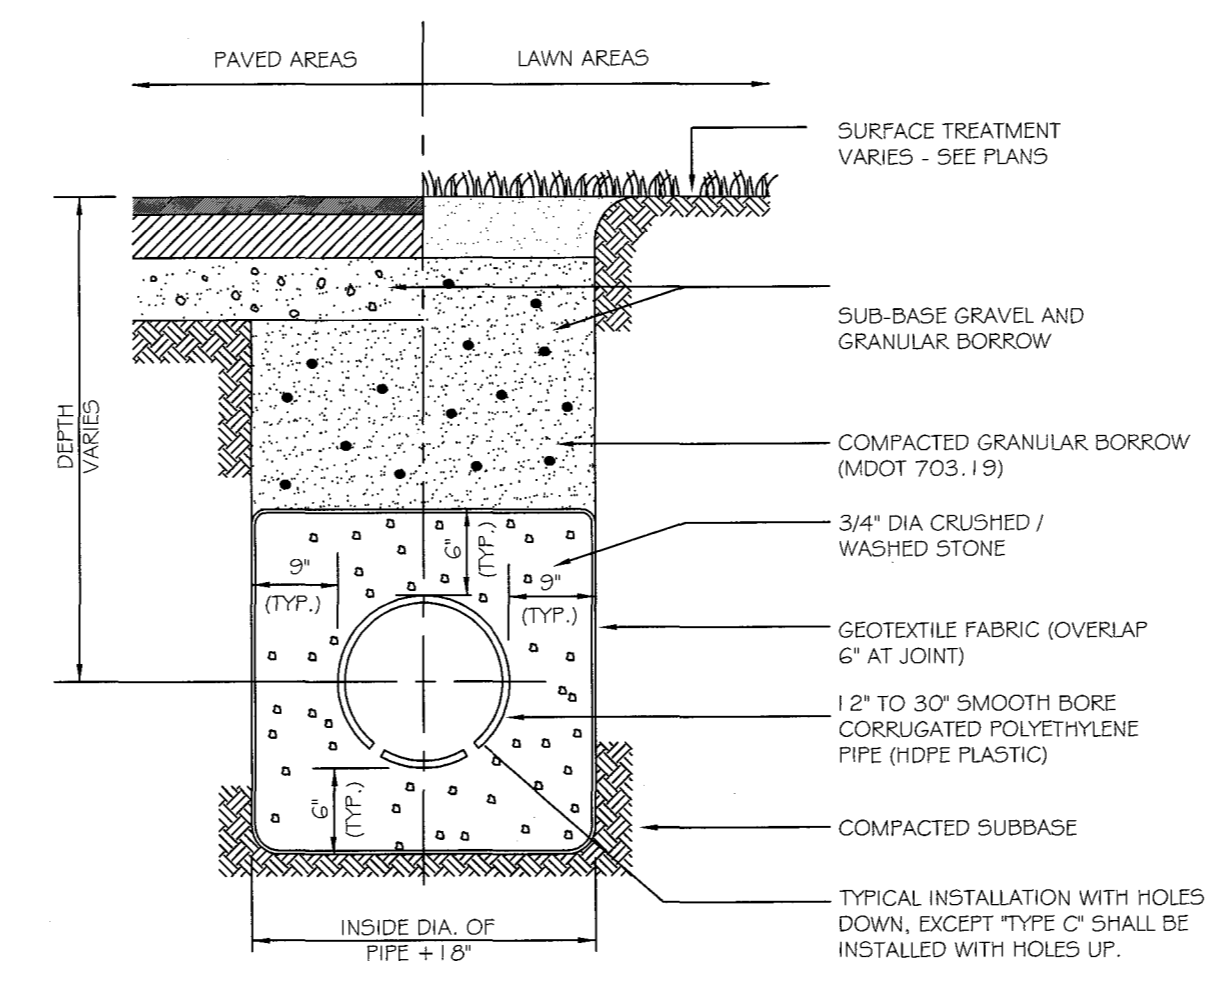


NOTES:  
1. BACKFILL MATERIAL WITHIN TRENCH BEYOND UNDERDRAIN LATERAL LIMITS SHALL, AS A MINIMUM, CONFORM TO THE REQUIREMENTS OF GRANULAR BORROW.  
2. UNDERDRAIN SHALL CONFORM TO THE REQUIREMENTS OF MDOT 605.04, TYPE 'B', EXCEPT AS NOTED.  
3. OUTLETS SHALL BE CONNECTED TO THE STORM DRAIN SYSTEM AS SHOWN ON THE PLANS, OR GRADED BY GRAVITY TO A SUITABLE DISCHARGE POINT.

8  
C10.2  
UNDERDRAIN DETAIL  
NOT TO SCALE

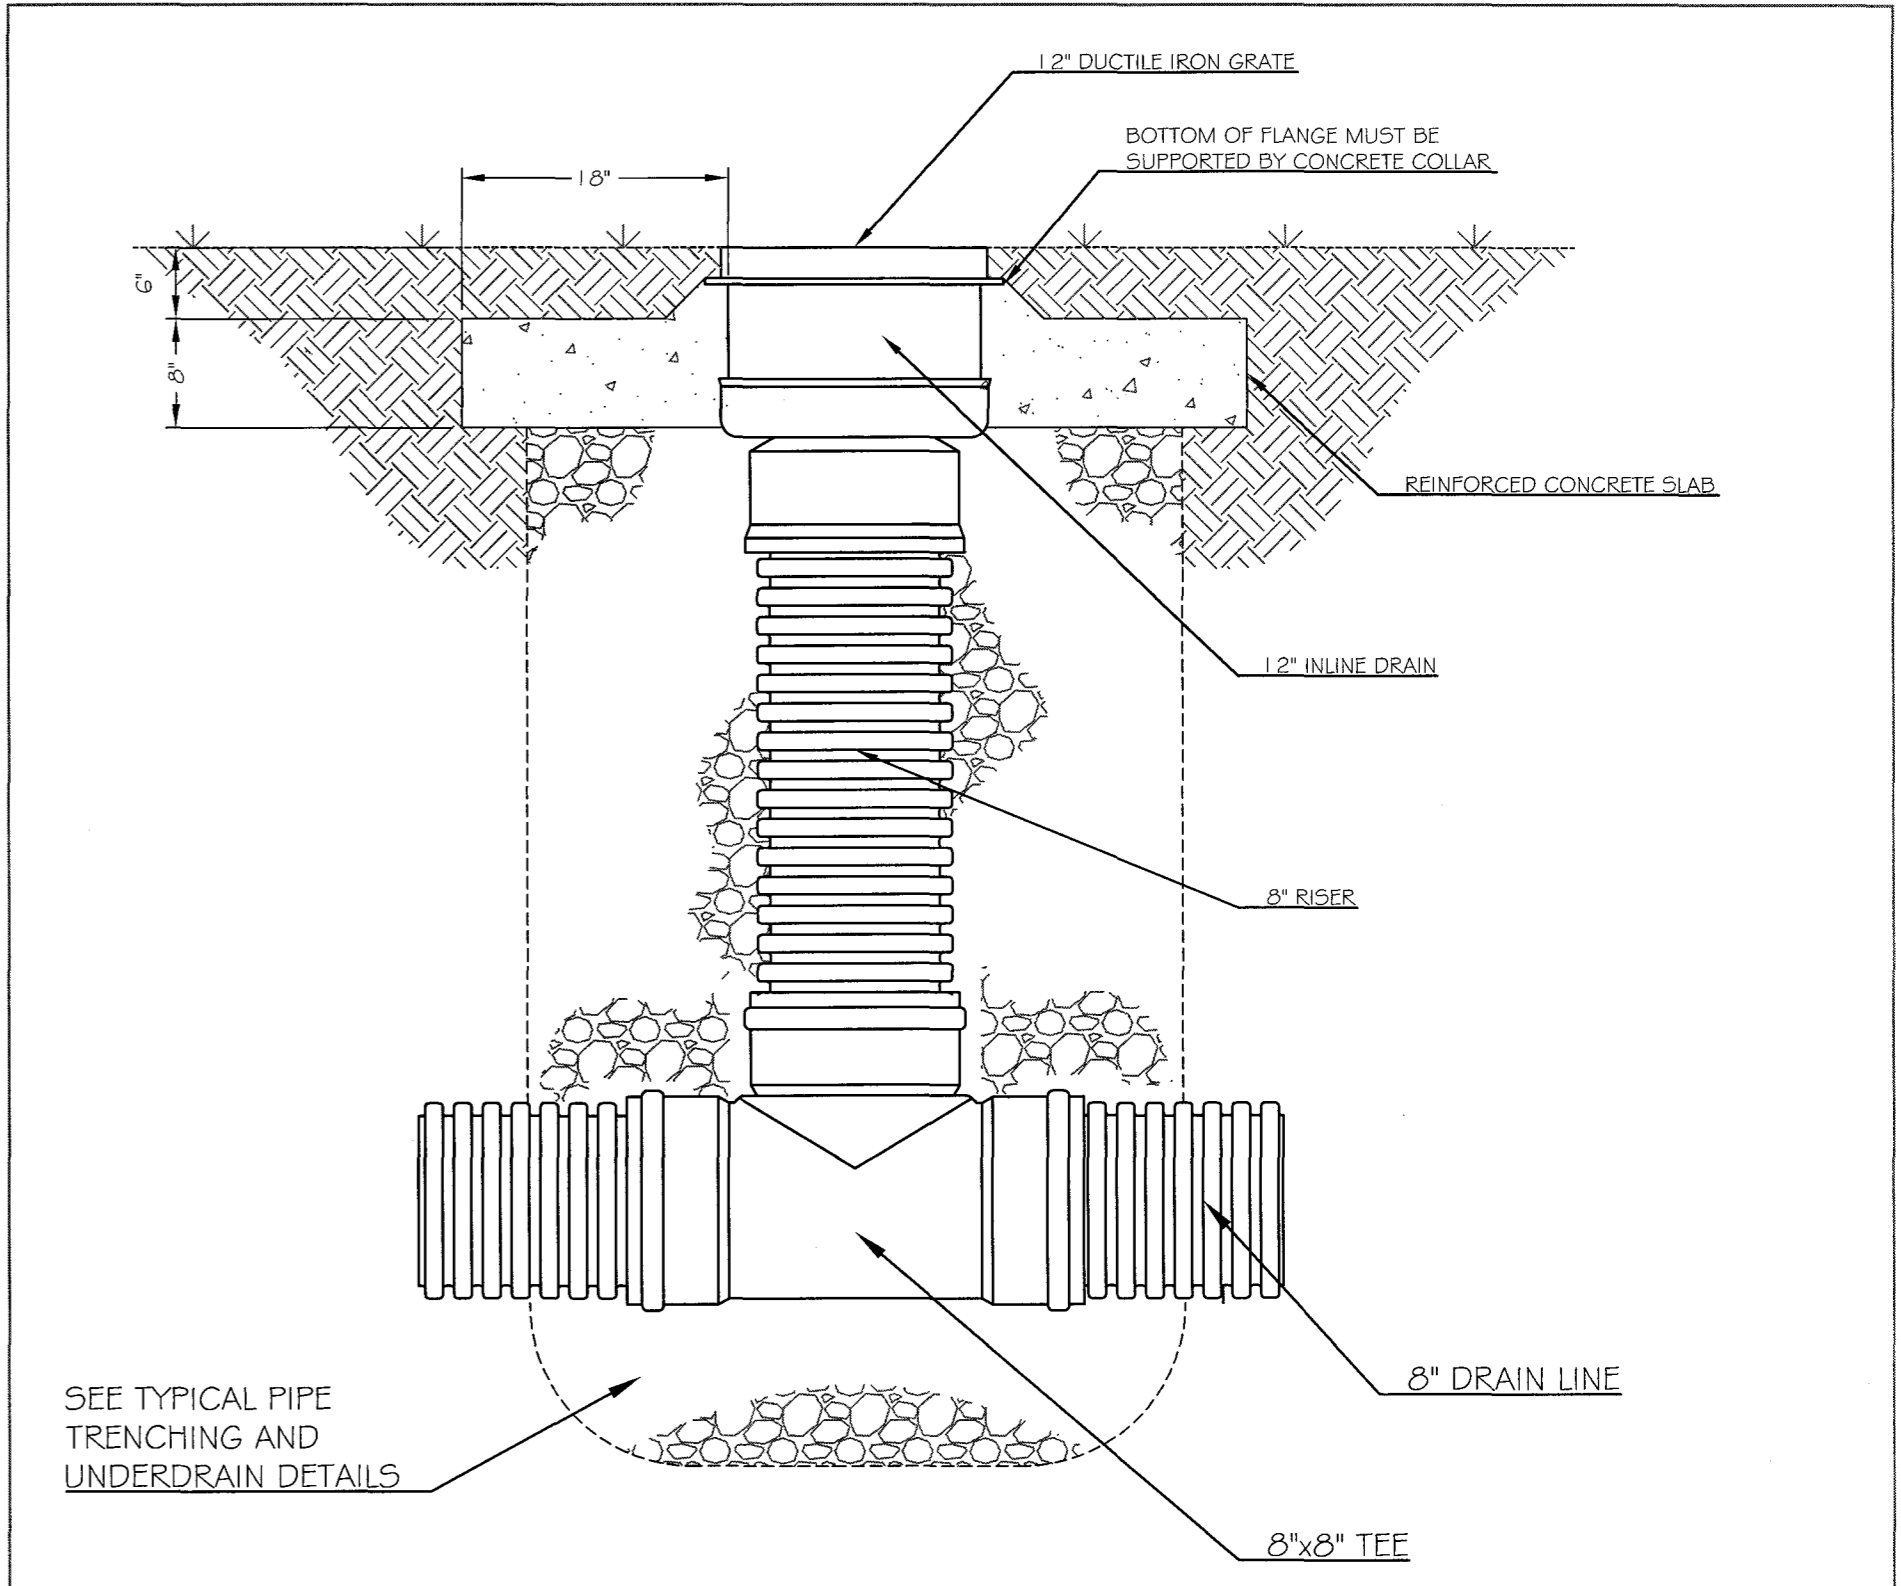

9  
C-201  
INLINE DRAIN DETAIL  
NOT TO SCALE

												<p><b>LAND DESIGN SOLUTIONS</b> LAND PLANNING, SITE PLANNING &amp; LANDSCAPE ARCHITECTURE P.O. Box 316, 160 Longwoods Road, Cumberland, ME 04021 tel: (207) 434-1717 APPLICANT &amp; OWNER: <b>JAKE'S DEVELOPMENT, INC.</b> 30 LEDGEWOOD DRIVE, FALMOUTH, MAINE 04105</p>		<p>DESIGN: PBB DRAWN: DEPT. CHKD: PBB DATE: NOV. 2017 SCALE: N.T.S.</p>		<p><b>PROPOSED PRESUMPCOT STREET BUSINESS PARK</b> 314-316 PRESUMPCOT STREET, PORTLAND, MAINE</p>	
												<p><b>SITE DETAILS</b></p>		<p>PROJ. NO. 118 DWG. NO. C-201 PLANNER Christian Roadman</p>			
REV.	DATE	STATUS	BY	CHKD.	APPD.	REV.	DATE	STATUS	BY	CHKD.	APPD.	REV.	DATE	STATUS	BY	CHKD.	APPD.
B	3/7/18	REVISED PER STAFF COMMENTS AND RESUBMITTED TO THE CITY OF PORTLAND															
A	11/30/17	SUBMITTED TO THE CITY OF PORTLAND FOR LEVEL 2 SITE PLAN APPLICATION															

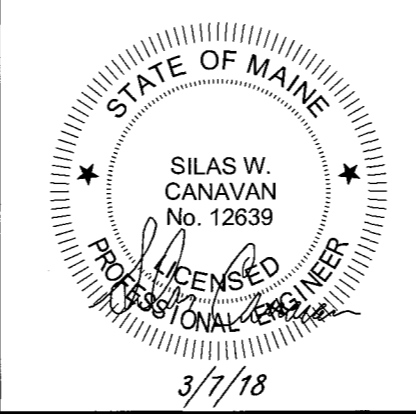


**WALSH**  
ENGINEERING ASSOCIATES, INC.  
One Karen Dr., Suite 2A | Westbrook, Maine 04092  
ph: 207.553.9998 | www.walsh-eng.com  
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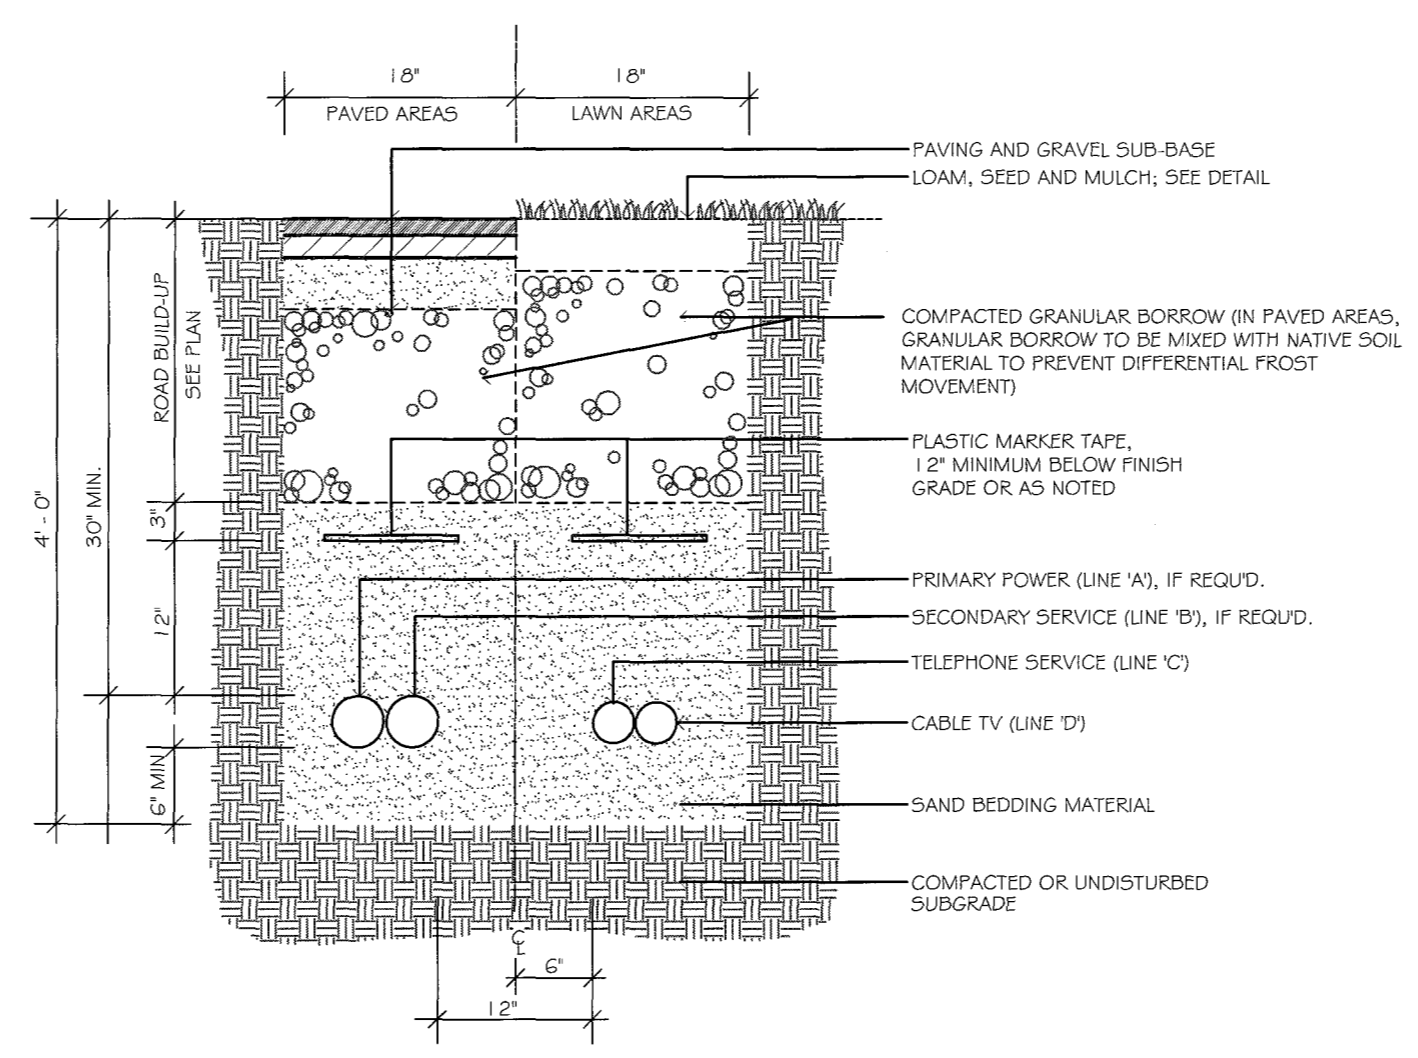


Reviewed for Code Compliance  
Permitting and Inspections Department  
Approved with Conditions  
07/23/2018



- NOTES:**
1. RESERVOIR COURSE SHALL CONSIST OF CLEAN WASHED MDOT 703.22 TYPE C UNDERDRAIN STONE.
  2. TREATMENT FILTER MEDIA SHALL CONSIST OF A MINERAL SOIL AGGREGATE WITH BETWEEN 4 AND 7% FINES (PASSING THE #200 SIEVE). BACKFILL MATERIAL FOR THE FOUNDATION MAY BE USED IF IT MEETS THE ABOVE CRITERIA.
  3. UNDERDRAIN BED SHALL CONSIST OF GRAVEL MEETING MDOT SPEC. 703.22, TYPE B.
  4. THE DRIPLINE TRENCH SHALL EXTEND THE LENGTH OF THE BUILDING OR AREA OF ROOF TO BE TREATED.
  5. THE DRIPLINE IS PART OF THE STORMWATER TREATMENT SYSTEM AND SHALL NOT BE REMOVED OR ALTERED IN ANY WAY.
- CONSTRUCTION OVERSIGHT**  
INSPECTIONS BY A PROFESSIONAL ENGINEER SHALL CONSIST OF WEEKLY VISITS TO THE SITE TO INSPECT EACH OF THE ROOF DRIP EDGE FILTERS UNDERDRAIN CONSTRUCTION, FILTER MATERIAL PLACEMENT, AND OVERFLOW FROM INITIAL GROUND DISTURBANCE TO FINAL STABILIZATION OF THE FILTER.

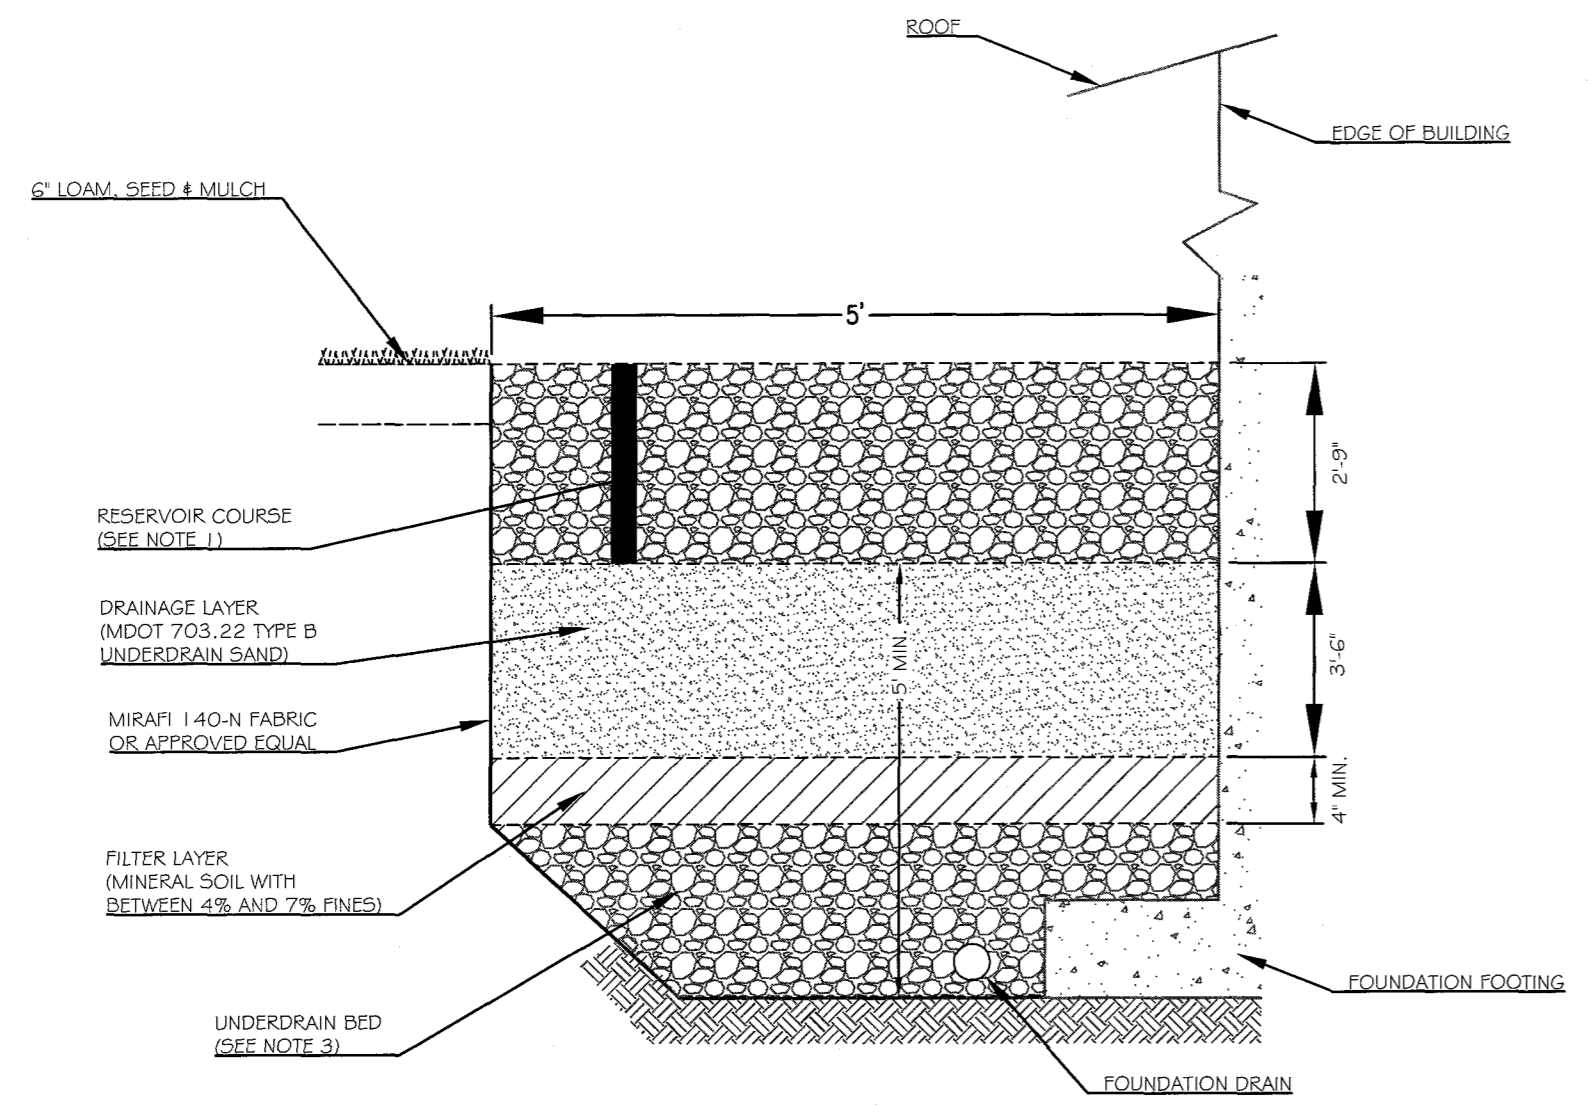
**1**  
C-202  
**TYPICAL ROOF DRIPLINE FILTER DETAIL**  
NOT TO SCALE




SERVICE	CONDUIT SIZE*	CONDUIT TYPE	UTILITY
'A'	4"	SCHEDULE 40 P.V.C. ELECTRICAL GRADE	PRIMARY POWER
'B'	4"	SCHEDULE 40 P.V.C. ELECTRICAL GRADE	SECONDARY POWER
'C'	3"	SCHEDULE 40 P.V.C. ELECTRICAL GRADE	TELEPHONE
'D'	3"	SCHEDULE 40 P.V.C. ELECTRICAL GRADE	CATV

- NOTES:**
1. ALL WORK SHALL COMPLY WITH THE RESPECTIVE UTILITY COMPANY STANDARDS.
  2. SEE UTILITIES PLANS FOR CONDUIT LOCATIONS.
  3. CONTRACTOR TO PROVIDE 1/4\"/>
  4. CONTRACTOR SHALL VERIFY CONDUIT SIZE WITH APPLICABLE UTILITY COMPANIES.


**2**  
C-202  
**UNDERGROUND UTILITY TRENCH SECTION (MULTIPLE CONDUITS)**  
NOT TO SCALE

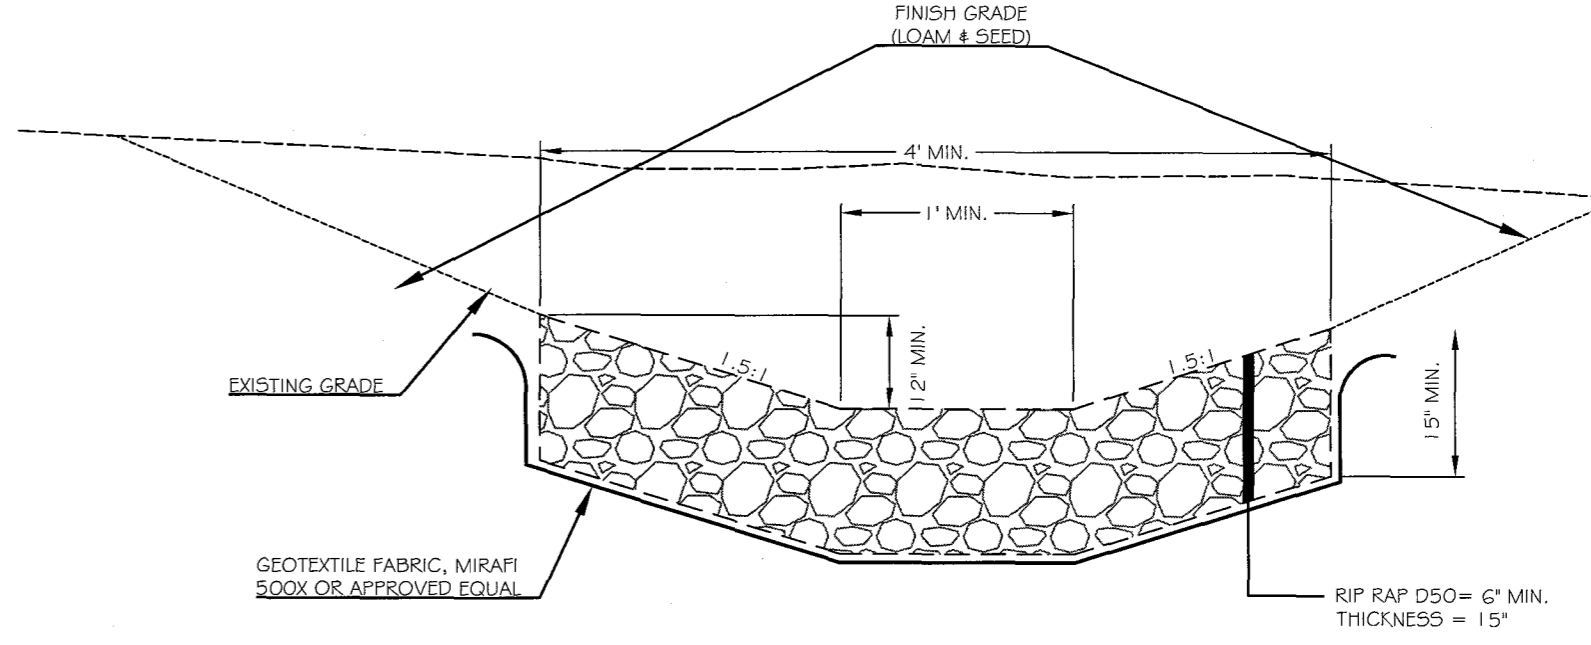


**3**  
C-202  
**RIPRAP SWALE DETAIL**  
NOT TO SCALE

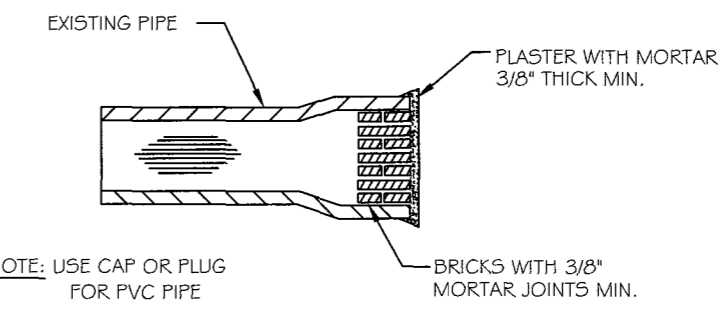


**4**  
C-202  
**PIPE ABANDONMENT DETAIL**  
NOT TO SCALE

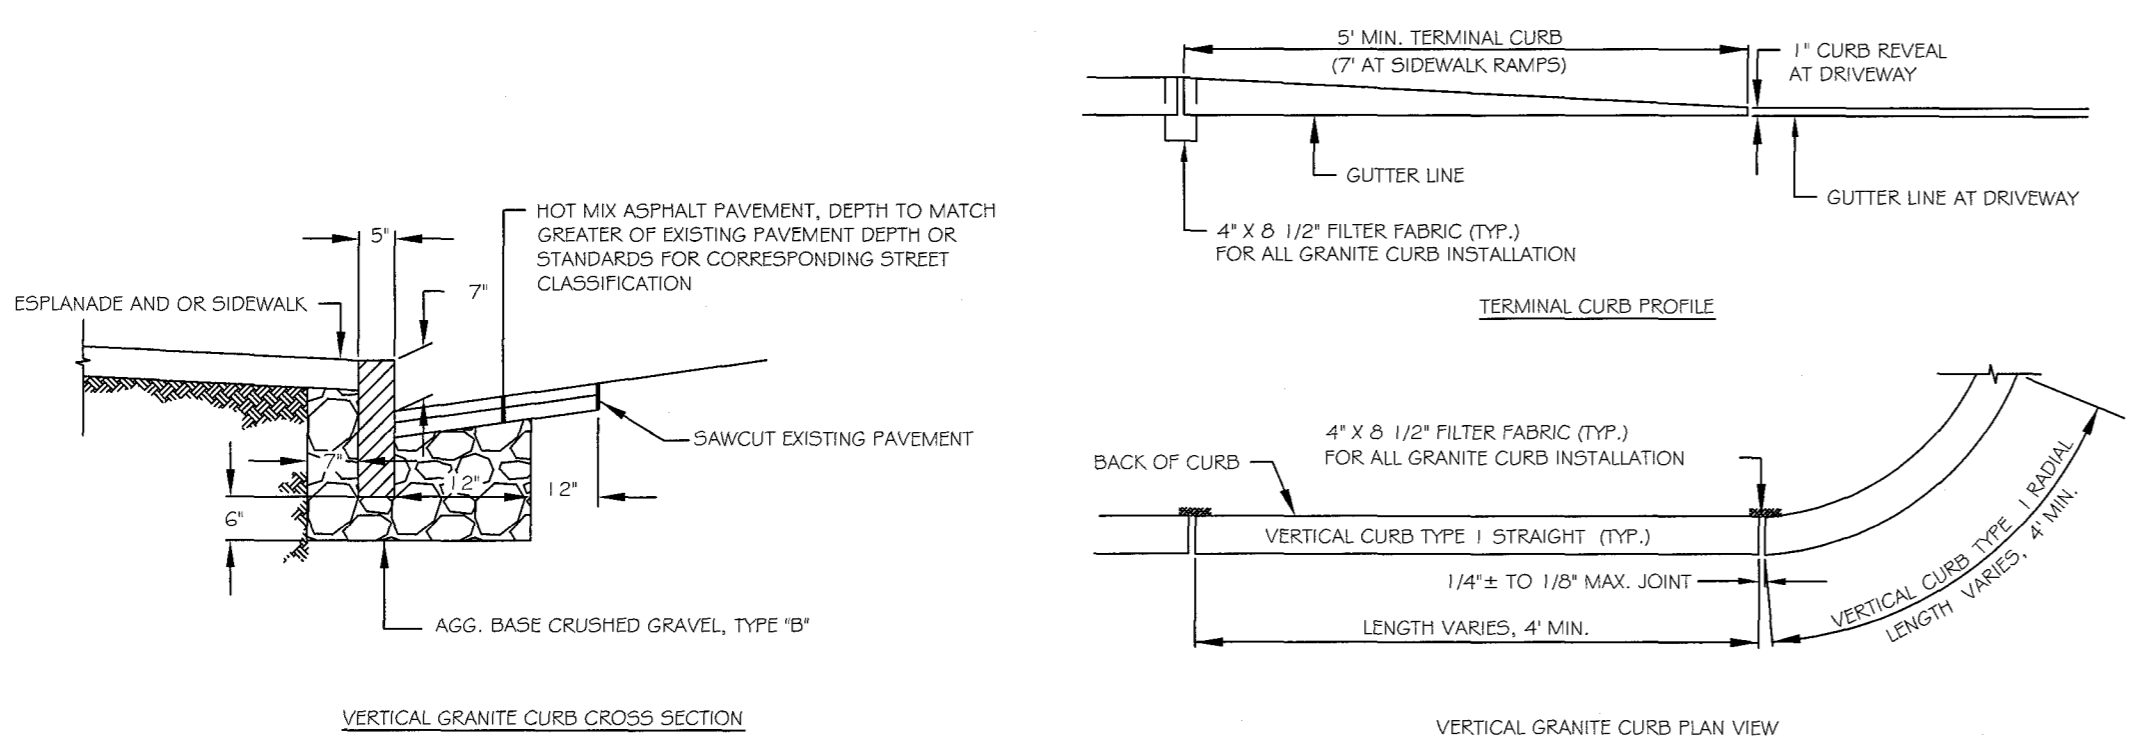

**5**  
C-202  
**GRANITE CURB INSTALLATION IN EXISTING STREETS DETAIL**  
NOT TO SCALE

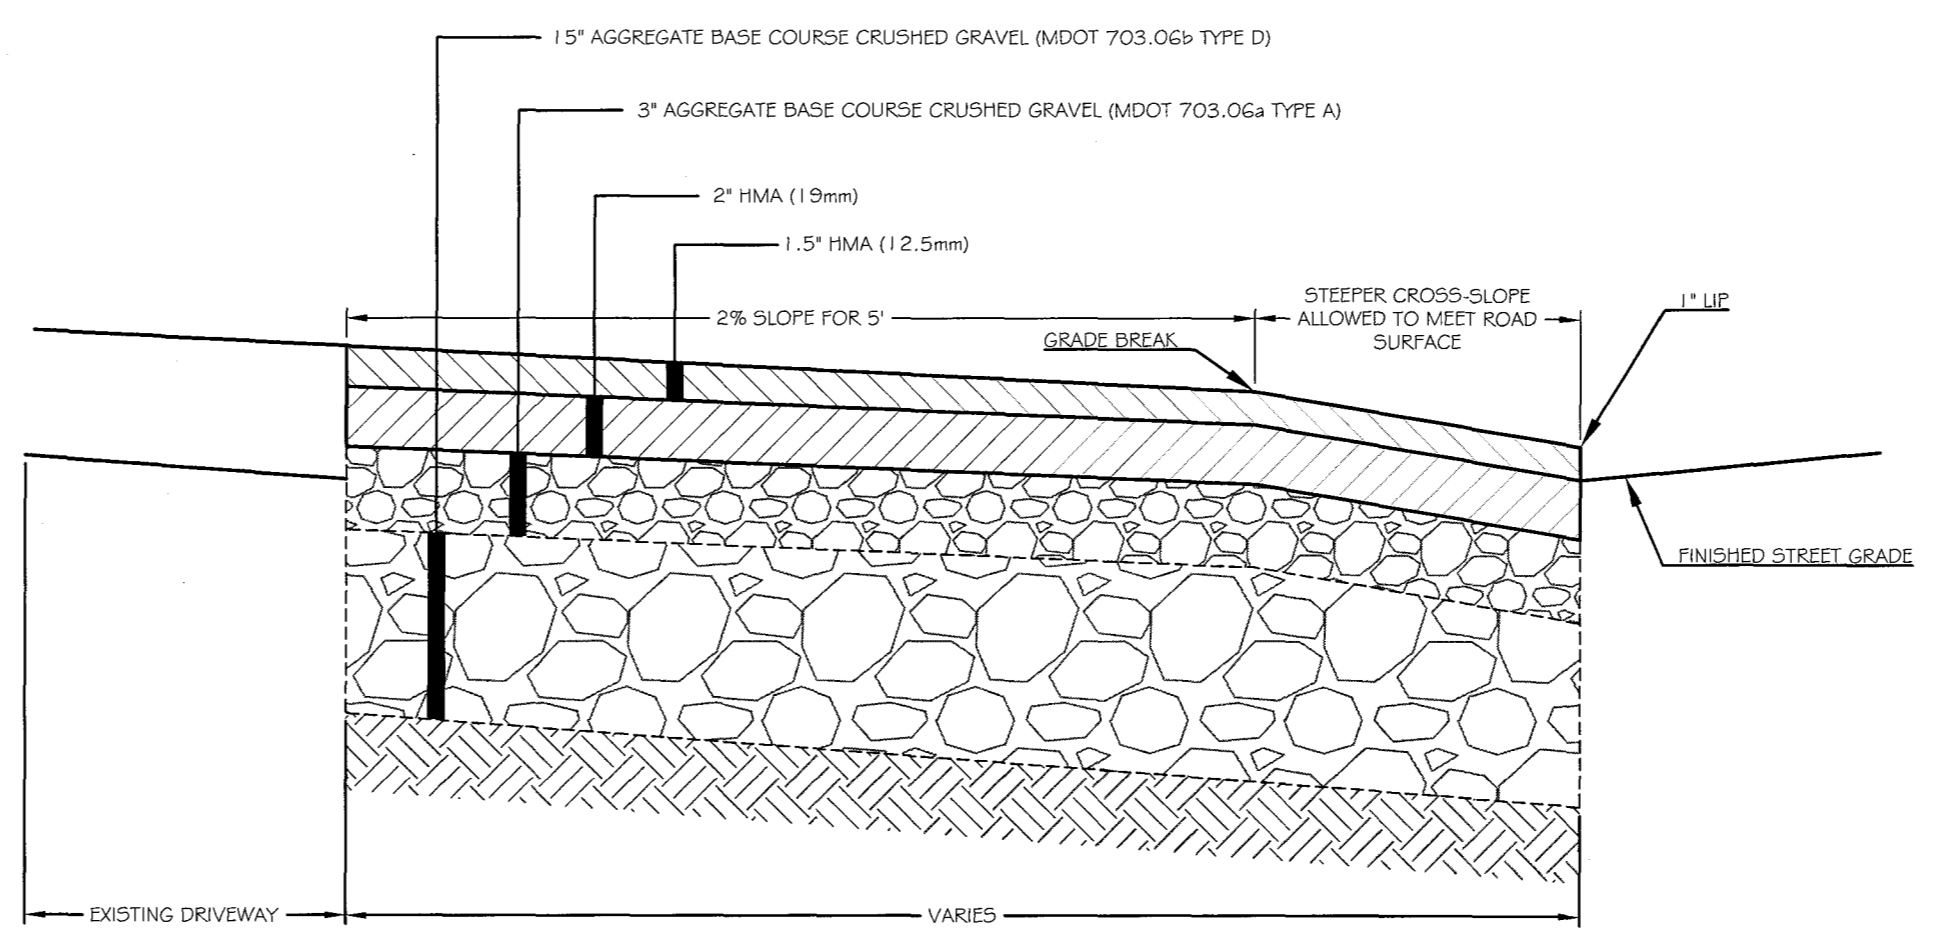


**6**  
C-202  
**BITUMINOUS DRIVEWAY APRON DETAIL**  
NOT TO SCALE

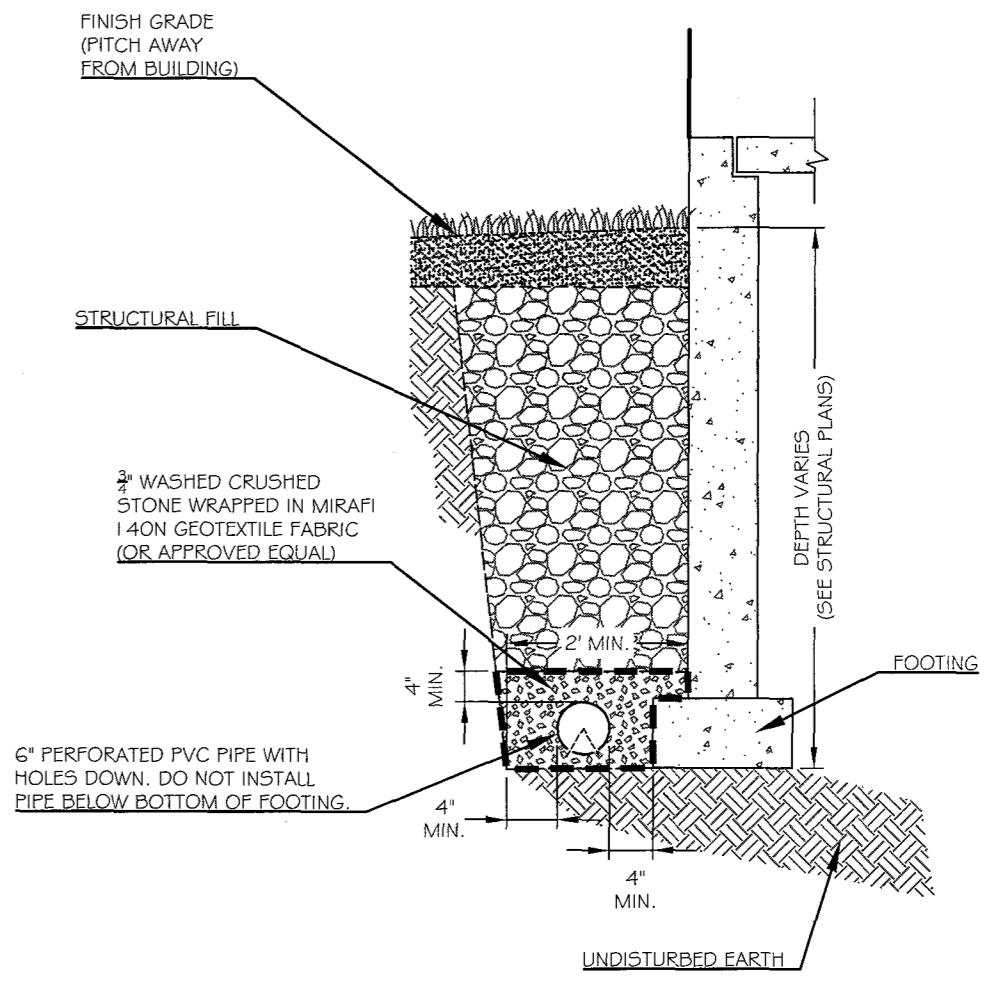

**7**  
C-202  
**FOUNDATION DRAIN DETAIL**  
NOT TO SCALE

REV.	DATE	STATUS	BY	CHKD	APPD.	REV.	DATE	STATUS	BY	CHKD	APPD.
B	3/7/18	REVISED PER STAFF COMMENTS AND RESUBMITTED TO THE CITY OF PORTLAND	DEPT.	SWC	PBB						
A	11/30/17	SUBMITTED TO THE CITY OF PORTLAND FOR LEVEL 2 SITE PLAN APPLICATION	DEPT.	SWC	PBB						

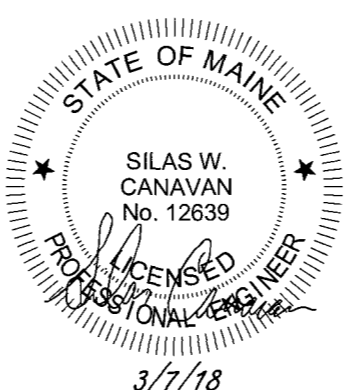

**WALSH**  
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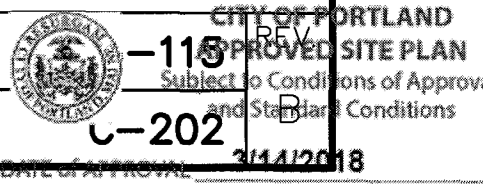
**LAND DESIGN SOLUTIONS**  
LAND PLANNING, SITE PLANNING & LANDSCAPE ARCHITECTURE  
P.O. Box 316, 160 Longwoods Road, Cumberland, ME 04021 tel:(207) 434-1171  
APPLICANT & OWNER:  
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30 LEDGEWOOD DRIVE, FALMOUTH, MAINE 04105

DESIGN: PBB  
DRAWN: DEPT.  
CHKD: PBB  
DATE: NOV. 2017  
SCALE: N.T.S.


**PROPOSED PRESUMPCOT STREET BUSINESS PARK**  
314-316 PRESUMPCOT STREET, PORTLAND, MAINE

**SITE DETAILS**


C-202




PLANNER: Christian Roadman

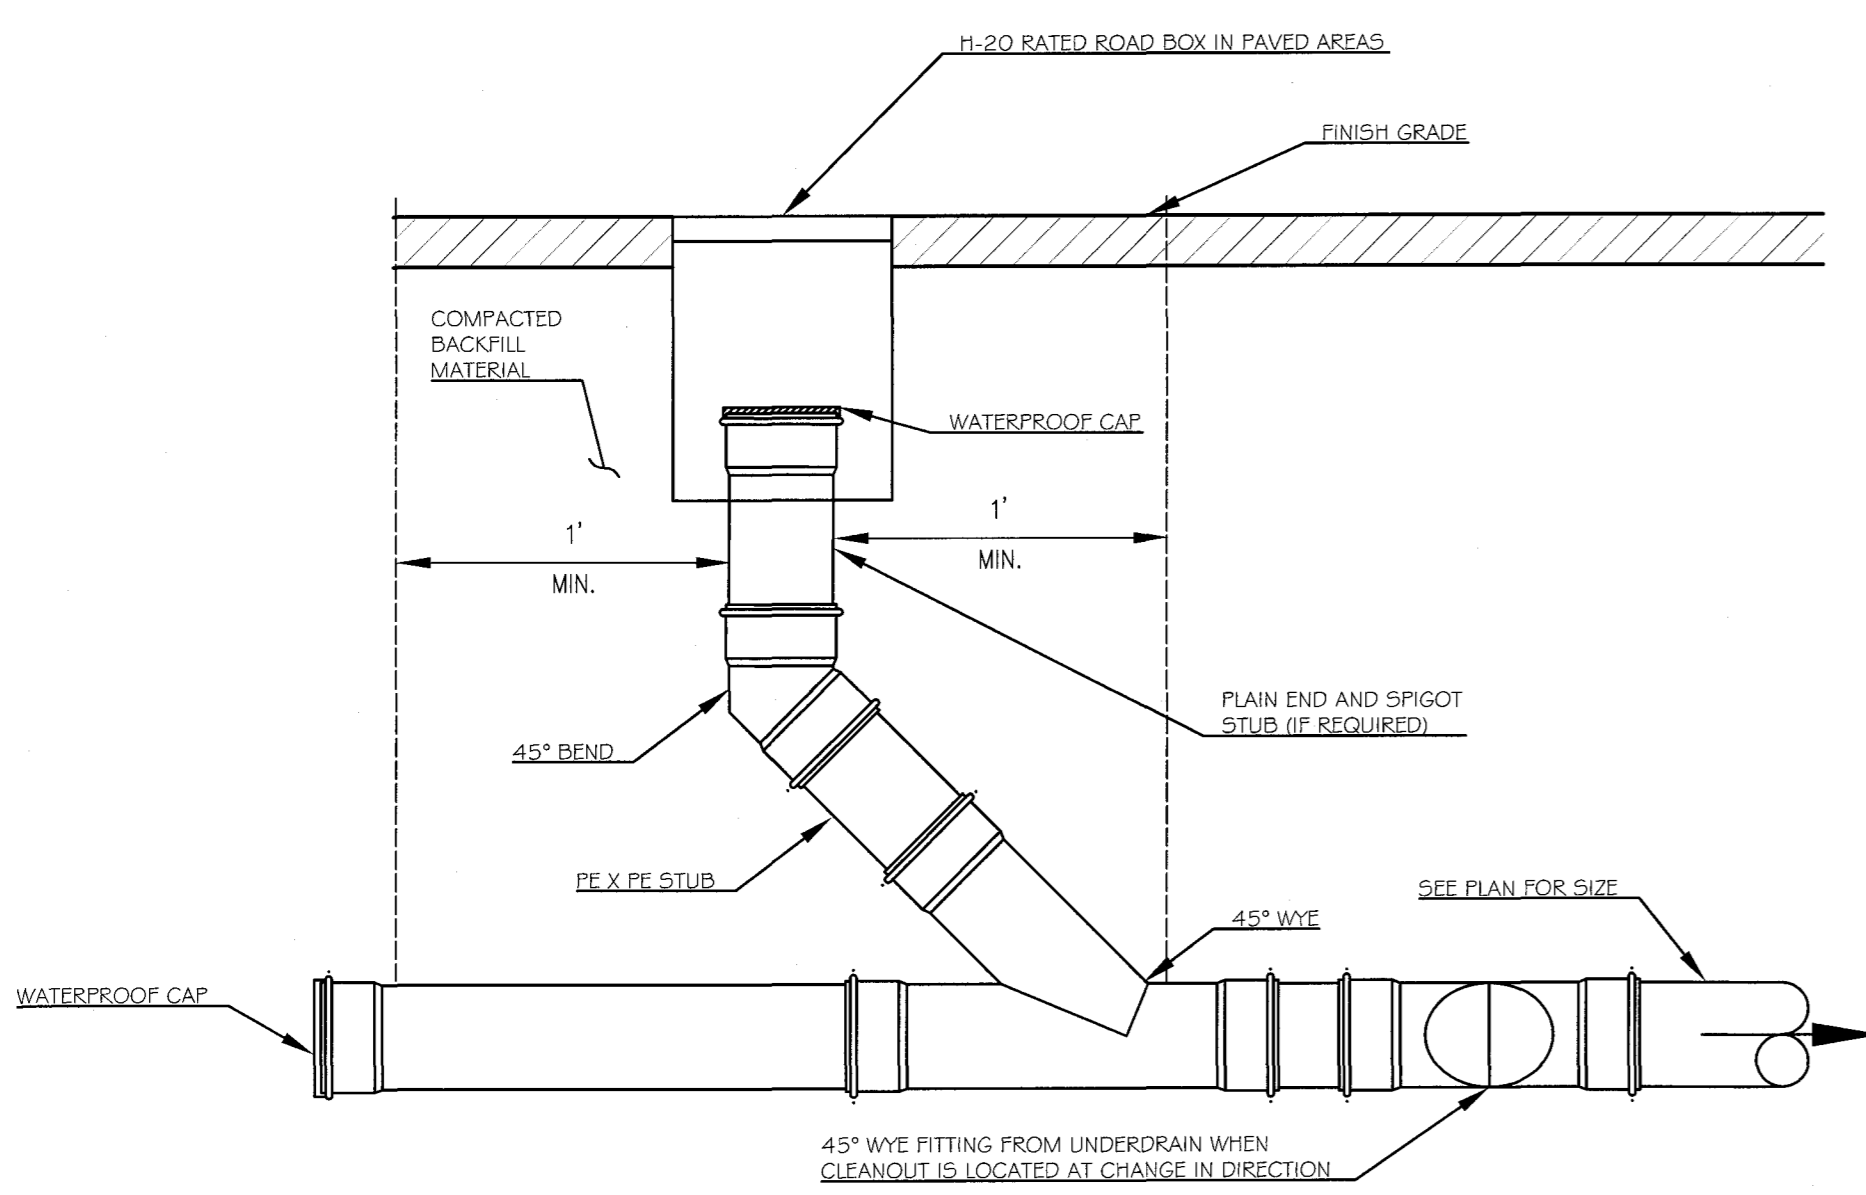


1 SEWER/STORM DRAIN CLEANOUT  
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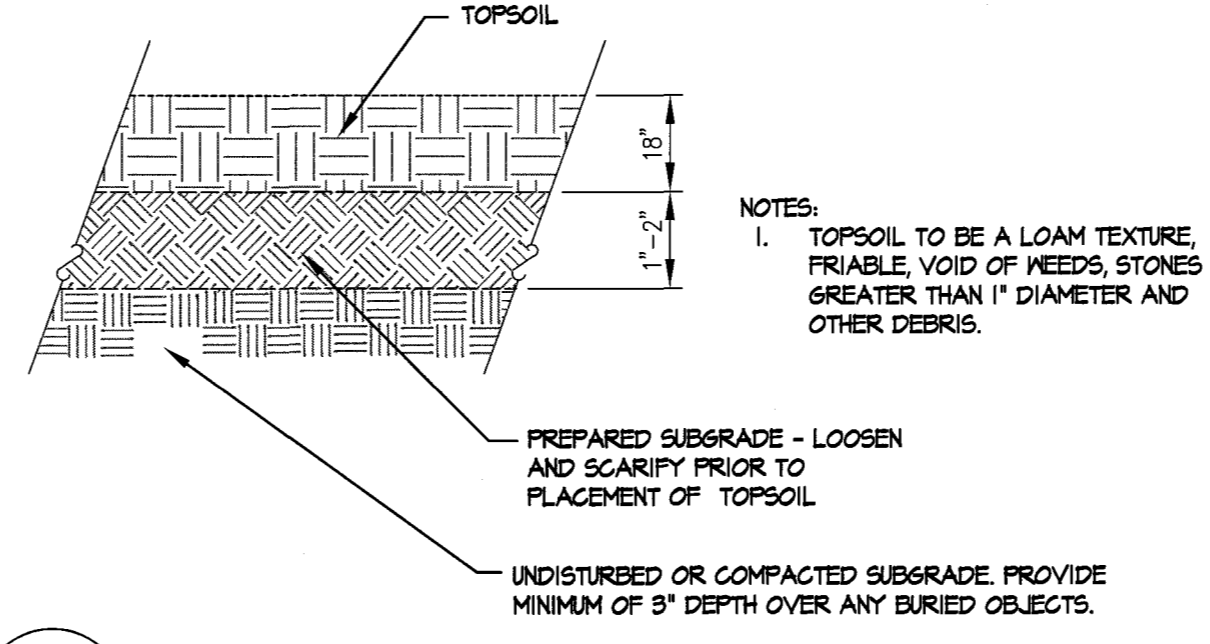
2 BIKE HITCH MOUNTING DETAIL  
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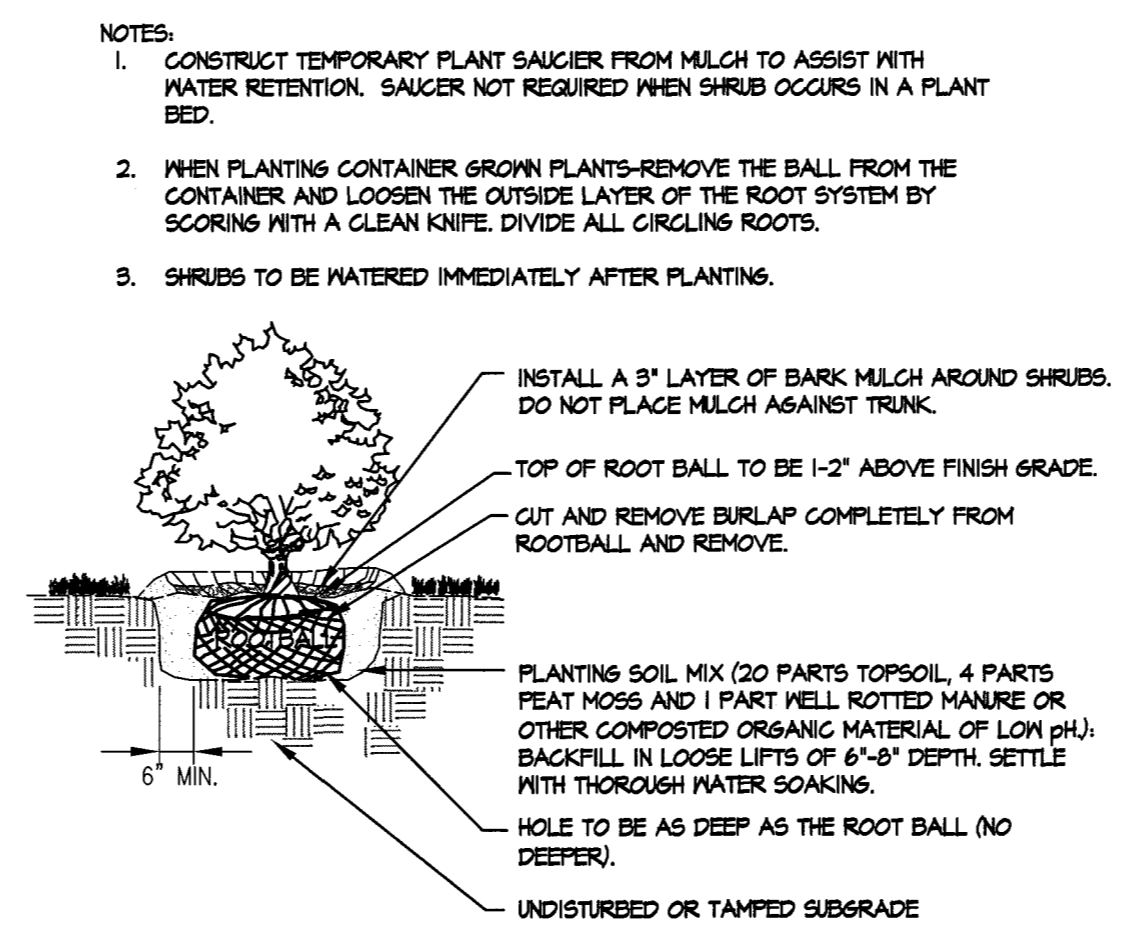
3 ACCESSIBLE PARKING STALL DETAIL  
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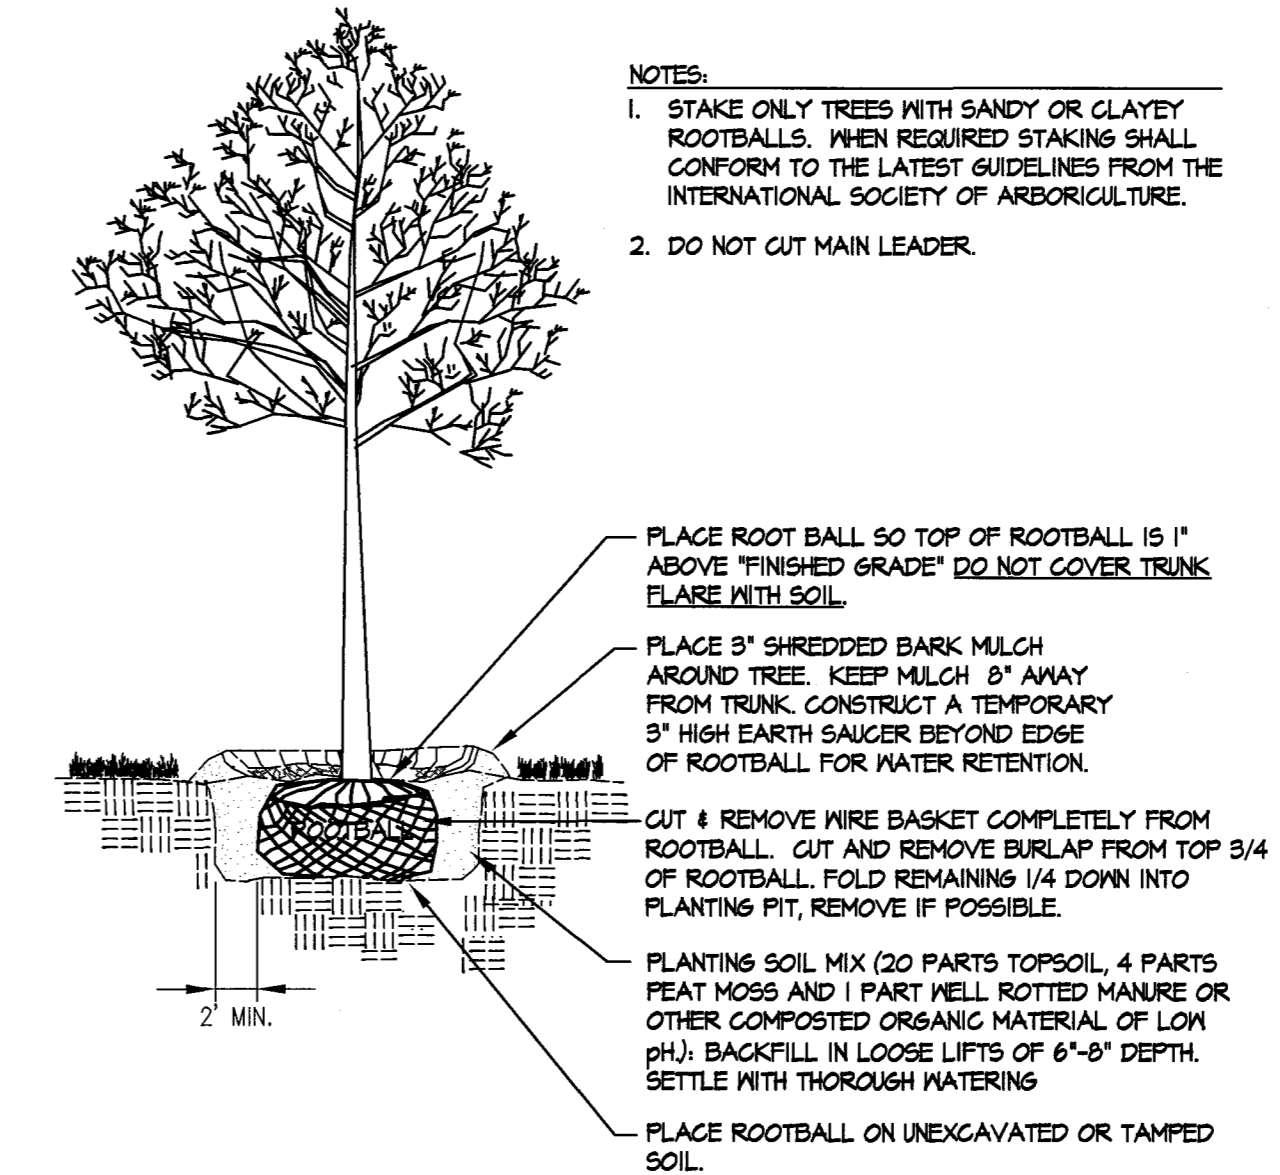
4 TYPICAL SANITARY MANHOLE  
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5 PLANT BED DETAIL  
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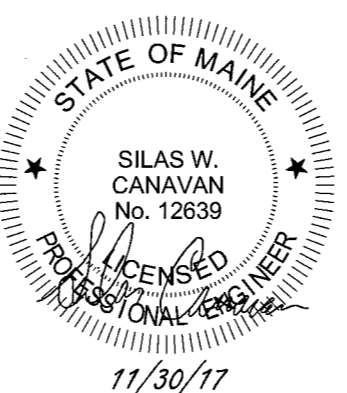


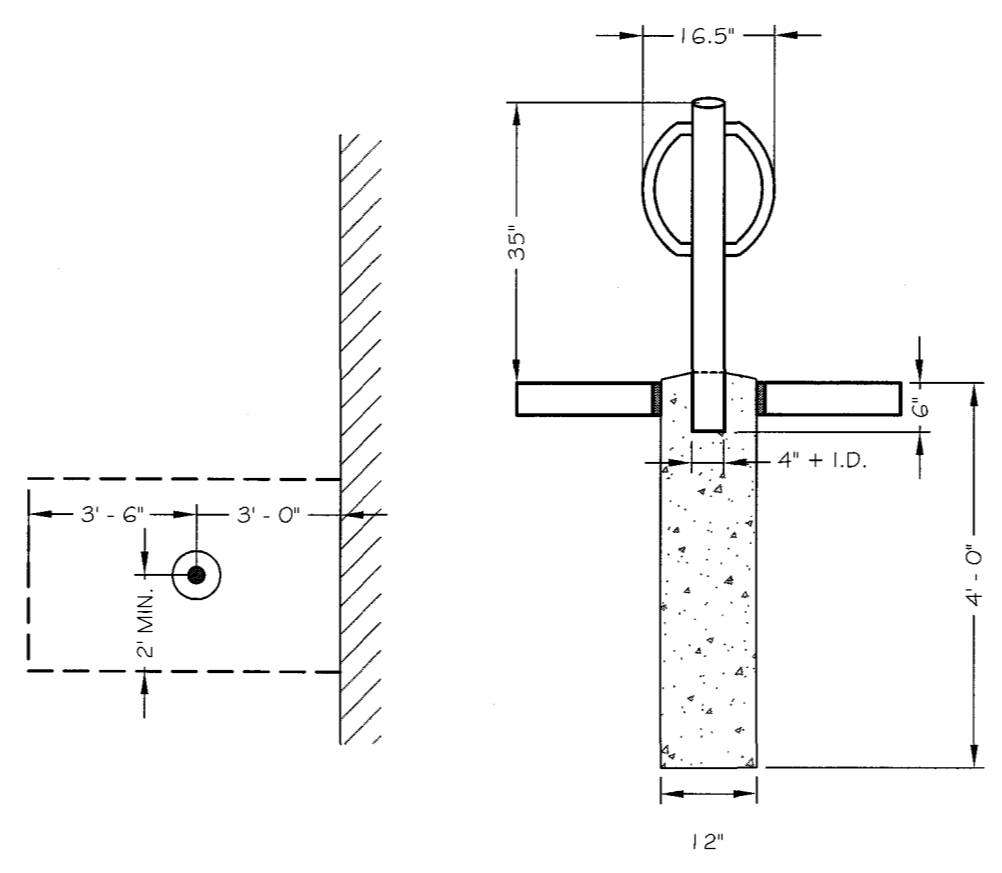6 SHRUB PLANTING DETAIL  
C-203 NOT TO SCALE

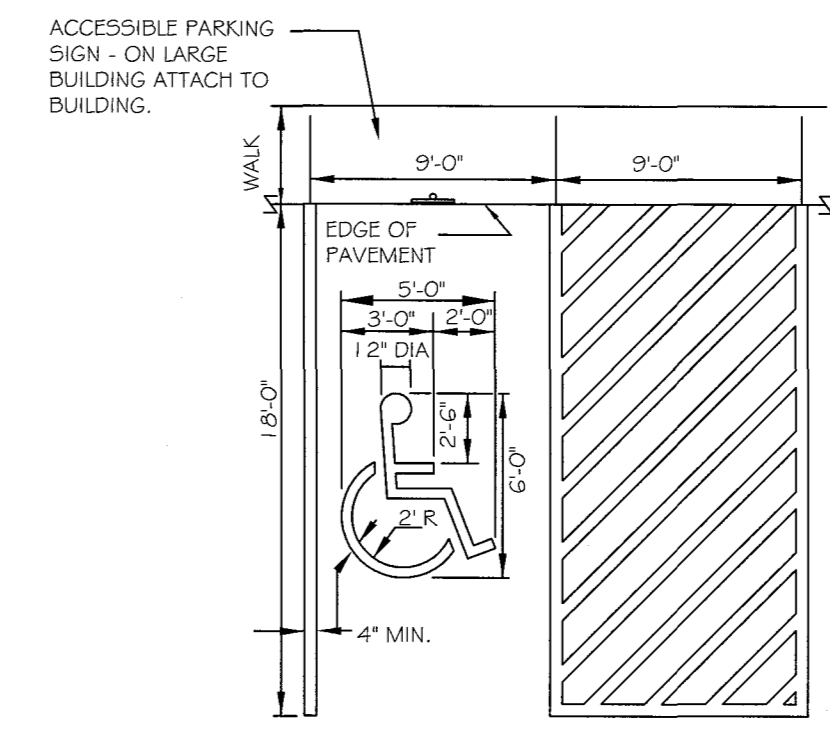

7 TREE PLANTING DETAIL  
C-203 NOT TO SCALE

REV.	DATE	STATUS	BY	CHKD.	APPD.	REV.	DATE	STATUS	BY	CHKD.	APPD.
A	11/30/17	SUBMITTED TO THE CITY OF PORTLAND FOR LEVEL 2 SITE PLAN APPLICATION	DEPT.	SWC	PBB						

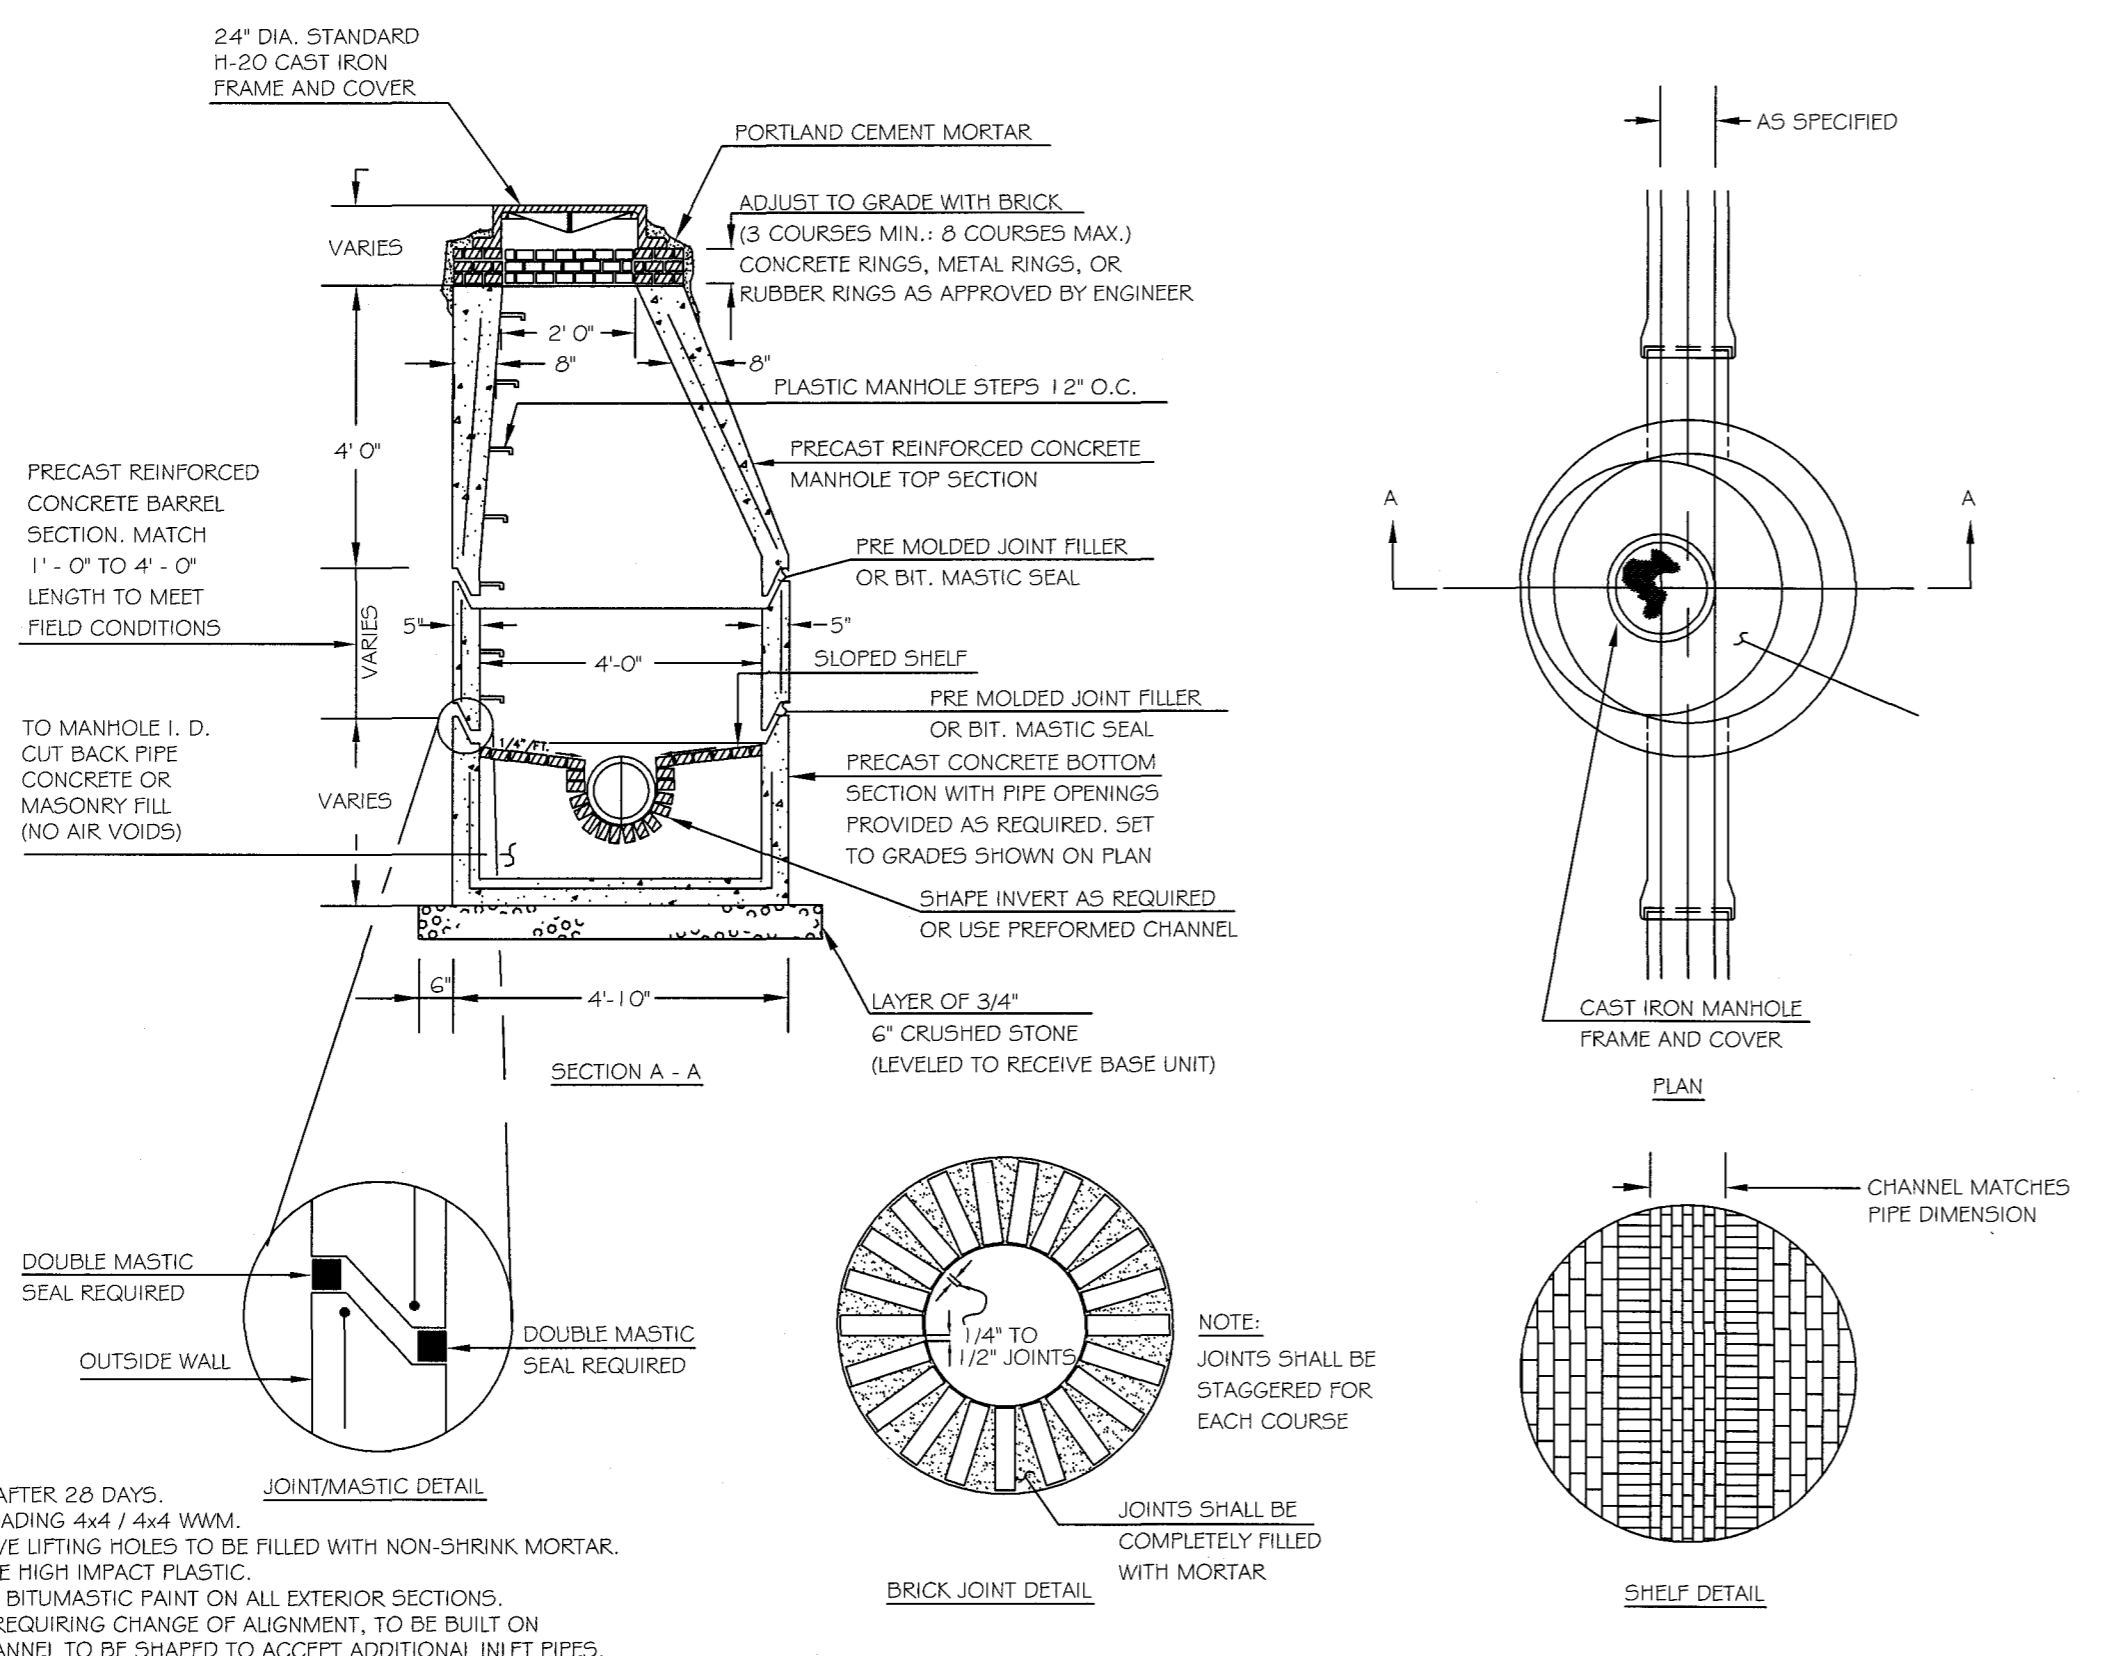

**WALSH**  
ENGINEERING ASSOCIATES, INC.  
One Karen Dr., Suite 2A | Westbrook, Maine 04092  
ph: 207.553.9898 | www.walsh-eng.com  
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**LAND DESIGN SOLUTIONS**  
LAND PLANNING, SITE PLANNING & LANDSCAPE ARCHITECTURE  
P.O. Box 916, 160 Longwoods Road, Cumberland, ME 04021 tel: (207) 939-1717

APPLICANT & OWNER:  
**JAKE'S DEVELOPMENT, INC.**  
30 LEDGEWOOD DRIVE, FALMOUTH, MAINE 04105

DESIGN: PBB
DRAWN: DEPT.
CHKD: PBB
DATE: NOV. 2017
SCALE: N.T.S.

**PROPOSED PRESUMPCOT STREET BUSINESS PARK**  
314-316 PRESUMPCOT STREET, PORTLAND, MAINE

**SITE DETAILS**

PROJ. NO. C-203  
DWG. NO. 314/2018

PLANNER: Christian Roadman





Reviewed for Code Compliance  
 Permitting and Inspections Department  
 Approved with Conditions  
 07/23/2018




BISKUP CONSTRUCTION, INC.  
 16 DANIELLE DRIVE  
 WINDHAM, MAINE 04062  
 TEL. (207) 892-9800  
 FAX. (207) 892-9895

WWW.BISKUPCONSTRUCTION.COM

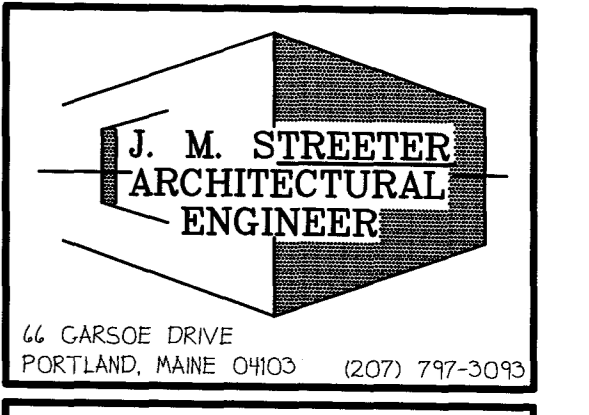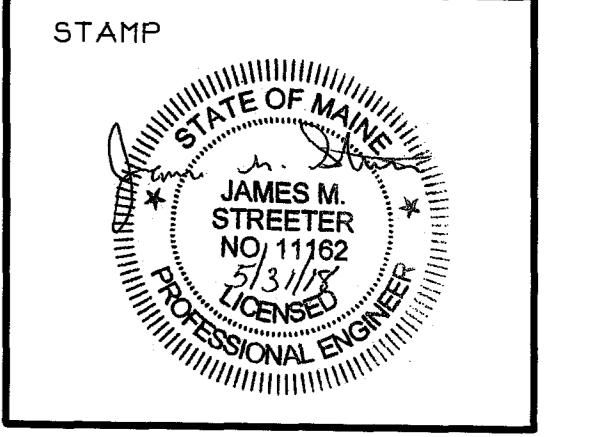

16 CARSOE DRIVE  
 PORTLAND, MAINE 04103 (207) 797-3093

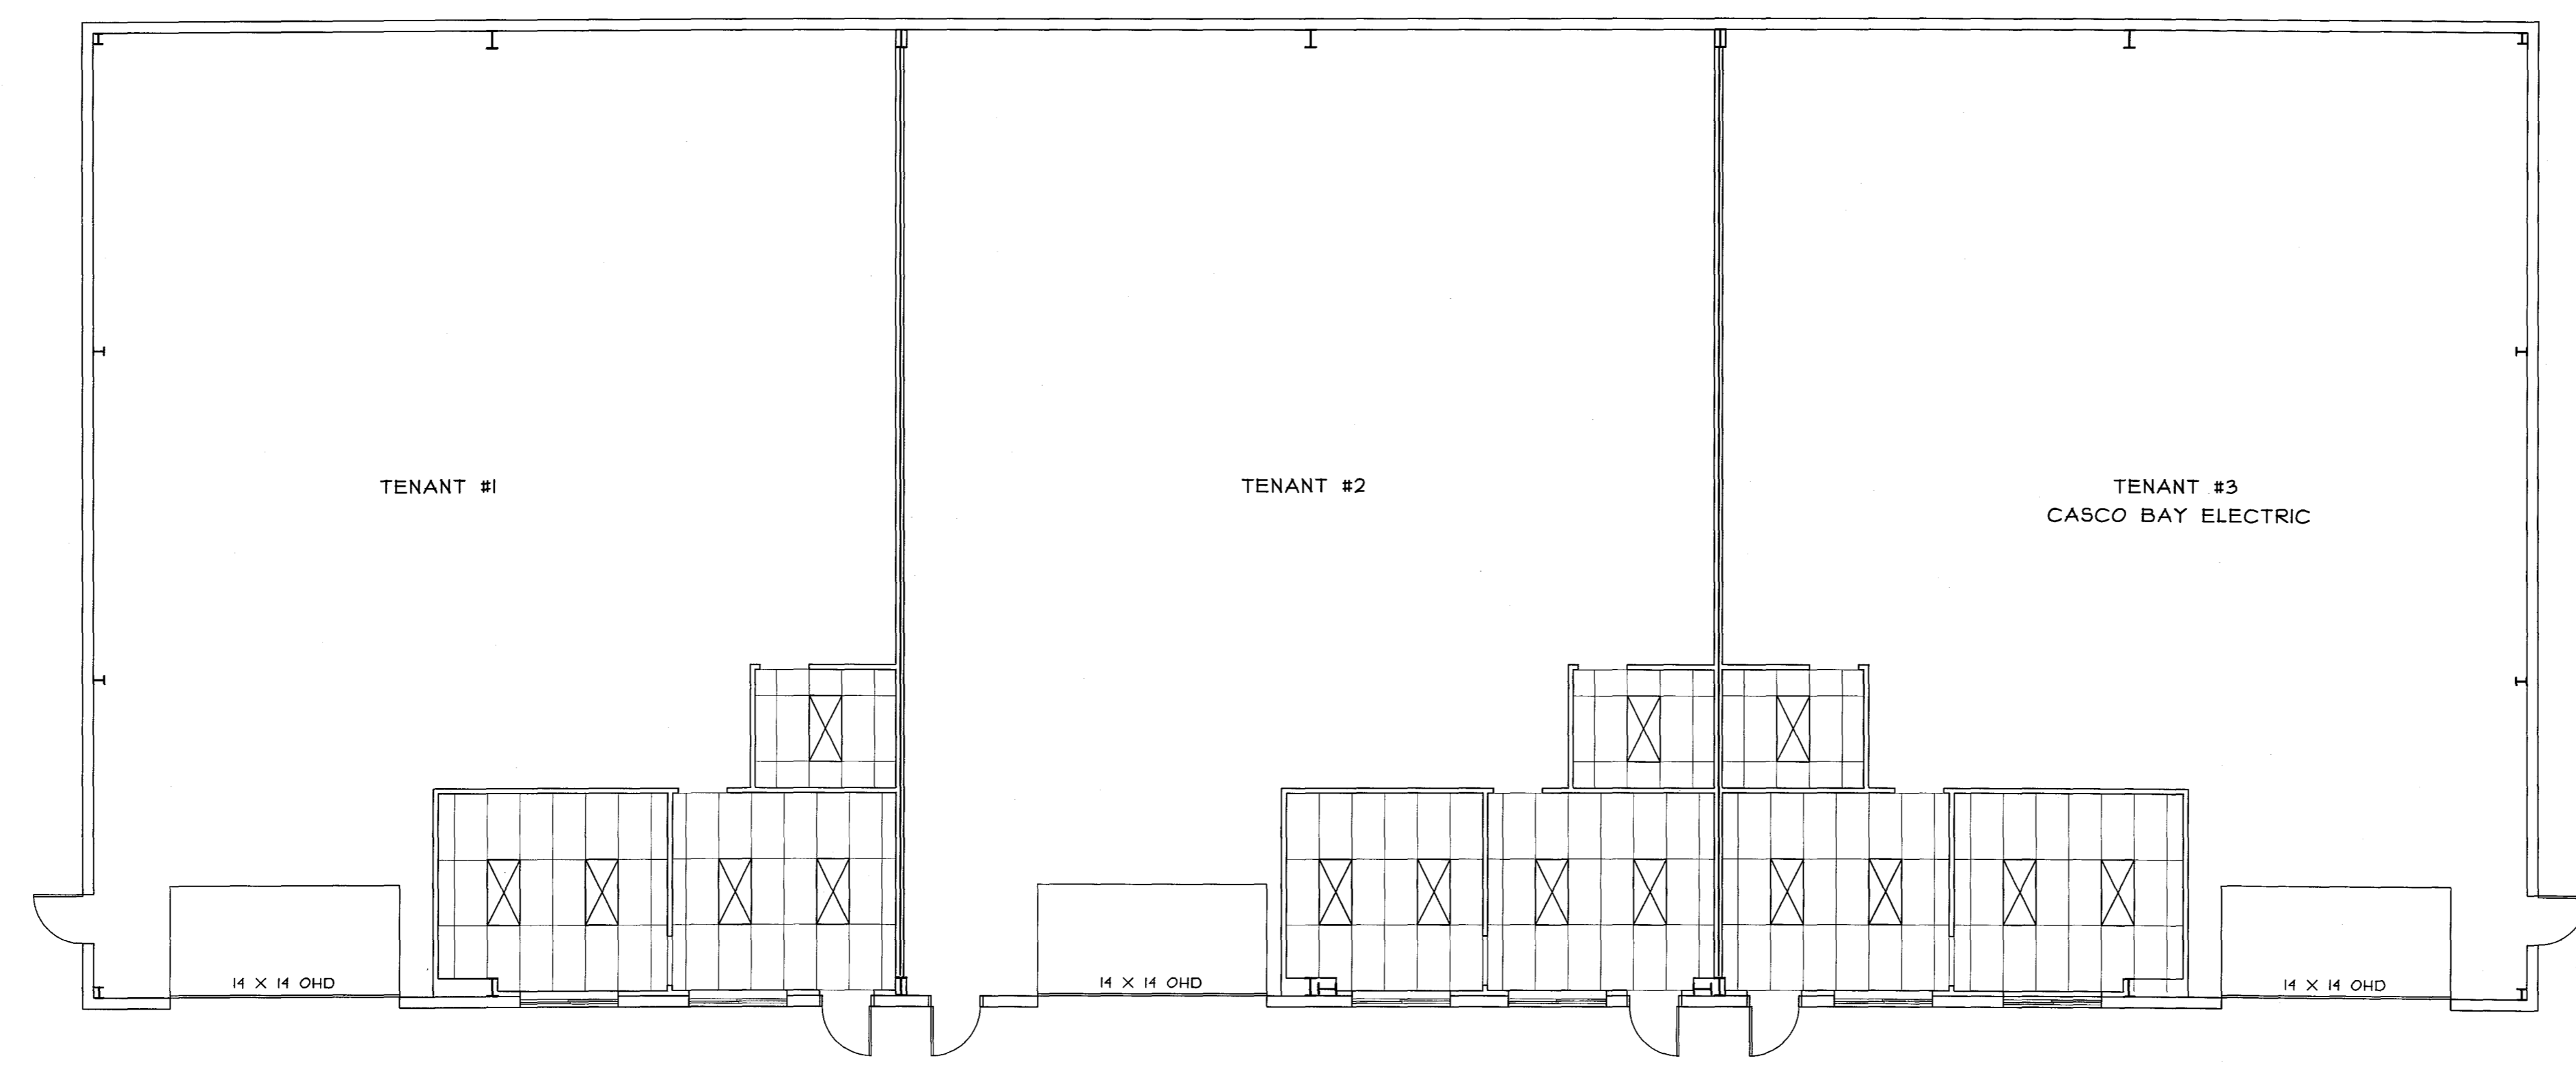

ALL CEILINGS 8'-3" A.F.F.

PROJECT:  
 PROPOSED BUILDING  
 320 P STREET, LLC  
 314 PRESUMPCOT STREET  
 PORTLAND, MAINE


REVISIONS	
DATE	DESCRIPTION

DATE: 5/30/2018  
 SCALE: 1/8" = 1'-0"  
 DESIGNER: JS  
 CHECKED BY: JB

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 BISKUP CONSTRUCTION, INC.

SHEET TITLE  
 CEILING PLAN

SHEET NUMBER  
 A-5  
 SHEET 5 OF 5

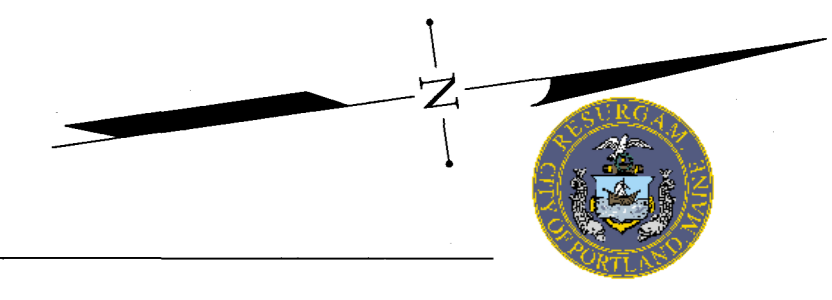




Reviewed for Code Compliance  
 Permitting and Inspections Department  
 Approved with Conditions  
**07/23/2018**

**GENERAL PROJECT NOTES:**


1. THE PROPERTY OWNER OF RECORD IS:  
 JAKE'S DEVELOPMENT, INC.  
 30 LEDGEWOOD DRIVE  
 FALMOUTH, ME 04105
2. TAX ASSESSORS REFERENCE: 423-A-33, 20, 13 & 12
3. BOUNDARY SURVEY WAS PROVIDED BY:  
 CULLENBERG LAND SURVEYING  
 892 OLD DANVILLE ROAD  
 AUBURN, ME 04210
4. TOPOGRAPHIC AND OTHER EXISTING CONDITIONS INFORMATION WAS PROVIDED BY CULLENBERG LAND SURVEYING, AERIAL MAPPING AND IN THE FIELD OBSERVATIONS BY THE DESIGN TEAM.
5. PRIOR TO THE START OF ANY EXCAVATION FOR THE PROJECT, BOTH ON-SITE AND OFF-SITE, THE CONTRACTOR SHALL NOTIFY DIGSAFE AND BE PROVIDED WITH A DIGSAFE NUMBER INDICATING THAT ALL EXISTING UTILITIES HAVE BEEN LOCATED AND CLEARLY MARKED.
6. CONTRACTOR SHALL THOROUGHLY FAMILIARIZE THEMSELVES WITH ALL DRAWINGS AND SITE CONDITIONS PRIOR TO BIDDING AND PRIOR TO CONSTRUCTION.
7. IT IS THE CONTRACTORS RESPONSIBILITY TO FAMILIARIZE THEMSELVES WITH THE CONDITIONS OF ALL PERMITS AND APPROVALS AND CONDUCT THE WORK IN ACCORDANCE WITH THESE PERMITS AND APPROVALS. THE CONTRACTOR SHALL OBTAIN AND PAY FOR ALL ADDITIONAL PERMITS, STREET OPENINGS, NOTICES AND FEES NECESSARY TO COMPLETE THE WORK.
8. ANY DISCREPANCIES BETWEEN DRAWINGS AND SITE CONDITIONS AS WELL AS MANUFACTURER'S RECOMMENDATIONS SHALL BE REPORTED IMMEDIATELY TO THE OWNER'S REPRESENTATIVE FOR CLARIFICATION AND RESOLUTION PRIOR TO BIDDING OR CONSTRUCTION.
9. CONTRACTOR SHALL BE SOLELY RESPONSIBLE FOR ALL MEANS, METHODS AND TECHNIQUES EMPLOYED TO PERFORM WORK SHOWN ON THESE PLANS. ALL WORK SHALL CONFORM TO THE CURRENT CITY OF PORTLAND TECHNICAL STANDARDS AND DETAILS.
10. THE CONTRACTOR SHALL LIMIT THE CONSTRUCTION ACTIVITY TO THE LIMITS SHOWN ON THE PLANS, UNLESS OTHERWISE AUTHORIZED BY THE OWNERS REPRESENTATIVE.
11. THE CONTRACTOR SHALL INSTALL TEMPORARY EROSION CONTROL MEASURES PRIOR TO STARTING CONSTRUCTION. SEE DRAWINGS C-102 AND C-200 FOR EROSION CONTROL MEASURES.
12. THERE IS A MORATORIUM ON STREET OPENINGS IN PRESUMPCOT STREET UNTIL 8-14-2018.

**EXISTING UTILITY NOTES:**

1. THE UNDERGROUND UTILITIES HEREON SHOWN HAVE BEEN LOCATED FROM FIELD SURVEY INFORMATION AND EXISTING DRAWINGS. THE DESIGN ENGINEER MAKES NO GUARANTEES THAT THE UNDERGROUND UTILITIES SHOWN COMPRISE ALL UTILITIES IN THE AREA, EITHER IN SERVICE OR ABANDONED. THE DESIGN ENGINEER FURTHER DOES NOT WARRANT THAT THE UNDERGROUND UTILITIES SHOWN ARE IN THE EXACT LOCATION INDICATED ALTHOUGH THEY ARE LOCATED AS ACCURATELY AS POSSIBLE FROM AVAILABLE INFORMATION.
2. THE CONTRACTOR SHALL BE RESPONSIBLE FOR NOTIFYING "DIG SAFE" AND LOCAL UTILITY COMPANIES AT LEAST THREE (3) BUSINESS DAYS, BUT NOT MORE THAN 60 CALENDAR DAYS, PRIOR TO THE COMMENCEMENT OF ANY EXCAVATION, IN ACCORDANCE WITH MAINE STATE LAW. "DIG SAFE" TELEPHONE NUMBER IS 1-888-344-7233.

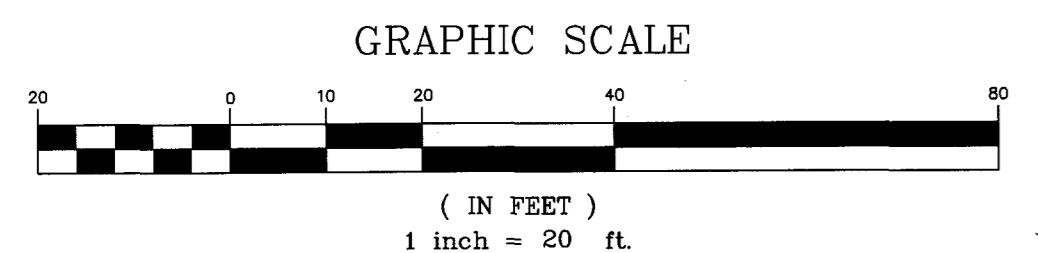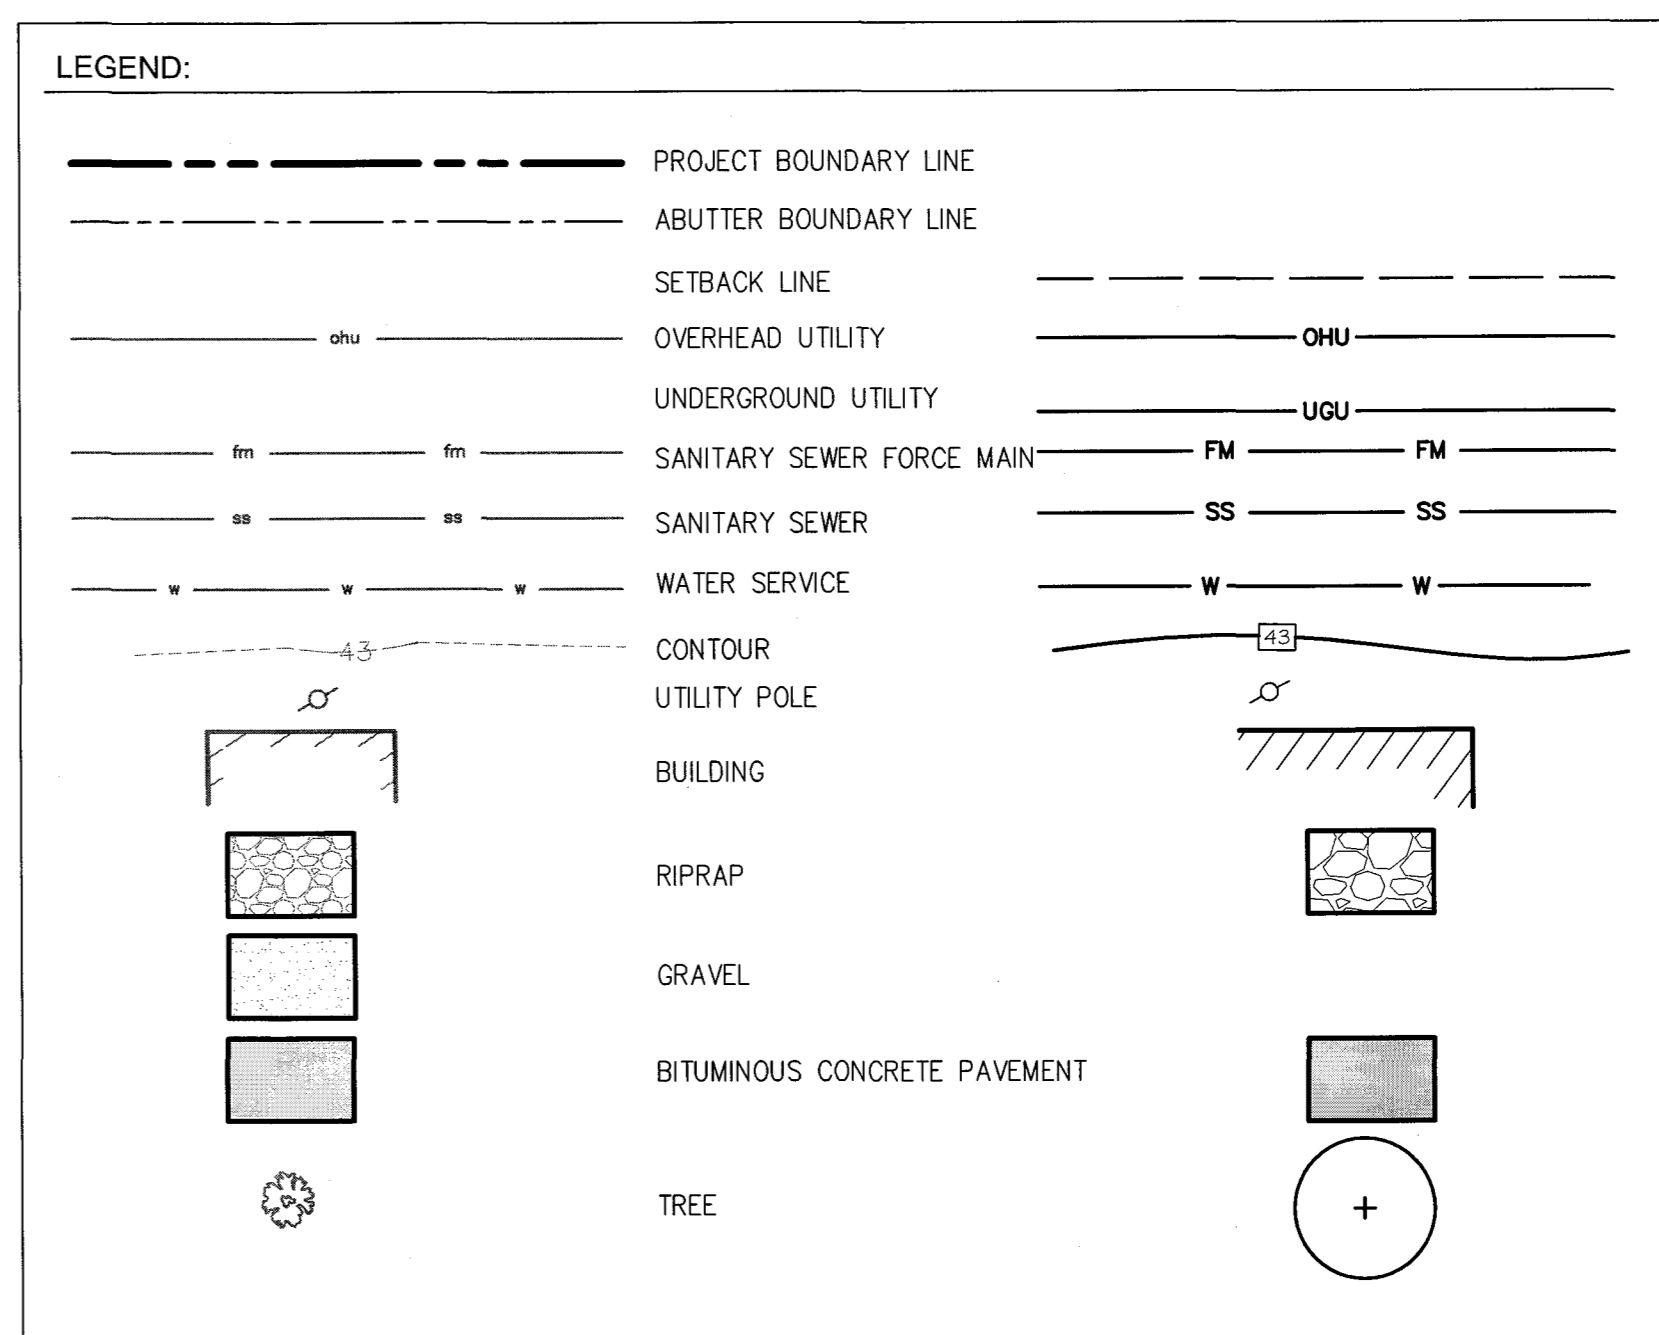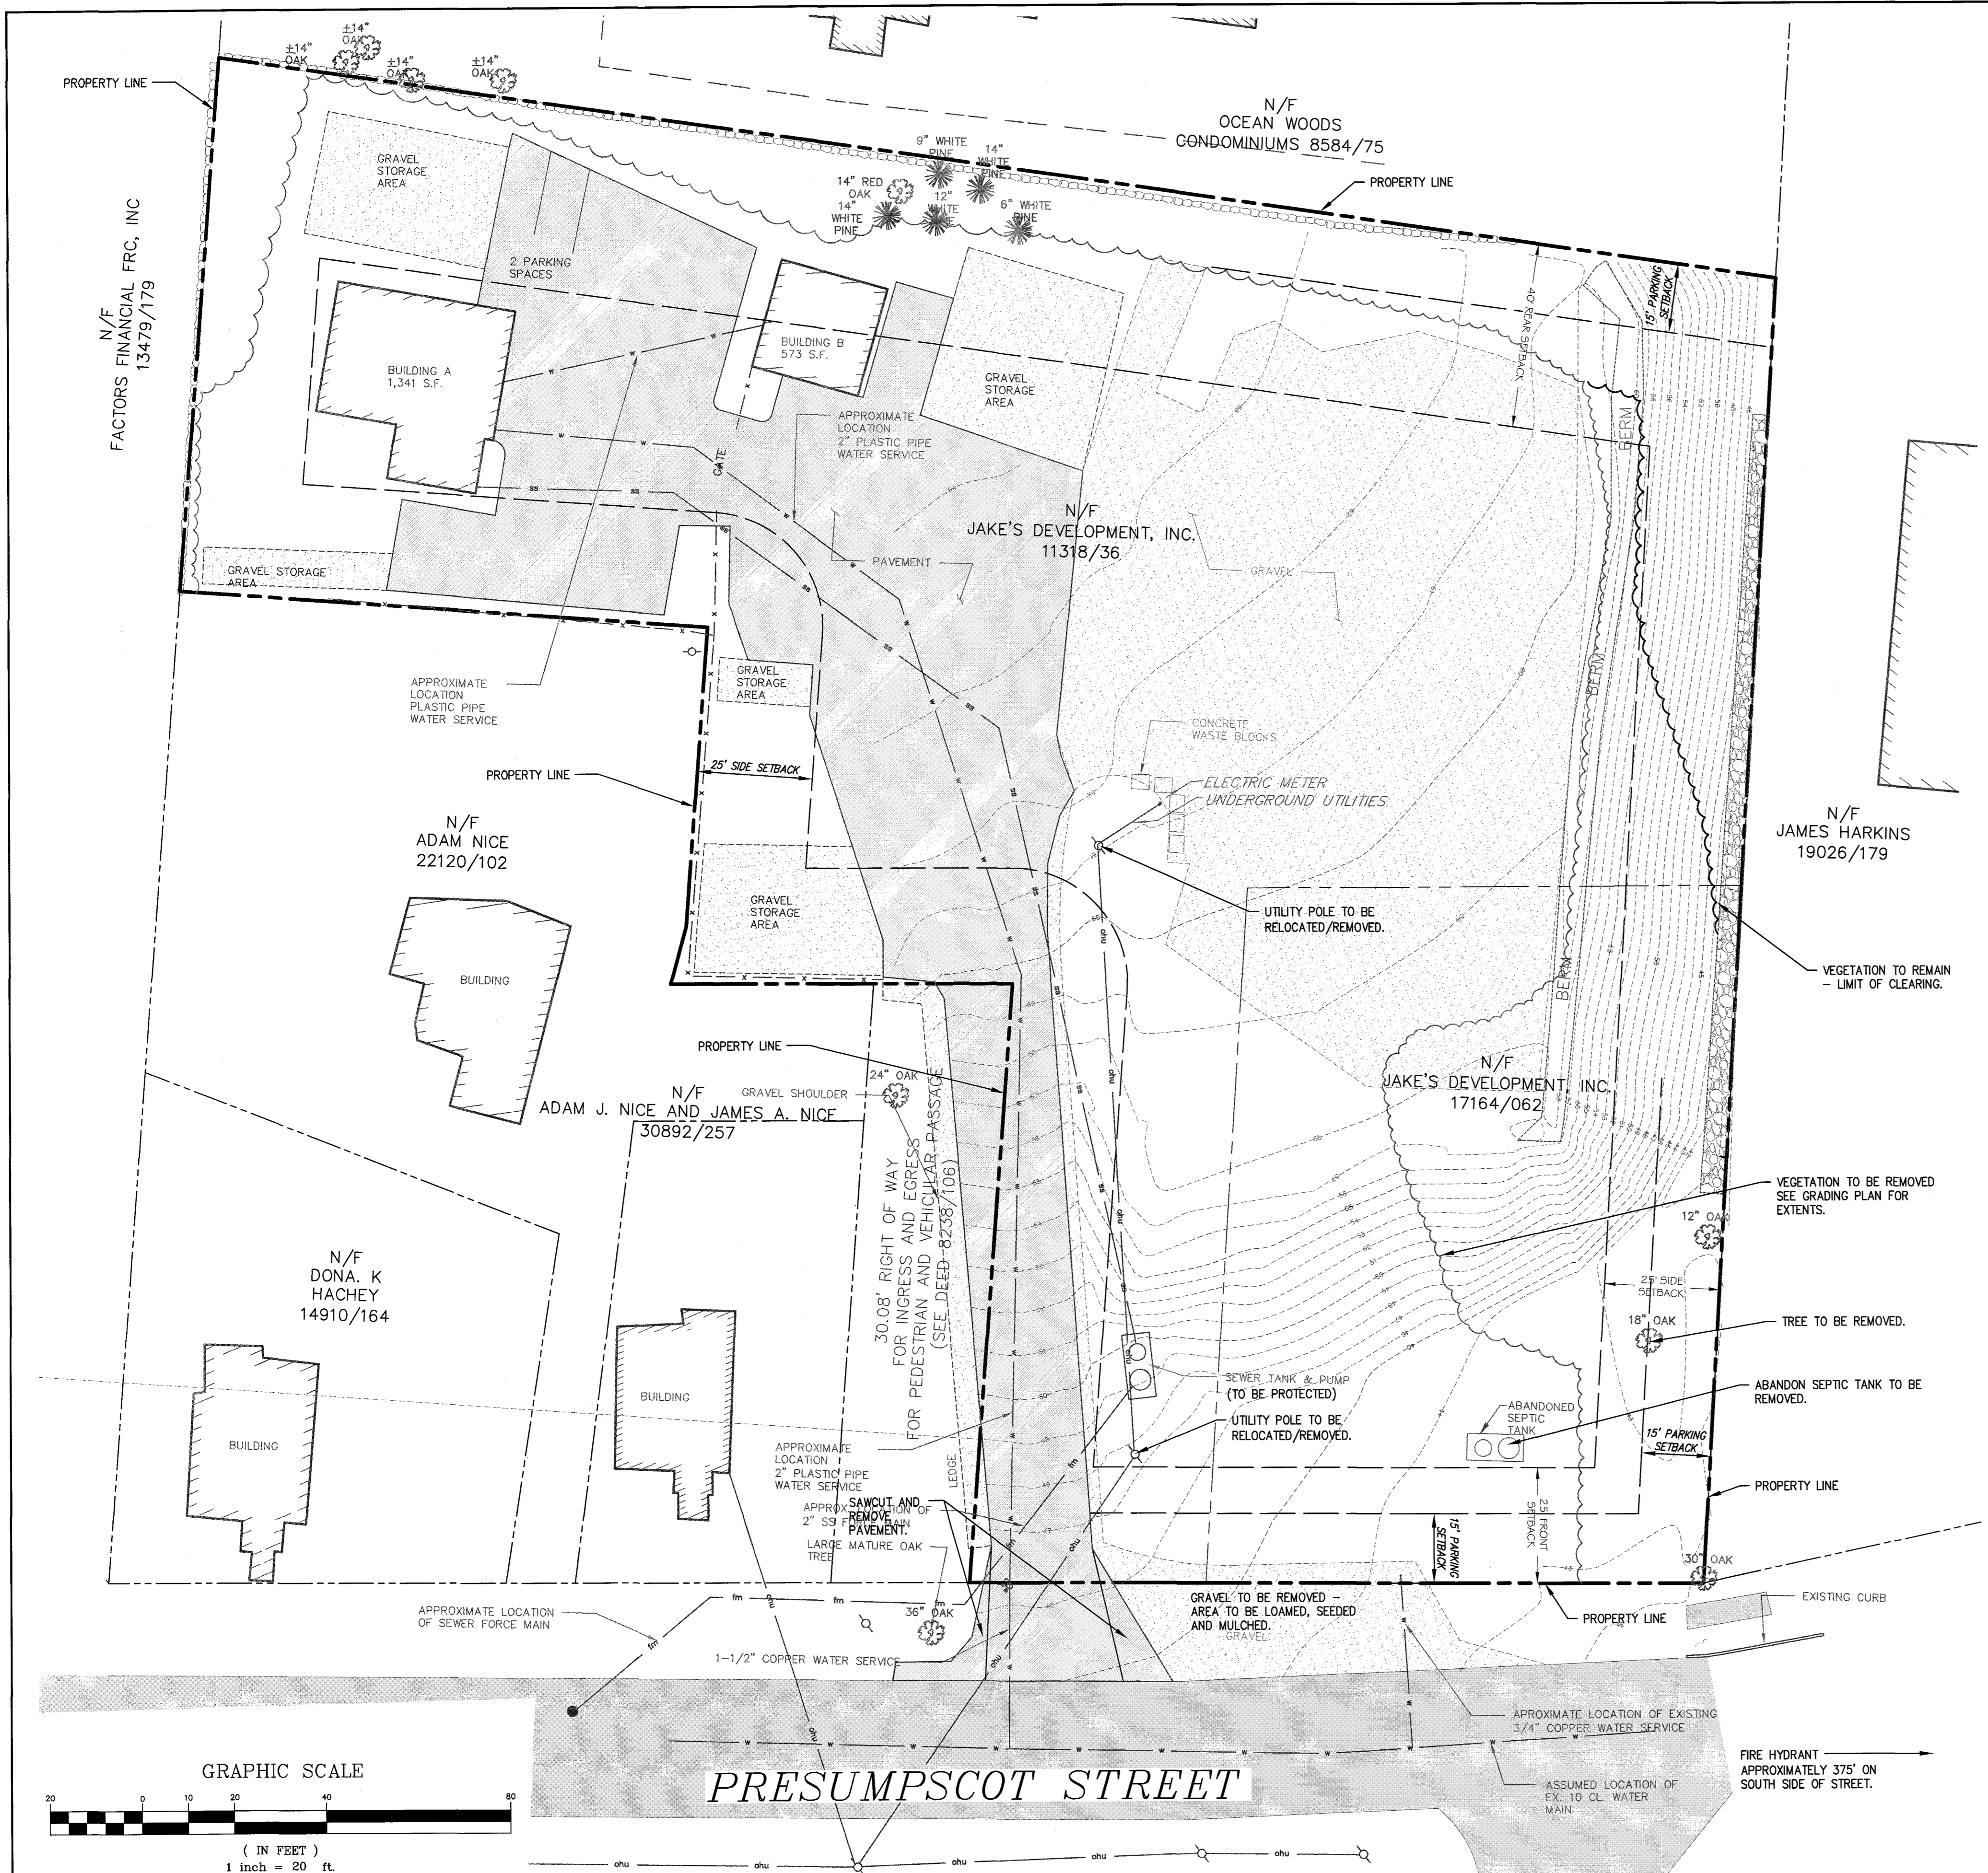


REV.	DATE	STATUS	BY	CHKD.	APPD.	REV.	DATE	STATUS	BY	CHKD.	APPD.
B	3/7/18	REVISED PER STAFF COMMENTS AND RE-SUBMITTED TO THE CITY OF PORTLAND	DEPT.	SWC	PBB						
A	11/30/17	SUBMITTED TO THE CITY OF PORTLAND FOR LEVEL 2 SITE PLAN APPLICATION	DEPT.	SWC	PBB						

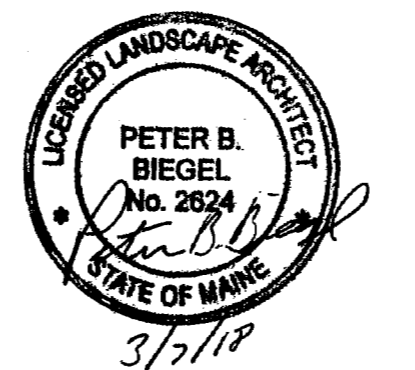

**LAND DESIGN SOLUTIONS**  
 LAND PLANNING, SITE PLANNING & LANDSCAPE ARCHITECTURE  
 P.O. Box 316, 160 Longhorns Road, Cumberland, ME 04021 tel:(207) 494-1717  
 APPLICANT & OWNER:  
**JAKE'S DEVELOPMENT, INC.**  
 30 LEDGEWOOD DRIVE, FALMOUTH, MAINE 04105

DESIGN: PBB  
 DRAWN: DEPT.  
 CHKD: PBB  
 DATE: NOV. 2017  
 SCALE: 1"=20'

**PROPOSED PRESUMPCOT STREET BUSINESS PARK**  
 314-316 PRESUMPCOT STREET, PORTLAND, MAINE  
**EXISTING CONDITIONS AND DEMOLITION PLAN**  
 PROJ. NO. 16-115  
 DWG. NO. C-100  
 DATE OF APPROVAL: 3/14/2018  
 PLANNER: Christian Roadman

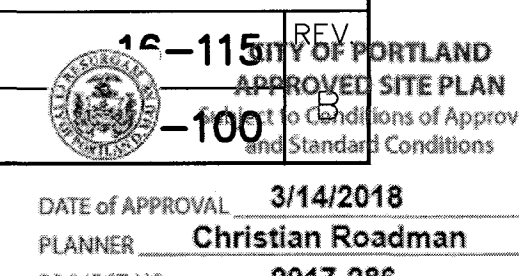



Reviewed for Code Compliance  
 Permitting and Inspections Department  
 Approved with Conditions


07/23/2018



BISKUP CONSTRUCTION, INC.  
 16 DANIELLE DRIVE  
 WINDHAM, MAINE 04092  
 TEL. (207) 892-9800  
 FAX. (207) 892-9895

WWW.BISKUPCONSTRUCTION.COM

STAMP

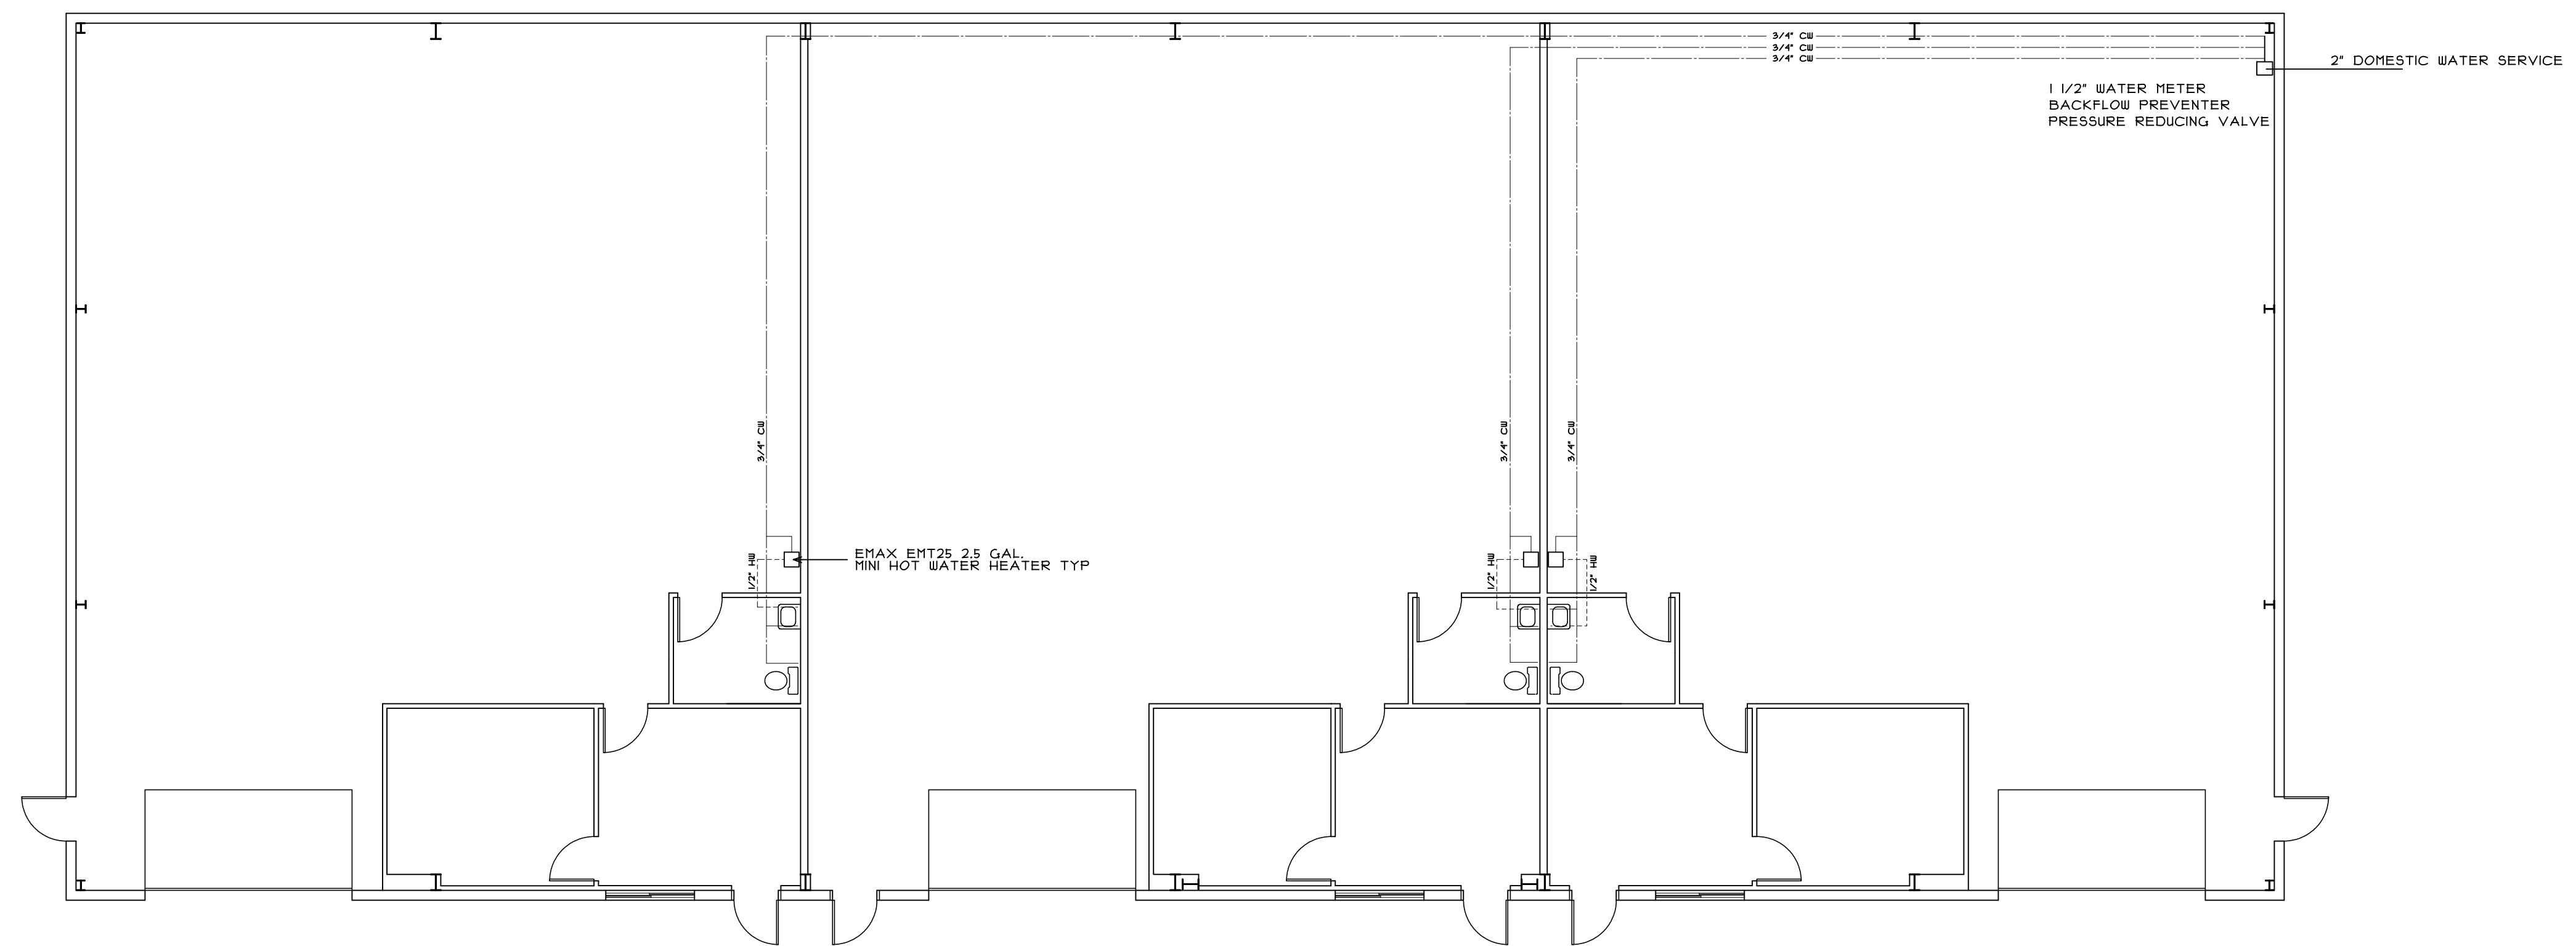

PROJECT:  
 PROPOSED BUILDING  
 320 P STREET, LLC  
 314 PRESUMPCOTT STREET  
 PORTLAND, MAINE

REVISIONS	
DATE	DESCRIPTION

DATE: 5/4/2018  
 SCALE: 1/8" = 1'-0"  
 DESIGNER: JS  
 CHECKED BY: JB

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 BISKUP CONSTRUCTION, INC.

SHEET TITLE  
 DOMESTIC  
 WATER  
 PLAN

SHEET NUMBER  
 P-2  
 SHEET 2 OF 2



Reviewed for Code Compliance  
 Permitting and Inspections Department  
 Approved with Conditions

07/23/2018



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STAMP

PROJECT:  
 PROPOSED BUILDING  
 320 P STREET, LLC  
 314 PRESUMSCOTT STREET  
 PORTLAND, MAINE


REVISIONS	
DATE	DESCRIPTION

DATE: 5/4/2018  
 SCALE: 1/8" = 1'-0"  
 DESIGNER: JS  
 CHECKED BY: JB

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SHEET TITLE  
 ELECTRICAL  
 PLAN


SHEET NUMBER  
 E-1  
 SHEET 1 OF 2

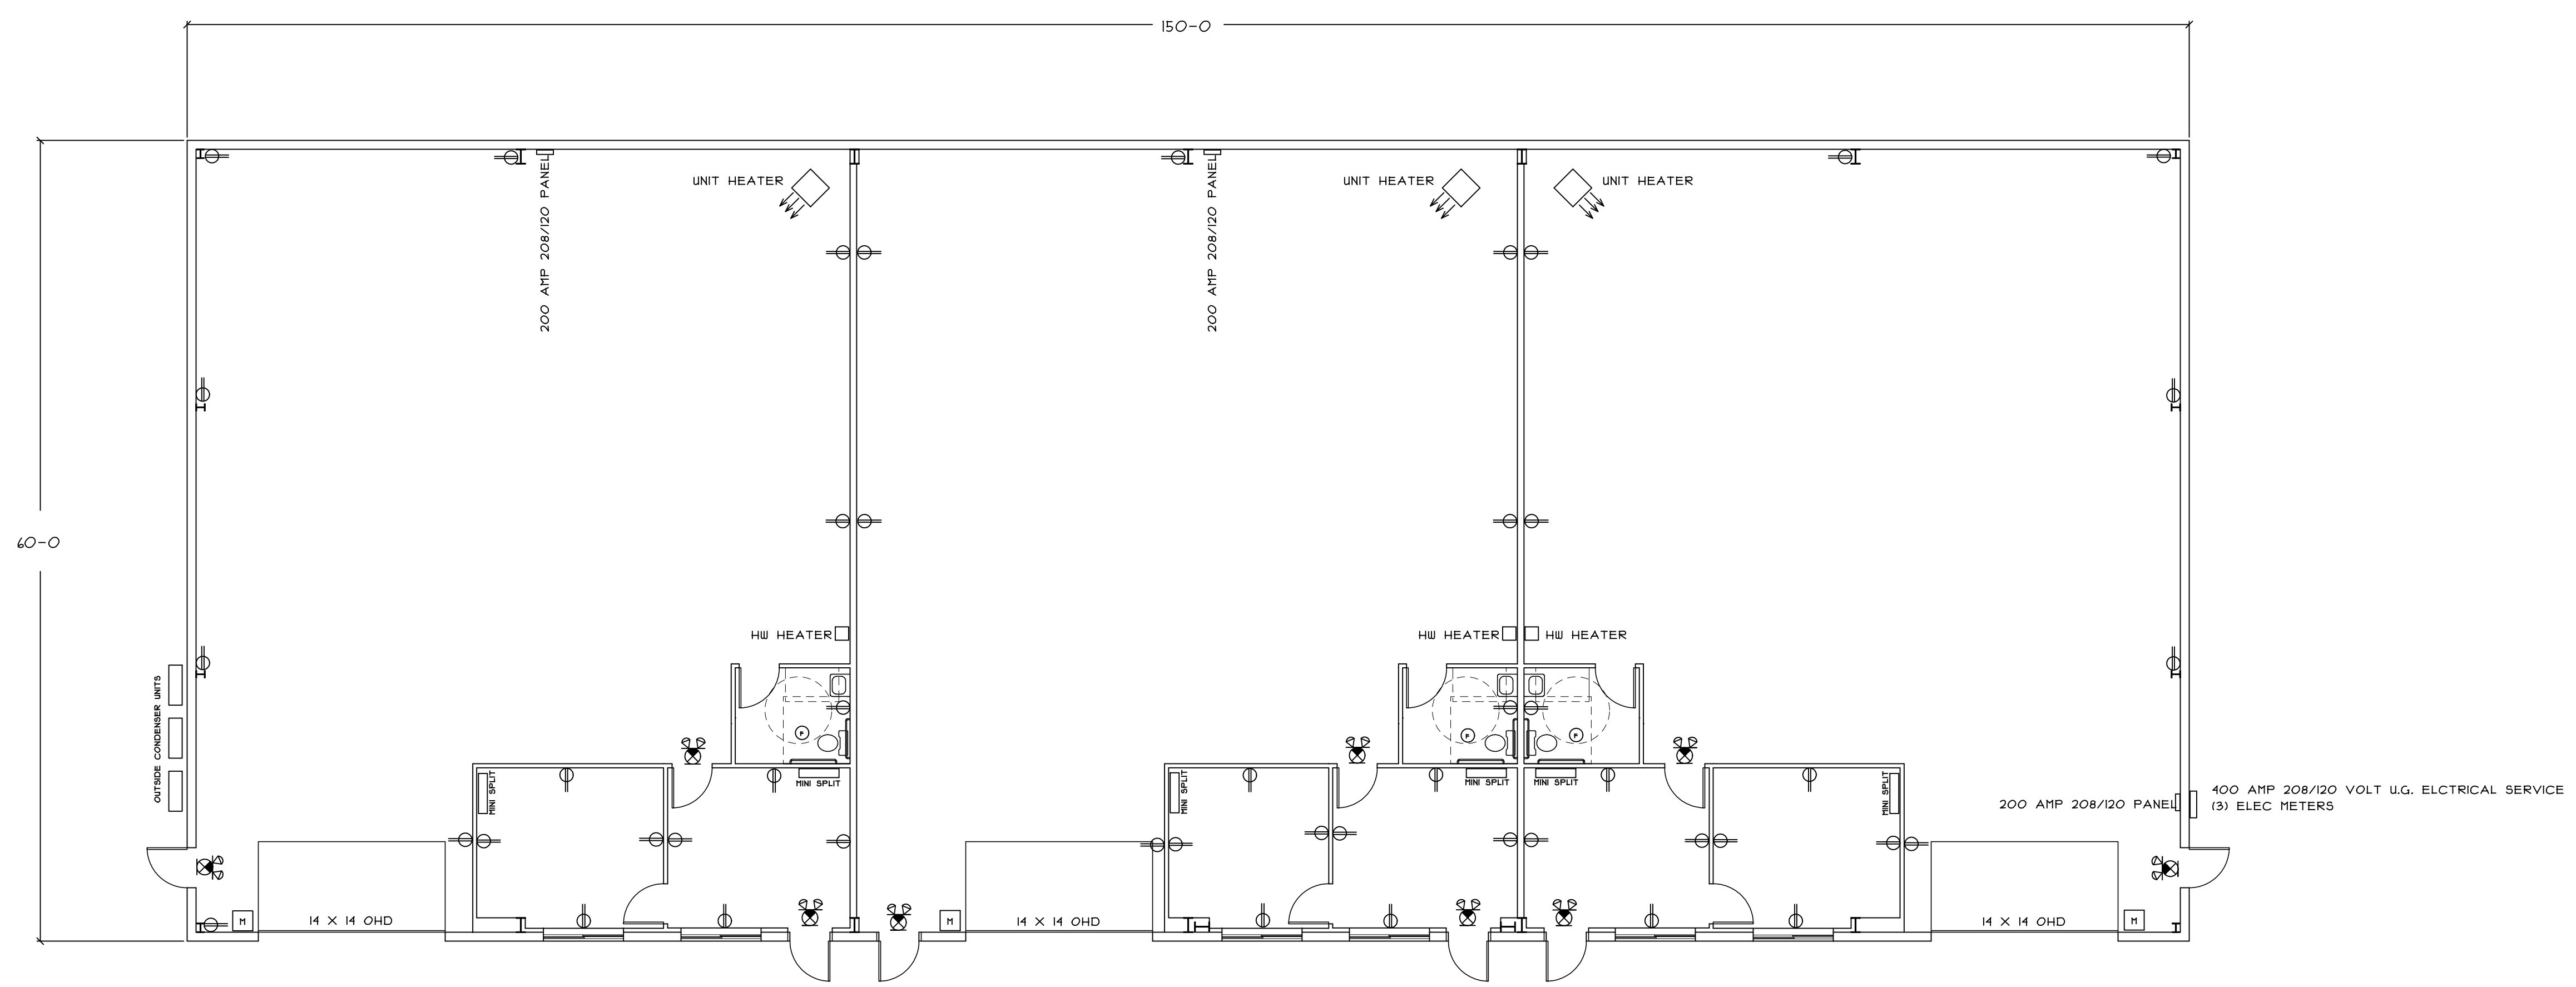

- DUPLEX RECEPTACLE
- OHD DOOR OPERATOR
- EXHAUST FAN
- EXIT/EMERGENCY LIGHT





Reviewed for Code Compliance  
 Permitting and Inspections Department  
 Approved with Conditions  
 07/23/2018

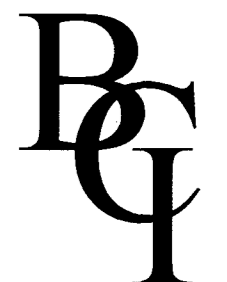


BISKUP CONSTRUCTION, INC.  
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 WINDHAM, MAINE 04092  
 TEL. (207) 892-9800  
 FAX. (207) 892-9895

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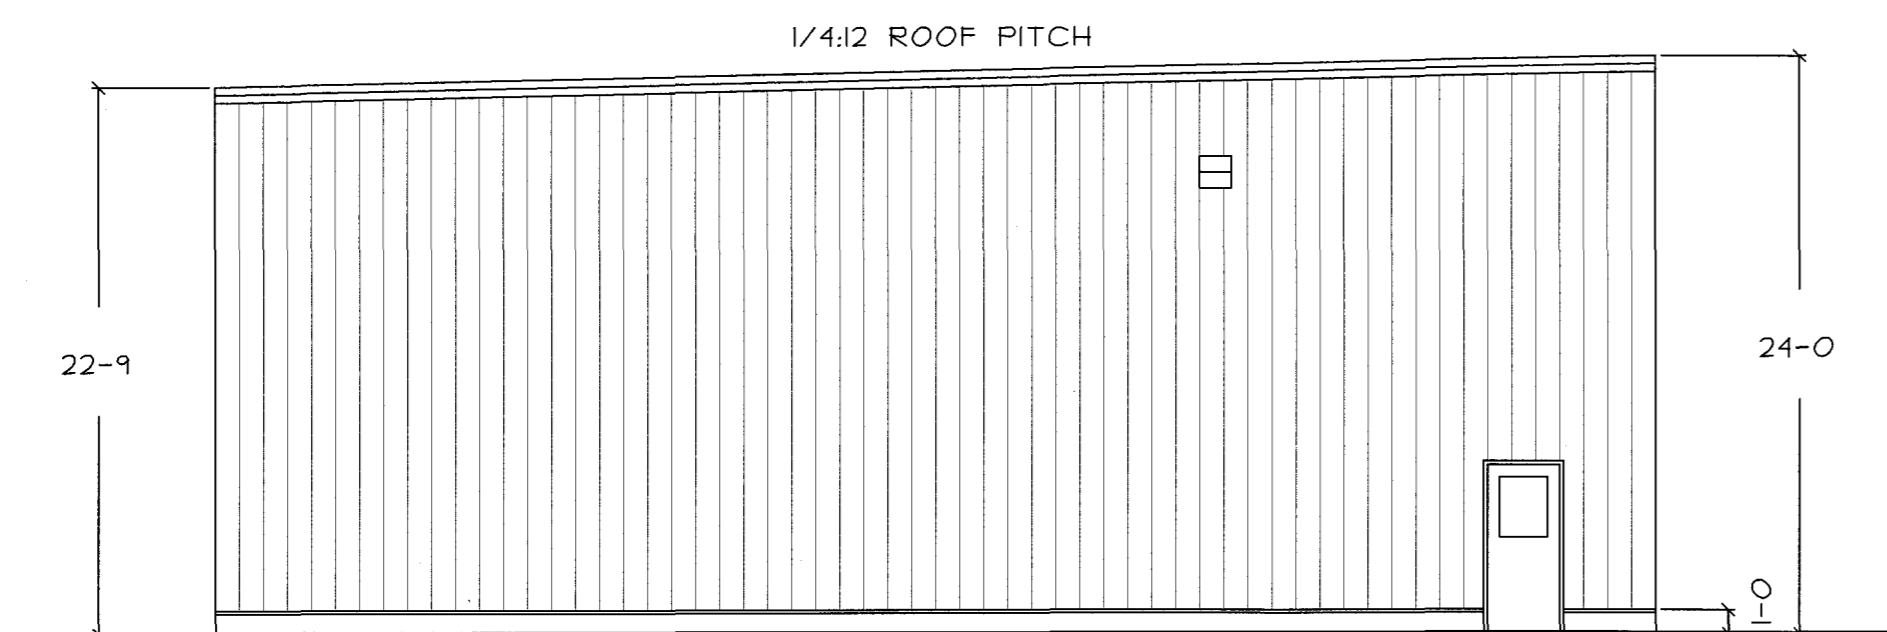
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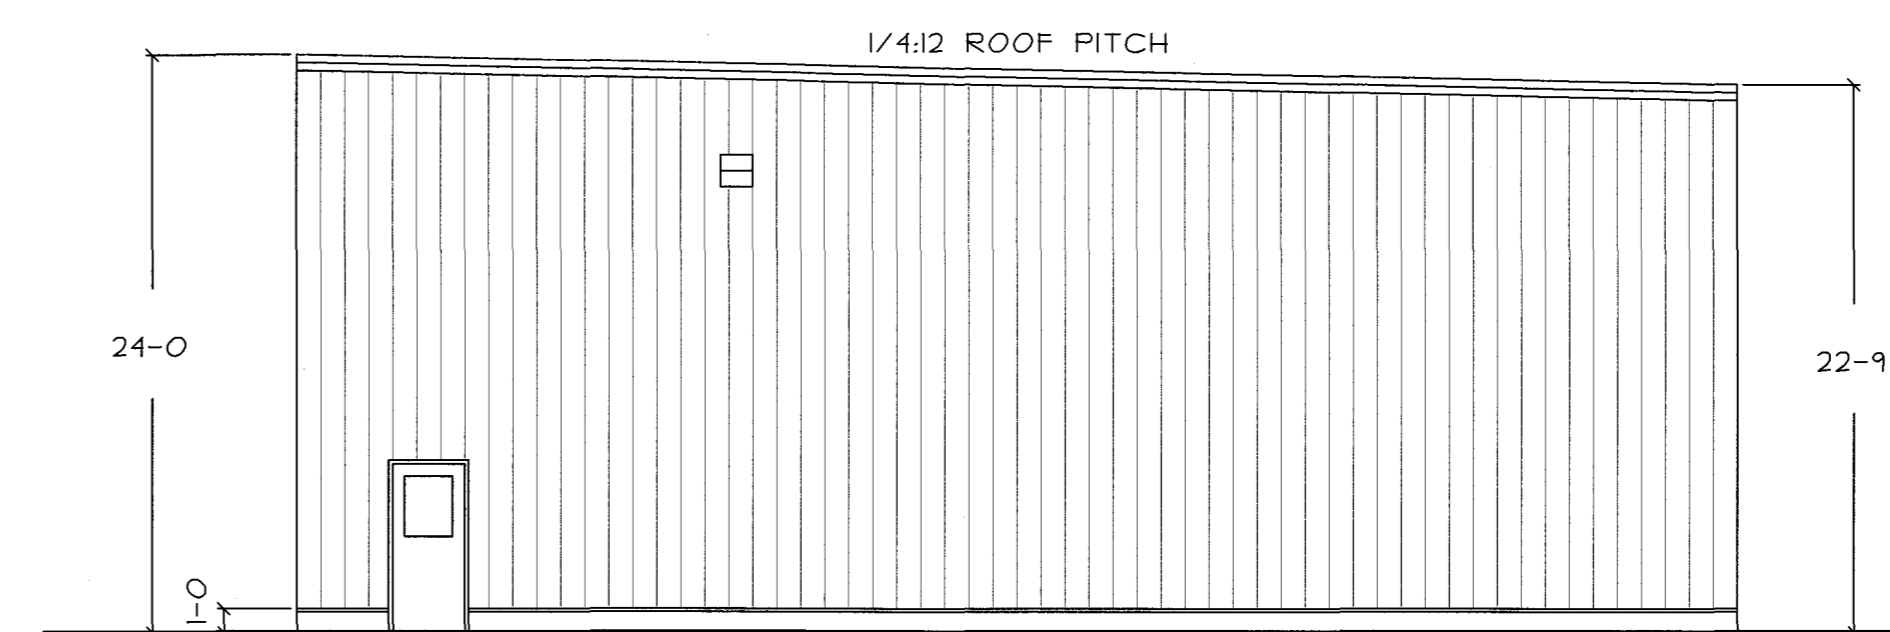
44 CARSOE DRIVE  
 PORTLAND, MAINE 04103 (207) 797-3093

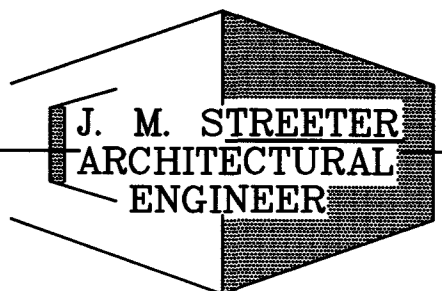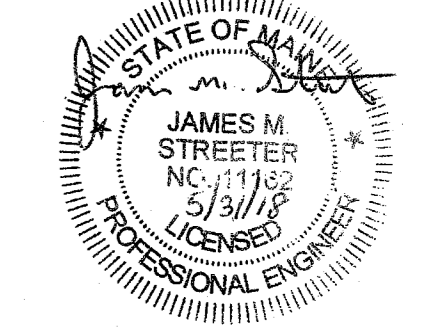


FRONT ELEVATION

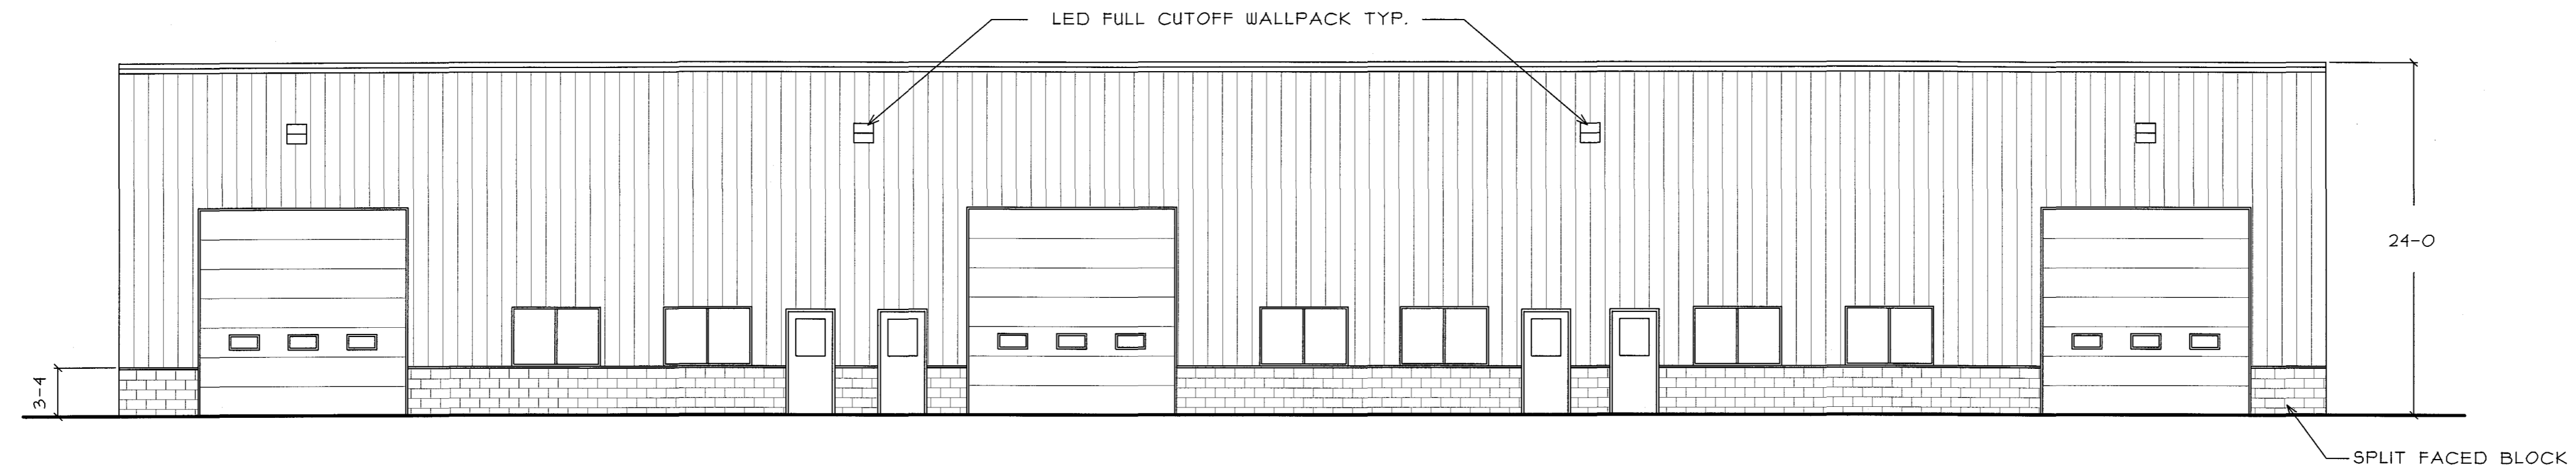

LEFT ELEVATION



RIGHT ELEVATION

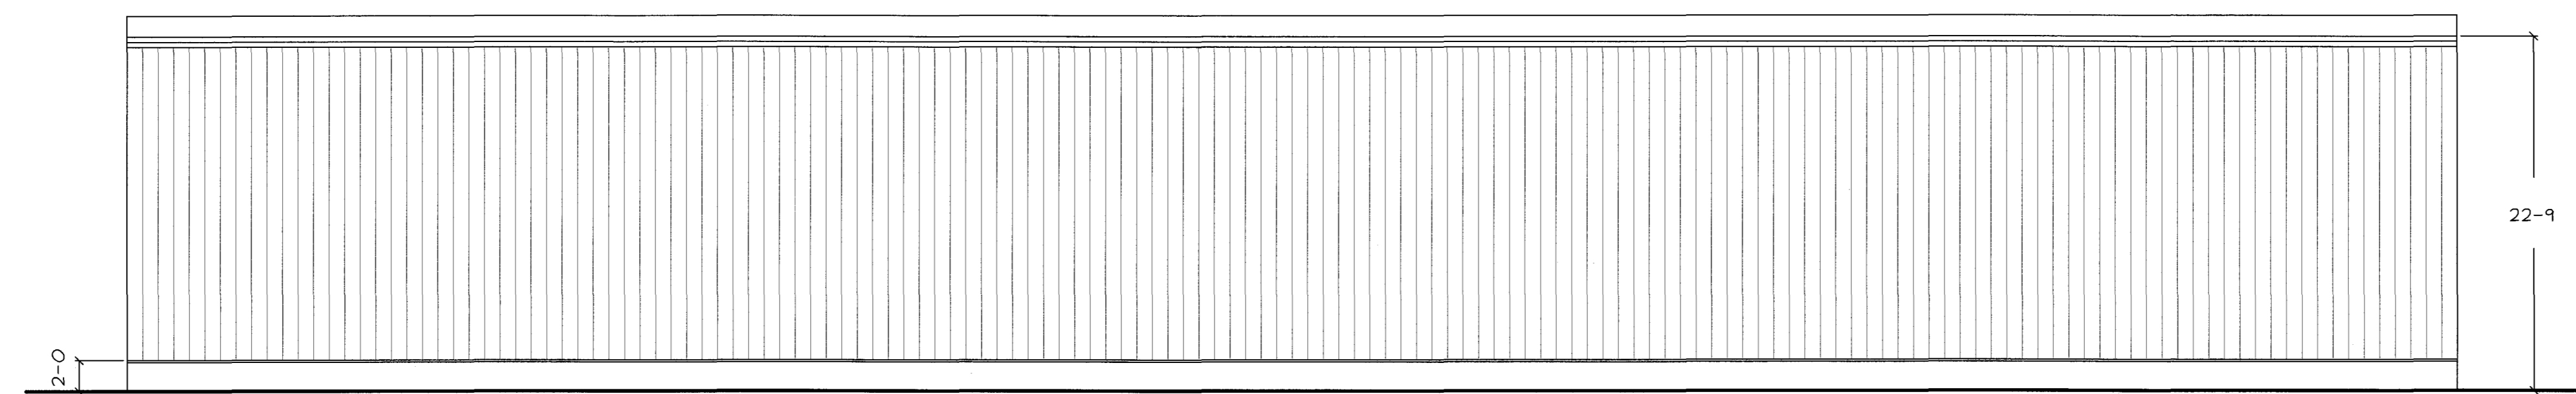

REAR ELEVATION

PROJECT:  
 PROPOSED BUILDING  
 320 P STREET, LLC  
 314 PRESUMPCOT STREET  
 PORTLAND, MAINE

REVISIONS	
DATE	DESCRIPTION

DATE: 5/30/2018  
 SCALE: 1/8" = 1'-0"  
 DESIGNER: JS  
 CHECKED BY: JB

© COPYRIGHT  
 BISKUP CONSTRUCTION, INC.

SHEET TITLE  
 ELEVATIONS


SHEET NUMBER  
 A-3  
 SHEET 3 OF 5




Reviewed for Code Compliance  
 Permitting and Inspections Department  
 Approved with Conditions  
 07/23/2018

GENERAL NOTES

BUILDING CODES: MUBEC, IBC 2015, NFPA 1 (2009), NFPA 10, NFPA 13, NFPA 101 (2004), IECC 2009  
 THIS BUILDING DOES NOT HAVE A SPRINKLER SYSTEM, BUT WILL HAVE A FIRE ALARM SYSTEM  
 THE BUILDING IS A PRE-ENGINEERED METAL BUILDING BY PACKAGE STEEL SYSTEMS, INC. OF SUTTON, MA. BUILDING MANUFACTURER TO PROVIDE STRUCTURAL DESIGN, BUILDING ENVELOPE DETAILS, AND LETTER OF CERTIFICATION.  
 FOUNDATION DESIGN TO BE BY ASSOCIATED DESIGN PROFESSIONALS  
 ALL DOORS SHALL BE 3'-0" WIDE AND HAVE HANDICAPPED LEVER TYPE HARDWARE  
 5 LB ABC FIRE EXTINGUISHERS SHALL BE MOUNTED AT EVERY EXIT  
 HANDICAPPED SIGNAGE SHALL BE MOUNTED AT 5'-0" A.F.F. AT ALL FUTURE BATHROOMS AND EXITS  
 THE BUILDING WILL BE HEATED BY GAS FIRED REZNOR HEATING UNITS  
 SEPARATE PERMITS ARE REQUIRED FOR THE ELECTRICAL, PLUMBING, AND HVAC WORK

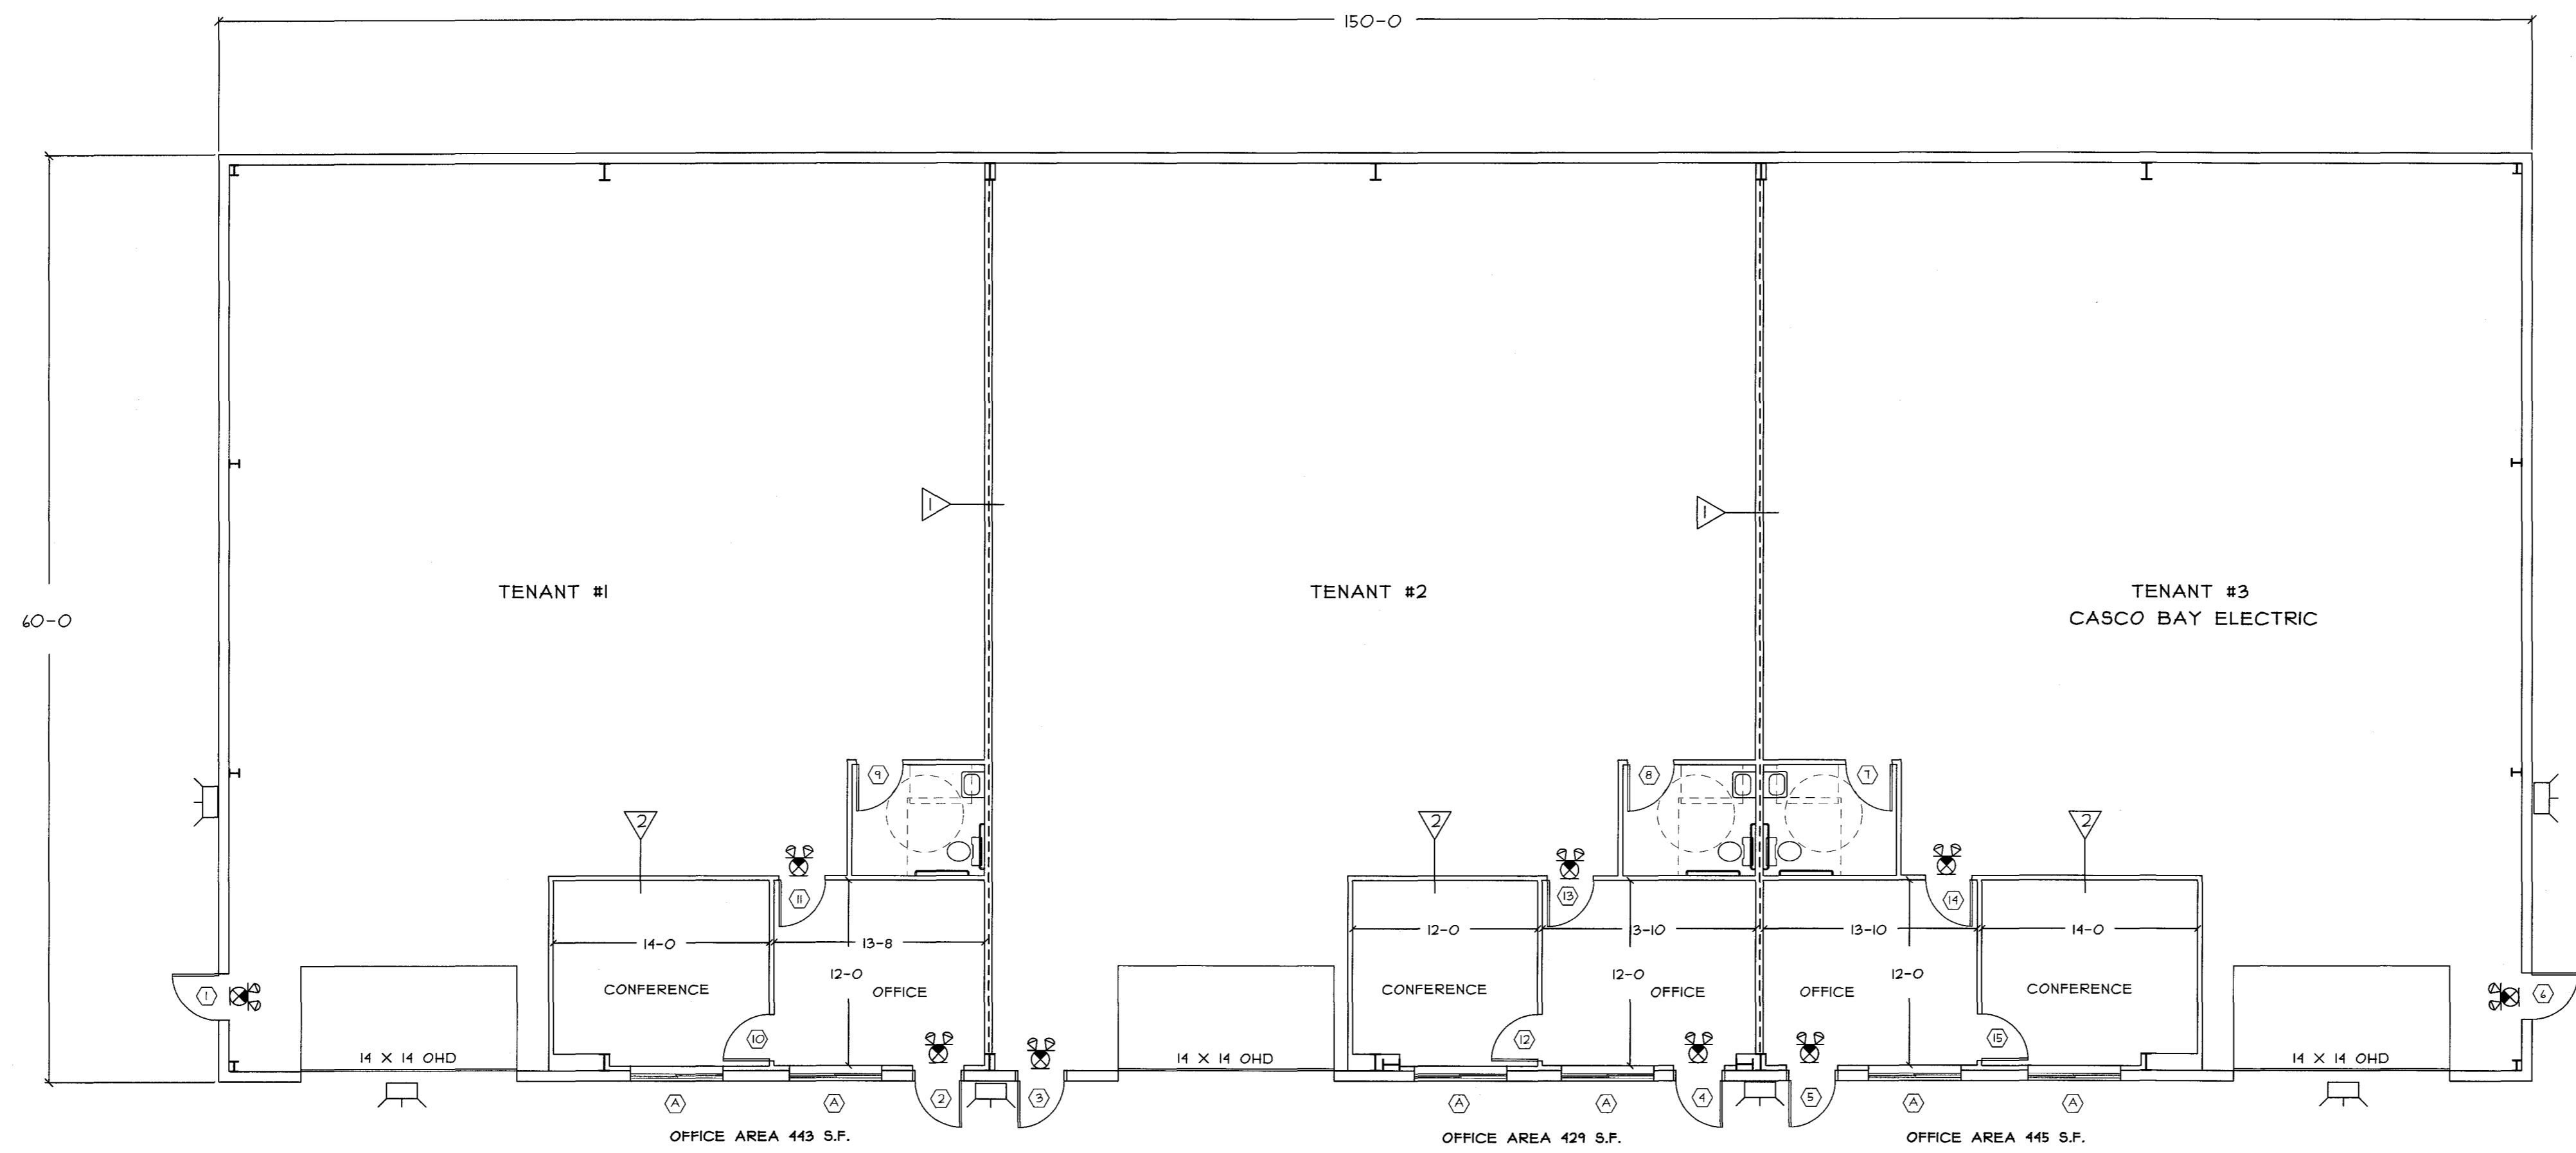

**B&C**  
 BISKUP CONSTRUCTION, INC.  
 16 DANIELLE DRIVE  
 WINDHAM, MAINE 04062  
 TEL. (207) 892-9800  
 FAX. (207) 892-9895  
 WWW.BISKUPCONSTRUCTION.COM

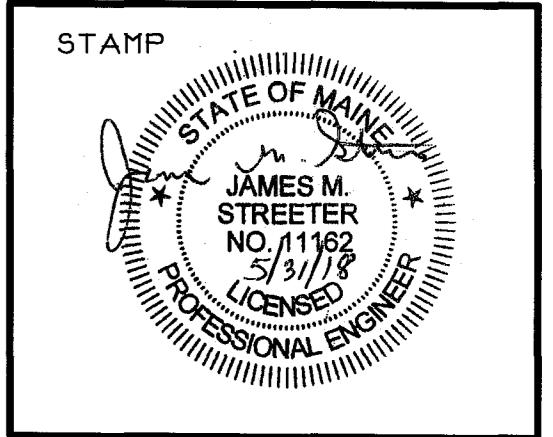

**J. M. STREETER**  
 ARCHITECTURAL  
 ENGINEER  
 44 CARSOE DRIVE  
 PORTLAND, MAINE 04103 (207) 797-3093

PROJECT:  
 PROPOSED BUILDING  
 320 P STREET, LLC  
 314 PRESUMPCOT STREET  
 PORTLAND, MAINE

REVISIONS	
DATE	DESCRIPTION

DATE: 5/30/2018  
 SCALE: 1/8" = 1'-0"  
 DESIGNER: JS  
 CHECKED BY: JB

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SHEET TITLE  
 FLOOR PLAN

SHEET NUMBER  
 A-1  
 SHEET 1 OF 5





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 Permitting and Inspections Department  
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 07/23/2018


**BQ**  
 BISKUP CONSTRUCTION, INC.  
 16 DANIELLE DRIVE  
 WINDHAM, MAINE 04062  
 TEL. (207) 892-9800  
 FAX. (207) 892-9895

WWW.BISKUPCONSTRUCTION.COM


CONSULTANT  
**ASSOCIATED DESIGN PARTNERS INC.**  
 20 Leighton Road  
 Portland, Maine 04105  
 Office: (207) 878-1725  
 Fax: (207) 878-1768  
 E-Mail: info@adpartners.com



PROPOSED BUILDING  
 320 P STREET, LLC  
 314 PRESUMPCOT STREET  
 PORTLAND, MAINE

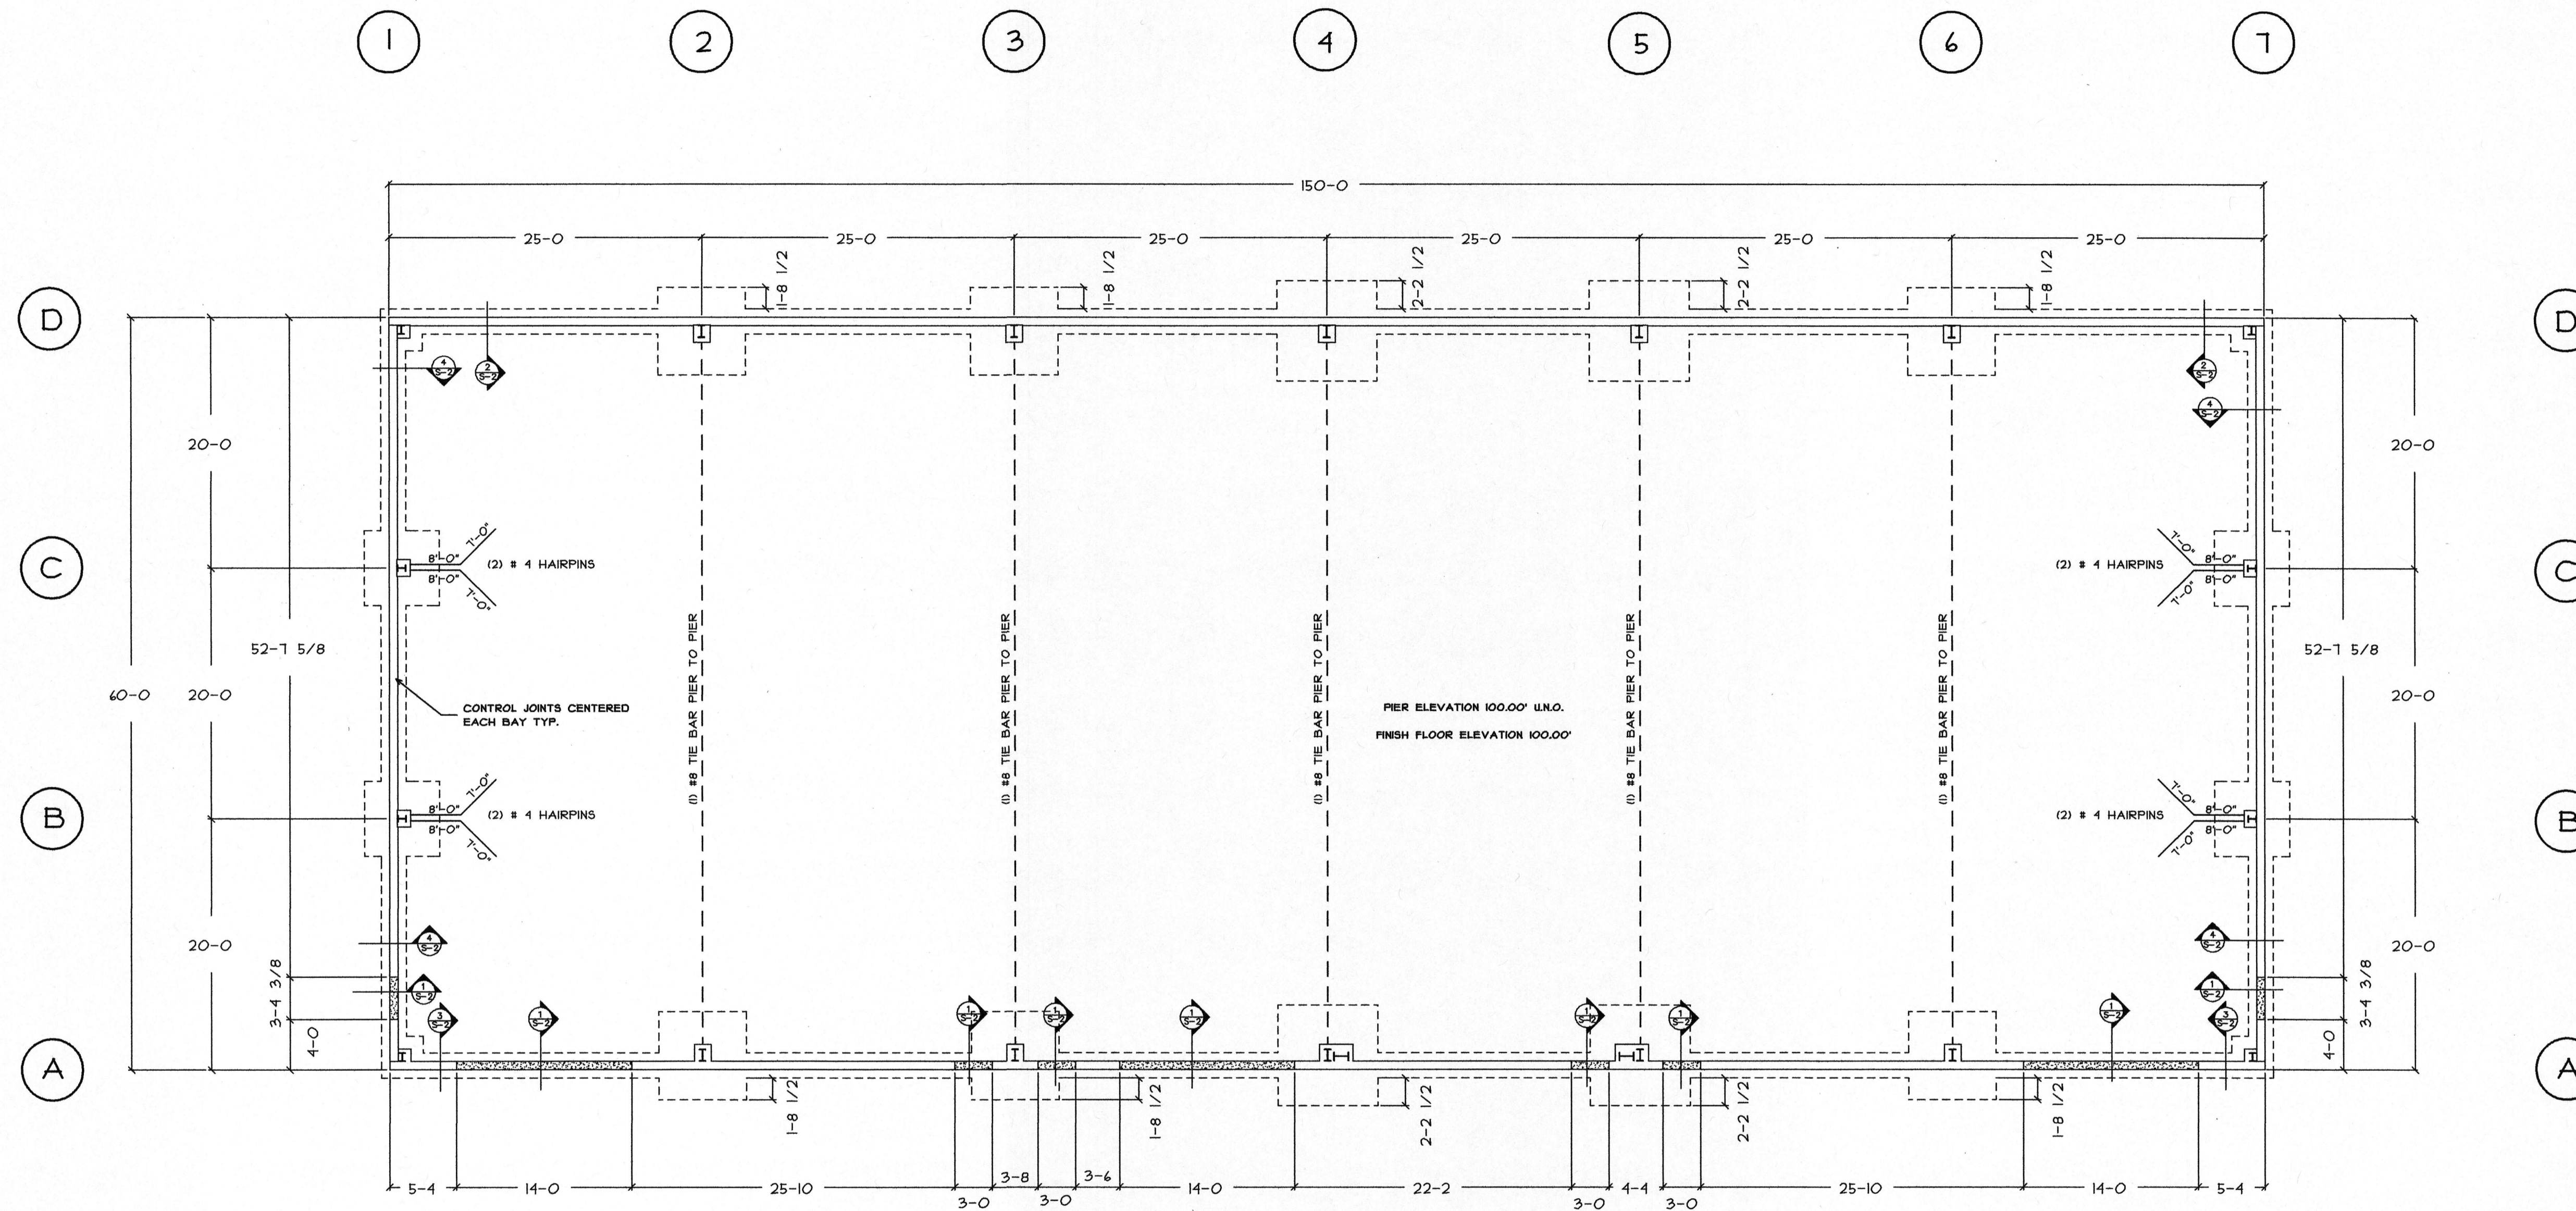

FOOTING & PIER SCHEDULE					
LOCATION	FOOTING SIZE	FOOTING REBAR	PIER SIZE	PIER REBAR	ANCHOR BOLTS
1A, 1D, 7A, 7D	3'-4" X 3'-4" X 1'-0"	3 #5 E.W. BOTT.	12" X 12"	2 #5 "U" BARS, 15" X 48" X 10"	3/4" X 18" A 301 HEADED
1B, 1C, 7B, 7C	4'-0" X 4'-0" X 1'-0"	4 #5 E.W. BOTT.	16" X 12"	2 #5 "U" BARS, 15" X 48" X 12"	3/4" X 18" A 301 HEADED
2A, 3A, 4A, 2D, 3D, 4D	7'-0" X 7'-0" X 1'-2"	8 #5 E.W. BOTT.	16" X 16"	2 #5 "U" BARS, 15" X 48" X 12"; 2 #5 "U" BARS, 15" X 48" X 14"	3/4" X 18" A 521 THREADED ROD WITH NUT
4D, 5D	8'-0" X 8'-0" X 1'-2"	9 #5 E.W. BOTT.	16" X 16"	2 #5 "U" BARS, 15" X 48" X 12"; 2 #5 "U" BARS, 15" X 48" X 14"	3/4" X 18" A 521 THREADED ROD WITH NUT
4A, 5A	8'-0" X 8'-0" X 1'-4"	11 #5 E.W. BOTT.	32" X 16"	4 #5 "U" BARS, 15" X 48" X 16"	3/4" X 18" A 521 THREADED ROD WITH NUT

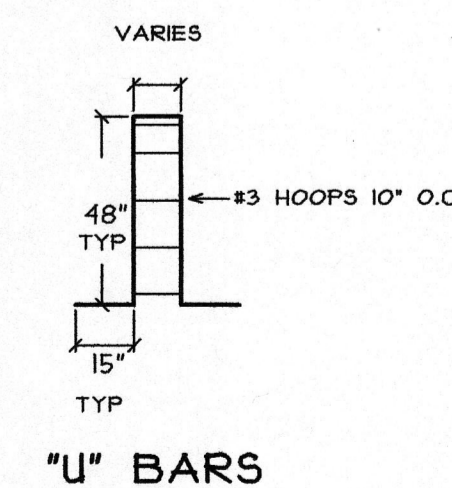

**GENERAL NOTES:**

- ALL FOOTINGS TO BEAR ON 4" OF 3/4" STONE ATOP UNDISTURBED SOIL, WITH AN ALLOWABLE NET. BEARING CAPACITY OF 3,000 PSF.
- MINIMUM COMPRESSIVE STRENGTH OF CONCRETE, 28 DAYS = 3,000 PSI.
- MINIMUM YIELD STRENGTH OF REINF. STEEL = 60,000 PSI.
- REINF. STEEL SHALL BE FABRICATED AND INSTALLED IN ACCORDANCE WITH THE CRSI MANUAL OF STANDARD PRACTICE, LATEST EDITION.
- CONCRETE WORKMANSHIP SHALL CONFORM TO THE REQUIREMENTS OF ACI 308 AND "SPECIFICATIONS FOR STRUCTURAL CONCRETE FOR BUILDINGS" ACI 301, LATEST EDITION.
- BACKFILL BOTH SIDES OF ALL WALLS SIMULTANEOUSLY.
- FOUNDATION DESIGN IS BASED ON THE GEOTECHNICAL REPORT BY SUMMIT GEOENGINEERING DATED 11/1/2016. THIS DESIGN PROFESSIONAL SHALL NOT BE RESPONSIBLE FOR SETTLEMENT OF THE BUILDING, OR DISCREPANCIES OF ON SITE CONDITIONS. A GEOTECHNICAL ENGINEER SHALL BE CONTACTED IF ANY UNSUITABLE MATERIALS ARE ENCOUNTERED.

REVISIONS	
DATE	DESCRIPTION

DATE: 6/1/2018  
 SCALE: 1/8" = 1'-0"  
 DESIGNER: AW  
 CHECKED BY: JB


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SHEET TITLE  
**FOUNDATION PLAN**

SHEET NUMBER  
**S-1**  
 SHEET 1 OF 3





Reviewed for Code Compliance  
Permitting and Inspections Department  
Approved with Conditions  
07/23/2018

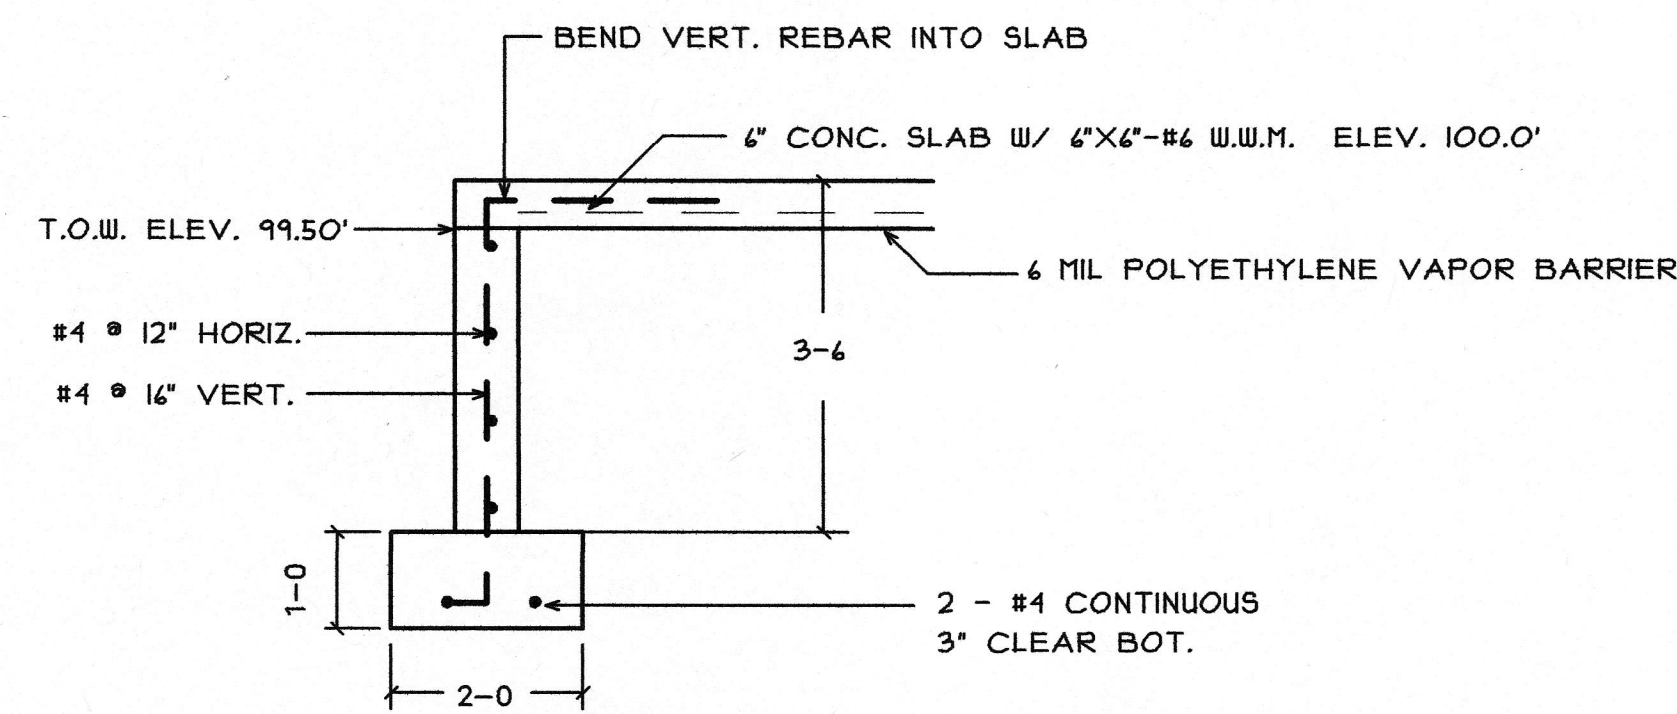



SECTION THRU DOOR OPENINGS

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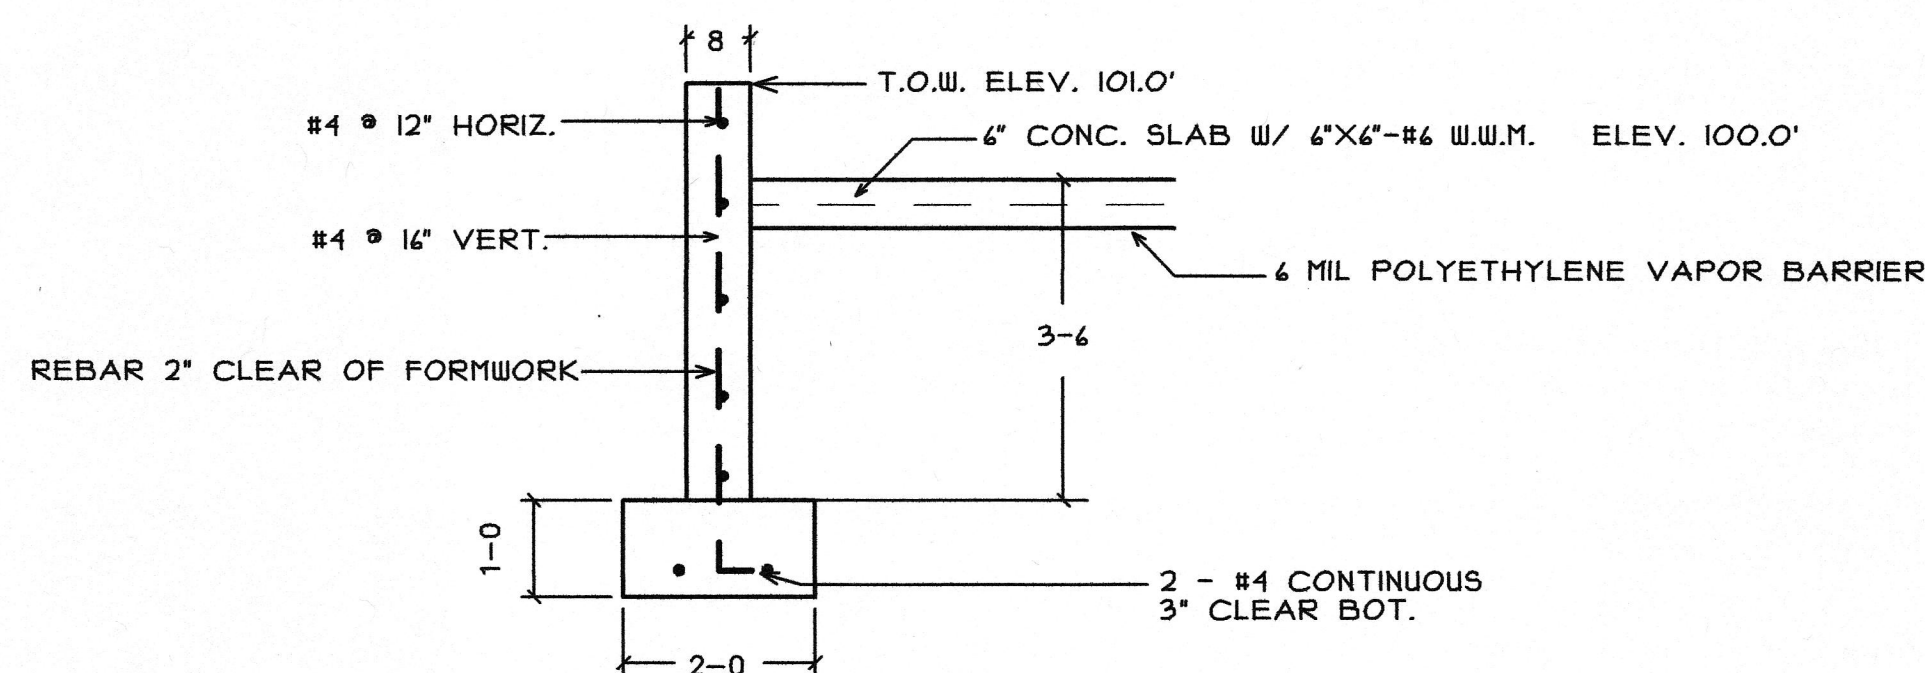
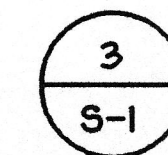
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SCALE: 1/2"=1'-0"

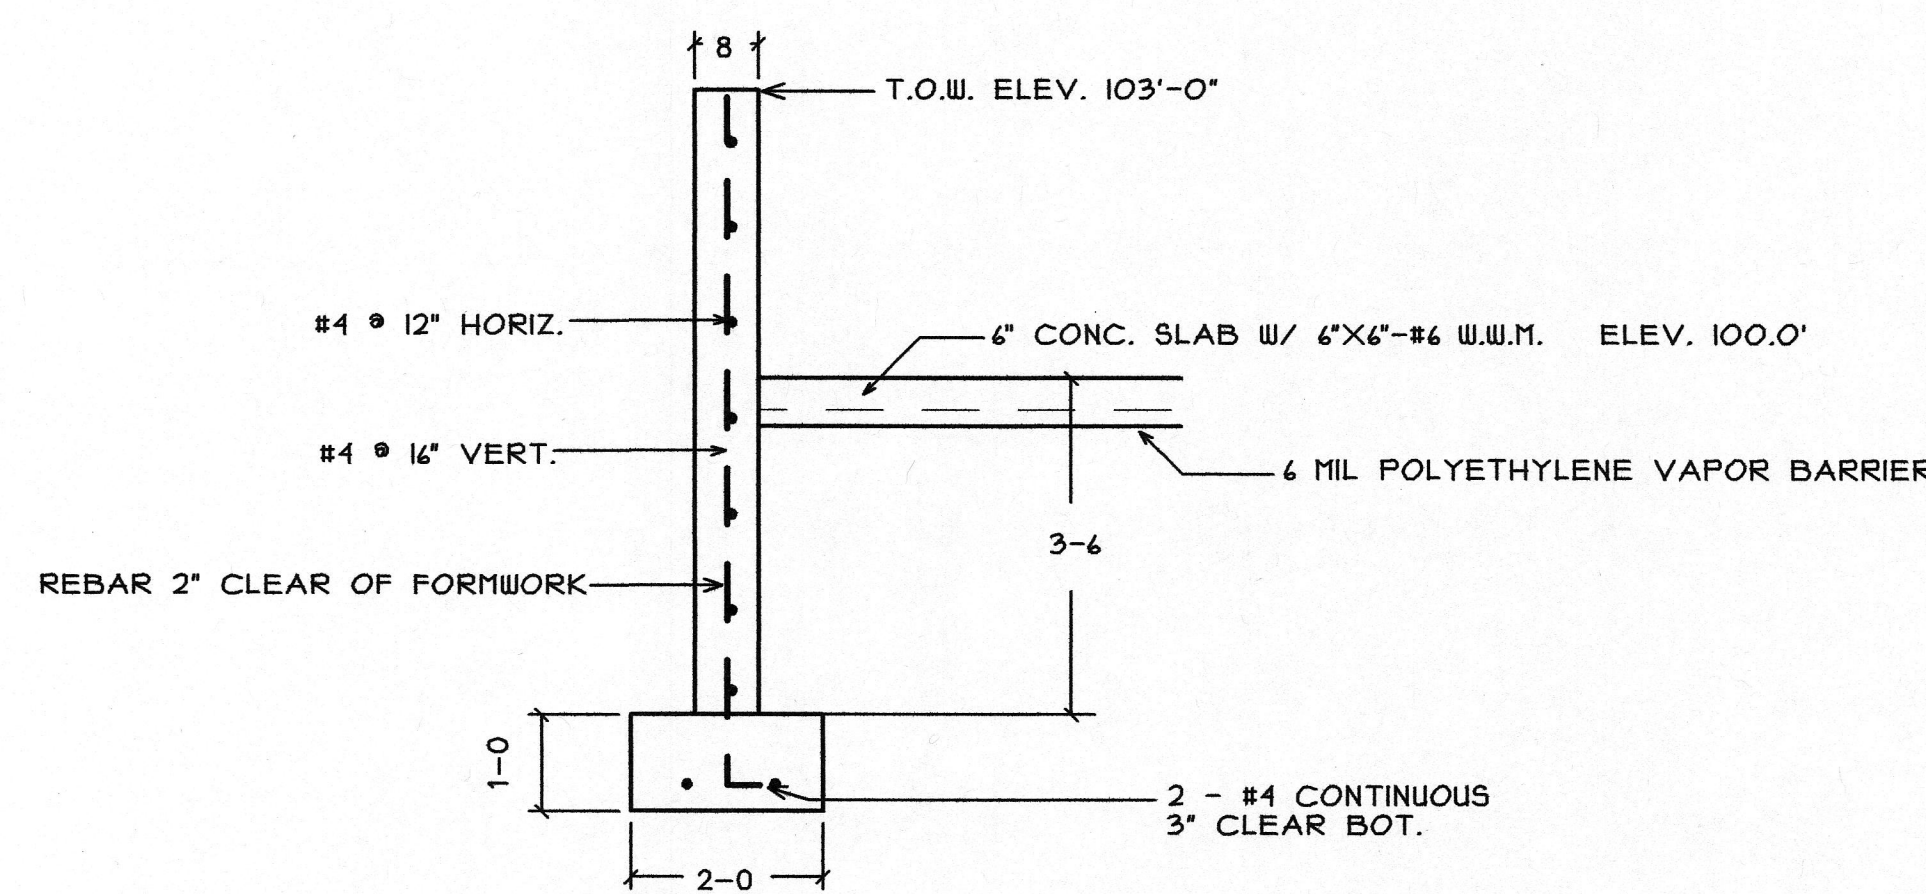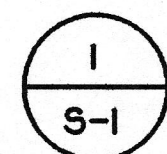



WALL SECTION

SCALE: 1/2"=1'-0"

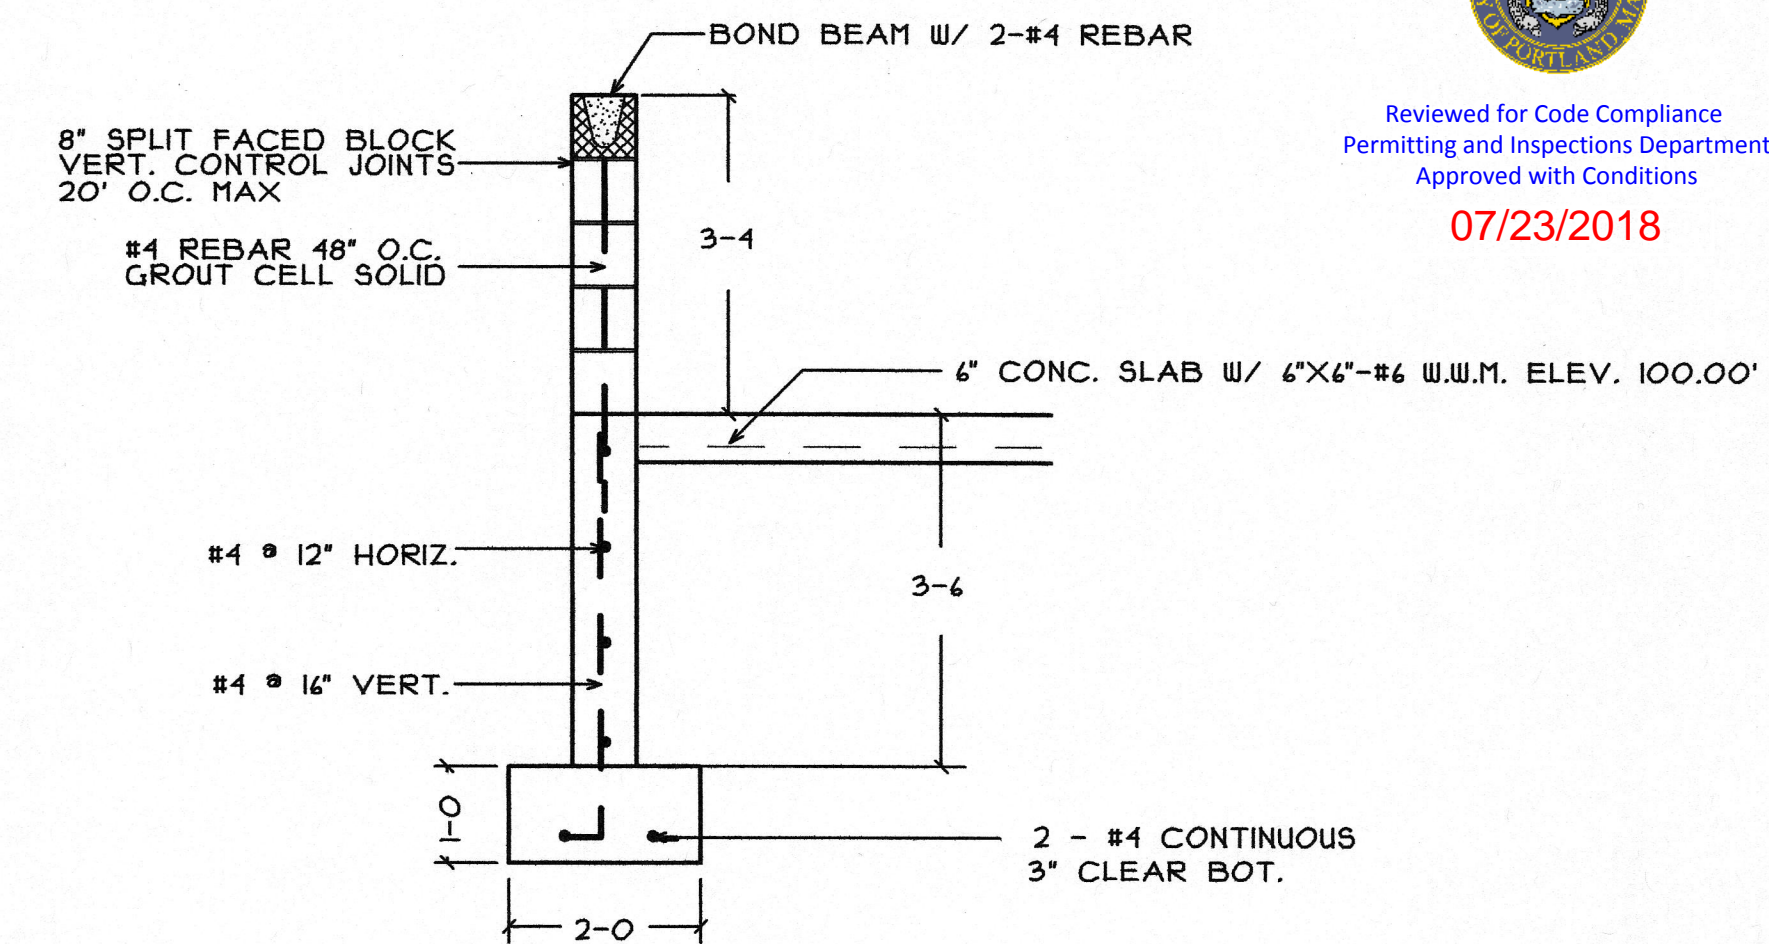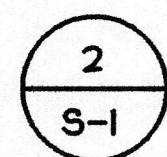


WALL SECTION

SCALE: 1/2"=1'-0"

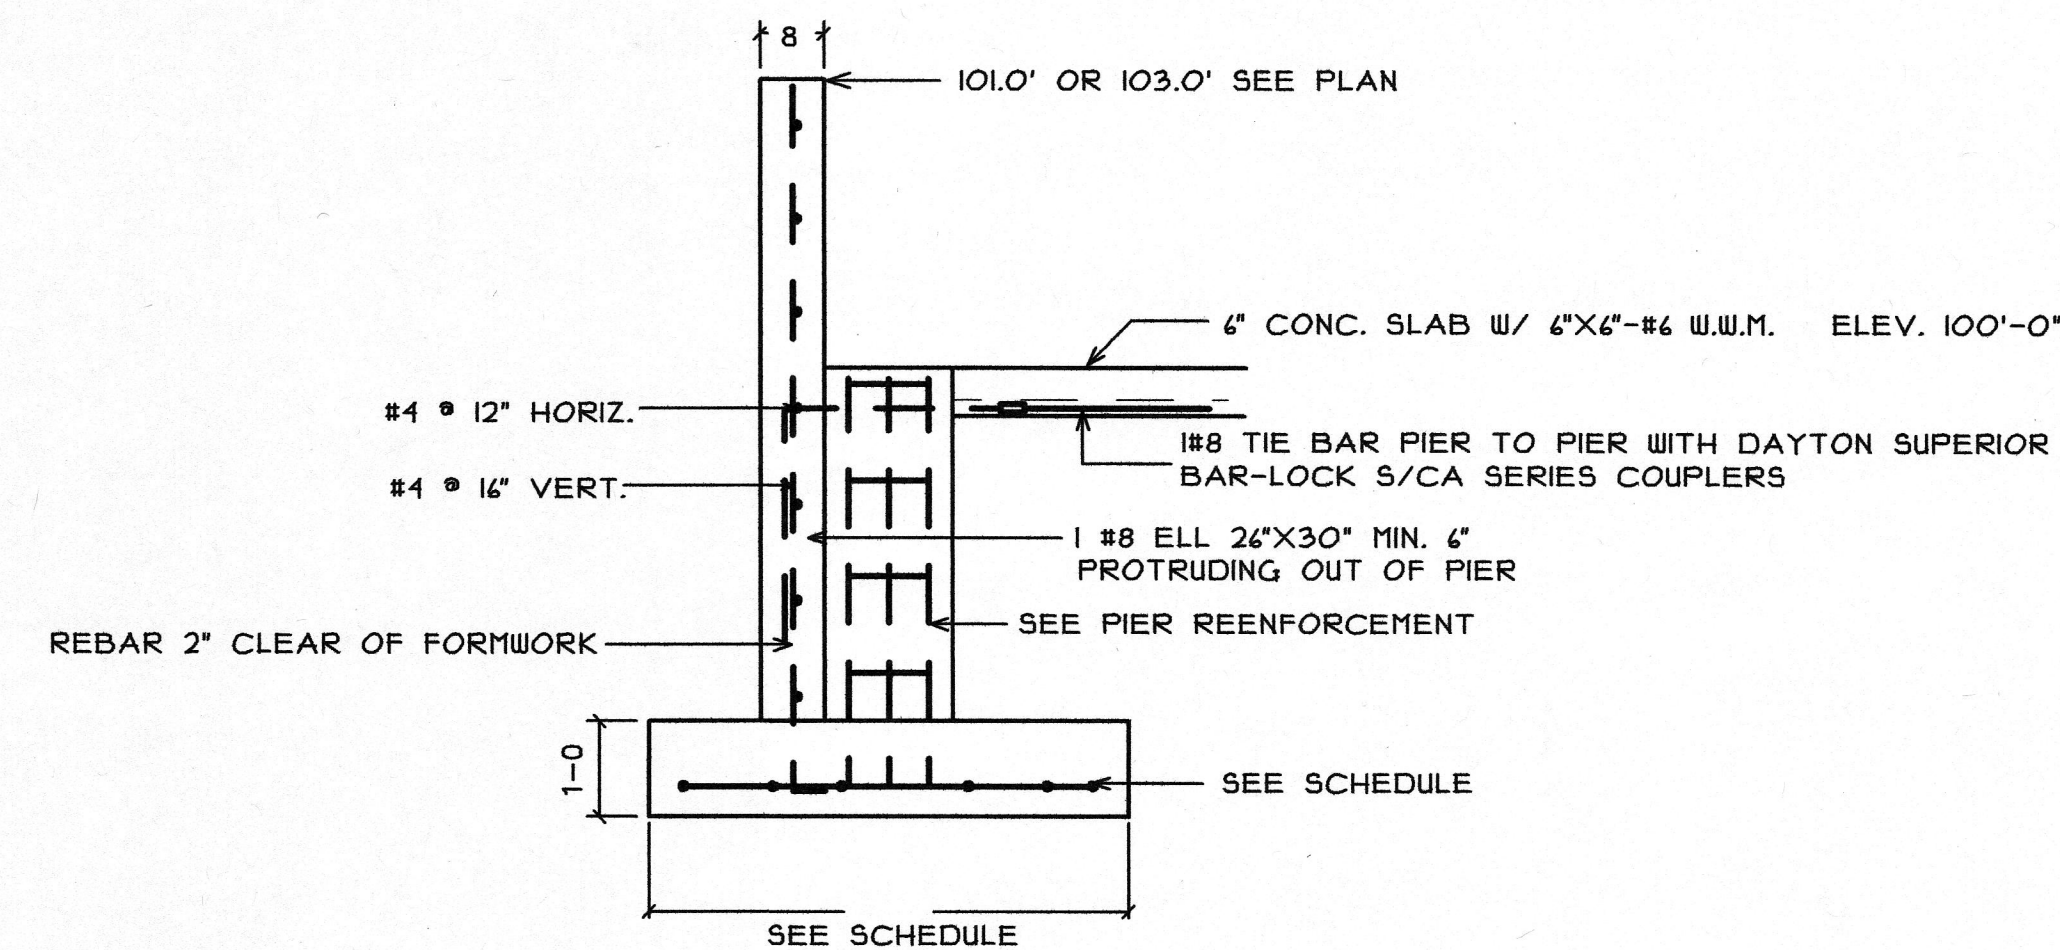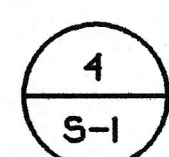


WALL SECTION @ PIERS

2A - 6A, 2D - 6D

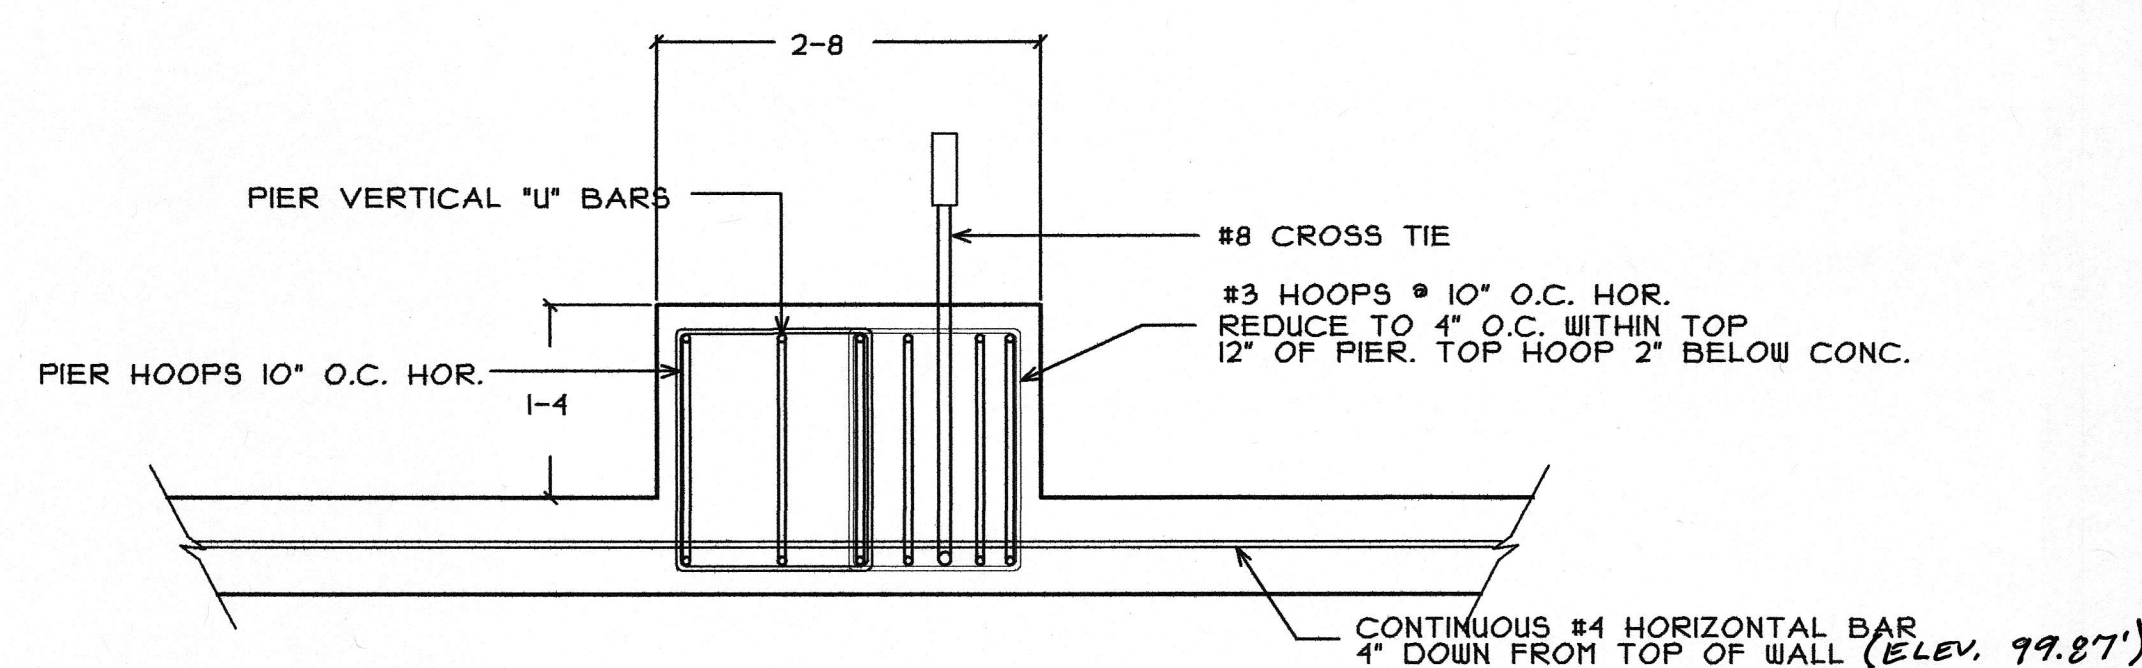

PIER REINFORCEMENT  
4A, 5A

SCALE: 3/4" = 1'-0"

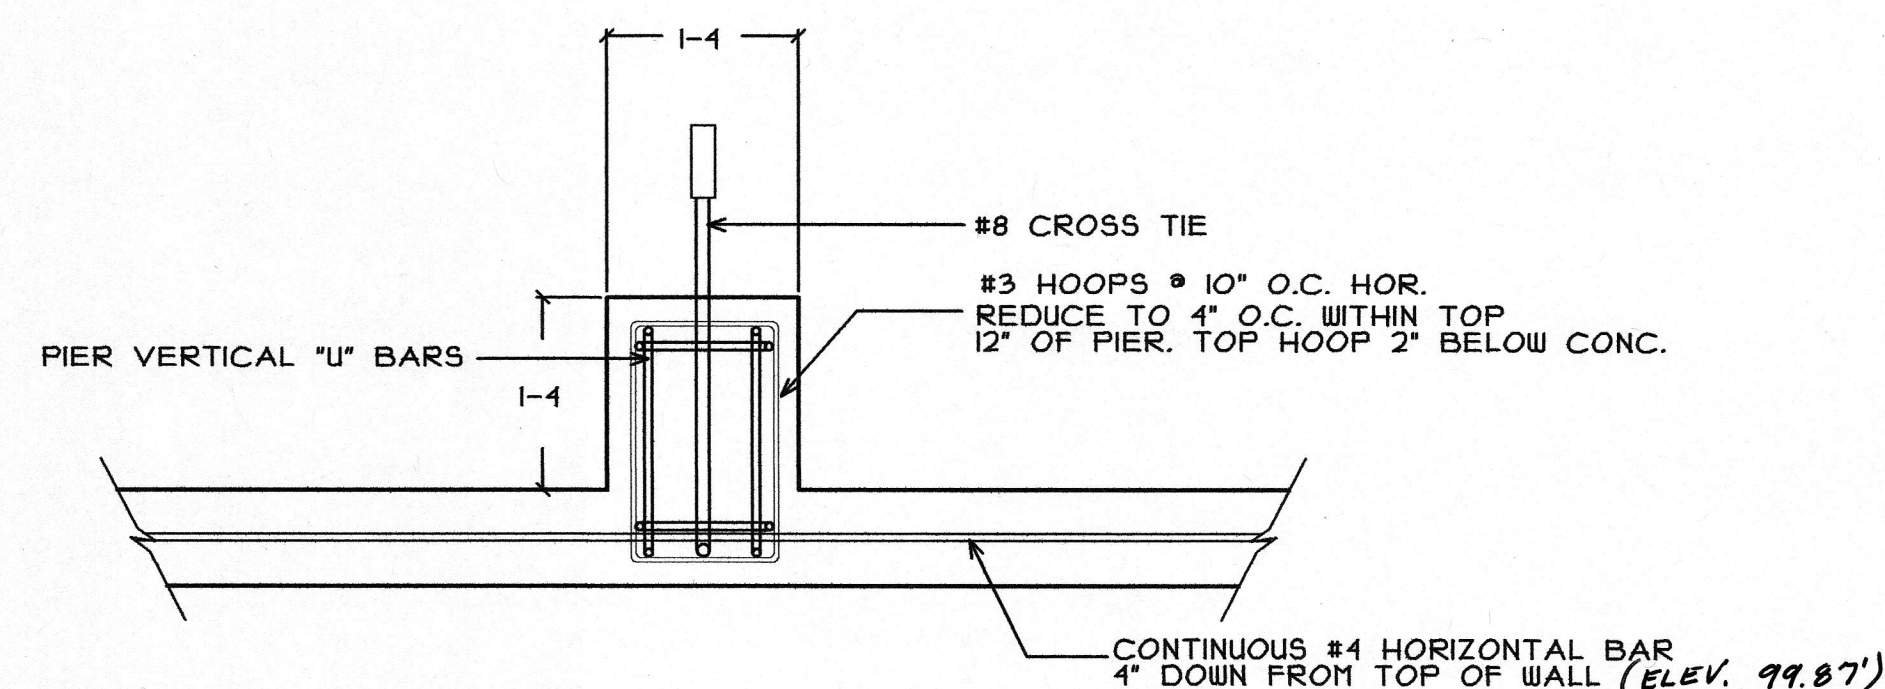


PIER REINFORCEMENT

2A, 3A, 6A  
2D THRU 6D

SCALE: 3/4" = 1'-0"

**BQ**  
BISKUP CONSTRUCTION, INC.  
16 DANIELLE DRIVE  
WINDHAM, MAINE 04062  
TEL. (207) 892-9800  
FAX. (207) 892-9895  
WWW.BISKUPCONSTRUCTION.COM

CONSULTANT  
ASSOCIATED DESIGN  
PARTNERS INC.  
80 Lightfoot Road  
Fairbush, Maine 04750  
Office: (207) 878-1755  
Fax: (207) 878-1758  
E-Mail: adp@adpartners.com

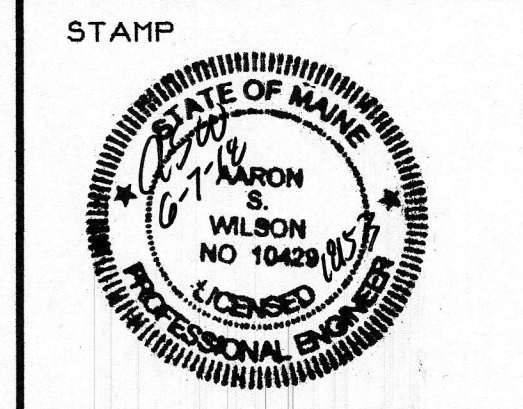

PROPOSED BUILDING  
320 P STREET, LLC  
314 PRESUMPCOT STREET  
PORTLAND, MAINE

REVISIONS

DATE	DESCRIPTION


DATE: 6/1/2018  
SCALE: 1/2" = 1'-0"  
DESIGNER: AW  
CHECKED BY: JB  
© COPYRIGHT  
BISKUP CONSTRUCTION, INC.

SHEET TITLE  
FOUNDATION  
DETAILS


SHEET NUMBER  
S-2  
SHEET 2 OF 3




Reviewed for Code Compliance  
 Permitting and Inspections Department  
 Approved with Conditions  
 07/23/2018

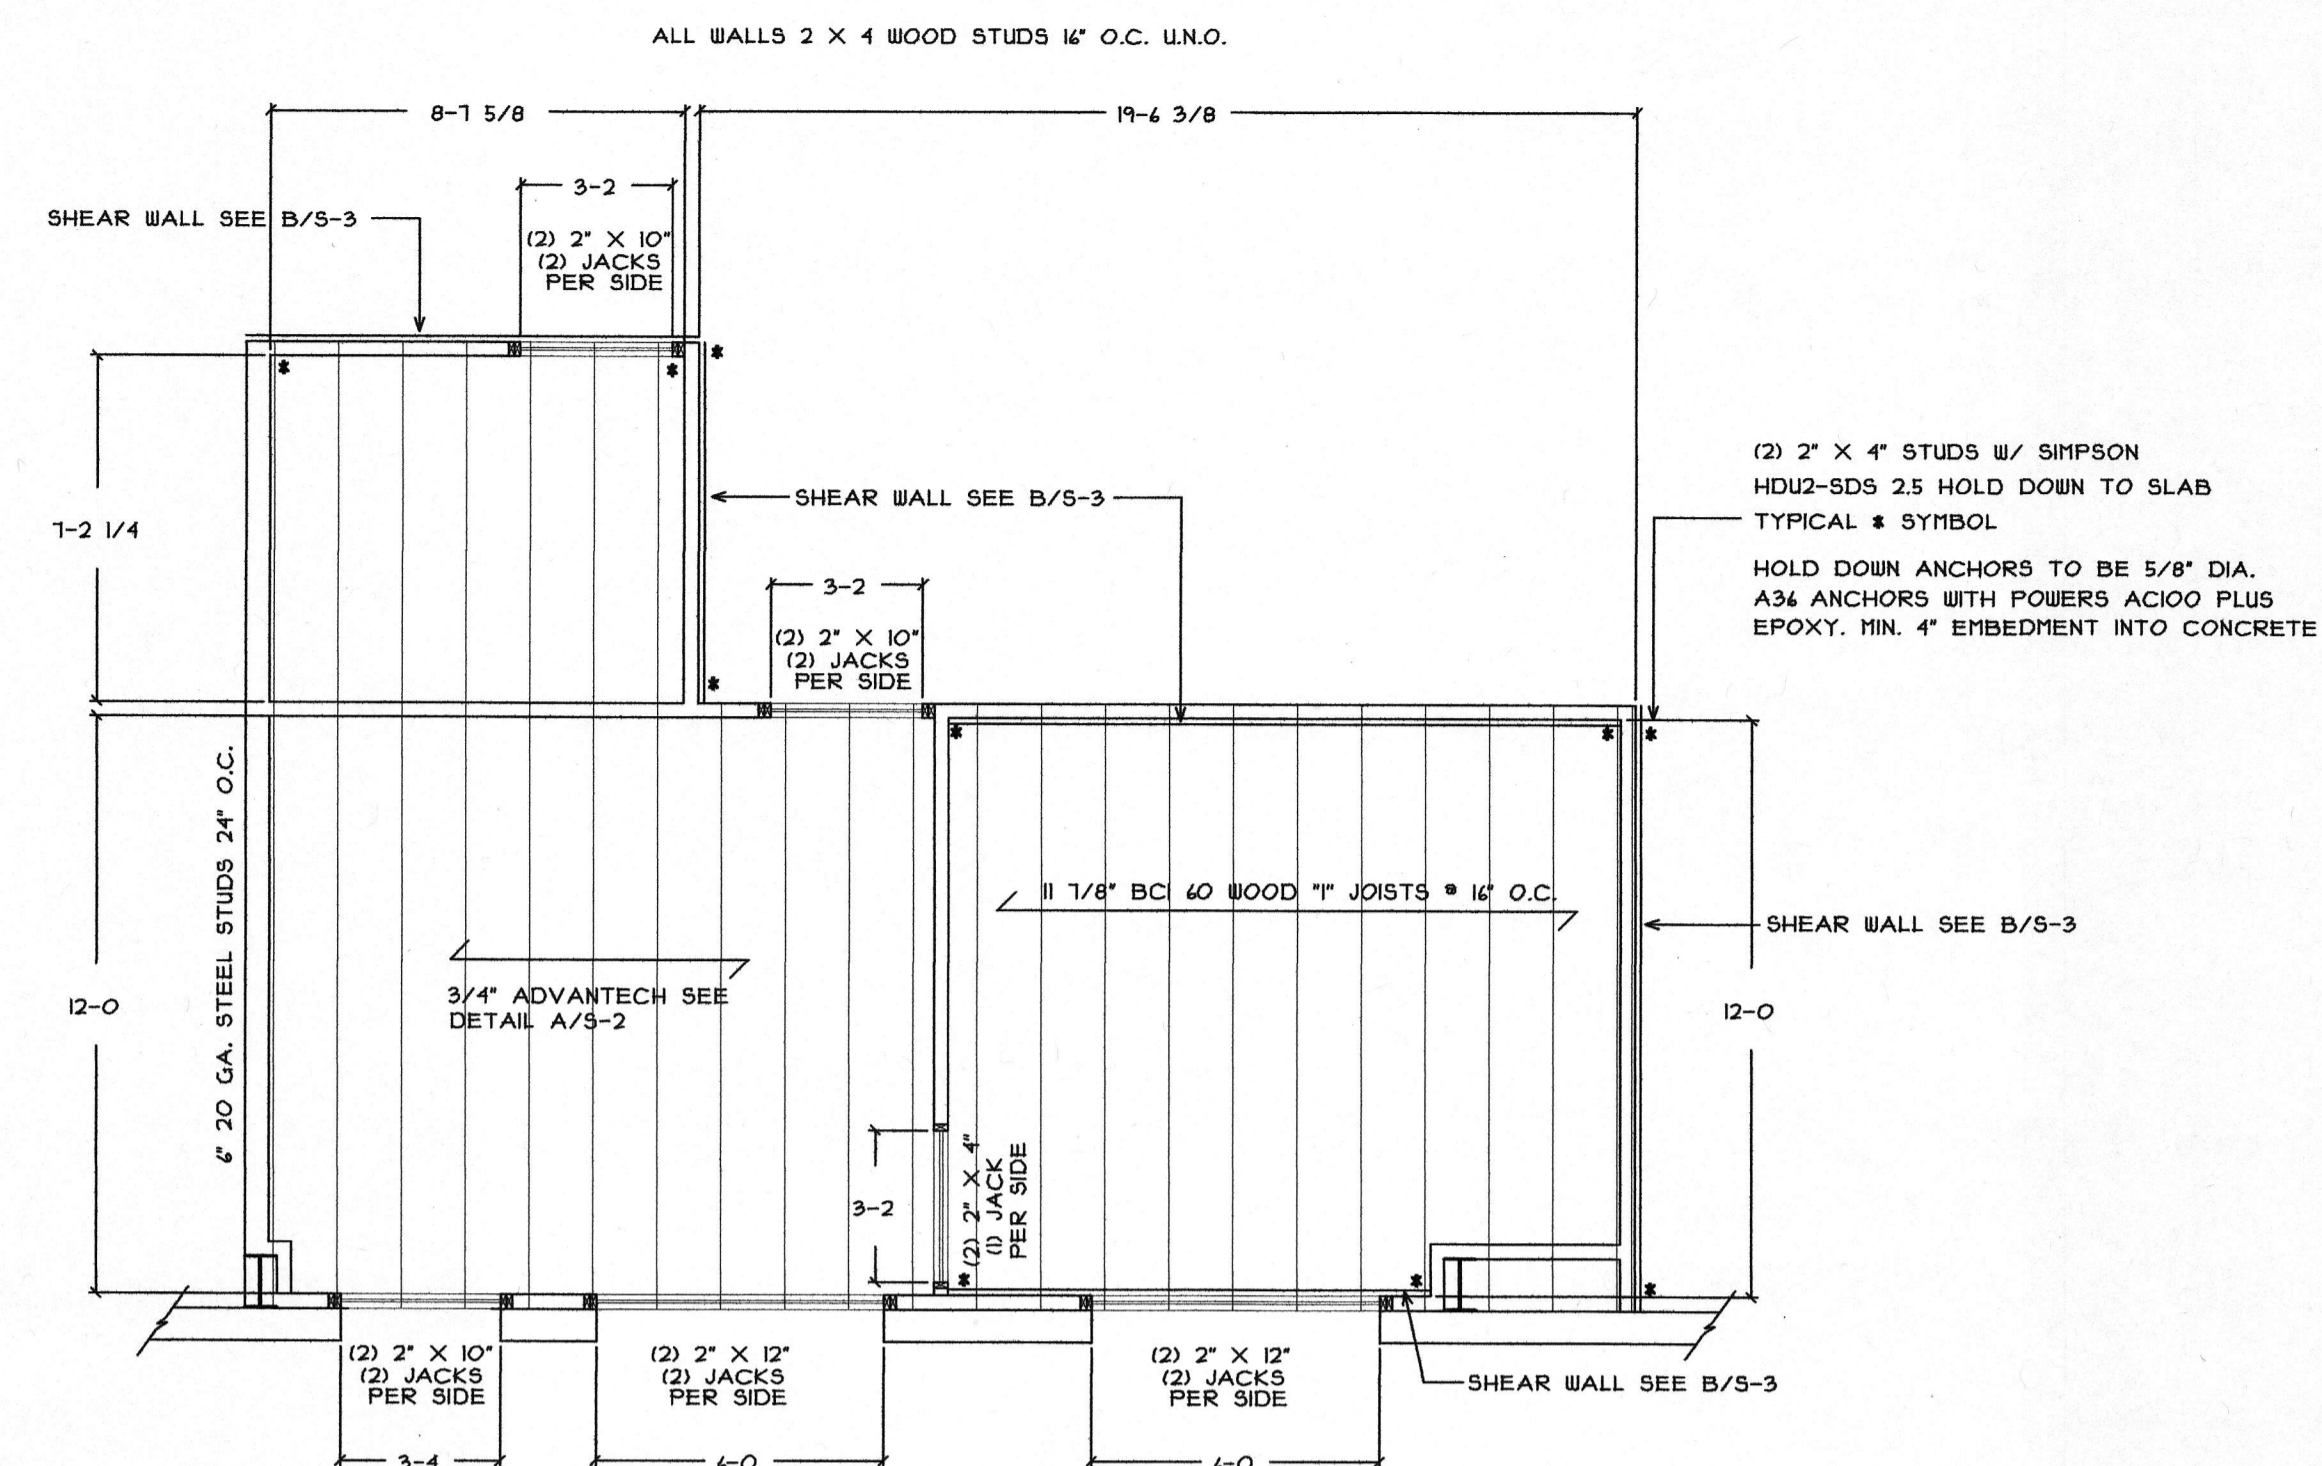


FLOOR DESIGN LOAD: 125 PSF LIGHT WAREHOUSE STORAGE  
 SCALE: 1/4" = 1'-0"  
 TYPICAL (3) TENANT SPACES

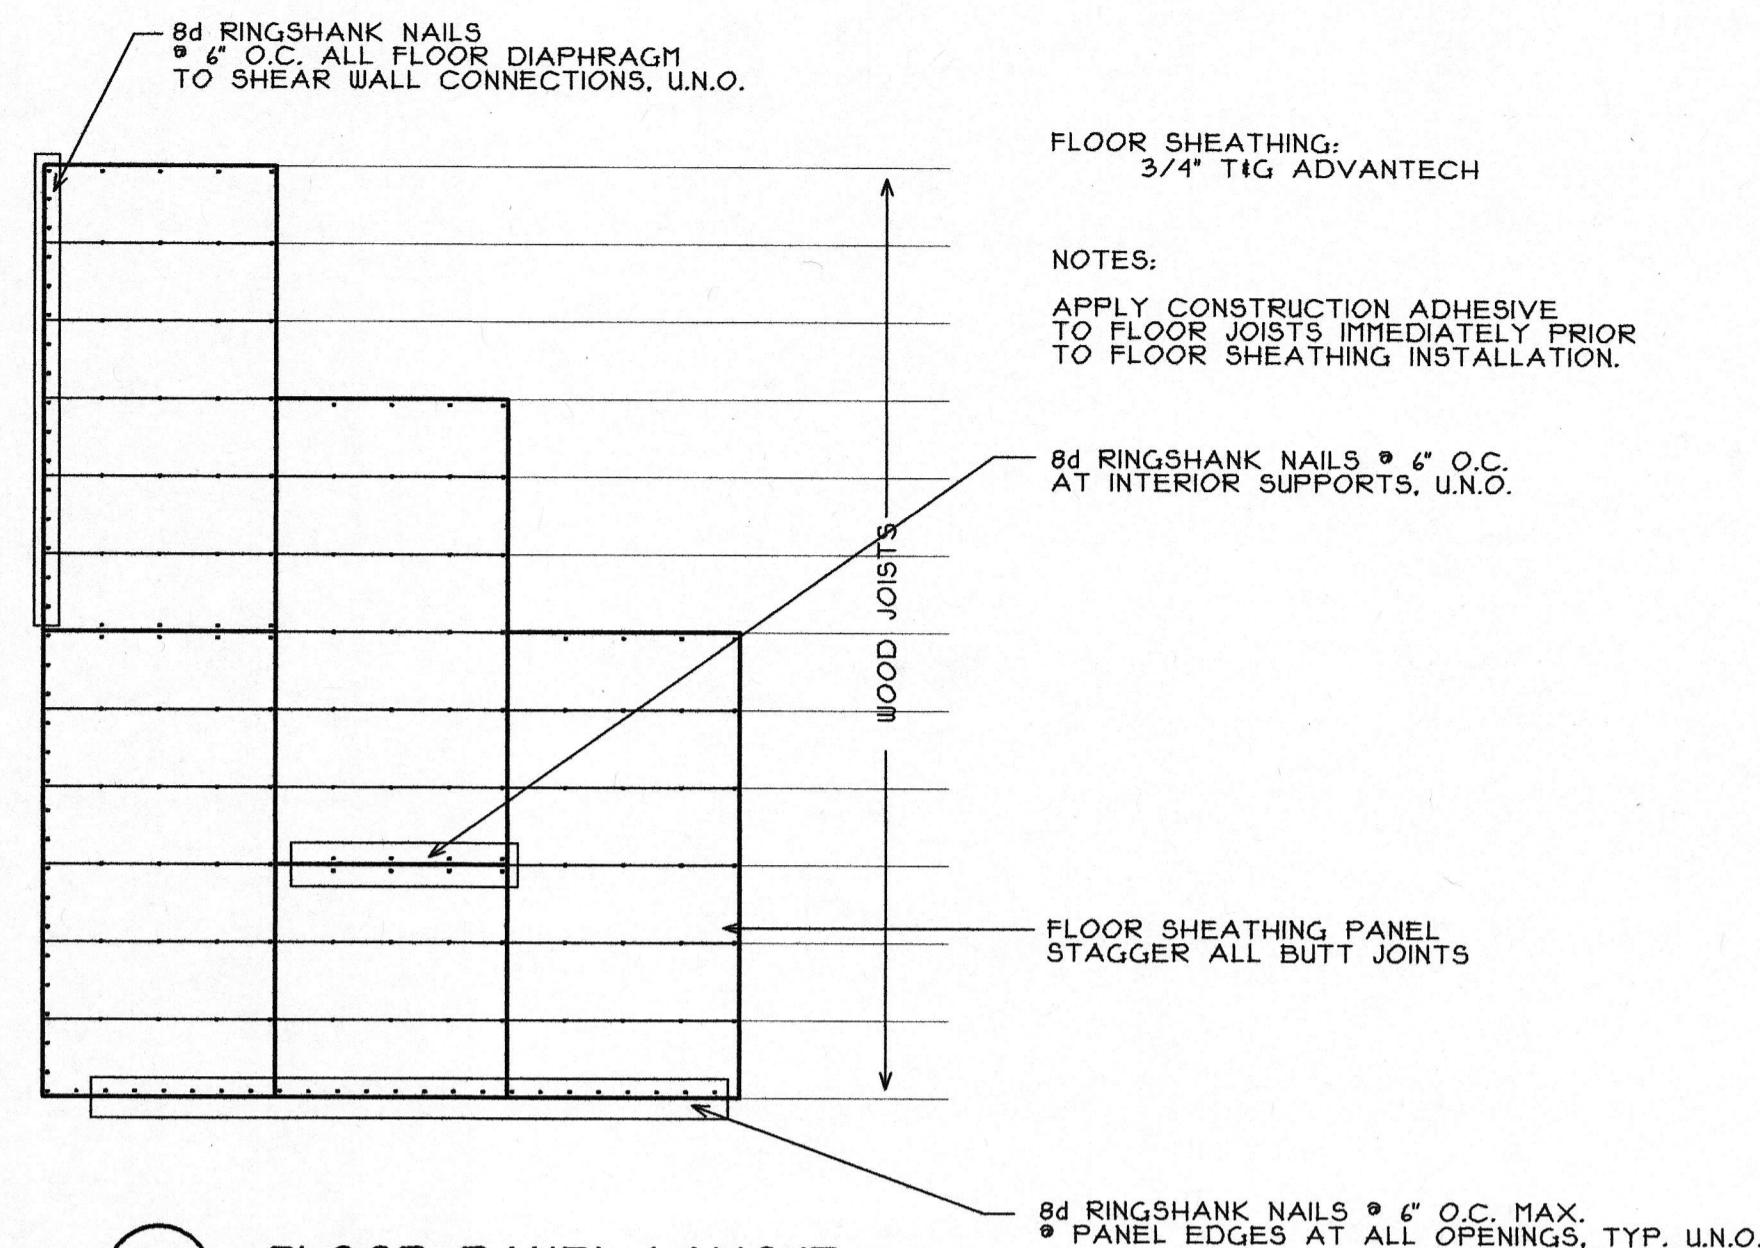


(A) FLOOR PANEL LAYOUT  
 SCALE: NO SCALE

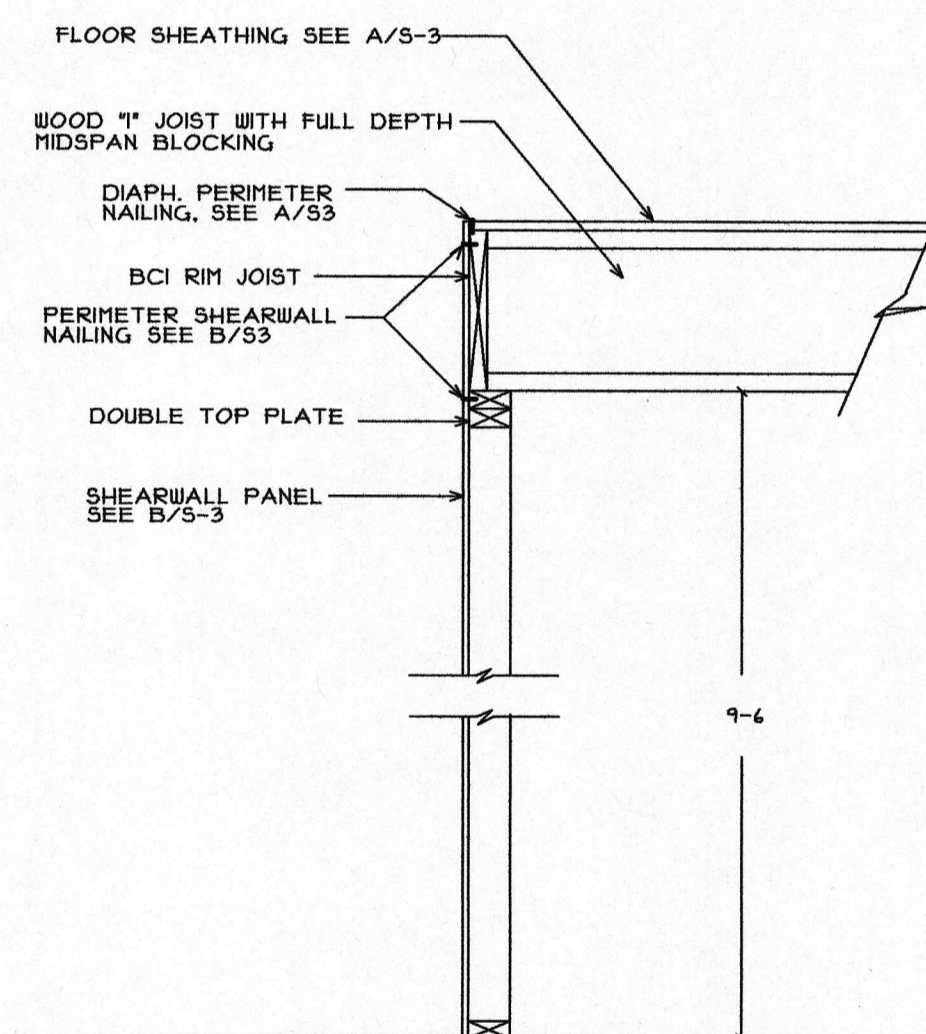

(C) FLOOR JOIST DETAIL  
 SCALE: NO SCALE

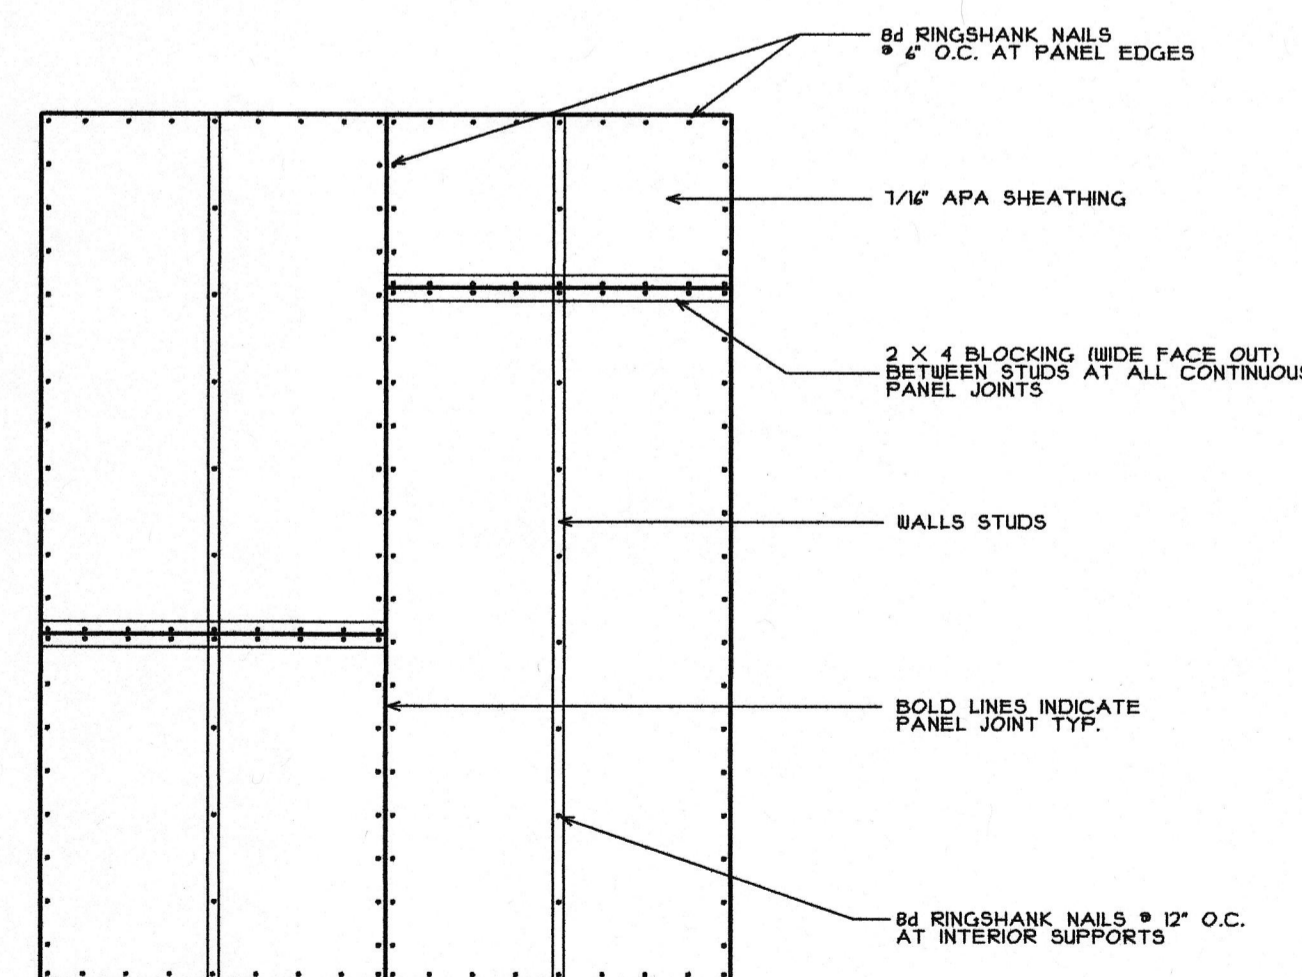

\* OPTIONAL PANELS MAY BE INSTALLED LONG SIDE HORIZONTAL WITH CONTINUOUS HORIZONTAL BLOCKING AT SEAMS  
 (B) SHEARWALL PANEL LAYOUT  
 SCALE: 1/2" = 1'-0"

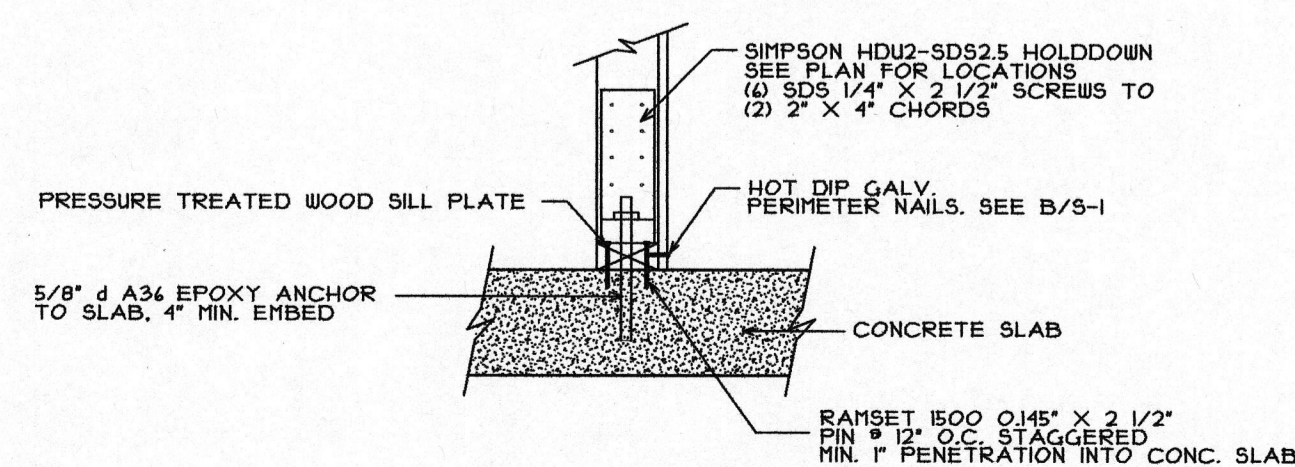

(D) SILL PLATE DETAIL  
 SCALE: NO SCALE

GENERAL STRUCTURAL NOTES


- ALL WORK SHALL CONFORM TO THE REQUIREMENTS OF ALL APPLICABLE STATE AND LOCAL CODES, INCLUDING BUT NOT LIMITED TO:
  - IBC BUILDING CODE 2015 ED
  - ANSI-ASCE 7-05
  - ACI 318-05 "BUILDING CODE REQUIREMENTS FOR REINFORCED CONCRETE"
  - ACI 301 "SPECIFICATIONS FOR STRUCTURAL CONCRETE FOR BUILDINGS"
  - AISC STEEL CONSTRUCTION MANUAL 9TH ED ASD
  - AISI COLD FORMED STEEL DESIGN MANUAL, 2001
  - ANSI-AF&PA NDS-2005
- DESIGN LOADS
  - 2.1. GRAVITY ROOF DESIGN LOADS:
 

MEZZ LIVE LOAD	125 PSF
MEZZ DEAD LOAD	15 PSF

THIS P.E. REVIEW COVERS STRUCTURAL FLOOR AND WALL FRAMING ELEMENTS FOR GRAVITY AND LATERAL LOADS DETAILED ON SHEET THIS SHEET ONLY. THIS P.E. REVIEW IS BASED ON THE MINIMUM DESIGN LOADS AND CONSTRUCTION STANDARDS SET FORTH THE IBC 2015 BUILDING CODE. DESIGN AND DETAIL FOR ALL OTHER FRAMING ELEMENTS, WIND/SEISMIC DESIGN, FRAMING CONNECTIONS, VENEER DESIGN, COMPONENTS AND CLADDING, FINISHES, FLOOR PLAN LAYOUT, THERMAL/MOISTURE PROTECTION (INCLUDING ROOFING AND INSULATION) LIFE SAFETY CODE REQUIREMENTS, AND OTHER ELEMENTS NOT SPECIFICALLY REPRESENTED HEREIN HAVE NOT BEEN REVIEWED AND ARE BEYOND THE PURVIEW OF THIS P.E. SEAL.

**BG**  
 BISKUP CONSTRUCTION, INC.  
 16 DANIELLE DRIVE  
 WINDHAM, MAINE 04042  
 TEL. (207) 892-9800  
 FAX. (207) 892-9895

CONSULTANT  
 ASSOCIATED DESIGN PARTNERS INC.  
 80 Leighton Road  
 Farmington, Maine 04005  
 Office: (207) 878-1725  
 Fax: (207) 878-1788  
 E-Mail: [adp@adpartners.com](mailto:adp@adpartners.com)

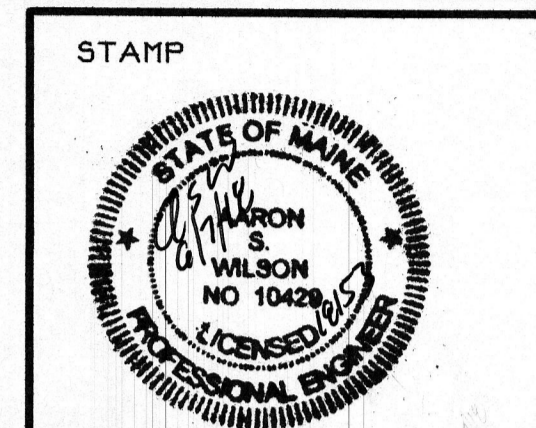



PROPOSED BUILDING  
 320 P STREET, LLC  
 314 PRESUMSCOT STREET  
 PORTLAND, MAINE

REVISIONS	
DATE	DESCRIPTION

DATE: 6/6/2018  
 SCALE: AS SHOWN  
 DESIGNER: AW  
 CHECKED BY: JB  
 © COPYRIGHT  
 BISKUP CONSTRUCTION, INC.

SHEET TITLE  
 FRAMING  
 DETAILS

SHEET NUMBER  
 S-3  
 SHEET 3 OF 3

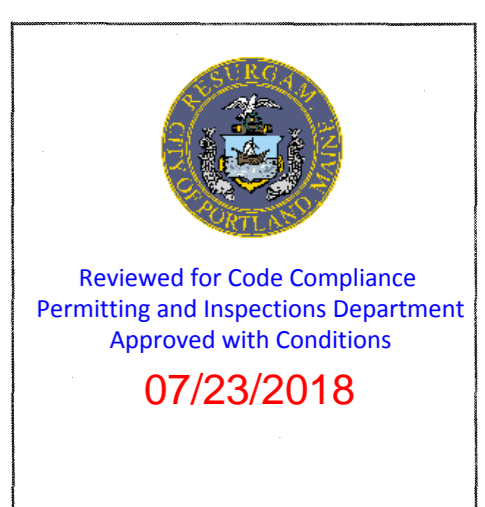
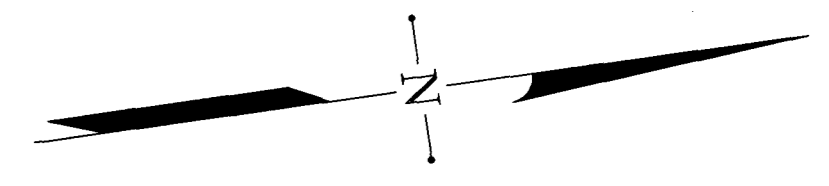


**GRADING & DRAINAGE NOTES:**

1. PRIOR TO THE START OF ANY EXCAVATION FOR THE PROJECT BOTH ON AND OFF THE SITE, THE CONTRACTOR SHALL NOTIFY DIGSAFE AND BE PROVIDED WITH A DIGSAFE NUMBER INDICATING THAT ALL EXISTING UTILITIES HAVE BEEN LOCATED AND MARKED.
2. CONTRACTOR SHALL VERIFY EXISTING GRADES AND NOTIFY THE OWNER'S REPRESENTATIVE OF ANY DISCREPANCIES.
3. CONTRACTOR SHALL MAINTAIN POSITIVE DRAINAGE AWAY FROM ALL STRUCTURES AND PLANTING BEDS.
4. CONTRACTOR TO ADJUST EXISTING AND PROPOSED UTILITY ELEMENT MEANT TO BE FLUSH WITH GRADE (CLEAN-OUTS, UTILITY MANHOLES, CATCH BASINS, INLETS, ETC) THAT ARE AFFECTED BY SITE WORK OR GRADE CHANGES, WHETHER SPECIFICALLY NOTED ON PLANS OR NOT.
5. WHERE PROPOSED GRADES MEET EXISTING GRADES, CONTRACTOR SHALL BLEND GRADES TO PROVIDE A SMOOTH TRANSITION BETWEEN EXISTING AND NEW WORK. PONDING AT TRANSITION AREAS WILL NOT BE ALLOWED.
6. CONTRACTOR SHALL PROVIDE A FINISHED PAVEMENT SURFACE FREE OF LOW SPOTS AND PONDING AREAS.
7. ALL WALKS SHALL HAVE A 2% CROSS SLOPE.
8. WHERE SLOPES IN DISTURBED AREAS EXCEED 3:1 AND IN SWALES THE CONTRACTOR SHALL INSTALL CURLEX 11 EROSION CONTROL BLANKET FROM AMERICAN EXCELSIOR. WHERE SLOPES EQUAL OR EXCEED 2:1, CONTRACTOR SHALL INSTALL ENKAMAT 7020 TURF REINFORCEMENT MATTING, OR APPROVED EQUAL.
9. ALL DRAINAGE PIPE NOT CALLED OUT ON THE DRAWINGS SHALL BE SMOOTH INTERIOR, CORRUGATED EXTERIOR, HDPE, N-12 AS MANUFACTURED BY ADS.
10. ALL UNSUITABLE AND UNUSED MATERIALS WHICH CAN NOT BE DISPOSED OF ON SITE SHALL BE REMOVED AND DISPOSED OF OFF SITE BY THE CONTRACTOR IN ACCORDANCE WITH ALL STATE AND LOCAL LAWS.
11. SEE SHEET C-200 FOR EROSION CONTROL NOTES, SEQUENCE AND DETAILS.
12. REFER TO DRAWINGS C-100 THRU C-104, C-200 THRU 203 AND THE ARCHITECTURAL DRAWINGS FOR ADDITIONAL INFORMATION.



**LEGEND:**

	PROJECT BOUNDARY LINE		ABUTTER BOUNDARY LINE
	SETBACK LINE		OVERHEAD UTILITY
	OHU		UNDERGROUND UTILITY
	FM		SANITARY SEWER FORCE MAIN
	SS		SANITARY SEWER
	W		WATER SERVICE
	CONTOUR		UTILITY POLE
	BUILDING		BUILDING
	RIPRAP		RIPRAP
	GRAVEL		GRAVEL
	BITUMINOUS CONCRETE PAVEMENT		BITUMINOUS CONCRETE PAVEMENT
	TREE		TREE
	TURF REINFORCEMENT MATTING		TURF REINFORCEMENT MATTING

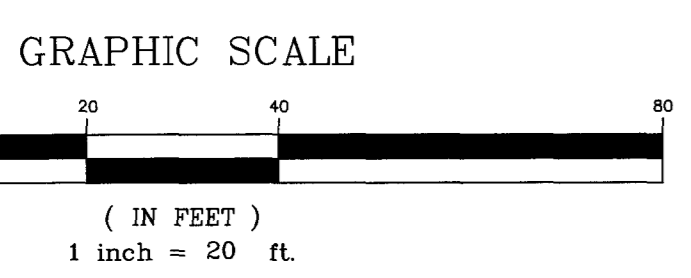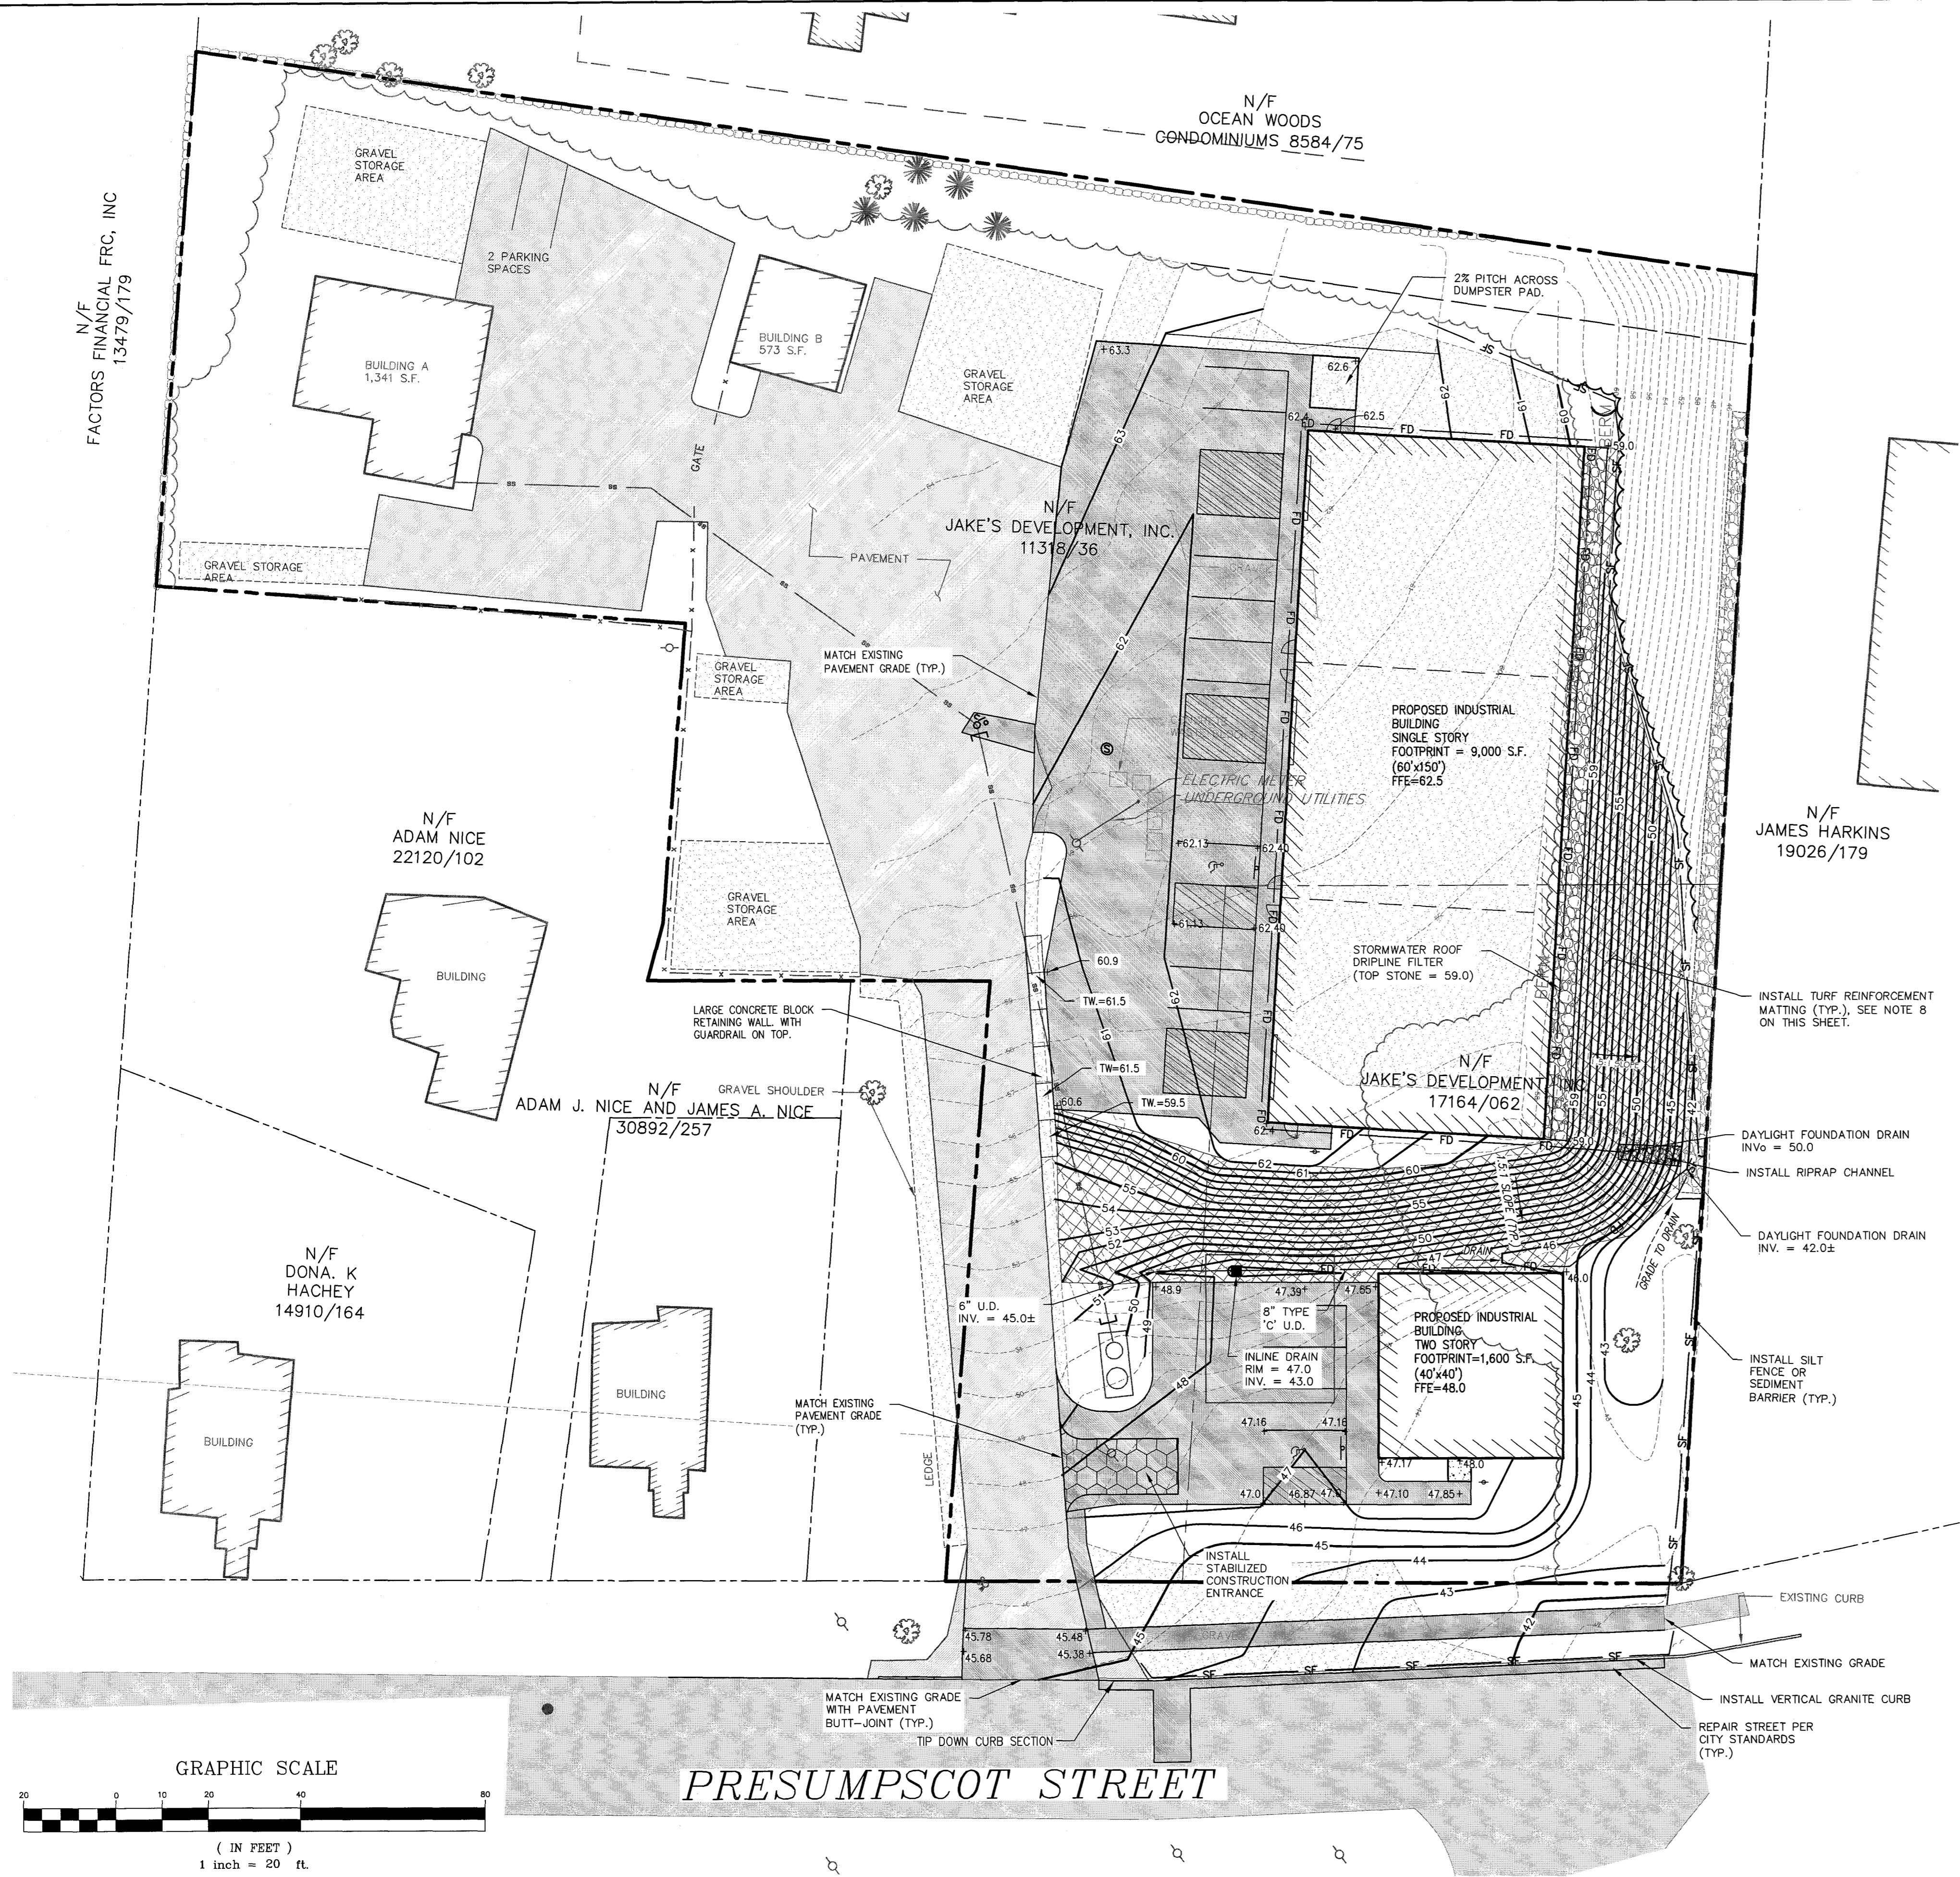

**PRESUMPCOT STREET**

REV.	DATE	STATUS	BY	CHKD.	APPD.	REV.	DATE	STATUS	BY	CHKD.	APPD.
B	3/7/18	REVISED PER STAFF COMMENTS AND RESUBMITTED TO THE CITY OF PORTLAND	DEPT.	SWC	PBB						
A	11/30/17	SUBMITTED TO THE CITY OF PORTLAND FOR LEVEL 2 SITE PLAN APPLICATION	DEPT.	SWC	PBB						

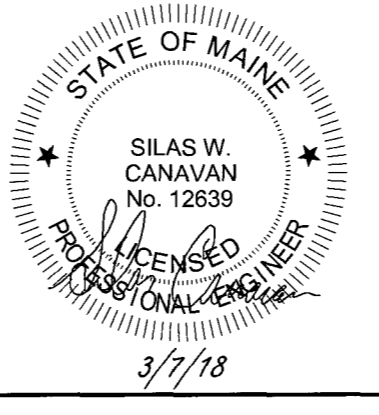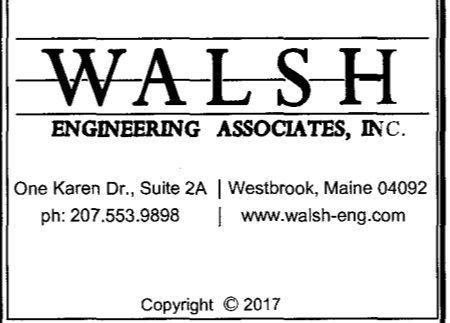

**LAND DESIGN SOLUTIONS**  
 LAND PLANNING, SITE PLANNING & LANDSCAPE ARCHITECTURE  
 P.O. Box 316, 160 Longwoods Road, Cumberland, ME 04021 | tel: (207) 494-1717  
 APPLICANT & OWNER:  
**JAKE'S DEVELOPMENT, INC.**  
 30 LEDGEWOOD DRIVE, FALMOUTH, MAINE 04105

DESIGN: --	<b>PROPOSED PRESUMPCOT STREET BUSINESS PARK</b> 314-316 PRESUMPCOT STREET, PORTLAND, MAINE
DRAWN: --	
CHKD: --	
DATE: NOV. 2017	<b>GRADING, DRAINAGE AND EROSION CONTROL PLAN</b>
SCALE: 1"=20'	
PROJ. NO.	16-115
DWG. NO.	-102
	<b>C-102</b>



Reviewed for Code Compliance  
 Permitting and Inspections Department  
 Approved with Conditions  
 07/23/2018


**B&C**  
 BISKUP CONSTRUCTION, INC.  
 14 DANIELLE DRIVE  
 WINDHAM, MAINE 04062  
 TEL. (207) 892-9800  
 FAX. (207) 892-9895  
 WWW.BISKUPCONSTRUCTION.COM

IBC 2015: CODE DATA	
OCCUPANT LOAD - TABLE 1004.1.2	91 IND. 1483/100=11 B 1317/100=14
USE GROUP CLASSIFICATION - SECTION 306.2, 304.1	F-1 FACTORY INDUSTRIAL, B BUSINESS
TYPE OF CONSTRUCTION - TABLE 601	V-B
ACTUAL BUILDING AREA	9,000 S.F.
BUILDING AREA LIMITATION - TABLE 504.2	8,500 S.F. (NO SPRINKLER)
STREET FRONTAGE INCREASE - 504.3.3	850 S.F. (SEE BELOW)
ALLOWABLE BUILDING AREA	9,350 S.F.
BUILDING HEIGHT LIMITATION - TABLE 504.4	1 STORY
BUILDING HEIGHT	24'-0" 1 STORY
FIRE SUPPRESSION: 903.2.4	NOT REQUIRED
FIRE RESISTANT CONSTRUCTION:	
STRUCTURAL FRAME	NA
EXTERIOR BEARING WALLS	NA
INTERIOR BEARING WALLS	NA
EXTERIOR NONBEARING WALLS	NA
FIRE WALLS & PARTY WALLS - TABLE 508.4	NO SEPARATION REQUIRED
FLOOR CONSTRUCTION	NA
ROOF CONSTRUCTION	NA
STAIR ENCLOSURES	NA
EXIT ACCESS TRAVEL DISTANCE - TABLE 1011.2	200' (NO SPRINKLER SYSTEM)
COMMON PATH OF TRAVEL - SEE NFPA 101-2009 TABLE A1.4	50' (NO SPRINKLER SYSTEM)
MINIMUM NUMBER OF EXITS - TABLE 1004.3.1	2
ACCESSORY USE	NA
FIRE EXTINGUISHERS - TABLE 904.3(1)	2-A, 1 AT EACH EXIT
GENERAL NOTES	


NFPA 101: CODE DATA - 2009 EDITION	
OCCUPANT LOAD - TABLE 13.1.2	91 IND. 1483/100=11 B 1317/100=14
USE GROUP CLASSIFICATION - 401.4(1), 381.4	GENERAL INDUSTRIAL, BUSINESS
TYPE OF CONSTRUCTION - TABLE 81	V (000)
ACTUAL BUILDING AREA	9,000 S.F.
BUILDING HEIGHT	24'-0" 1 STORY
FIRE SUPPRESSION: 403.5, 383.5	NOT REQUIRED
FIRE RESISTANT CONSTRUCTION:	
STRUCTURAL FRAME	NA
EXTERIOR BEARING WALLS	NA
INTERIOR BEARING WALLS	NA
EXTERIOR NONBEARING WALLS	NA
FIRE WALLS & PARTY WALLS - 614.3.2 MIXED USE	NO SEPARATION REQUIRED
FLOOR CONSTRUCTION	NA
ROOF CONSTRUCTION	NA
STAIR ENCLOSURES	NA
EXIT ACCESS TRAVEL DISTANCE - TABLE 402.4	200' (NO SPRINKLER SYSTEM)
COMMON PATH OF TRAVEL - TABLE 402.5	50' (NO SPRINKLER SYSTEM)
MINIMUM NUMBER OF EXITS - 402.4(1)	2
ACCESSORY USE	NA
FIRE EXTINGUISHERS	2-A, 1 AT EACH EXIT
GENERAL NOTES	

NFPA 1: CODE DATA - 2009 EDITION	
OCCUPANT LOAD - TABLE 14.8.1.2	91 IND. 1483/100=11 B 1317/100=14
USE GROUP CLASSIFICATION - SECTION 411.2 411	GENERAL INDUSTRIAL, BUSINESS
TYPE OF CONSTRUCTION - TABLE A1.2.1	V (000)
ACTUAL BUILDING AREA	9,000 S.F.
BUILDING HEIGHT	24'-0" 1 STORY
FIRE SUPPRESSION:	NONE REQUIRED
FIRE WALLS & PARTY WALLS	NA
COMMON PATH OF TRAVEL 1410.1.4	50' (NO SPRINKLER SYSTEM)
MINIMUM NUMBER OF EXITS 14.1.1	2
FIRE EXTINGUISHERS - TABLE 13.4.8.2(1)	2-A, 1 AT EACH EXIT
GENERAL NOTES	

STREET FRONTAGE INCREASE 504.3.3  
 AREA INCREASE = (150/120-0.25) 30/30  
 AREA INCREASE = 0.10 OR 850 S.F.

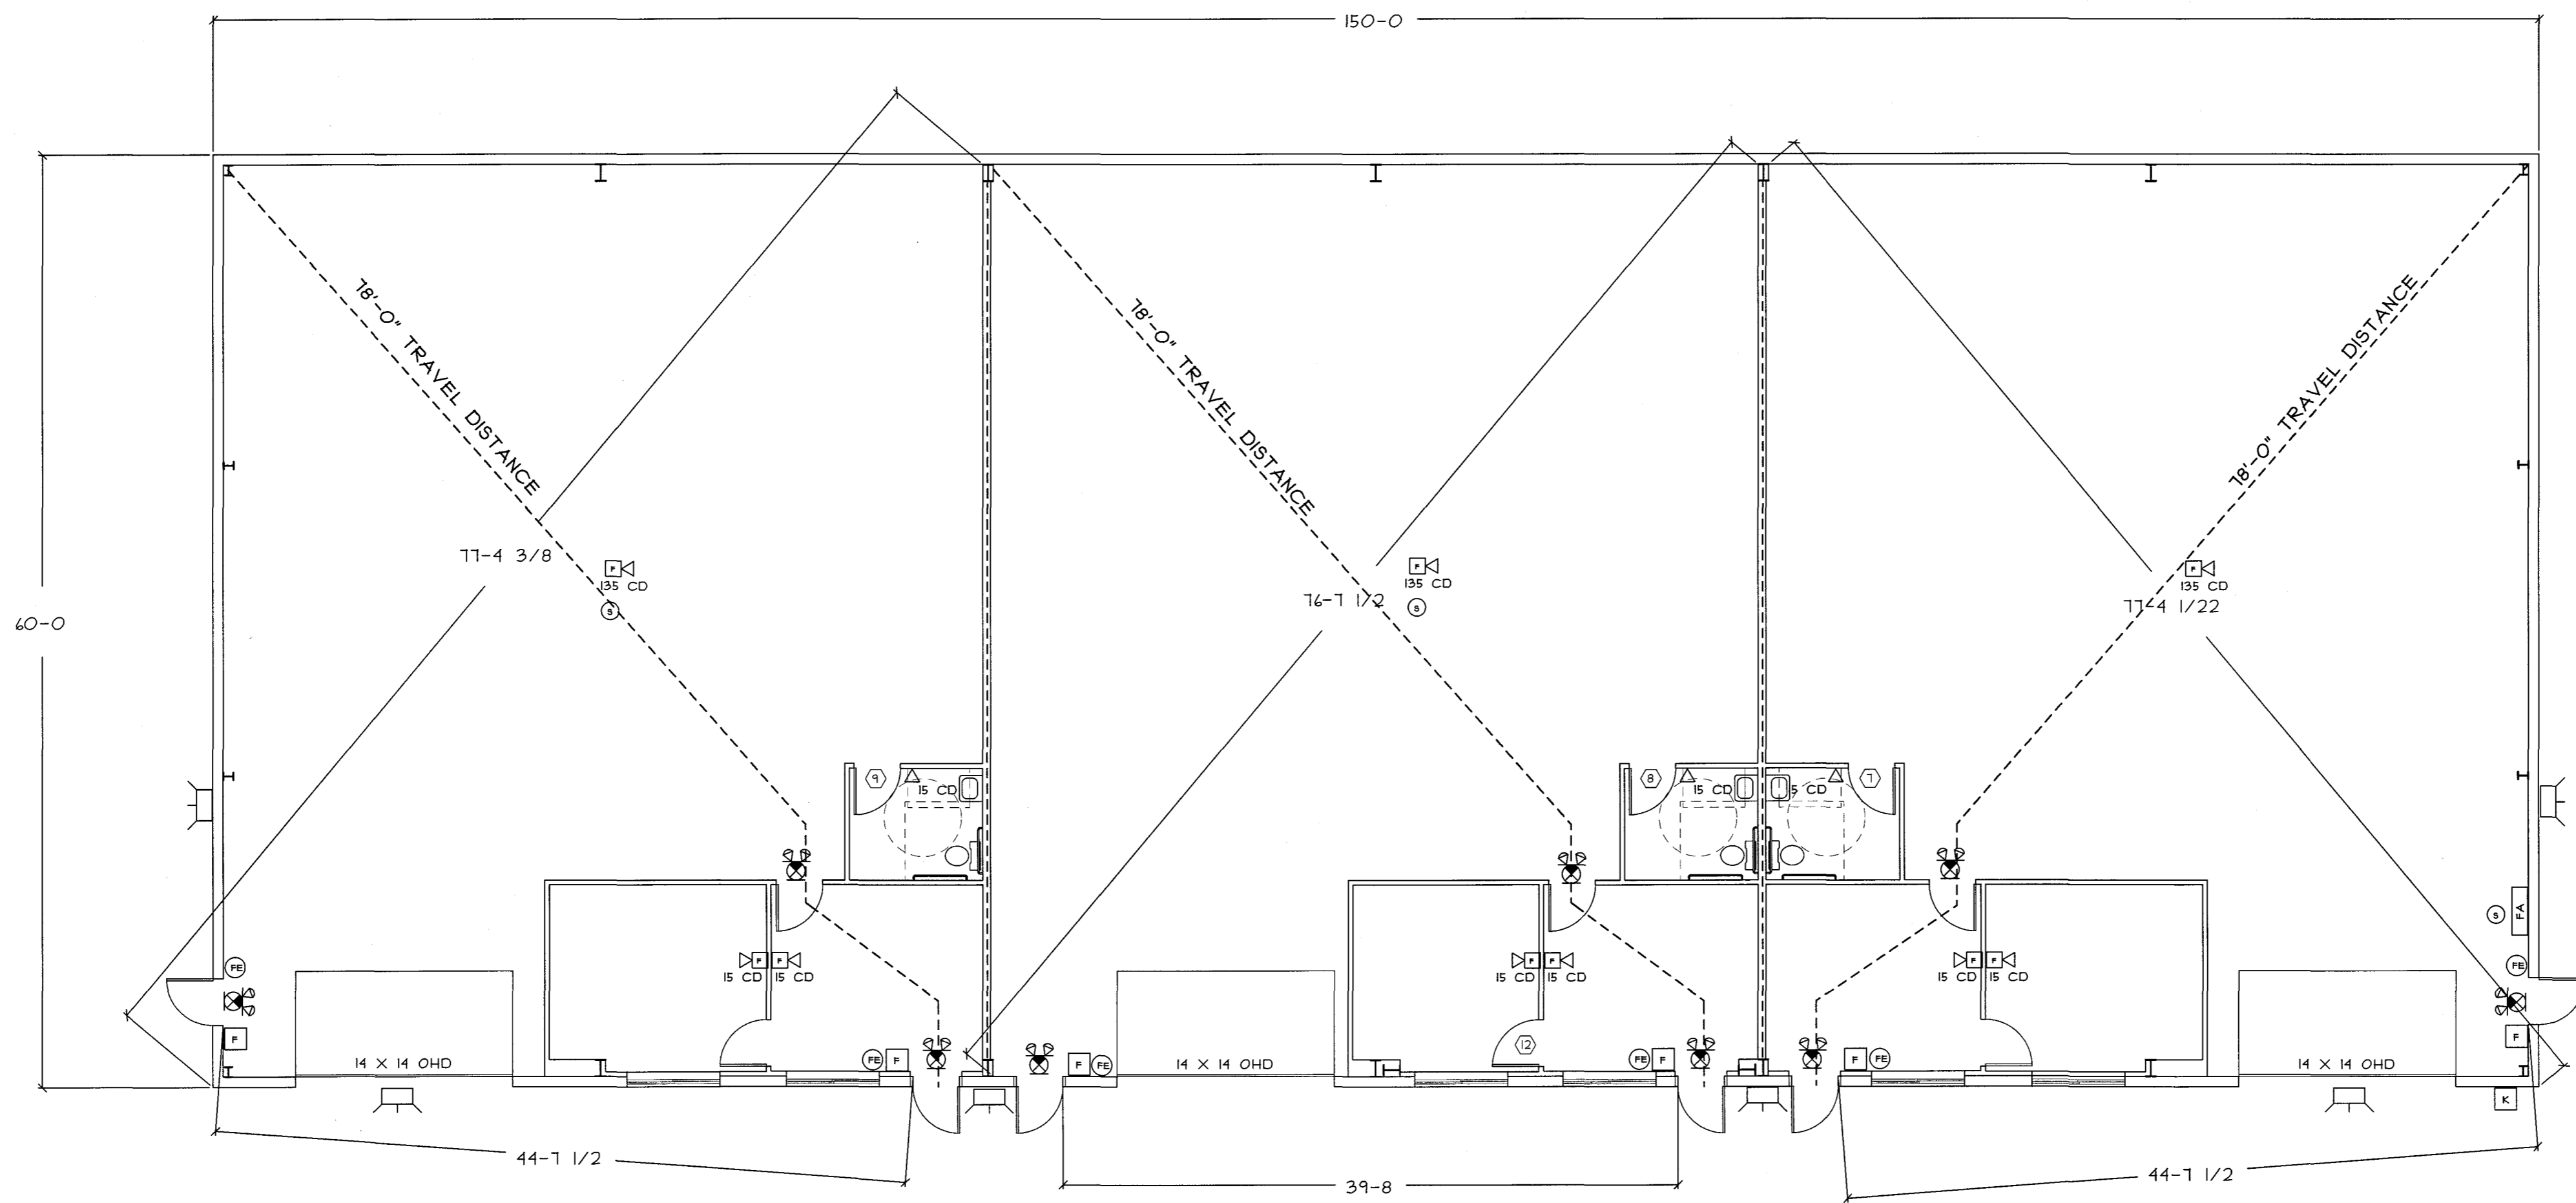

- MANUAL PULL STATION
- ADA HORN/STROBE
- ADA STROBE ONLY
- ALARM PANEL
- SMOKE DETECTOR
- EXIT SIGN
- EMERGENCY LIGHT PACK
- KNOX BOX
- FIRE EXTINGUISHER

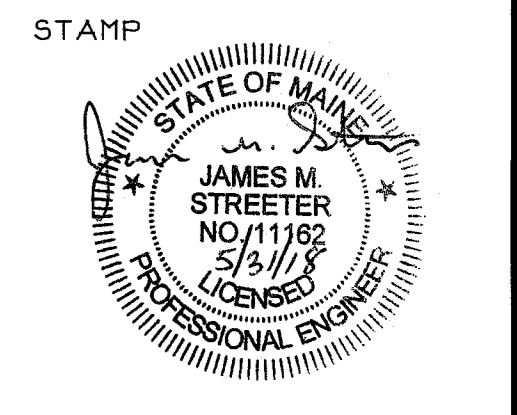

**J. M. STREETER**  
 ARCHITECTURAL  
 ENGINEER  
 66 CARSOE DRIVE  
 PORTLAND, MAINE 04103 (207) 797-3093

PROJECT:  
 PROPOSED BUILDING  
 320 P STREET, LLC  
 314 PRESUMPSCOT STREET  
 PORTLAND, MAINE

REVISIONS	
DATE	DESCRIPTION


DATE: 5/30/2018  
 SCALE: 1/8" = 1'-0"  
 DESIGNER: JS  
 CHECKED BY: JB  
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 BISKUP CONSTRUCTION, INC.

SHEET TITLE  
**LIFE SAFETY PLAN**

SHEET NUMBER  
**A-2**  
 SHEET 2 OF 5



Reviewed for Code Compliance  
 Permitting and Inspections Department  
 Approved with Conditions  
 07/23/2018

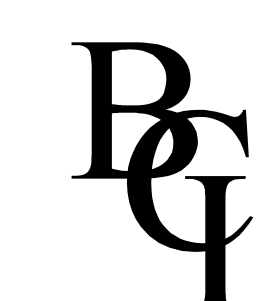

BISKUP CONSTRUCTION, INC.  
 16 DANIELLE DRIVE  
 WINDHAM, MAINE 04062  
 TEL. (207) 892-9800  
 FAX. (207) 892-9895  
 WWW.BISKUPCONSTRUCTION.COM

STAMP

PROJECT:  
 PROPOSED BUILDING  
 320 P STREET, LLC  
 314 PRESUMPCOTT STREET  
 PORTLAND, MAINE


REVISIONS	
DATE	DESCRIPTION

DATE: 5/4/2018  
 SCALE: 1/8" = 1'-0"  
 DESIGNER: JS  
 CHECKED BY: JB

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SHEET TITLE  
 LIGHTING  
 PLAN

SHEET NUMBER  
 E-2  
 SHEET 2 OF 2

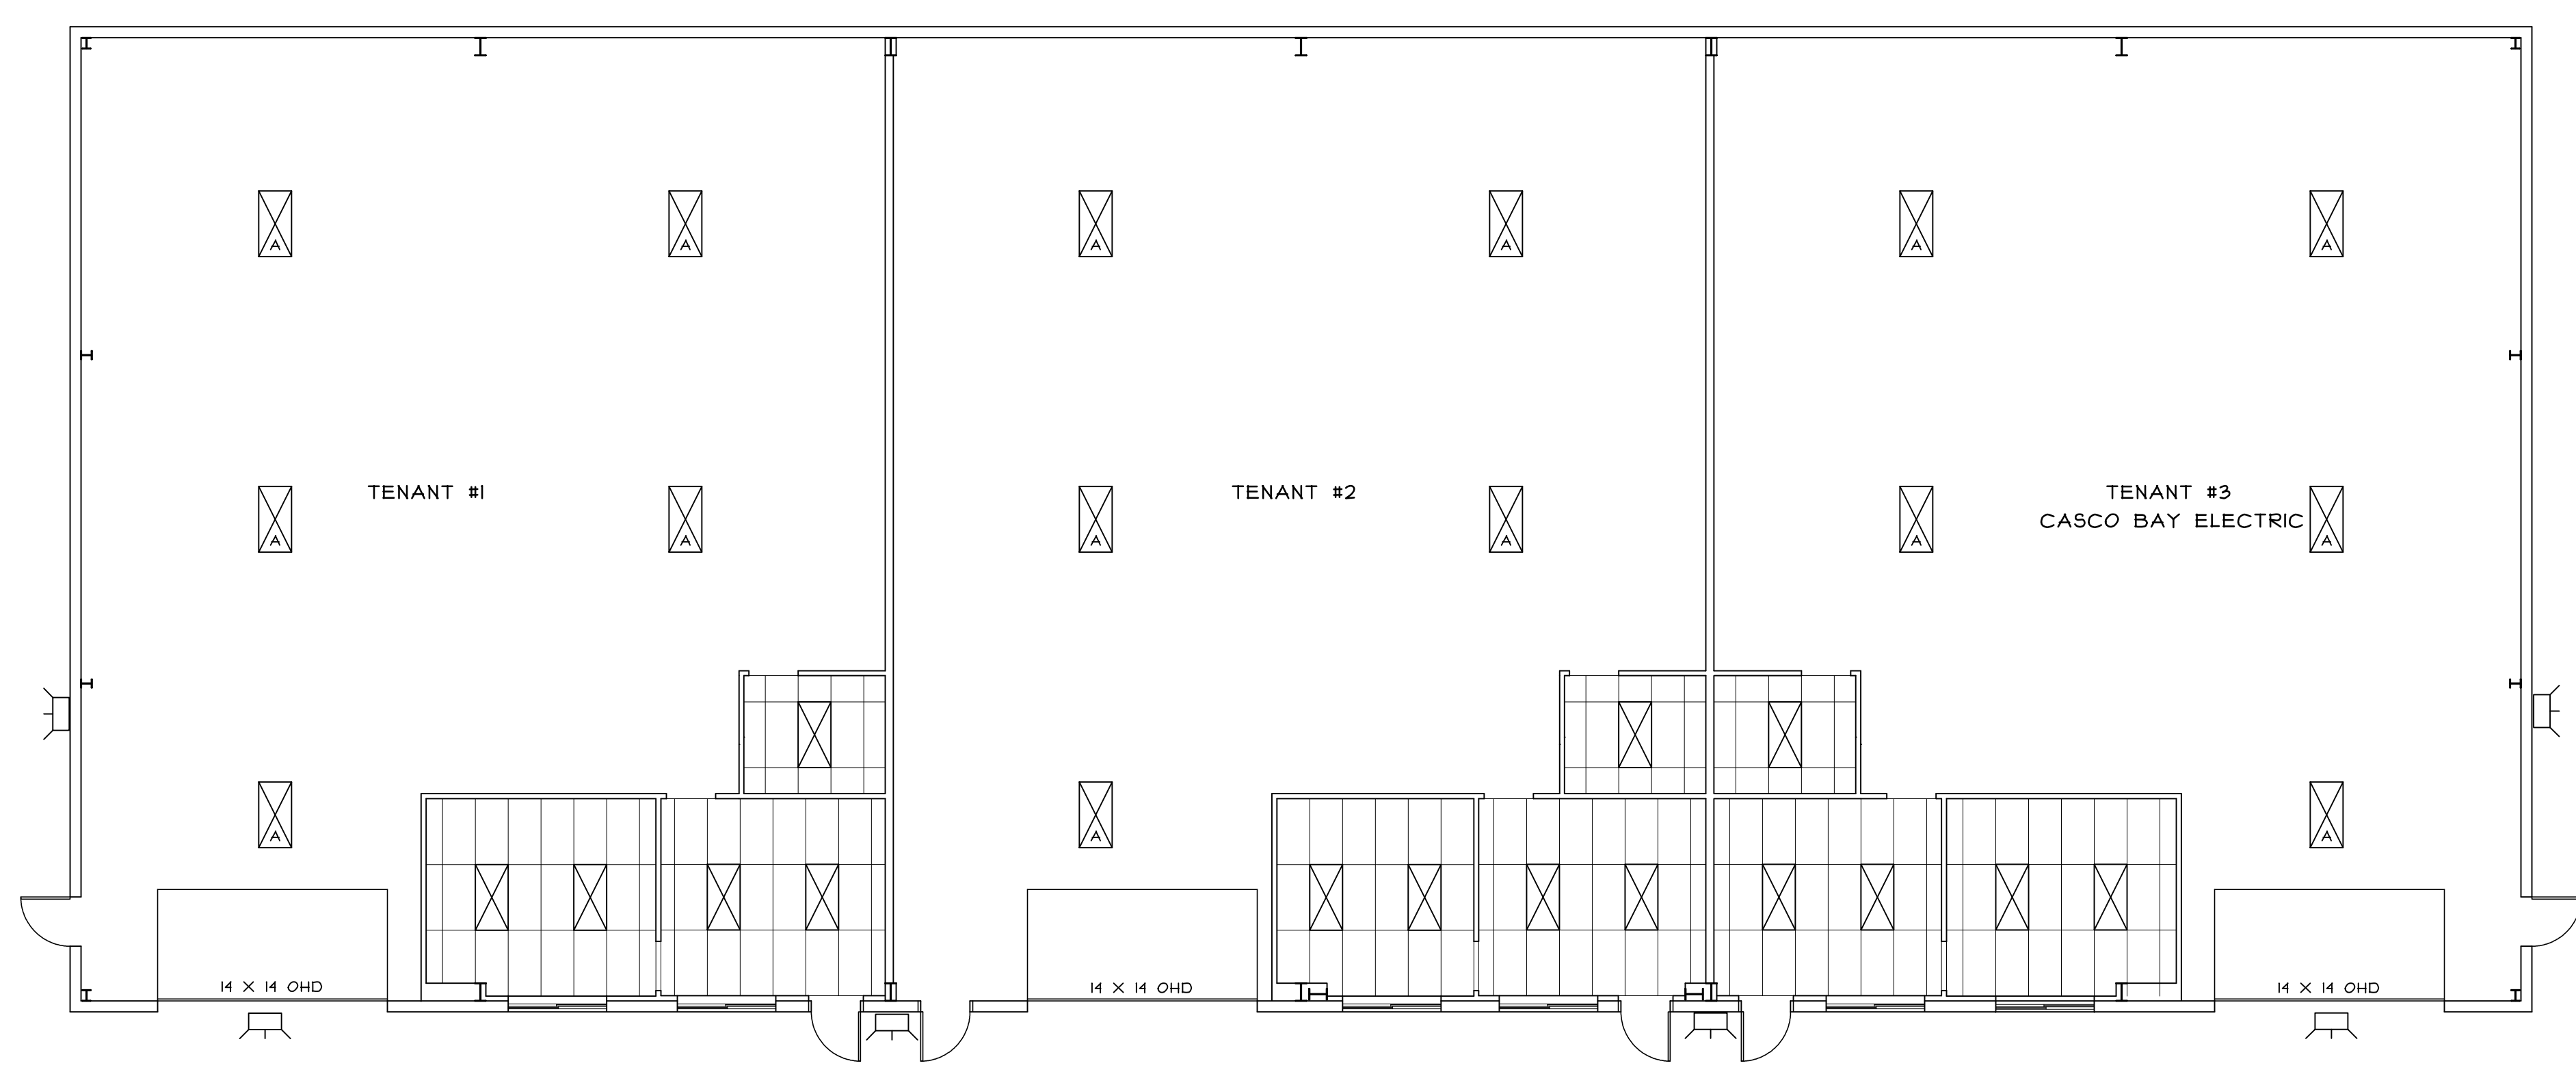

ALL CEILINGS 8'-3" A.F.F.

- RAB LED FULL CUTOFF WPLED52N
- ALEO LED SLB2-165/850/F XE G3
- ALEO LED LT-CD-24LE-34/840 XE G3




Reviewed for Code Compliance  
 Permitting and Inspections Department  
 Approved with Conditions  
 07/23/2018



BISKUP CONSTRUCTION, INC.  
 16 DANIELLE DRIVE  
 WINDHAM, MAINE 04042  
 TEL. (207) 892-9800  
 FAX. (207) 892-9895

WWW.BISKUPCONSTRUCTION.COM

STAMP

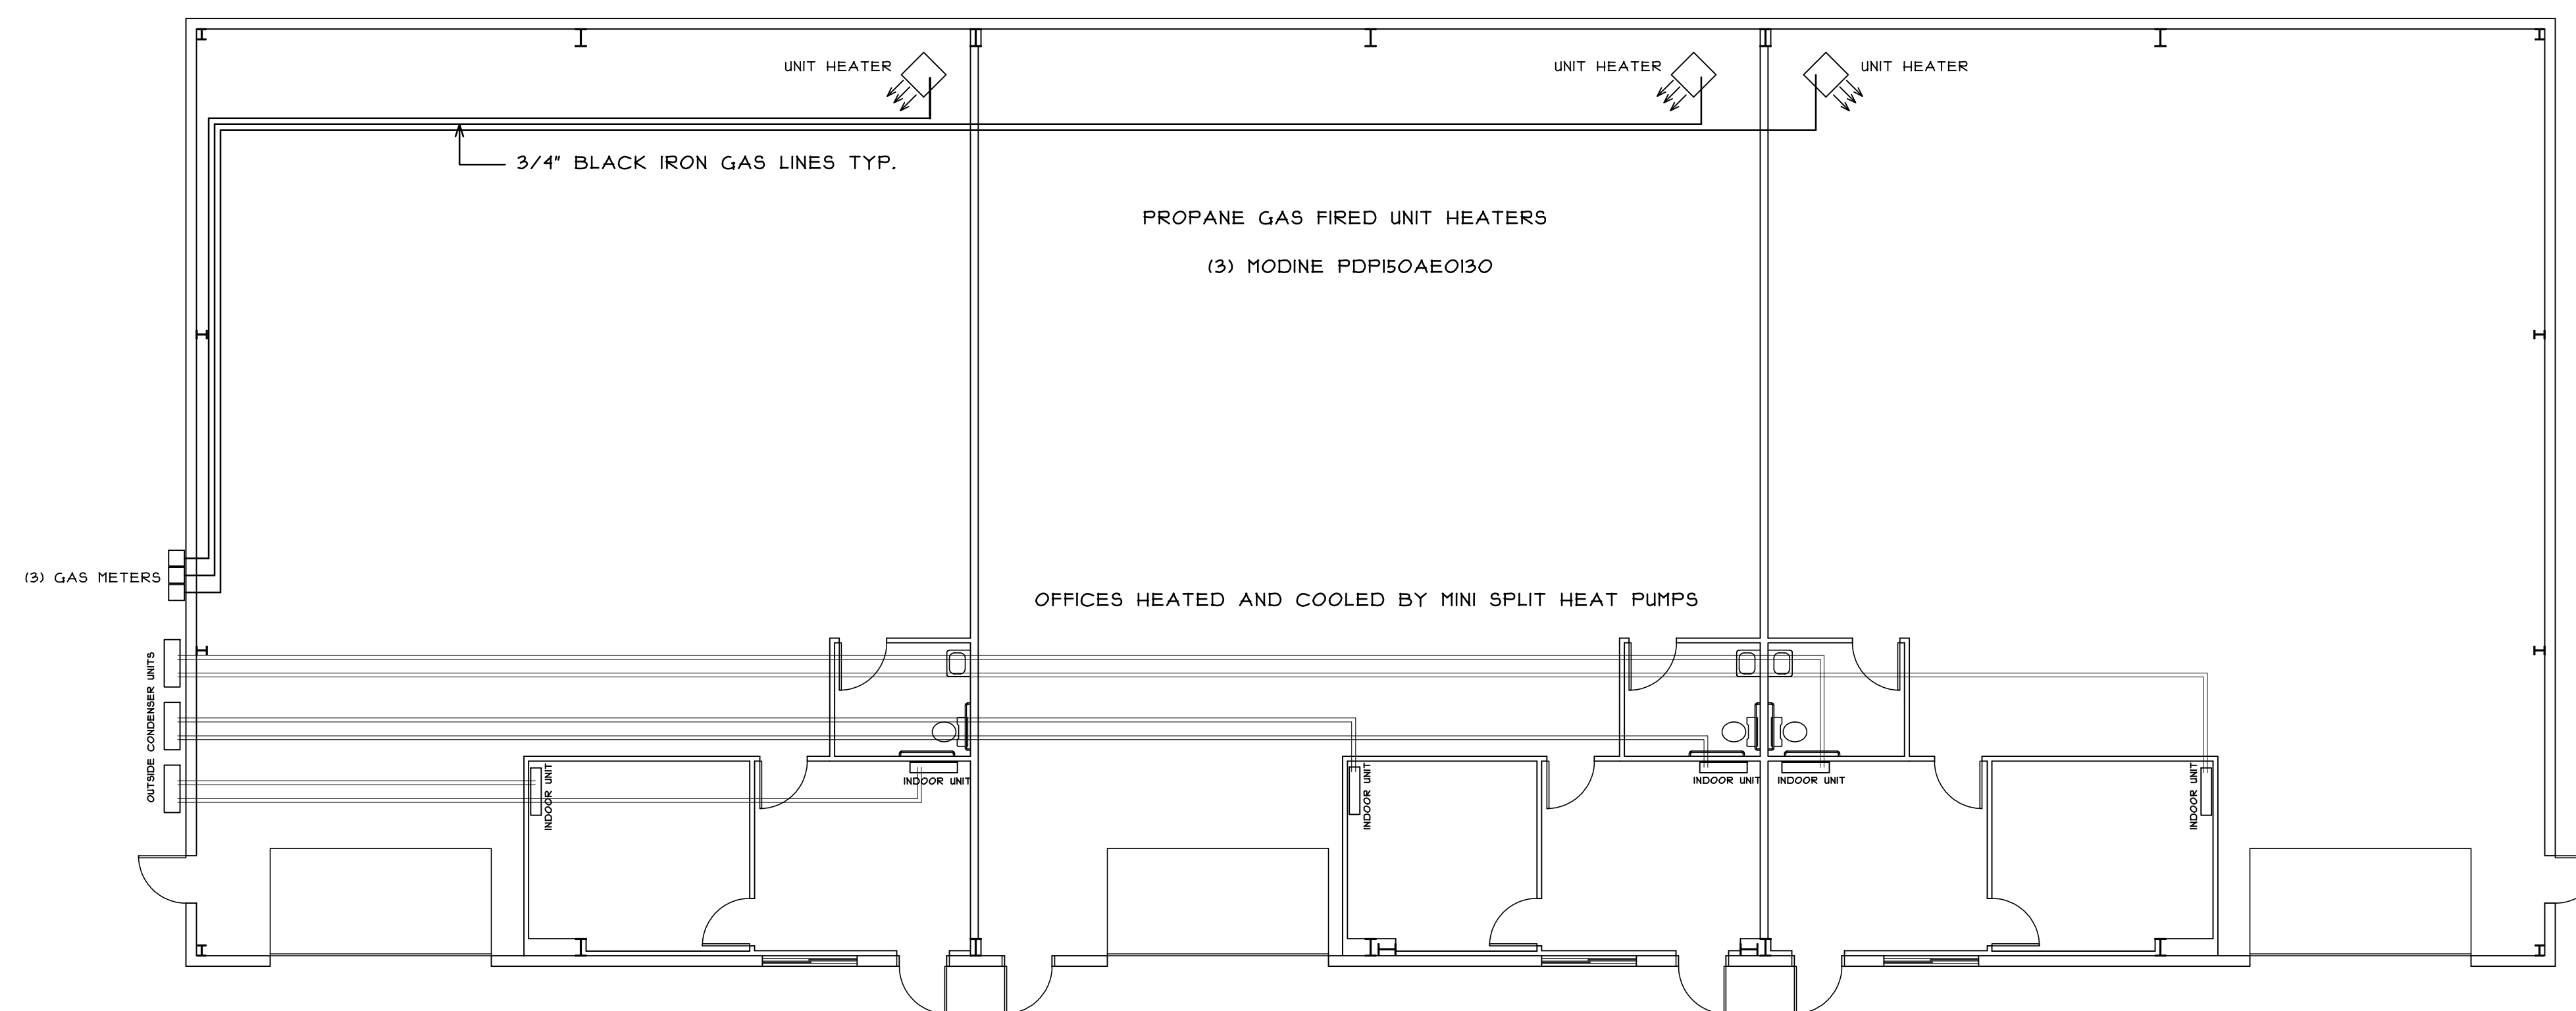

PROJECT:  
 PROPOSED BUILDING  
 320 P STREET, LLC  
 314 PRESUMSCOTT STREET  
 PORTLAND, MAINE

REVISIONS	
DATE	DESCRIPTION

DATE: 5/4/2018  
 SCALE: 1/8" = 1'-0"  
 DESIGNER: JS  
 CHECKED BY: JB

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SHEET TITLE  
 MECHANICAL  
 PLAN


SHEET NUMBER  
 M-1  
 SHEET 1 OF 1



Reviewed for Code Compliance  
 Permitting and Inspections Department  
 Approved with Conditions  
 07/23/2018



DRAINAGE LEGEND

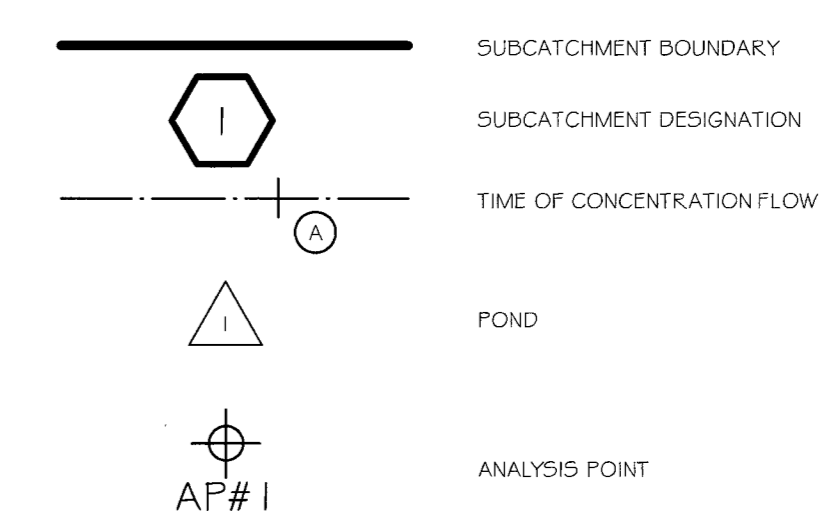


NOTES

- SOIL INFORMATION OBTAINED FROM THE FOLLOWING SOURCE:  
 1.1. SOIL SURVEY STAFF, NATURAL RESOURCES CONSERVATION SERVICE, UNITED STATES DEPARTMENT OF AGRICULTURE. WEB SOIL SURVEY. AVAILABLE ONLINE AT [HTTP://WEBSOILSURVEY.NRC.S.USDA.GOV/](http://websoilsurvey.nrcs.usda.gov/). ACCESSED JULY 22, 2016.
- CONTOURS SHOWN OUTSIDE OF THE GROUND SURVEY AREA ARE BASED ON LIDAR TOPOGRAPHIC INFORMATION OBTAINED FROM THE MAINE OFFICE OF GIS.

T<sub>c</sub> FLOW LINE DATA:

SUBCATCHMENT	SEGMENT	LENGTH	SLOPE	FLOW TYPE
SUBCATCHMENT 1.0	A-B	50'	0.035	SHEET FLOW
	B-C	70'	0.100	SHEET FLOW
SUBCATCHMENT 2.1	A-B	150'	0.067	SHEET FLOW
	B-C	240'	0.031	SHALLOW CONCENTRATED FLOW
	C-D	150'	0.110	SHALLOW CONCENTRATED FLOW
SUBCATCHMENT 2.2	SEGMENT	LENGTH	SLOPE	FLOW TYPE
DIRECT ENTRY, 5 MINUTE MINIMUM				
SUBCATCHMENT 3.1	A-B	15'	0.016	SHEET FLOW
	B-C	40'	0.125	SHEET FLOW
	C-D	140'	0.041	SHALLOW CONCENTRATED FLOW
	D-E	30'	0.540	SHALLOW CONCENTRATED FLOW
	E-F	170'	0.013	TRAPEZOIDAL CHANNEL FLOW
SUBCATCHMENT 3.2	SEGMENT	LENGTH	SLOPE	FLOW TYPE
DIRECT ENTRY, 5 MINUTE MINIMUM				
SUBCATCHMENT 3.3	SEGMENT	LENGTH	SLOPE	FLOW TYPE
DIRECT ENTRY, 5 MINUTE MINIMUM				

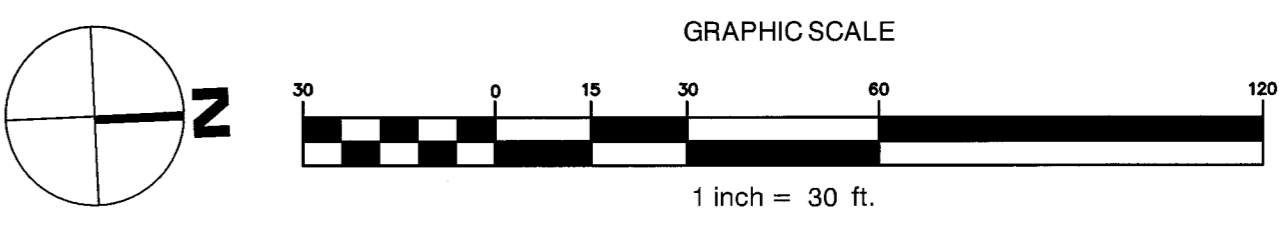

Drawn: 07/13/18 - 314 - Permitting & Inspections - Drainage / Plot Date: / Time: Mon, 5/18 / 5:10 PM

REV.	DATE	STATUS	BY	CHKD.	APPD.	REV.	DATE	STATUS	BY	CHKD.	APPD.
B	3/6/18	REVISED PER CITY COMMENTS									
A	11/21/17	SUBMITTED TO THE CITY OF PORTLAND FOR LEVEL 2 SITE PLAN REVIEW									

**WALSH**  
 ENGINEERING ASSOCIATES, INC.  
 One Karen Dr., Suite 2A | Westbrook, Maine 04092  
 ph: 207.553.9698 | www.walsh-eng.com  
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STATE OF MAINE  
 SILAS W. CANAVAN  
 No. 12639  
 3/8/18

**LAND DESIGN SOLUTIONS**  
 LAND PLANNING, SITE PLANNING & LANDSCAPE ARCHITECTURE  
 P.O. Box 316, 160 Longwoods Road, Cumberland, ME 04021 tel: (207) 434-1111  
 APPLICANT & OWNER:  
**JAKE'S DEVELOPMENT, INC.**  
 30 LEDGEWOOD DRIVE, FALMOUTH, MAINE 04105

DESIGN: PBB  
 DRAWN: DEPT.  
 CHKD: PBB  
 DATE: Nov 2017  
 SCALE: 1" = 30'

**PROPOSED INDUSTRIAL DEVELOPMENT**  
 314-316 PRESUMPCOT STREET, PORTLAND, MAINE

**POST DEVELOPMENT DRAINAGE PLAN**

PROJ. NO. J-102  
 DWG. NO. D-102

DATE OF APPROVAL: 07/23/2018  
 PLANNER: Christian Rodman

CITY OF PORTLAND  
 115 APPROVED SITE PLAN  
 Submitted: 07/23/2018  
 Date of Approval: 07/23/2018  
 Conditions





Reviewed for Code Compliance  
Permitting and Inspections Department  
Approved with Conditions  
07/23/2018




**DRAINAGE LEGEND**

	SUBCATCHMENT BOUNDARY
	SUBCATCHMENT DESIGNATION
	TIME OF CONCENTRATION FLOW
	ANALYSIS POINT

**T<sub>c</sub> FLOW LINE DATA:**

SUBCATCHMENT	SEGMENT	LENGTH	SLOPE	FLOW TYPE
SUBCATCHMENT 1.0	A-B	50'	0.035	SHEET FLOW
	B-C	70'	0.070	SHEET FLOW
SUBCATCHMENT 2.0	A-B	150'	0.067	SHEET FLOW
	B-C	240'	0.031	SHALLOW CONCENTRATED FLOW
	C-D	150'	0.097	SHALLOW CONCENTRATED FLOW
SUBCATCHMENT 3.0	A-B	15'	0.016	SHEET FLOW
	B-C	40'	0.125	SHEET FLOW
	C-D	150'	0.040	SHALLOW CONCENTRATED FLOW
	D-E	120'	0.023	TRAPEZOIDAL CHANNEL FLOW
	E-F	35'	0.400	SHALLOW CONCENTRATED FLOW
	F-G	40'	0.050	TRAPEZOIDAL CHANNEL FLOW

- NOTES**
- SOIL INFORMATION OBTAINED FROM THE FOLLOWING SOURCE:
    - SOIL SURVEY STAFF, NATURAL RESOURCES CONSERVATION SERVICE, UNITED STATES DEPARTMENT OF AGRICULTURE. WEB SOIL SURVEY. AVAILABLE ONLINE AT [HTTP://WEBSOILSURVEY.NRCS.USDA.GOV](http://websoilsurvey.nrcs.usda.gov). ACCESSED JULY 22, 2016.
  - CONTOURS SHOWN OUTSIDE OF THE GROUND SURVEY AREA ARE BASED ON LIDAR TOPOGRAPHIC INFORMATION OBTAINED FROM THE MAINE OFFICE OF GIS.

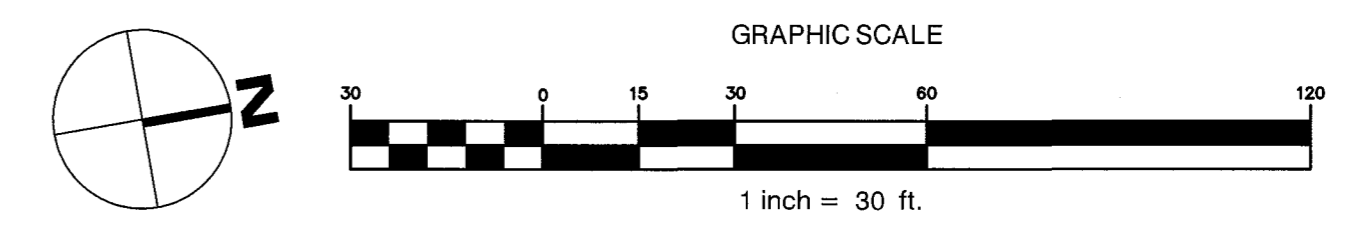

Drawing Name: P-1018 - 314 Presumpscot St, Portland, ME 04108 - Design [Plan Date: 7/18/18] / Title: 5/18 / 5:10 PM

REV.	DATE	STATUS	BY	CHKD.	APPD.	REV.	DATE	STATUS	BY	CHKD.	APPD.
B	3/6/18	REVISED PER CITY COMMENTS									
A	11/21/17	SUBMITTED TO THE CITY OF PORTLAND FOR LEVEL 2 SITE PLAN REVIEW									

**WALSH**  
ENGINEERING ASSOCIATES, INC.  
One Karen Dr., Suite 2A | Westbrook, Maine 04092  
ph: 207.553.9898 | www.walsh-eng.com  
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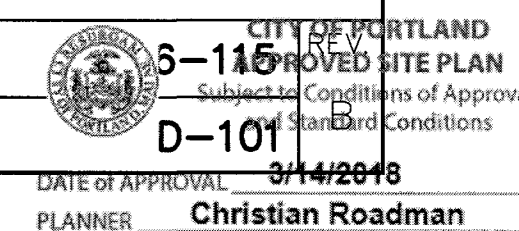
**LAND DESIGN SOLUTIONS**  
LAND PLANNING, SITE PLANNING & LANDSCAPE ARCHITECTURE  
P.O. Box 316, 160 Longwoods Road, Cumberland, ME 04021 tel: (207) 934-1717  
APPLICANT & OWNER:  
**JAKE'S DEVELOPMENT, INC.**  
30 LEDGEWOOD DRIVE, FALMOUTH, MAINE 04105

DESIGN: PBB
DRAWN: DEPT.
CHKD: PBB
DATE: Jun 2017
SCALE: 1"=30'

**PROPOSED INDUSTRIAL DEVELOPMENT**  
314-316 PRESUMPSCOT STREET, PORTLAND, MAINE

**PRE DEVELOPMENT DRAINAGE PLAN**

DATE OF APPROVAL: 7/14/2018  
PLANNER: Christian Roadman



SPlice BOLT TABLE							
Mark	Qty	Top	Bot	Int	Type	Dia	Length
SP-1	4	4	2	2	A325	7/8"	2 1/2"
SP-2	2	4	2	2	A325	3/4"	2"

FLANGE BRACE TABLE			
ID	MARK	LENGTH	SIDES
1	FB44.5A	3'-8 1/2"	2
2	FB57.4A	4'-9 3/8"	2
3	FB41.5A	3'-5 1/2"	1
4	FB28.9B	3'-4 7/8"	1
5	FB41.6A	3'-5 5/8"	1
6	FB27.5A	3'-9 1/2"	1
7	FB43.1A	3'-7 1/8"	1
8	FB46.5A	3'-10 1/2"	2


FBxA - 1-1/2"x1-1/2"x1/8"  
 FBxB - 2"x2"x1/8"  
 FBxC - 2-1/2"x2-1/2"x3/16"

Mark	Weight	Web Depth		Web Plate		Outside Flange			Inside Flange		
		Start/End	Thick	Length	Length	W x Thk x Length	W x Thk x Length	W x Thk x Length	W x Thk x Length		
RF1-1	904	10.5/29.1	0.188	168.0	6 x 5/16" x 262.3	6 x 1/2" x 222.1					
RF1-2	976	29.1/35.0	0.313	95.0	6 x 1/2" x 43.3						
		38.0/19.0	0.250	195.6	6 x 5/16" x 314.8	6 x 5/16" x 196.5					
RF1-3	1002	19.0/28.0	0.188	120.0							
		28.0/19.0	0.188	120.0	6 x 5/16" x 314.2	6 x 5/16" x 120.3					
RF1-4	1179	19.0/37.0	0.250	194.2							
		36.0/30.0	0.313	96.9	8 x 1/2" x 44.3	6 x 3/8" x 194.2					
		30.0/10.5	0.188	180.0	8 x 5/16" x 277.0	8 x 5/8" x 236.2					




Reviewed for Code Compliance  
 Permitting and Inspections Department  
 Approved with Conditions


07/23/2018

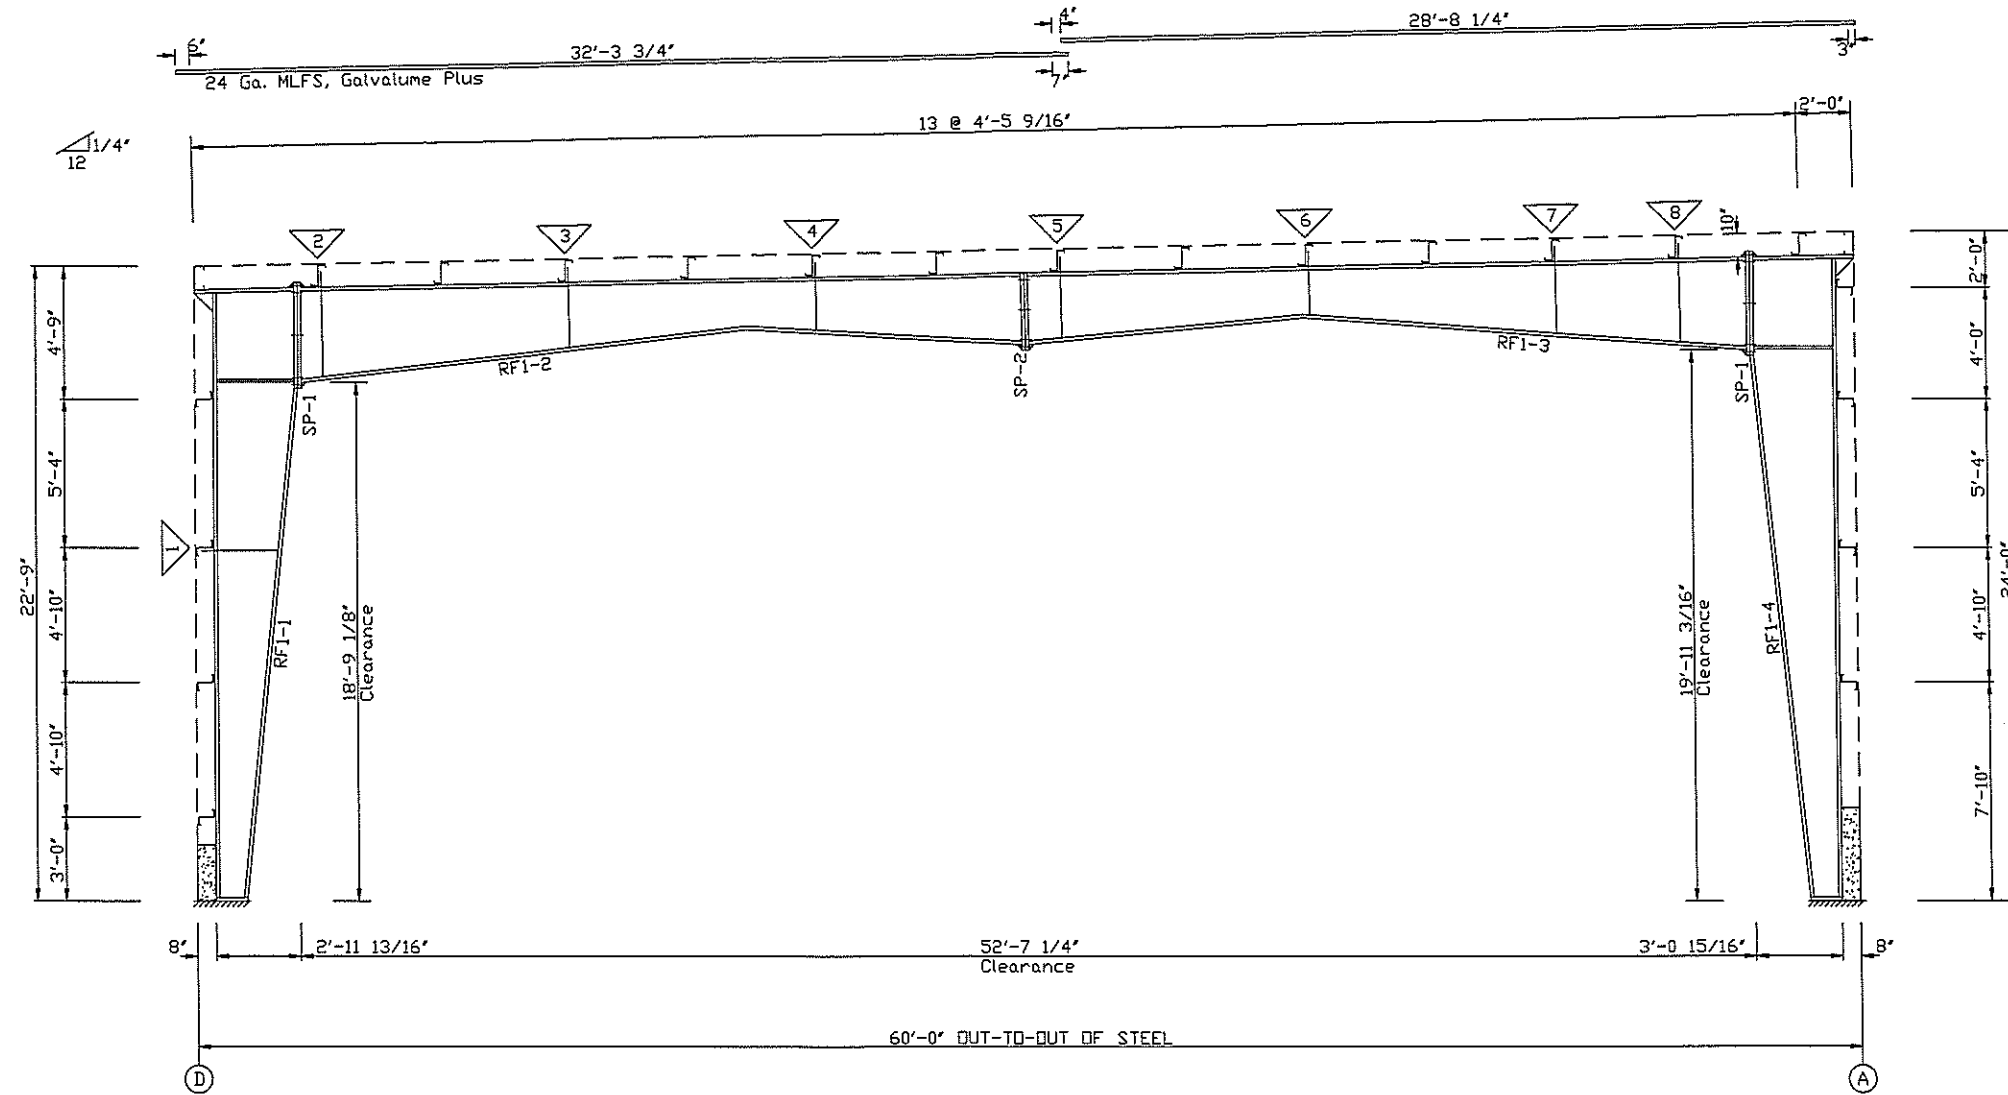

FRAME CROSS SECTION: FRAME LINE 2 3 4 5 6

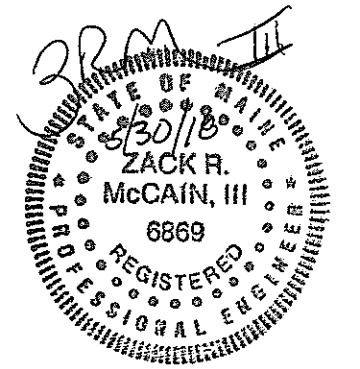


REV.	DESCRIPTION:	DATE:	DRAFT	ENG.
3				
2				
1				
PRELIMINARY DRAWING: NOT FOR CONSTRUCTION / FOR PERMIT ONLY				CURRENT REVISION: 0
PACKAGE STEEL SYSTEMS, INC.		Biskup Construction Inc.		
PROJECT	320 P Street LLC	RIGID FRAME X-SECTION		
ID	1805-076	DESIGN: ZRM	DESIGN CHECK:	
PROJECT	314 Presumpscott St.	DRAFT: TMZ	DRAFT CHECK:	
ADDRESS	Portland, ME 04103	DATE: 5/30/18	DRAWING: FRXS-1	

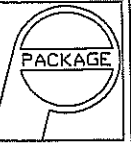




Reviewed for Code Compliance  
 Permitting and Inspections Department  
 Approved with Conditions  
 07/23/2018

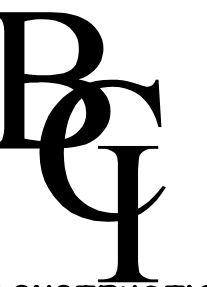

BISKUP CONSTRUCTION, INC.  
 16 DANIELLE DRIVE  
 WINDHAM, MAINE 04062  
 TEL. (207) 892-9800  
 FAX. (207) 892-9895

WWW.BISKUPCONSTRUCTION.COM

STAMP

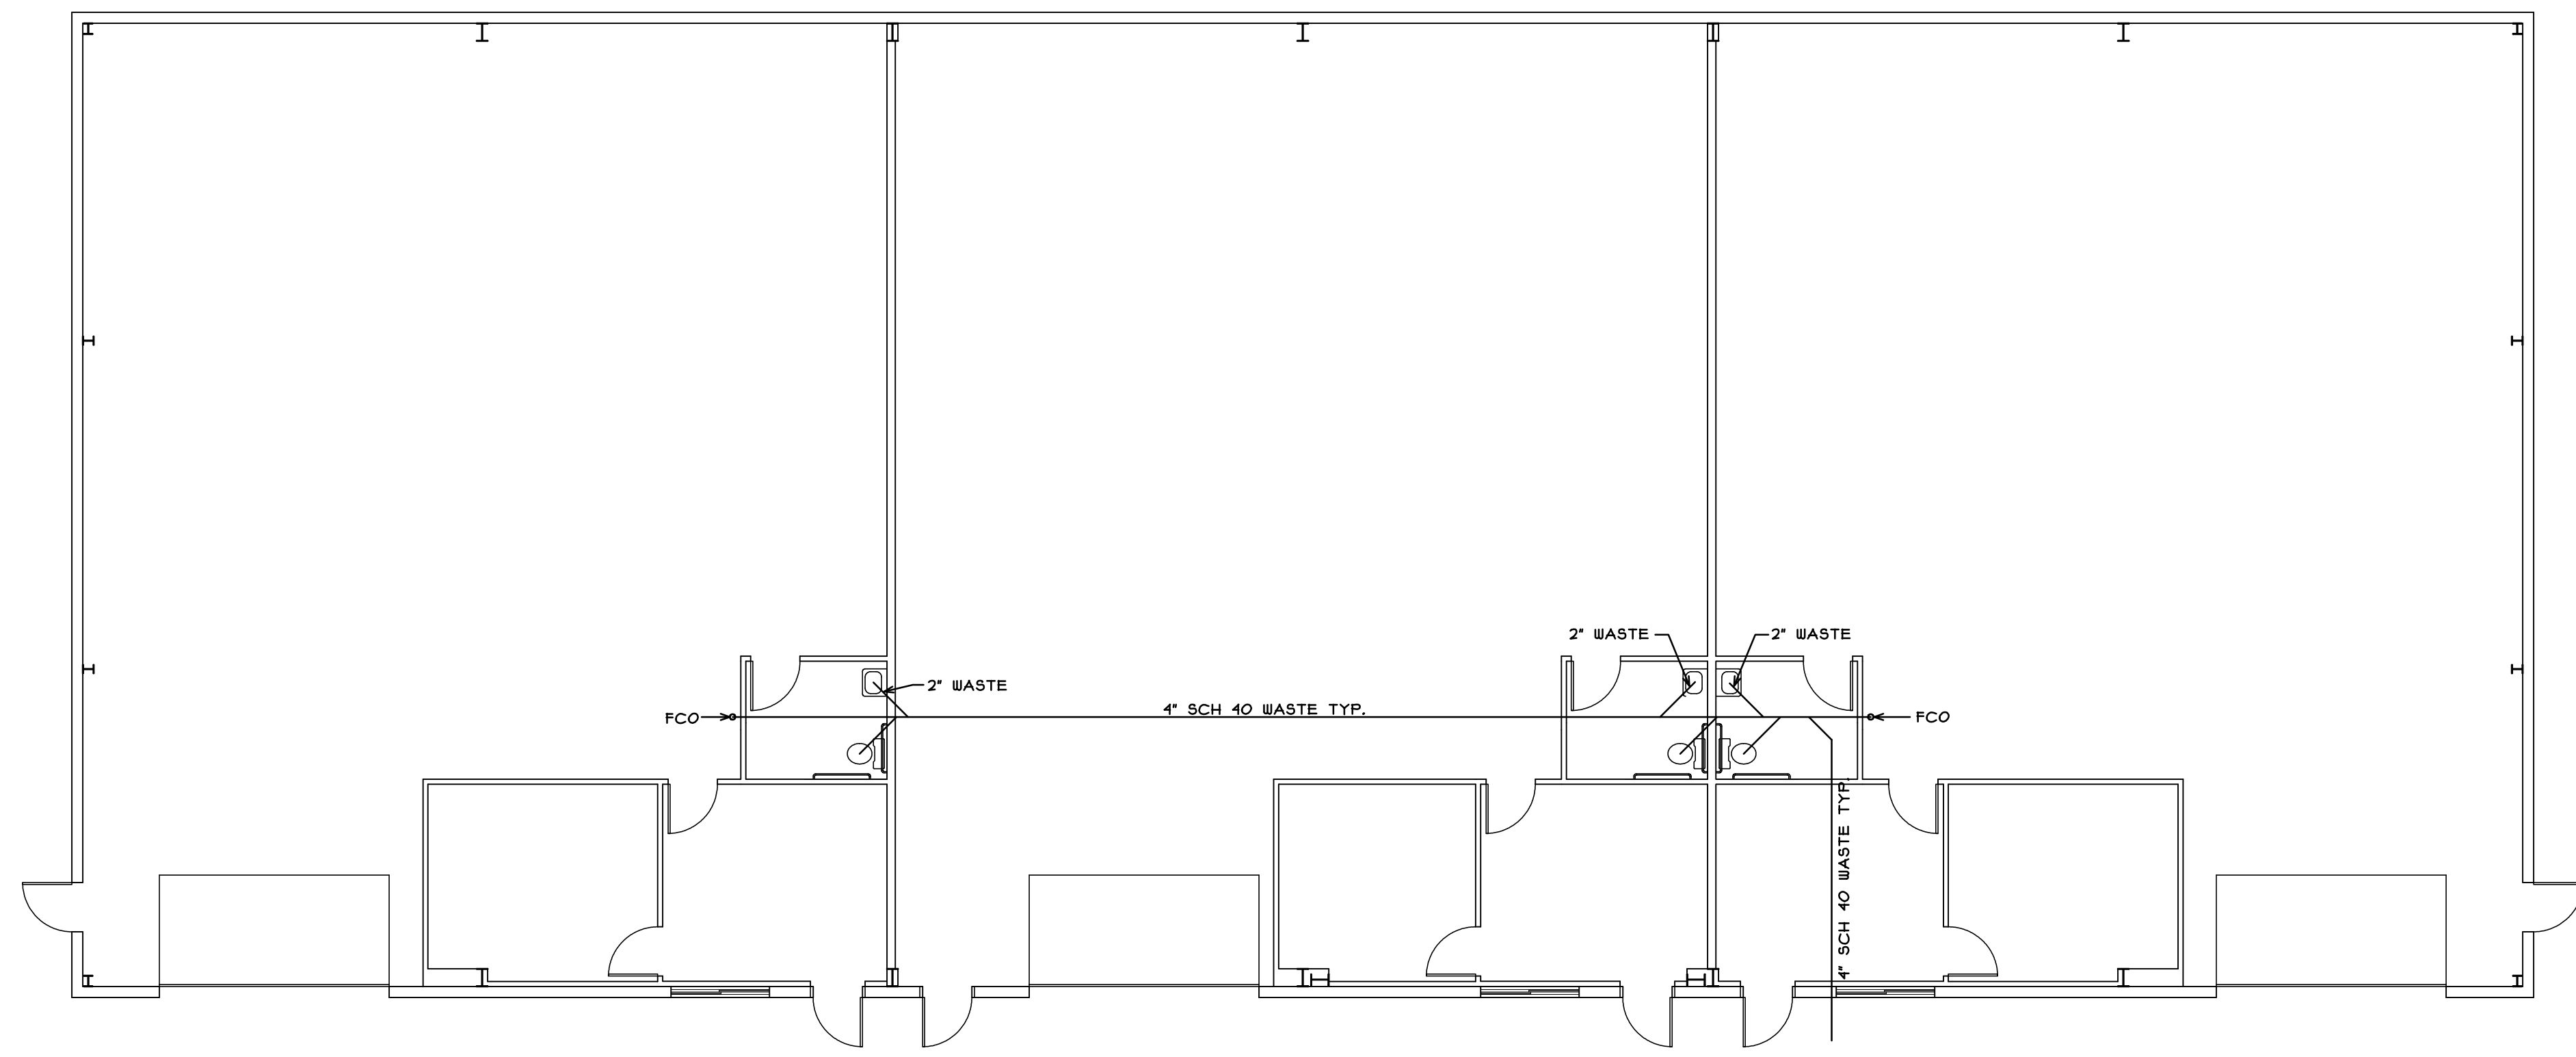

PROJECT:  
 PROPOSED BUILDING  
 320 P STREET, LLC  
 314 PRESUMPCOTT STREET  
 PORTLAND, MAINE

REVISIONS	
DATE	DESCRIPTION

DATE: 5/4/2018  
 SCALE: 1/8" = 1'-0"  
 DESIGNER: JS  
 CHECKED BY: JB  
 © COPYRIGHT  
 BISKUP CONSTRUCTION, INC.

SHEET TITLE  
 SANITARY  
 WASTE  
 PLAN

SHEET NUMBER  
 P-1  
 SHEET 1 OF 2



Reviewed for Code Compliance  
Permitting and Inspections Department  
Approved with Conditions  
07/23/2018

DOOR SCHEDULE

TAG	DOOR SLAB	SIZE	THICKNESS	SWING	FIRE LABEL	FRAME	WALL THICKNESS	REMARKS
1	HM	3010	1 3/4	LHR		HM 4 1/8	24 X 30 INS. GLASS	HRDWR SET #1
2	HM	3010	1 3/4	RHR		HM 4 1/8	24 X 30 INS. GLASS	HRDWR SET #1
3	HM	3010	1 3/4	LHR		HM 4 1/8	24 X 30 INS. GLASS	HRDWR SET #1
4	HM	3010	1 3/4	RHR		HM 4 1/8	24 X 30 INS. GLASS	HRDWR SET #1
5	HM	3010	1 3/4	LHR		HM 4 1/8	24 X 30 INS. GLASS	HRDWR SET #1
6	HM	3010	1 3/4	RHR		HM 4 1/8	24 X 30 INS. GLASS	HRDWR SET #1
7	HM	3010	1 3/4	LH		HM 4 1/8		HRDWR SET #2
8	HM	3010	1 3/4	RH		HM 4 1/8		HRDWR SET #2
9	HM	3010	1 3/4	RH		HM 4 1/8		HRDWR SET #2
10	HM	3010	1 3/4	LH		HM 4 3/4		HRDWR SET #3
11	HM	3010	1 3/4	RH		HM 4 3/4		HRDWR SET #3
12	HM	3010	1 3/4	LH		HM 4 3/4		HRDWR SET #3
13	HM	3010	1 3/4	RH		HM 4 3/4		HRDWR SET #3
14	HM	3010	1 3/4	LH		HM 4 3/4		HRDWR SET #3
145	HM	3010	1 3/4	RH		HM 4 3/4		HRDWR SET #3


HARDWARE SCHEDULE

SET #1	HINGES, CLOSER, LOCKSET, WEATHERSTRIP, THRESHOLD
SET #2	HINGES, PRIVACY SET
SET #3	HINGES, PASSAGE SET

NOTE: ALL LOCKS TO BE MASTER KEYED


WINDOW SCHEDULE

TAG	SIZE	TYPE	MANUFACTURER	GLAZING	"U" VALUE	SHGC	REMARKS
A	12" X 48"	SLIDER	MARVIN INTEGRITY	LOW "E" WITH ARGON	0.31	0.33	

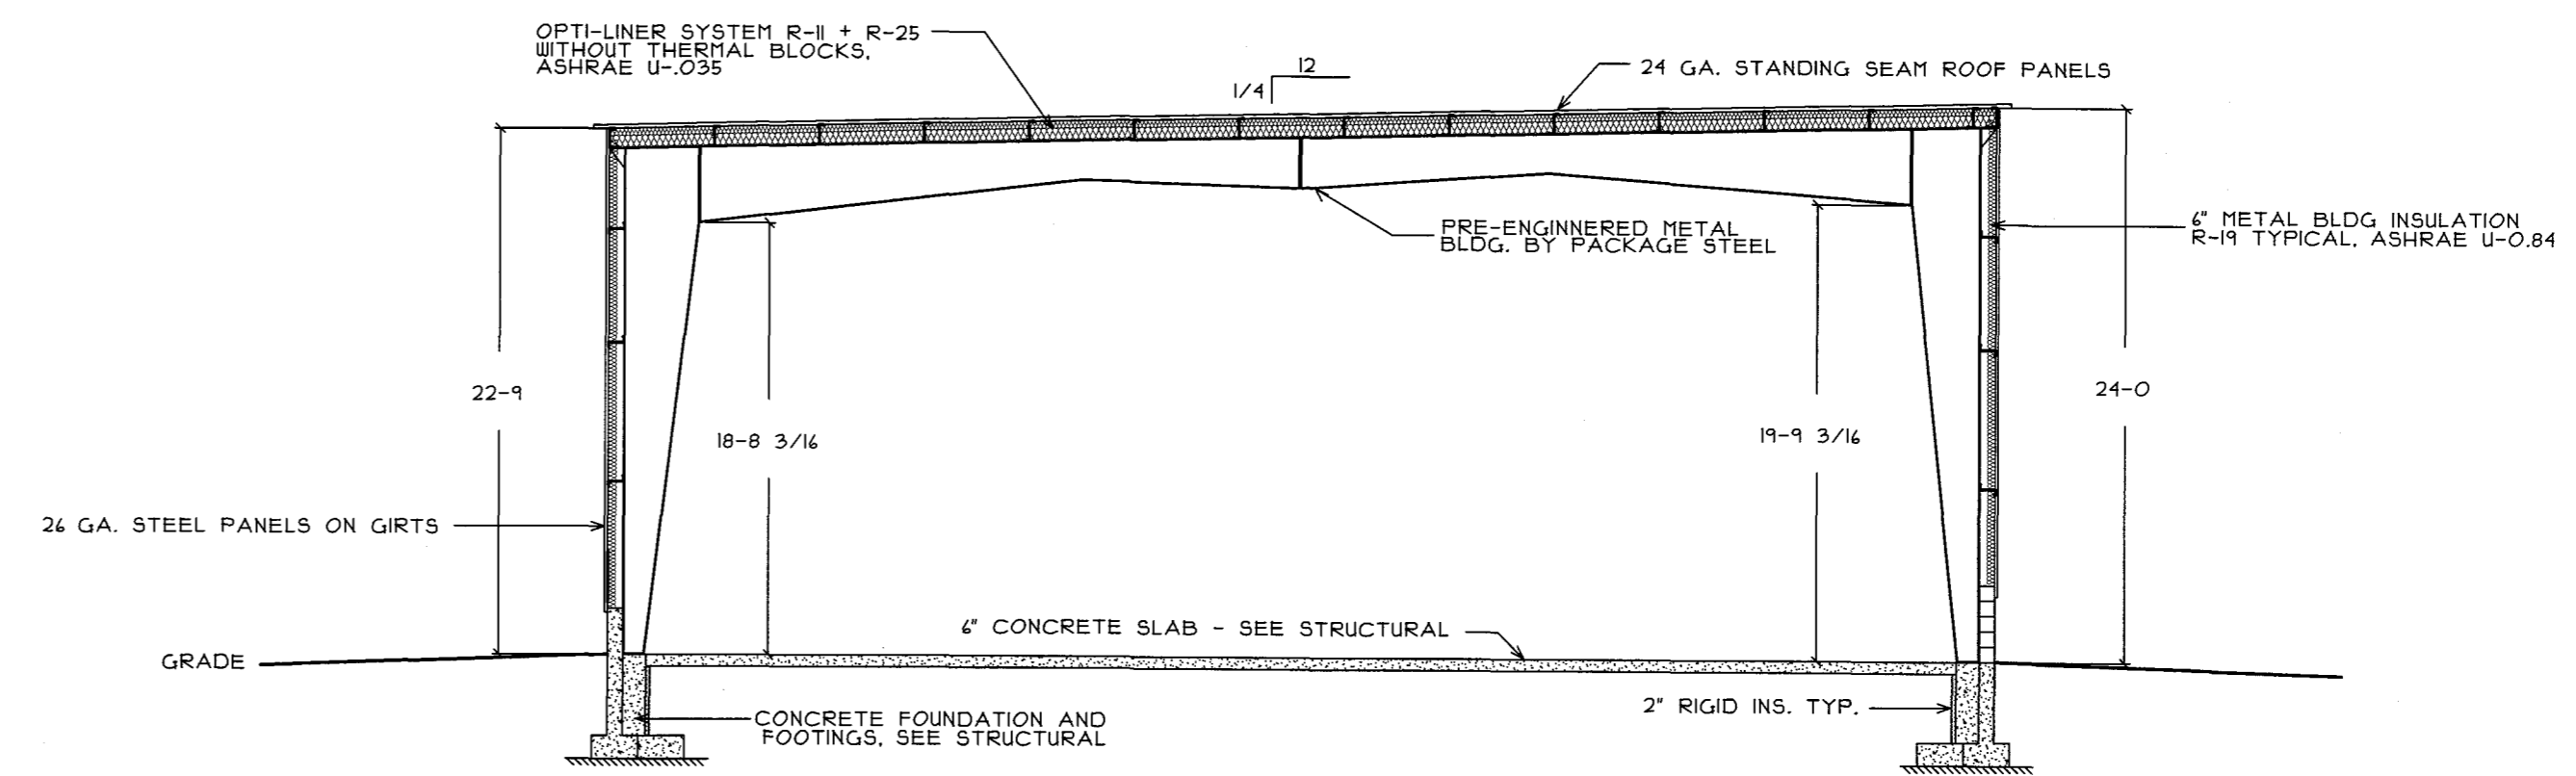

BUILDING SECTION


SCALE: 1/8" = 1'-0"

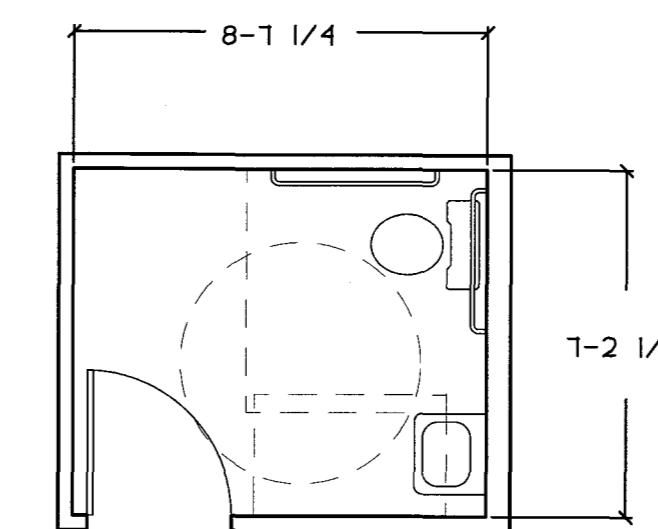

ENLARGED PLAN BATHROOM


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NOTE:  
PROVIDE SOLID WOOD BLOCKING IN WALL FOR MOUNTING OF ALL WALL MOUNTED ITEMS

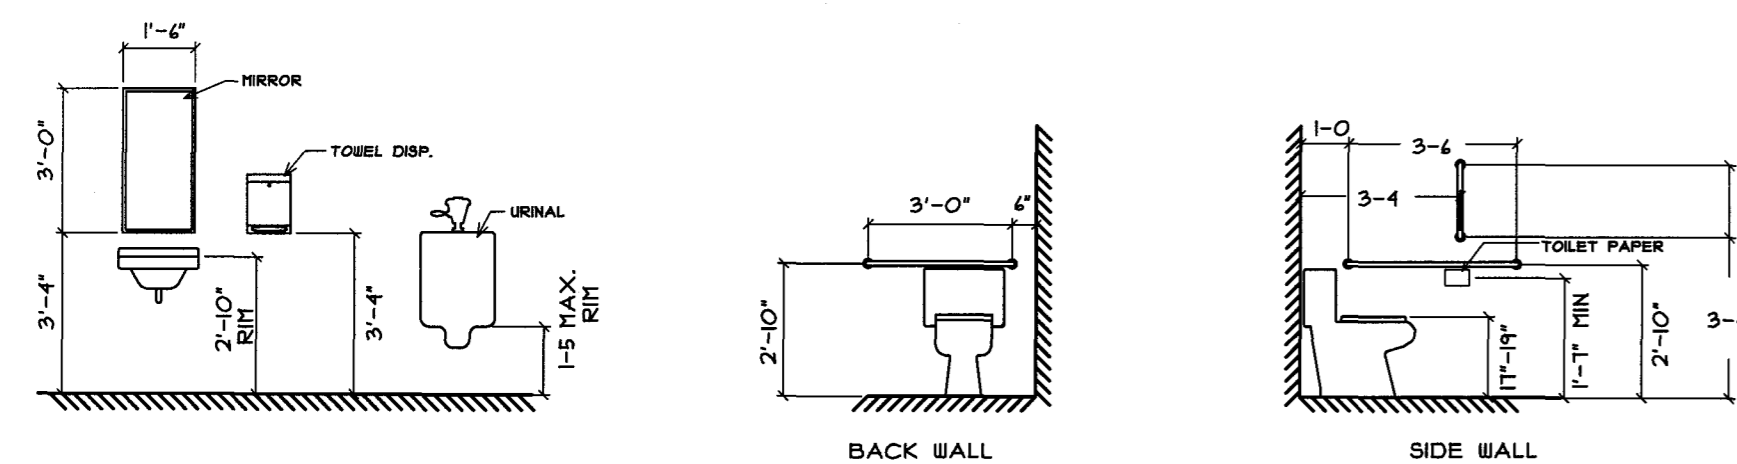


TOILET FIXTURE MOUNTING HEIGHTS

SCALE 1/4" = 1'-0"

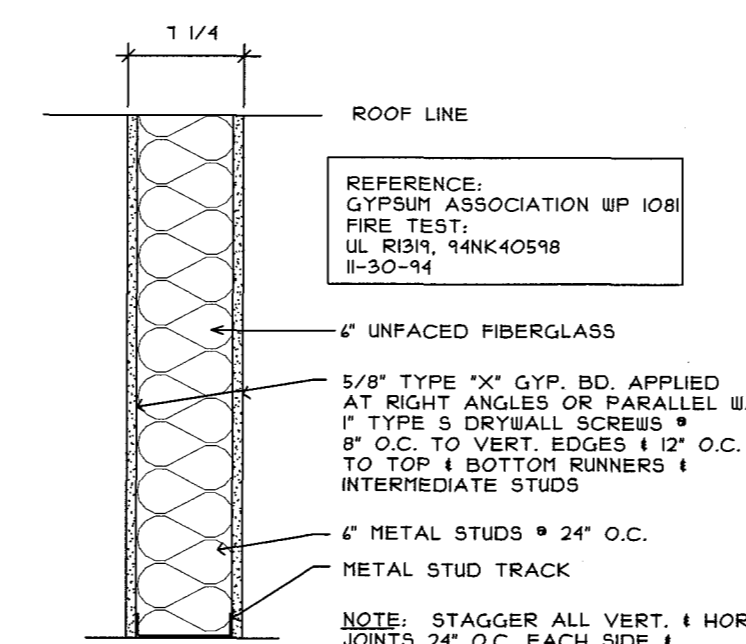

1 HR. PARTITION UL DESIGN: U465

SCALE: 1/4" = 1'-0"


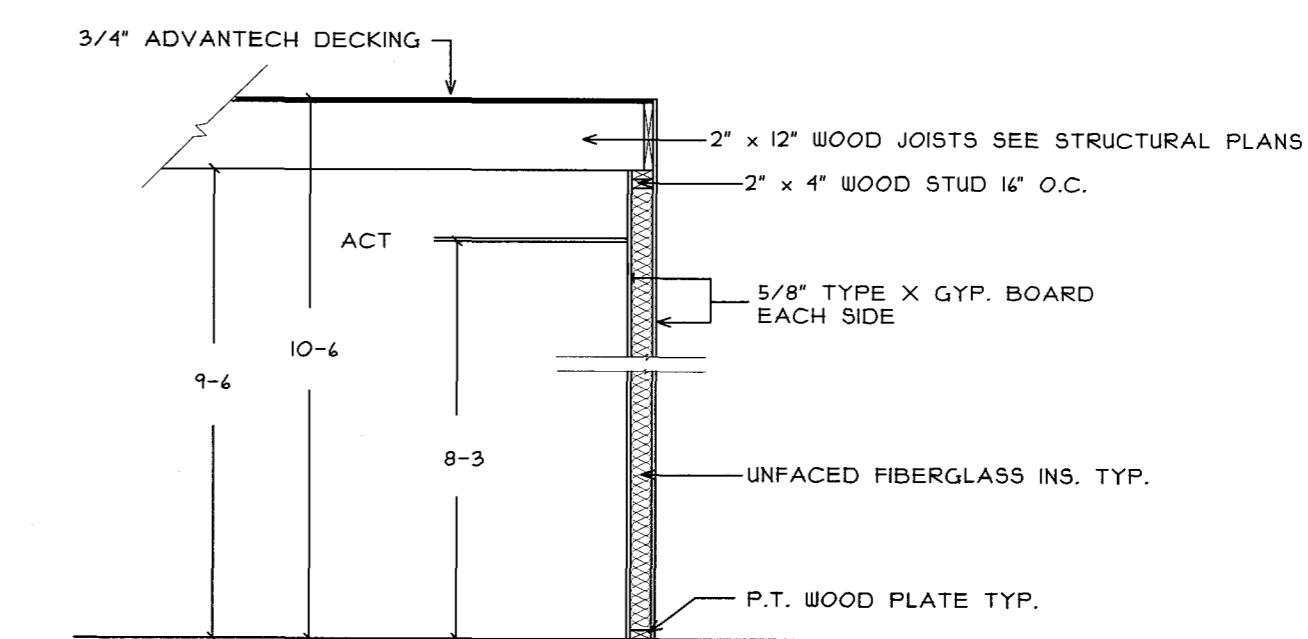


NON RATED WALL & DECK TYP. U.N.O.

SCALE: 3/8" = 1'-0"

**BQ**  
BISKUP CONSTRUCTION, INC.  
16 DANIELLE DRIVE  
WINDHAM, MAINE 04092  
TEL. (207) 892-9800  
FAX. (207) 892-9895

WWW.BISKUPCONSTRUCTION.COM

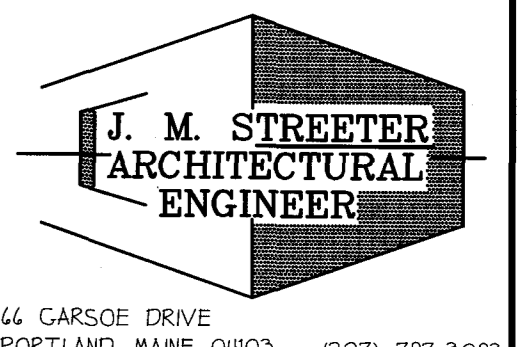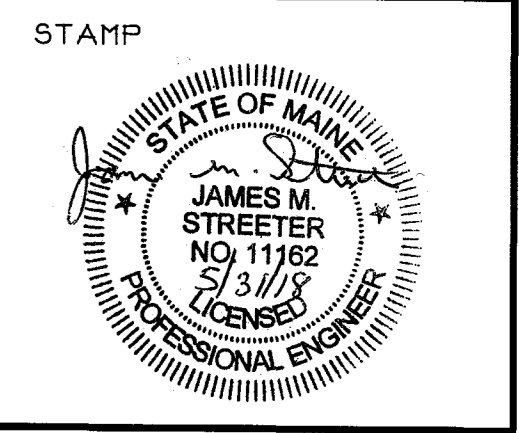

44 CARSOE DRIVE  
PORTLAND, MAINE 04103 (207) 797-3093

PROJECT:  
PROPOSED BUILDING  
320 P STREET, LLC  
314 PRESUMPSCOT STREET  
PORTLAND, MAINE

REVISIONS

DATE	DESCRIPTION

DATE: 5/30/2018  
SCALE: 1/8" = 1'-0"  
DESIGNER: JS  
CHECKED BY: JB  
© COPYRIGHT  
BISKUP CONSTRUCTION, INC.

SHEET TITLE  
SCHEDULES  
&  
DETAILS




SHEET NUMBER  
A-4  
SHEET 4 OF 5

N/F  
FACTORS FINANCIAL FRC, INC  
13479/179

N/F  
OCEAN WOODS  
CONDOMINIUMS 8584/75

GENERAL PROJECT NOTES:

1. THE PROPERTY OWNER OF RECORD IS:  
JAKE'S DEVELOPMENT, INC.  
30 LEDGEWOOD DRIVE  
FALMOUTH, ME 04105
2. TAX ASSESSORS REFERENCE: 423-A-33, 20, 13 & 12
3. BOUNDARY SURVEY WAS PROVIDED BY:  
CULLENBERG LAND SURVEYING  
892 OLD DANVILLE ROAD  
AUBURN, ME 04210
4. TOPOGRAPHIC AND OTHER EXISTING CONDITIONS INFORMATION WAS PROVIDED BY CULLENBERG LAND SURVEYING, AERIAL MAPPING AND IN THE FIELD OBSERVATIONS BY THE DESIGN TEAM.
5. PRIOR TO THE START OF ANY EXCAVATION FOR THE PROJECT, BOTH ON-SITE AND OFF-SITE, THE CONTRACTOR SHALL NOTIFY DIGSAFE AND BE PROVIDED WITH A DIGSAFE NUMBER INDICATING THAT ALL EXISTING UTILITIES HAVE BEEN LOCATED AND CLEARLY MARKED.
6. CONTRACTOR SHALL THOROUGHLY FAMILIARIZE THEMSELVES WITH ALL DRAWINGS AND SITE CONDITIONS PRIOR TO BIDDING AND PRIOR TO CONSTRUCTION.
7. IT IS THE CONTRACTORS RESPONSIBILITY TO FAMILIARIZE THEMSELVES WITH THE CONDITIONS OF ALL PERMITS AND APPROVALS AND CONDUCT THE WORK IN ACCORDANCE WITH THESE PERMITS AND APPROVALS. THE CONTRACTOR SHALL OBTAIN AND PAY FOR ALL ADDITIONAL PERMITS, STREET OPENINGS, NOTICES AND FEES NECESSARY TO COMPLETE THE WORK.
8. ANY DISCREPANCIES BETWEEN DRAWINGS AND SITE CONDITIONS AS WELL AS MANUFACTURER'S RECOMMENDATIONS SHALL BE REPORTED IMMEDIATELY TO THE OWNER'S REPRESENTATIVE FOR CLARIFICATION AND RESOLUTION PRIOR TO BIDDING OR CONSTRUCTION.
9. CONTRACTOR SHALL BE SOLELY RESPONSIBLE FOR ALL MEANS, METHODS AND TECHNIQUES EMPLOYED TO PERFORM WORK SHOWN ON THESE PLANS. ALL WORK SHALL CONFORM TO THE CURRENT CITY OF PORTLAND TECHNICAL STANDARDS AND DETAILS.
10. THE CONTRACTOR SHALL LIMIT THE CONSTRUCTION ACTIVITY TO THE LIMITS SHOWN ON THE PLANS, UNLESS OTHERWISE AUTHORIZED BY THE OWNERS REPRESENTATIVE.
11. THE CONTRACTOR SHALL INSTALL TEMPORARY EROSION CONTROL MEASURES PRIOR TO STARTING CONSTRUCTION. SEE DRAWINGS C-102 AND C-200 FOR EROSION CONTROL MEASURES.

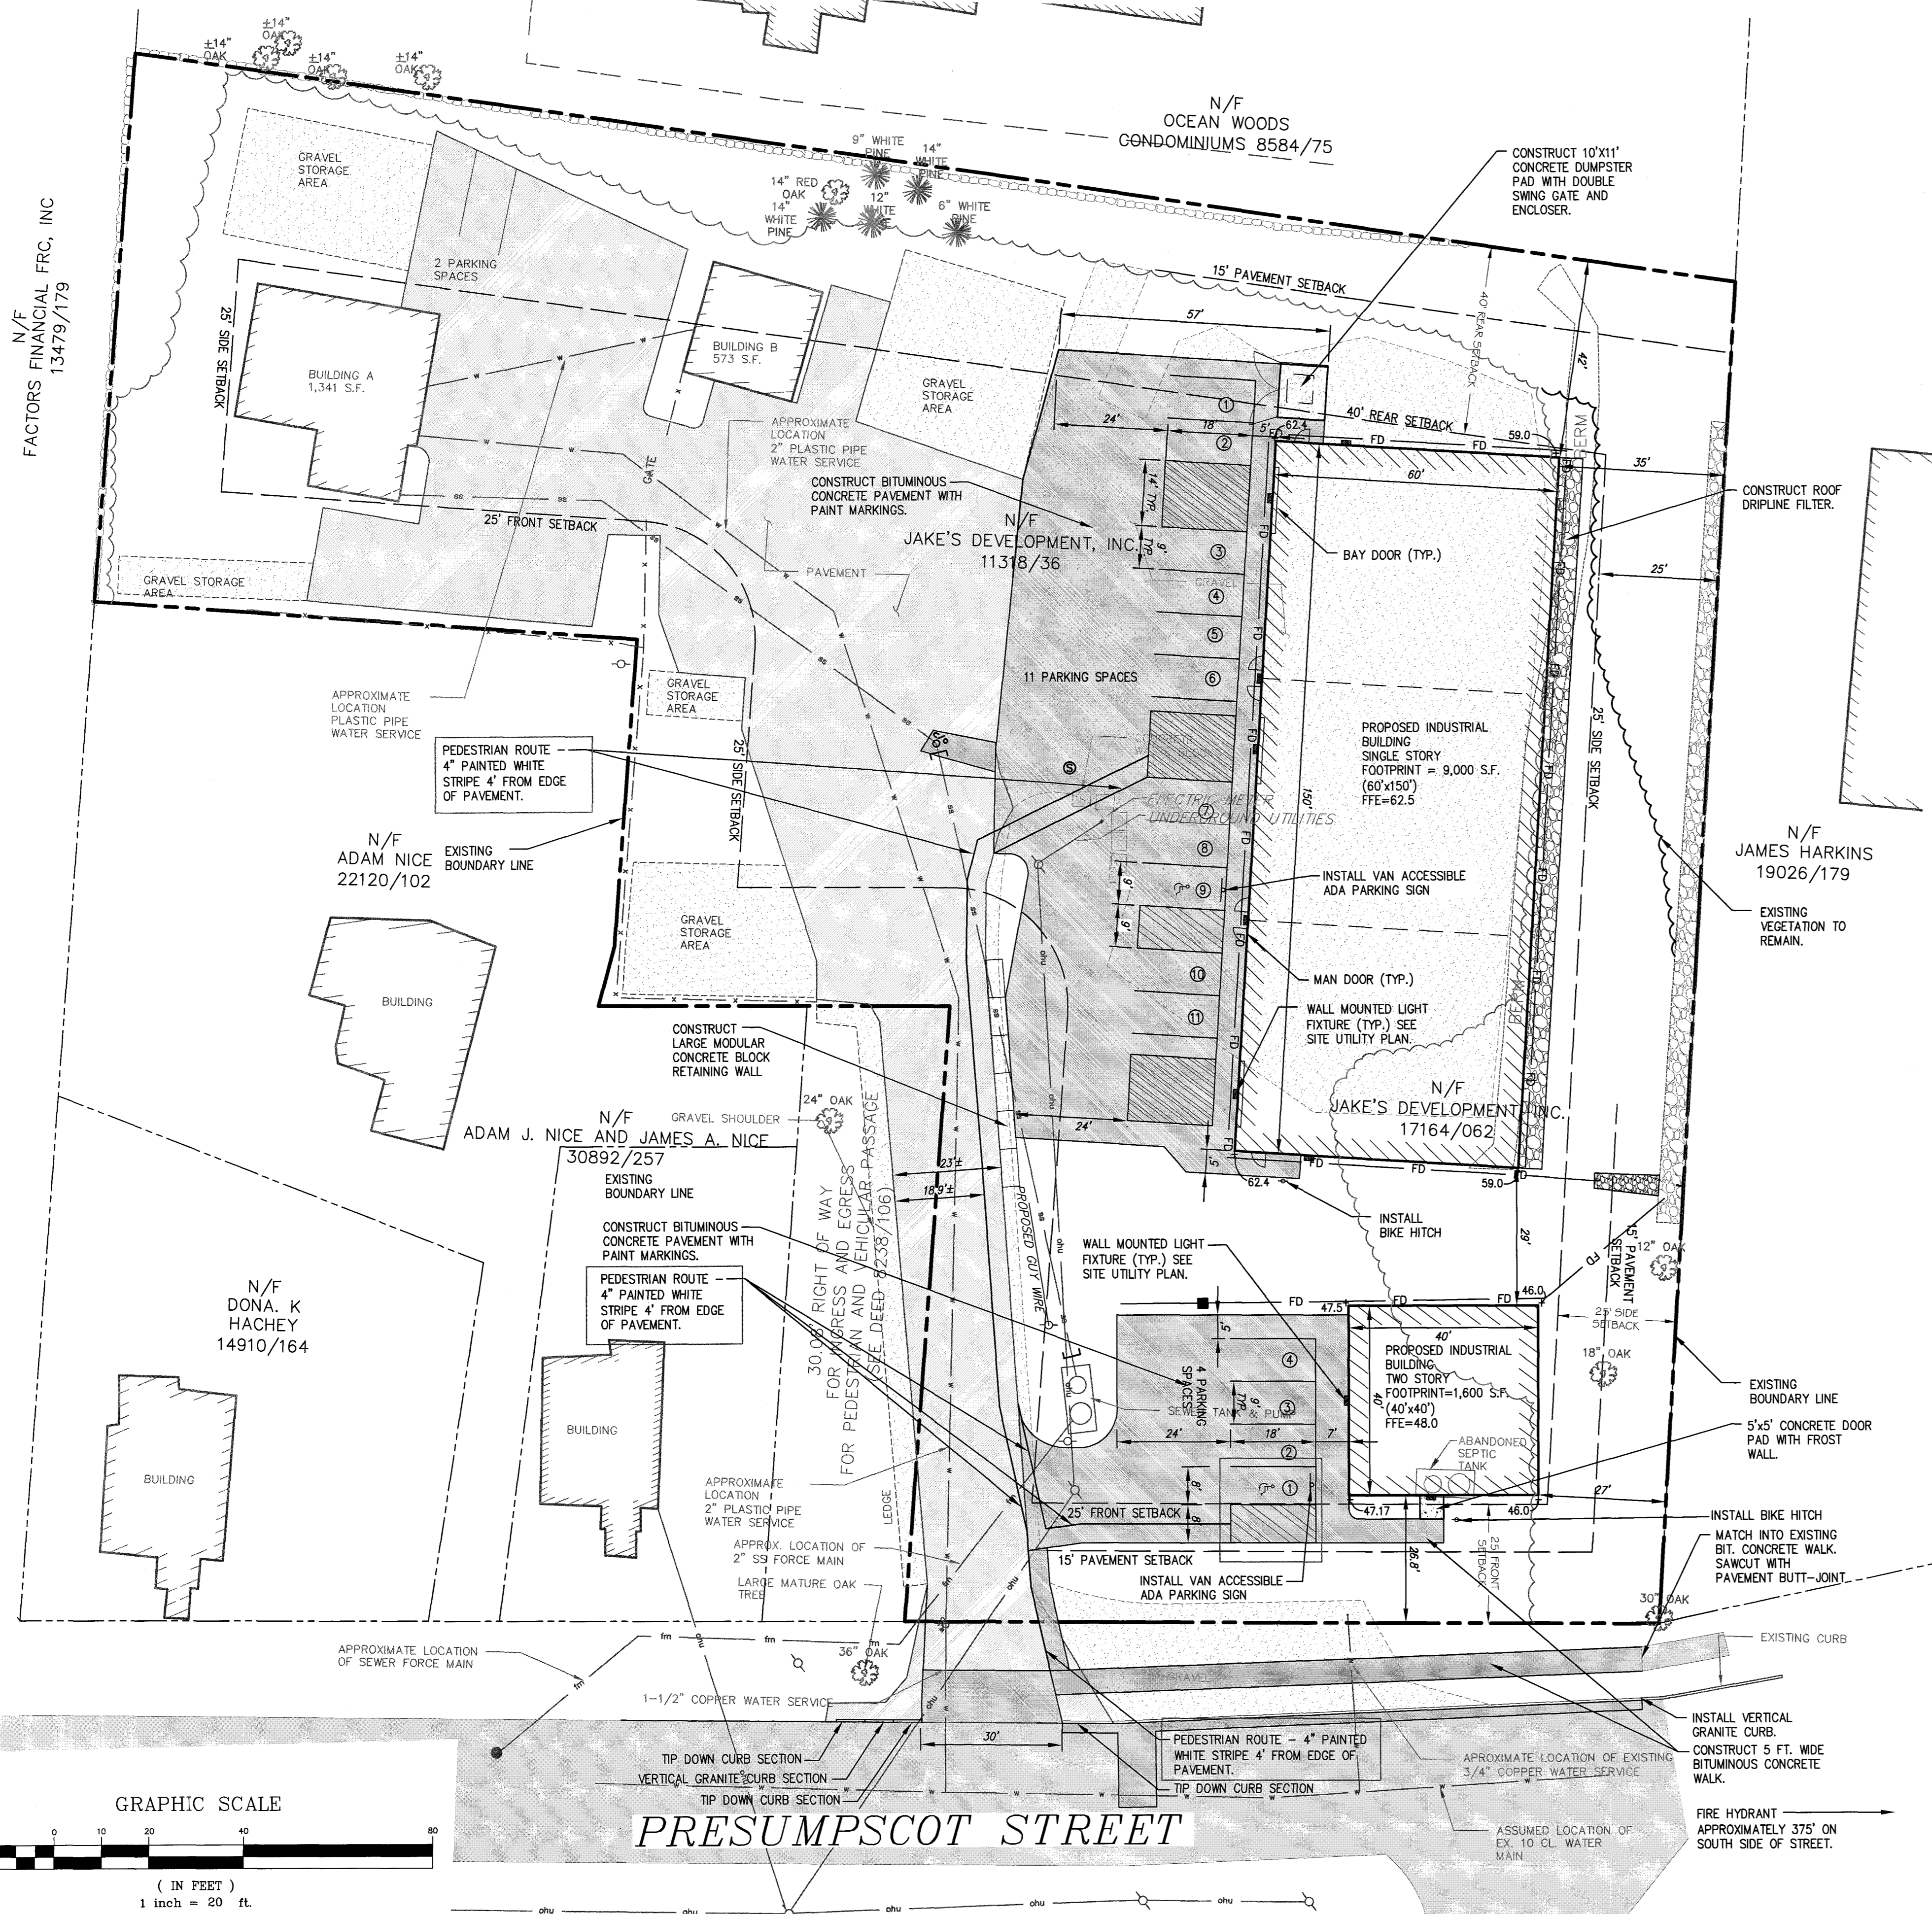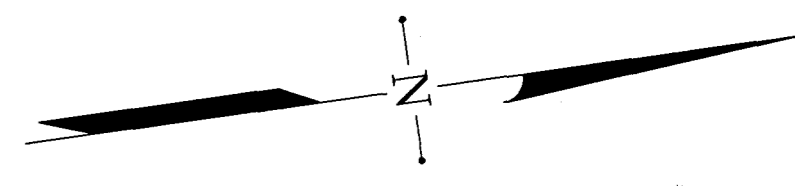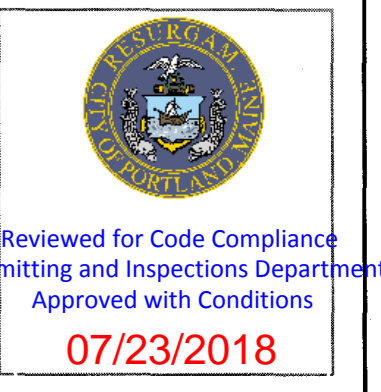

ZONING SUMMARY:

ZONE: IL - INDUSTRIAL LOW IMPACT  
USE: OFFICE, COMMERCIAL & WAREHOUSE

SPACE AND BULK CRITERIA:

	REQUIRED:	EXISTING/PROPOSED:
MIN. LOT SIZE:	NONE	71,930 S.F. (1.65 AC)
MIN. STREET FRONTAGE:	60'	159.45'
MIN. FRONT YARD (BLDG.):	25'	26' MIN.
MIN. SIDE YARD (BLDG.):	25'	27' MIN.
* MIN. REAR YARD (BLDG.):	40'	42' MIN.
PAVEMENT SETBACK:	15'	16' MIN.
MAX. BUILDING HEIGHT:(LARGE BLDG)	45'	25.5'
MAX. BUILDING HEIGHT:(SMALL BLDG)	45'	26.4'
MAX IMPERVIOUS SURFACE RATIO:	65%	64%



\* WHEN ABUTTING A RESIDENTIAL ZONE

PARKING:

REQUIRED SPACE SIZE = 9'x18'  
AISLE WIDTH (90 DEGREE PARKING) = 24'



	REQUIRED	EXISTING	PROPOSED
EXISTING INDUSTRIAL (1 SPACE PER 1000 S.F.)	1,914 S.F./1000=2 SPACES	2 SPACES	11 SPACES
PROPOSED INDUSTRIAL (1 SPACE PER 1000 S.F.)	9,000 S.F./1000=9 SPACES		4 SPACES
PROPOSED INDUSTRIAL (1 SPACE PER 1000 S.F.)	3,200 S.F./1000=4 SPACES		
TOTAL PARKING SPACES		15	17

LANDSCAPING:  
STREET TREES - 1 STREET TREE REQUIRED EVERY 30'-45' ON CENTER IN THE CITY R.O.W ALONG STREET FRONTAGE. FRONTAGE = APPROXIMATELY 127' (NOT INCLUDING THE ENTRANCE DRIVE)/45 = 2.8 OR 3 STREET TREES REQUIRED.

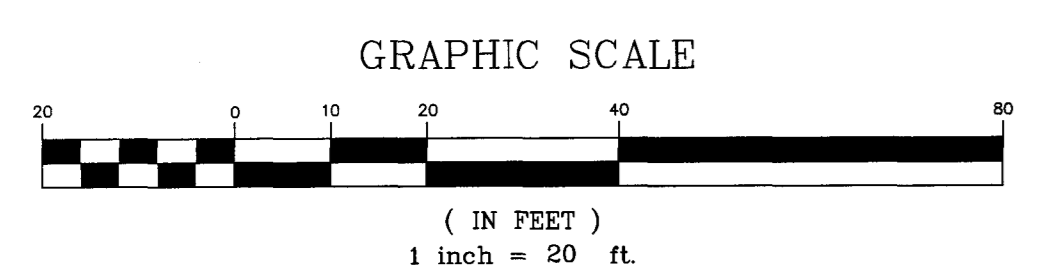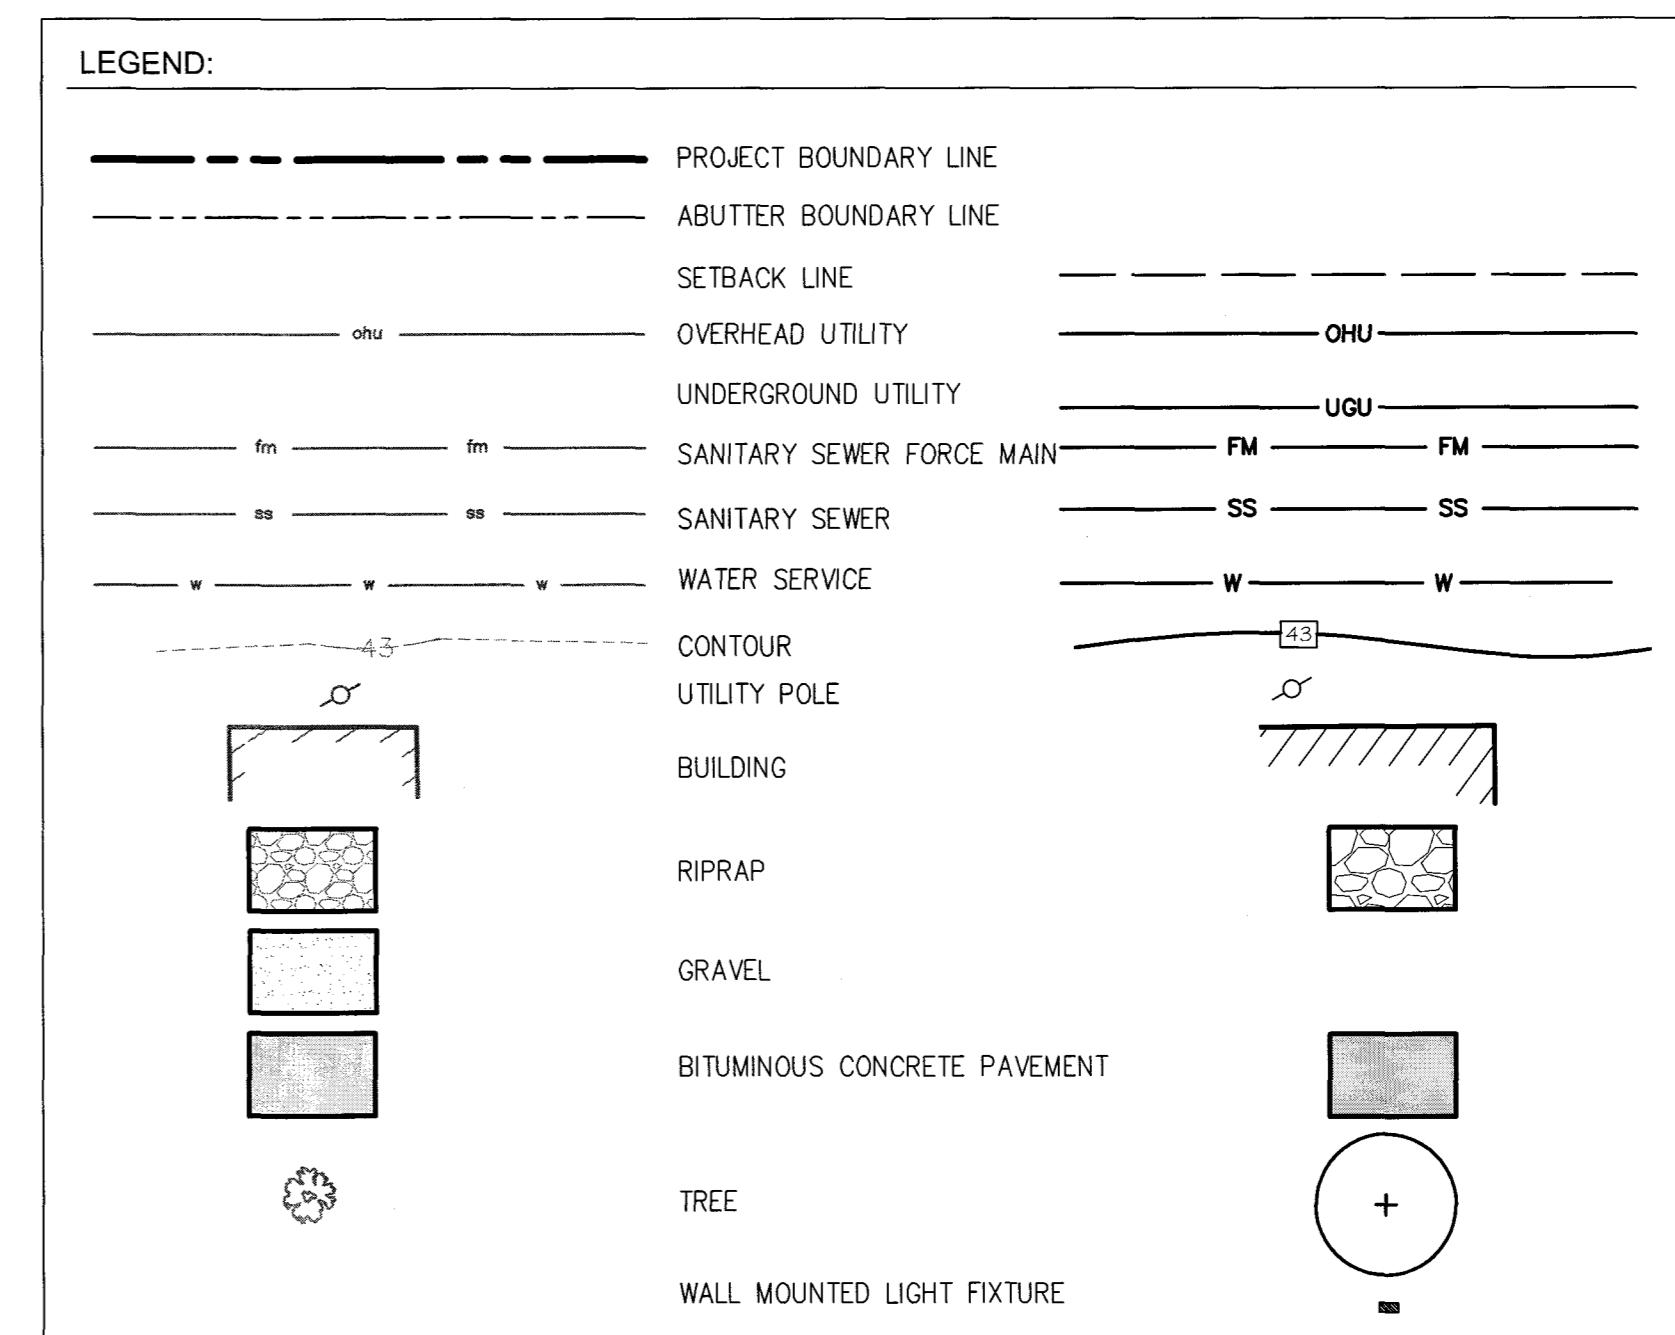

PRESUMPSCOT STREET

REV.	DATE	STATUS	BY	CHKD.	APPD.	REV.	DATE	STATUS	BY	CHKD.	APPD.
C	3/18/18	REVISED PER STAFF COMMENTS AND RESUBMITTED TO THE CITY OF PORTLAND	DEPT.	SWC	PBB						
B	2/9/18	REVISED PER STAFF COMMENTS AND RESUBMITTED TO THE CITY OF PORTLAND	DEPT.	SWC	PBB						
A	11/30/17	SUBMITTED TO THE CITY OF PORTLAND FOR LEVEL 2 SITE PLAN APPLICATION	DEPT.	SWC	PBB						

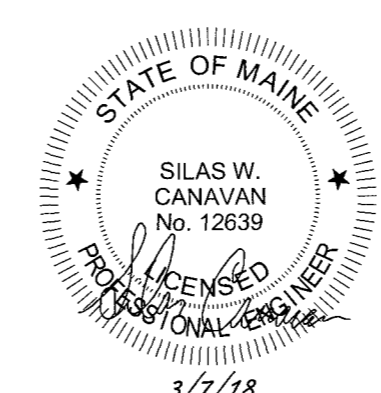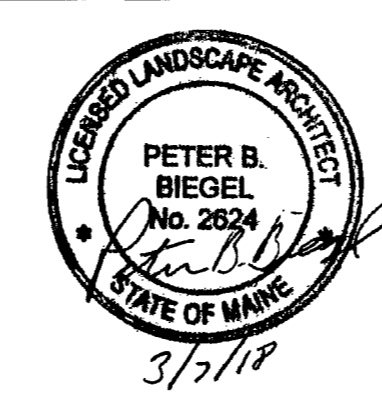

**LAND DESIGN SOLUTIONS**  
LAND PLANNING, SITE PLANNING & LANDSCAPE ARCHITECTURE  
P.O. Box 316, 160 Longwoods Road, Cumberland, ME 04021 tel: (207) 494-1111  
APPLICANT & OWNER:  
**JAKE'S DEVELOPMENT, INC.**  
30 LEDGEWOOD DRIVE, FALMOUTH, MAINE 04105

DESIGN: PBB  
DRAWN: DEPT.  
CHKD: PBB


**PROPOSED PRESUMPSCOT STREET BUSINESS PARK**  
314-316 PRESUMPSCOT STREET, PORTLAND, MAINE


**SITE PLAN**

DATE: NOV. 2017  
SCALE: 1"=20'

PROJ. NO. 15-115  
DWG. NO. C-101

DATE OF APPROVAL: 3/14/2018  
PLANNER: Christian Roadman

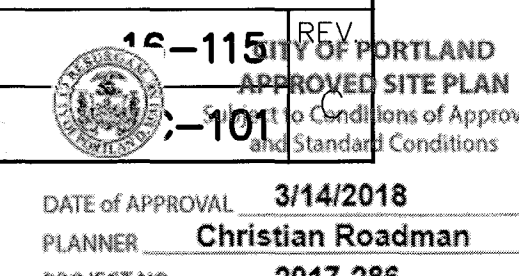


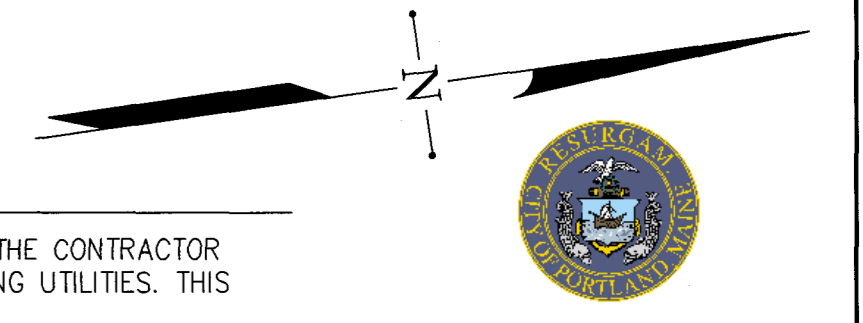


Reviewed for Code Compliance  
 Permitting and Inspections Department  
 Approved with Conditions  
 07/23/2018

**UTILITY NOTES:**

1. THE CONTRACTOR SHALL VERIFY ACTUAL FIELD LOCATION OF UTILITIES PRIOR TO CONSTRUCTION. THE CONTRACTOR SHALL EXCAVATE TEST PITS AT ALL POINTS WHERE PROPOSED UTILITIES ARE TO CROSS EXISTING UTILITIES. THIS INFORMATION SHALL BE PROVIDED TO THE OWNER'S REPRESENTATIVE PRIOR TO CONSTRUCTION.
2. ALL UTILITY WORK SHALL BE IN CONFORMANCE WITH THE CITY OF PORTLAND AND INDIVIDUAL UTILITY COMPANY STANDARDS RESPECTIVELY.
3. THE CONTRACTOR SHALL COORDINATE THE INSTALLATION OF NEW UTILITIES WITH THE APPROPRIATE UTILITY COMPANY.
4. ALL WATER SERVICE SHALL BE COORDINATED WITH THE APPROPRIATE UTILITY DISTRICT. CONSTRUCTION, MATERIALS, TESTING AND CHLORINATION SHALL BE IN ACCORDANCE WITH PORTLAND WATER DISTRICT STANDARDS. WATER VALVES TO BE LEFT OPEN.
5. CONTRACTOR SHALL PROVIDE CONDUIT OF SUITABLE SIZE WITH PULL LINES FOR ALL UNDERGROUND WIRING.
6. CONTRACTOR SHALL INSTALL ONE 1000 GALLON UNDERGROUND PROPANE TANK PER CODE AND VENDOR REQUIREMENTS.
7. ALL MANHOLES AND CATCH BASINS SHALL BE PROVIDED WITH FLEXIBLE BOOT CONNECTIONS FOR PIPES.
8. PIPE MATERIAL FOR 2" WATER SERVICES TO BUILDINGS SHALL BE 200 PSI CTS POLYETHYLENE TUBING.
9. MINIMUM COVER OVER WATER LINE SHALL BE 5.5'.
10. PROPANE GAS LINE SHALL BE INSTALLED PER UTILITY COMPANY STANDARDS.
11. PIPE MATERIAL FOR SANITARY SEWER SHALL BE SDR-35PVC.
12. SEWER MANHOLE SMH#1 INVERTS TO BE DETERMINED FOLLOWING TEST PIT BY CONTRACTOR TO VERIFY SIZE, MATERIAL, AND ELEVATION OF EXISTING SEWER SERVICE.
13. WHERE THERE IS LESS THAN 5' COVER OVER SEWER LINES, PLACE 2 LAYERS OF 2" THICK RIGID INSULATION OVER PIPE FOR FULL WIDTH OF TRENCH. INSULATION JOINTS SHALL BE STAGGERED.
14. SITE LIGHTING - BUILDING WALL MOUNTED LIGHTS ARE PROPOSED FOR USE TO LIGHT THE ENTRANCES AND PARKING AREAS. THE PROPOSED FIXTURE IS THE MPLED 52 AS MANUFACTURED BY RAB LIGHTING. THE FIXTURE IS AN LED AND FULL CUTOFF. MOUNTING HEIGHT IS APPROXIMATELY 18'-6" ABOVE FINISHED FLOOR ELEVATION. NO OTHER SITE LIGHTING IS PROPOSED.
15. IF PROPERTY IS EVER SUBDIVIDED OR OWNERSHIP IS SPLIT, COMMON FIRE AND DOMESTIC SERVICES WILL BE NON-CONFORMING. INDIVIDUAL SERVICES WILL BE REQUIRED.

**LEGEND:**

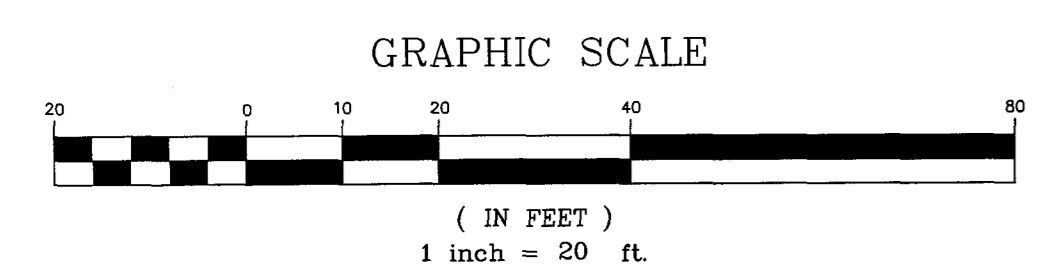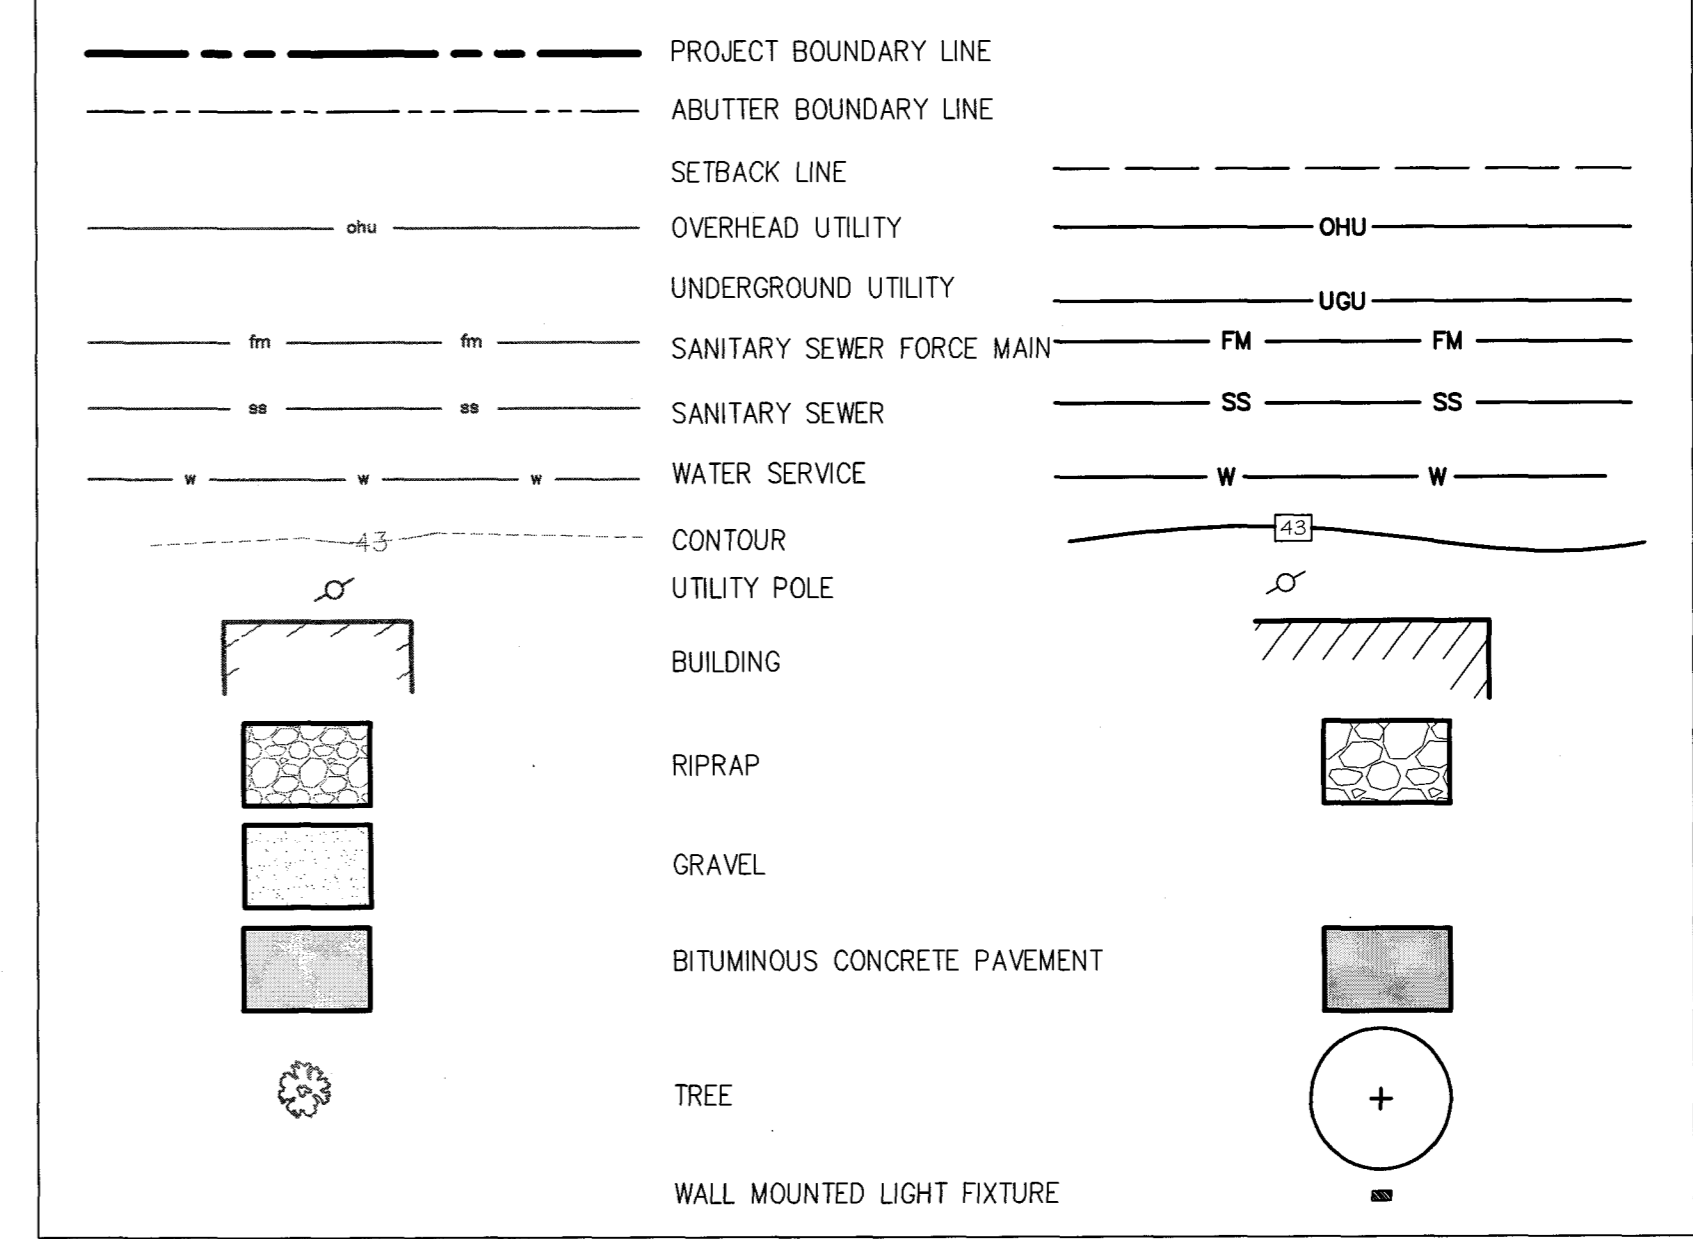

REV.	DATE	STATUS	BY	CHKD	APPD	REV.	DATE	STATUS	BY	CHKD	APPD
B	2/9/18	REVISED PER PORTLAND WATER DISTRICT COMMENTS RESUBMITTED TO THE CITY	DEPT.	SWC	PBB						
A	11/30/17	SUBMITTED TO THE CITY OF PORTLAND FOR LEVEL 2 SITE PLAN APPLICATION	DEPT.	SWC	PBB						

**WALSH**  
 ENGINEERING ASSOCIATES, INC.  
 One Karen Dr., Suite 2A | Westbrook, Maine 04092  
 ph: 207.653.9898 | www.walsh-eng.com  
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STATE OF MAINE  
 SILAS W. CARAVAN  
 No. 12639  
 LICENSED PROFESSIONAL ENGINEER  
 2/9/18

**LAND DESIGN SOLUTIONS**  
 LAND PLANNING, SITE PLANNING & LANDSCAPE ARCHITECTURE  
 P.O. Box 316, 160 Longwoods Road, Cumberland, ME 04021 tel: (207) 494-1717  
 APPLICANT & OWNER:  
**JAKE'S DEVELOPMENT, INC.**  
 30 LEDGEWOOD DRIVE, FALMOUTH, MAINE 04105

**PROPOSED PRESUMPCOT STREET BUSINESS PARK**  
 314-316 PRESUMPCOT STREET, PORTLAND, MAINE

**SITE UTILITY PLAN**

DESIGN: -  
 DRAWN: -  
 CHKD: -

DATE: NOV. 2017  
 SCALE: 1"=20'

PROJ. NO. 16-115  
 DWG. NO. C-103

APPROVED SITE PLAN  
 103  
 Christian Roadman  
 3/14/2018