


# SELF STORAGE TENANT FIT-UP

## ABBREVIATIONS:

AB	ANCHOR BOLT	L	ANGLE / LENGTH
ACV	AIR CONDITIONING	LF	LEFT
ACCU	AIR CONDITIONING CONDENSER UNIT	LINO	SHEET LINOLEUM
ACPLAS	ACOUSTICAL PLASTER	LL	LIVE LOAD
ACT	ACOUSTIC CEILING TILE	LLH	LONG LEG HORIZONTAL
AFF	ABOVE FINISH FLOOR	LLV	LONG LEG VERTICAL
AGG	AGGREGATE	LP	LIGHTING PANEL / LIQUIFIED PROPANE
ALT	ALTERNATE	MAX	MAXIMUM
AP	ACCESS PANEL	MB	MARKER BOARD
APROX	APPROXIMATE	MDO	MEDIUM DENSITY OVERLAY
ARCH	ARCHITECTURAL	MECH	MECHANICAL
BCX	BOTTOM CORD EXTENSION	MFR	MANUFACTURER
BD	BOARD	MIN	MINIMUM
BIT	BITUMINOUS	MISC	MISCELLANEOUS
BLDG	BUILDING	MO	MASONRY OPENING
BLP	BORROWED LIGHT PANEL	MR	MOISTURE-RESISTANT
BO	BOTTOM OF	MUA	MAKE-UP AIR
BOF	BOTTOM OF FOOTING	N	NOSING
BOS	BOTTOM OF STEEL	NCB	NEW CATCH BASIN
BOT	BOTTOM	NDMH	NEW DRAIN MANHOLE
BRDG	BRIDGING	NFM	NEW FORCE MAIN
BRG	BEARING	NIC	NOT IN CONTRACT
BS	BOTH SIDES	NS	NEAR SIDE
BSE	BRICK SHELF ELEVATION	NSD	NEW STORM DRAIN LINE
C	CHANNEL	NSS	NEW SANITARY SEWER LINE
CB	CATCH BASIN / CHALKBOARD	NTS	NOT TO SCALE
CEM BD	CEMENTITIOUS BACKER BOARD	NW	NEW WATER LINE
CFM	CUBIC FEET PER MINUTE	OC	ON CENTER
CIP	CAST IN PLACE	OF	OUTSIDE FACE
CJ	CONTROL JOINT / CONSTRUCTION JOINT	OH	OVERHEAD
CL	CENTER LINE	PA	PUBLIC ADDRESS
CLL	CONTACT LIMIT LINE	PAF	POWER-ACTUATED FASTENER
CLR	CLEAR	PDU	POOL DEHUMIDIFICATION UNIT
CMU	CONCRETE MASONRY UNIT	PL	PLATE / PROPERTY LINE
COL	COLUMN	PLAM	PLASTIC LAMINATE
CONC	CONCRETE	PLF	POUNDS PER LINEAR FOOT
CONT	CONTINUOUS	PP	POWER PANEL
CT	CERAMIC TILE	PSF	POUNDS PER SQUARE FOOT
CUH	CABINET UNIT HEATER	PSI	POUNDS PER SQUARE INCH
D	DIAMETER	PT	PRESSURE-TREATED
DBL	DOUBLE	PVC	POLYVINYL CHLORIDE
DF	DRINKING FOUNTAIN	PVMT	PAVEMENT
DL	DEAD LOAD	R	RISER / RADIUS
DR	DISPLAY RAIL	RB	RESILIENT BASE
DTL	DETAIL	RD	ROOF DRAIN
DW	DISHWASHER	REINF	REINFORCED
DWG	DRAWING	REQD	REQUIRED
EA	EACH	RT	RIGHT
EF	EXHAUST FAN / EACH FACE	RO	ROUGH OPENING
EJ	EXPANSION JOINT	ROW	RIGHT OF WAY
EL	ELEVATION	RR	RUB-RAIL
ELEC	ELECTRICAL	RTU	ROOF TOP UNIT (HVAC)
EOP	EDGE OF PAVEMENT	SACT	SUSPENDED ACOUSTIC TILE CEILING
EOPDM	ETHYLENE PROPYLENE DIENE MONOMER	SC	SOLID CORE
EQ	EQUAL	SF	SQUARE FOOT / SUPPLY FAN
EW	EACH WAY	SFRM	SPRAYED FIRE-RESISTIVE MATERIAL
EWC	ELECTRIC WATER COOLER	SHT	SHEET
EXIST	EXISTING	SK	SKIRT
EXP	EXPANSION	SN	SANITARY NAPKIN (DISPENSER)
EXT	EXTERIOR	SP	SPECIAL
FB	FLAT BAR	SS	STAINLESS STEEL
FBO	FURNISHED BY OTHERS	STA	STATION
FCO	FLOOR CLEA-OUT	STL	STEEL
FD	FLOOR DRAIN	STRUC	STRUCTURAL
FE	FIRE EXTINGUISHER	T	TREAD
FEC	FIRE EXTINGUISHER CABINET	TB	TACKBOARD
FF	FINISH FLOOR / FAR FACE	T&B	TOP AND BOTTOM
FFE	FINISH FLOOR ELEVATION	TBM	TEMPORARY BENCHMARK
FO	FRAMED OPENING	TCE	TOP CHORD EXTENSION
FRP	FIBER REINFORCED PLASTIC	TJ	TIE JOIST
FS	FAR SIDE	TO	TOP OF
FTG	FOOTING	TOC	TOP OF CONCRETE
GA	GAUGE	TOP	TOP OF FOOTING
GALV	GALVANIZED	TCM	TOP OF MASONRY
GB	GRAB BAR	TOP	TOP OF PIER
GC	GENERAL CONTRACTOR	TOS	TOP OF STEEL
GDT	GYPSPUM DROP-IN TILE	TOW	TOP OF WALL
GV	GRAVITY VENT	TP	TOILET PAPER (DISPENSER) / TEST PIT
GWB	GYPSPUM WALL BOARD	TS	TUBE STEEL
H	HORIZONTAL	TYP	TYPICAL
HC	HANDICAPPED / HOLLOW CORE	UH	UNIT HEATER
HORIZ	HORIZONTAL	UNO	UNLESS NOTED OTHERWISE
HM	HOLLOW METAL	V	VENT PIPE / VERTICAL
HRU	HEAT RECOVERY UNIT	VB	VAPOR BARRIER
H&V	HEATING AND VENTILATING	VCT	VINYL COMPOSITION TILE
HVAC	HEATING, VENTILATING AND AIR CONDITIONING	VERT	VERTICAL
I	INCLUDED ANGLE	VP	VERTICAL
ID	INSIDE DIAMETER	VTR	VENT THROUGH THE ROOF
IF	INSIDE FACE	W	WITH
IJ	ISOLATION JOINT	WC	WATER CLOSET
IMP	IMPACT RESISTANT	WD	WOOD
INS	INSULATED	WF	WIDE FLANGE
INV	INVERT	WH	WATER HEATER
JS	JOINT SUBSTITUTE	W/O	WITH OUT
K	KIPS	WP	WORKING POINT
		WS	WEB STIFFENER
		WWF	WELDED WIRE FABRIC

## LOCATION MAP:

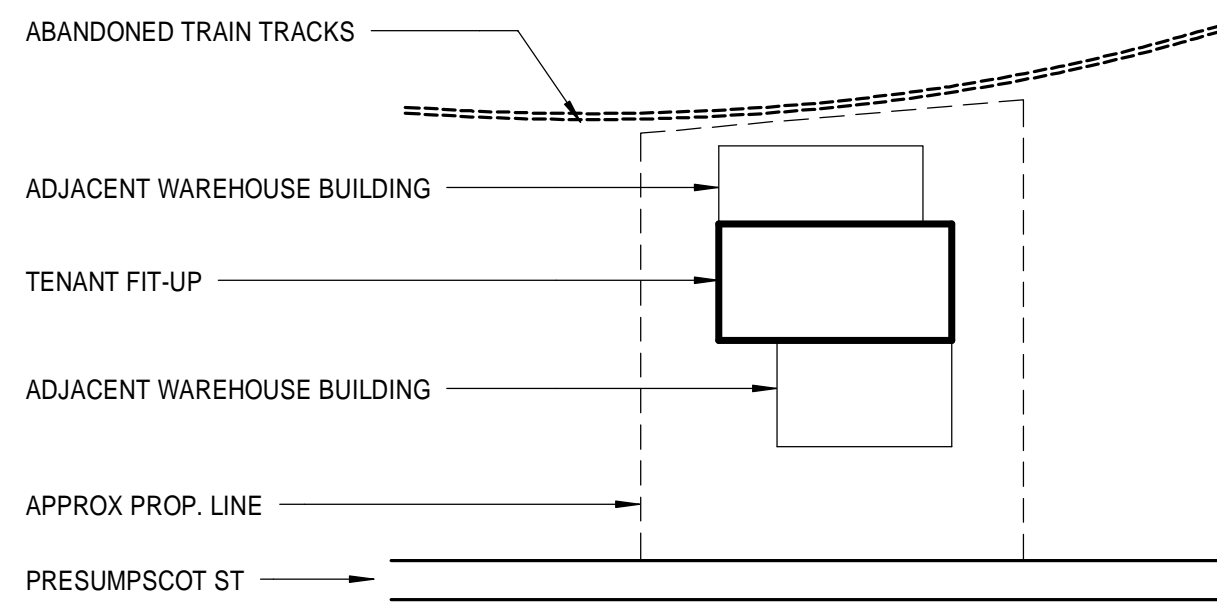

## GENERAL NOTES:

1. FIELD VERIFY ALL DIMENSIONS AND LAYOUT PRIOR TO PROCEEDING WITH WORK. NOTIFY ARCHITECT IN WRITING OF ANY DISCREPANCIES OR INCONSISTENCIES. FAILURE TO REPORT ANY DISCREPANCIES WITHIN THESE CONSTRUCTION DOCUMENTS TO THE ARCHITECT WILL NOT BE GROUNDS FOR ADDITIONAL COST OR CHANGE ORDERS.
2. CONTRACTOR SHALL BE RESPONSIBLE FOR PROVIDING ALL MATERIALS (UNLESS NOTED OTHERWISE), AND WORKMANSHIP IN ACCORDANCE WITH FEDERAL, STATE, CITY, AND LOCAL BUILDING CODES AND THEIR REQUIREMENTS.
3. CONTRACTOR AND ALL TRADES SHALL NOTE REQUIREMENTS OF "GENERAL NOTES" ON ALL SHEETS.
4. EACH TRADE TO PROVIDE SMOKE OR FIRE SEALANT AT PENETRATIONS AS REQUIRED FOR WALL TYPE (UNLESS NOTED OTHERWISE). ALL SEALANT, FIRE STOPPING AND SMOKE STOPPING ASSEMBLIES SHALL BE U.L. RATED.
5. REFER TO ALL CONSTRUCTION DOCUMENTS FOR REQUIREMENTS WHICH MAY AFFECT THE WORK IN ANOTHER AREA AND/OR DISCIPLINE AND COORDINATE.
6. PROVIDE BLOCKING IN WALLS AS NECESSARY WHERE CASEWORK, FURNITURE, SHELVES, HANDRAILS, AND/OR OTHER MISC. EQUIPMENT IS LOCATED.
7. DO NOT SCALE CONSTRUCTION DOCUMENTS.
8. PROVIDE MEANS "FURNISH AND INSTALL".




## SYMBOL LEGEND:

	BUILDING SECTION
	WALL SECTION
	DETAIL
	EXTERIOR ELEVATION
	INTERIOR ELEVATION
	LEVEL LINE
	KEY NOTE
	EQUIPMENT/ACCESSORY TAG
	WINDOW TAG
	PARTITION TAG
	DOOR TAG
	ROOM NAME ROOM NUMBER
	COLUMN BUBBLE AND CENTER LINE
	BACKER ROD AND SEALANT
	WALL MOUNTED EXIT SIGN

## DRAWING LIST:

<b>GENERAL</b>	
GI001	COVER SHEET, LEGEND AND ABBREVIATIONS, WALL TYPES
<b>ARCHITECTURAL</b>	
A-001	FIRST FLOOR CODE COMPLIANCE PLAN
A-002	SECOND FLOOR CODE COMPLIANCE PLAN
AD101	FIRST FLOOR DEMOLITION PLAN
AD102	SECOND FLOOR DEMOLITION PLAN
AD121	FIRST FLOOR DEMO RCP
AD122	SECOND FLOOR DEMO RCP
AD201	EXTERIOR DEMOLITION ELEVATION
AE101	FIRST FLOOR PLAN
AE102	SECOND FLOOR PLAN
AE121	FIRST FLOOR RCP
AE122	SECOND FLOOR RCP
AE201	EXTERIOR ELEVATIONS
AE501	DETAILS

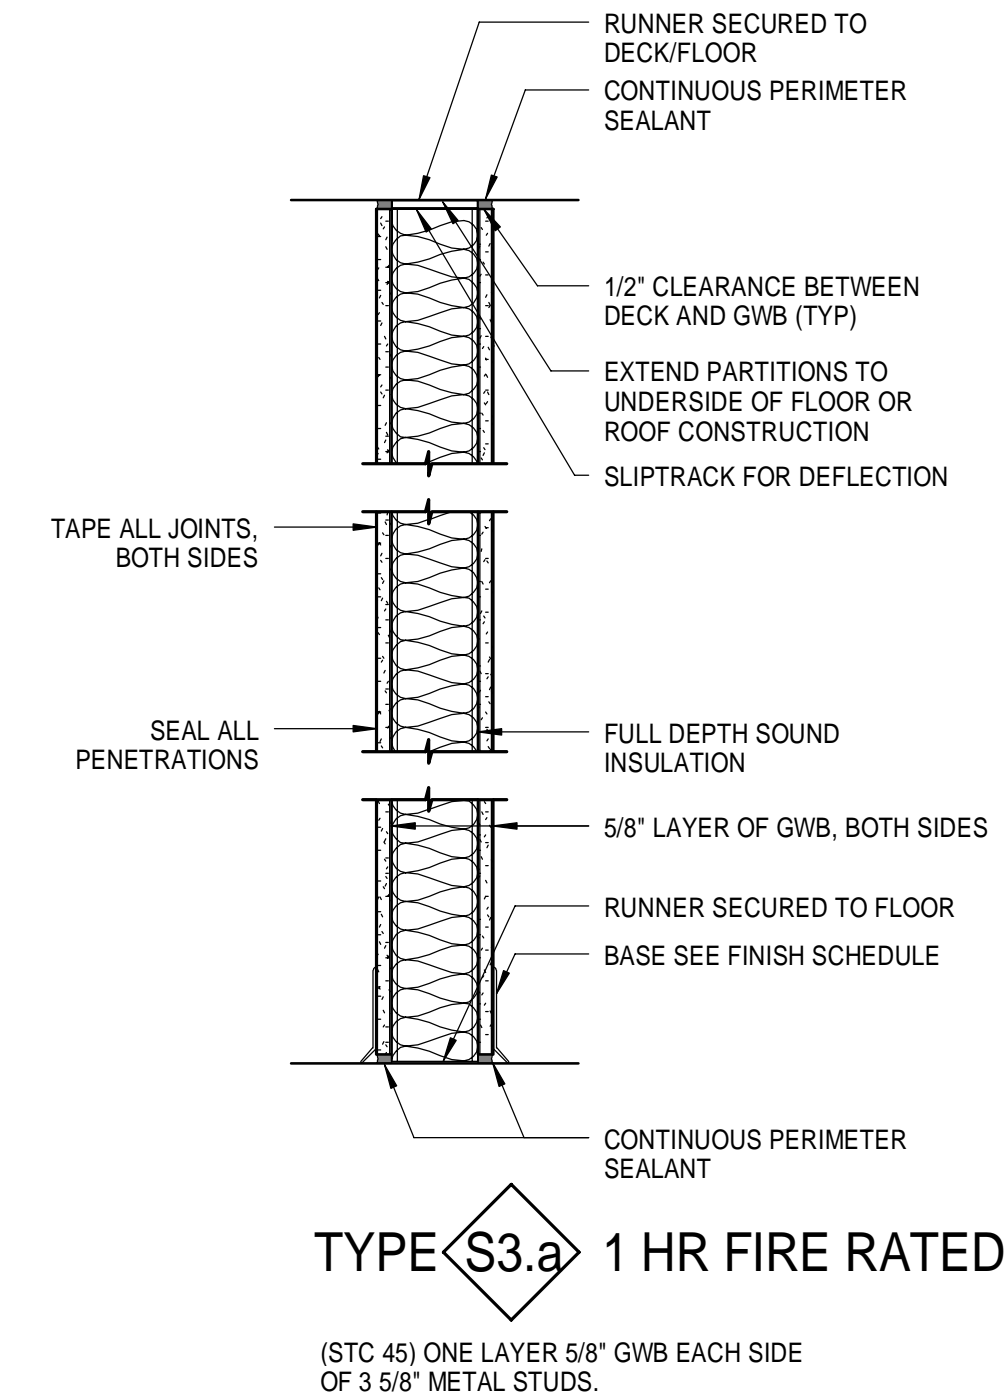

## A10 PARTITION TYPES

1 1/2" = 1'-0"

SELF-STORAGE TENANT FIT-UP

PERMIT SET  
5-12-16

235 PRESUMPSCOT STREET

CURRENT ISSUE STATUS:

REV	DESCRIPTION	DATE

GRAPHIC SCALE:



SCALE: As indicated  
PROJECT MANAGER: JLH  
JC/DRAWN BY: SHK  
A/E OF RECORD: JLH  
PROJECT NO: 15105  
SMART FILE: GI001 - 15105

DATE:  
SHEET TITLE:  
**COVER SHEET,  
LEGEND AND  
ABBREVIATIONS**

SHEET No.  
**GI001**

©Copyright 2016 SHK LLC