



EXISTING FIRST FLOOR PLAN
 SCALE: 1/8" = 1'-0"



FRONT ELEVATION
 SCALE: NTS

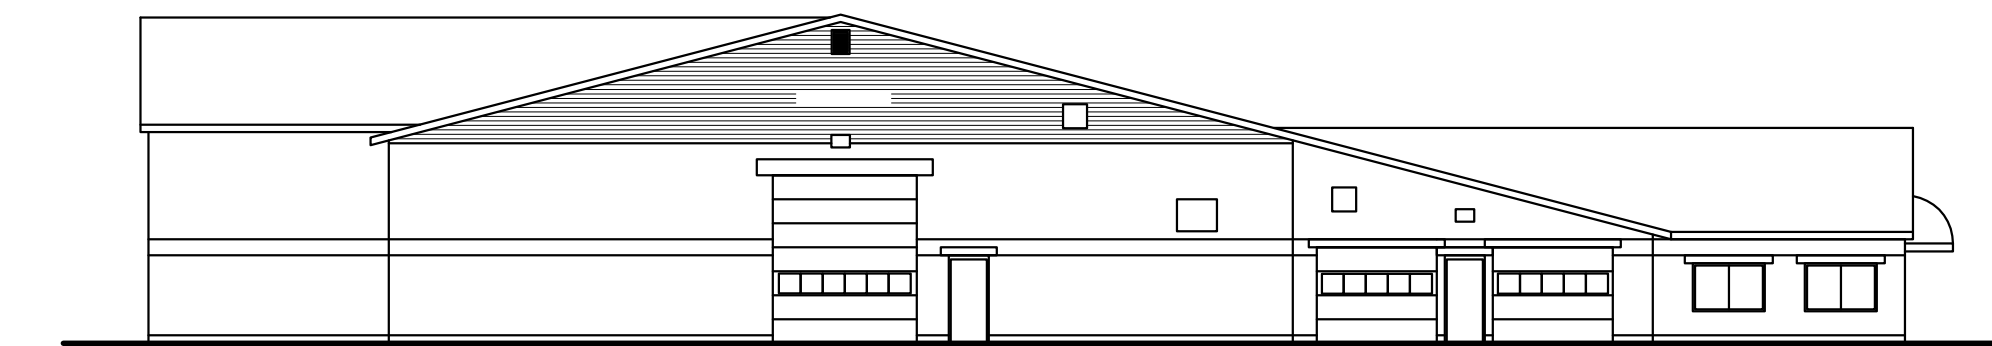

LEFT ELEVATION
 SCALE: NTS

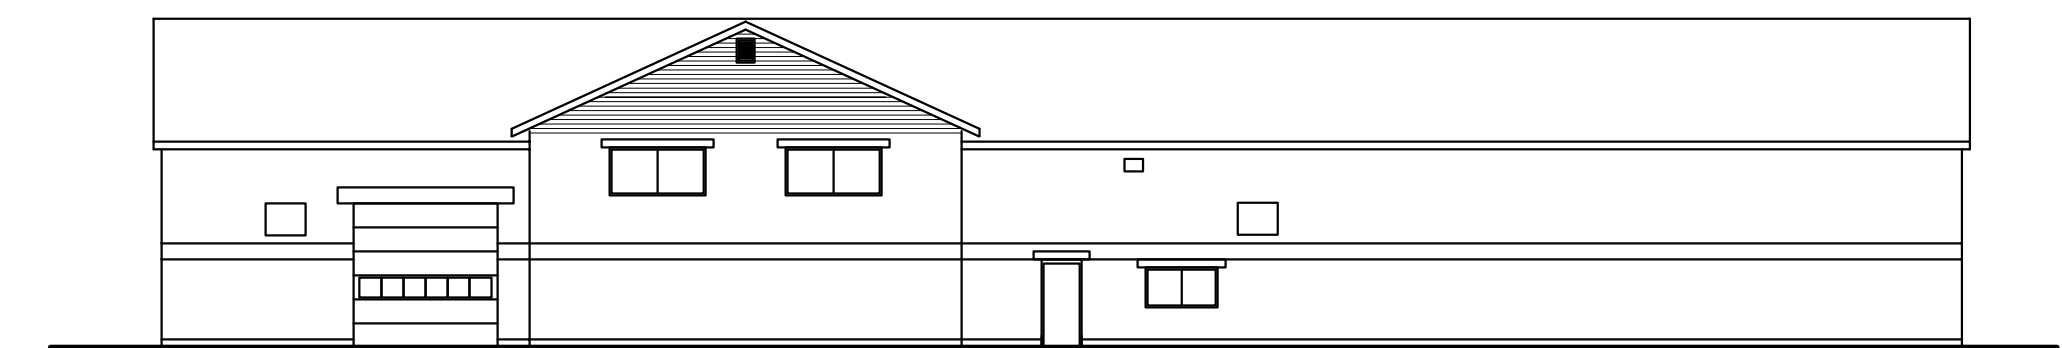

REAR ELEVATION
 SCALE: NTS



RIGHT ELEVATION
 SCALE: NTS

FIRE SAFETY LEGEND




- SMOKE/HEAT DETECTOR
- PULL STATION
- FIRE EXTINGUISHER
- EMERGENCY LIGHT/ HORN STROBE PACK
- FIRE ALARM BELL

- DRAWING LIST:**
- A1 EXISTING FIRST FLOOR PLAN
 - A2 SECOND FLOOR PLAN
 - A3 DETAILS

These drawings are the property of MacLeod Structural Engineers, PA and are for the exclusive use of:
Moody's Collision Center
 Use of these drawings by others without written consent is prohibited.


MacLeod
 Structural Engineers, PA
 404 Main Street Gorham, Maine 04038 207.839.0980

Moody's Collision Center
 Presumpscot Street
 Portland, Maine

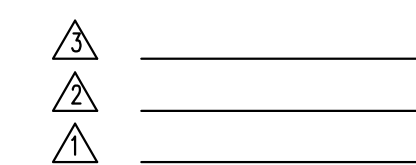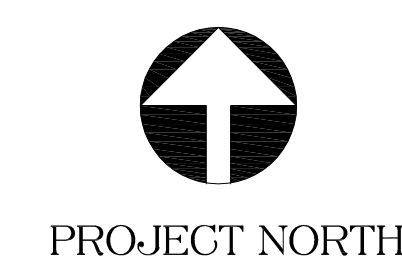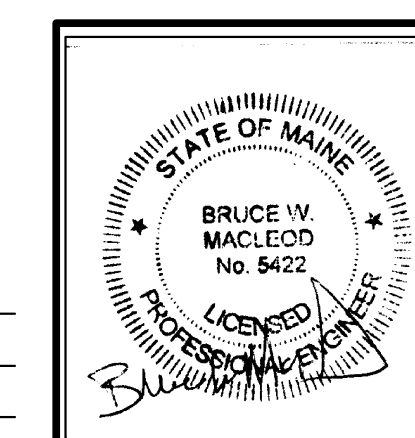

TITLE: EXISTING FIRST FLOOR PLAN		
DATE: 01/10/13	DRAWN BY: BIM	DRAWING NUMBER:
SCALE: as noted	PROJ NO: 2013-109	A1

MOODY'S COLLISION CENTER
 PORTLAND, MAINE

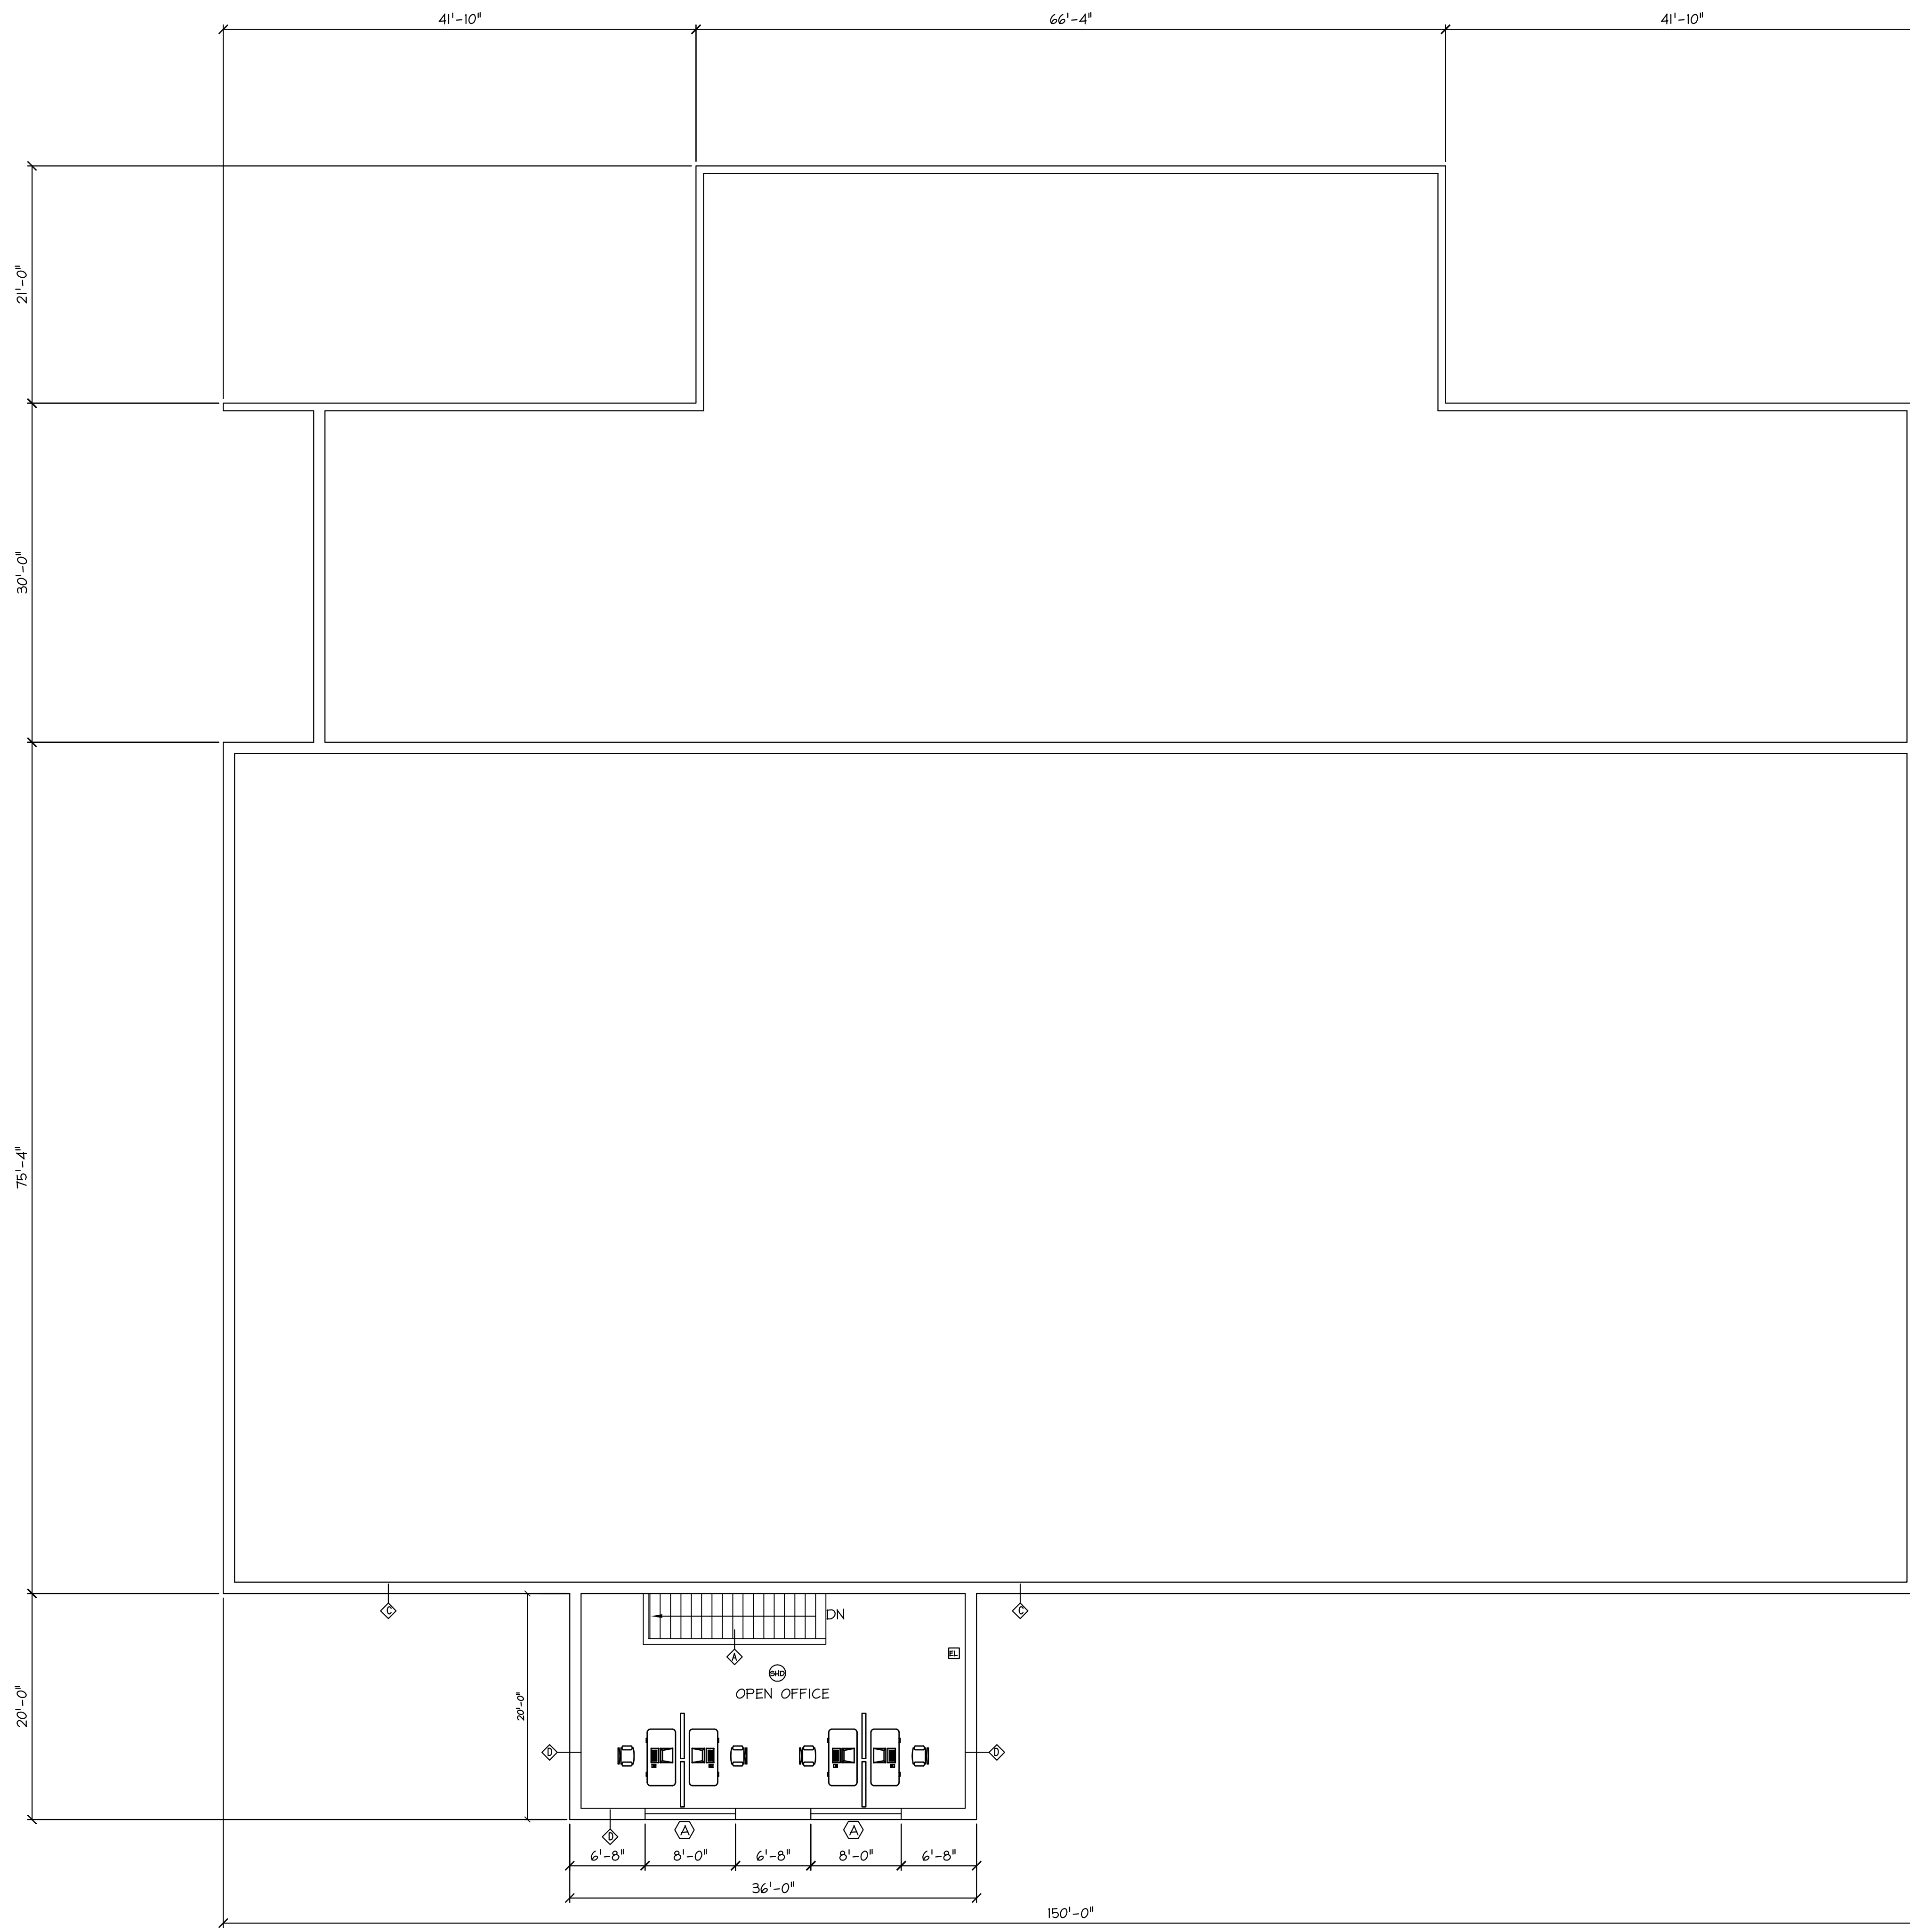




SECOND FLOOR PLAN
SCALE: 1/8" = 1'-0"

CODE REVIEW


2009 INTERNATIONAL BUILDING CODE (IBC)
2009 NFPA 101 LIFE SAFETY CODE

USE AND OCCUPANCY CLASSIFICATION
 USE GROUP : B - BUSINESS (OFFICE AREA): 1 ST. 1,393 SF
 2nd ST. 720 SF
 USE GROUP : S-1 - MODERATE HAZARD STORAGE: 1 ST. 16,519 SF
 (MOTOR VEHICLE REPAIR GARAGE)
 TOTAL BUILDING AREA: HT 20', 18,362 SF
 TYPE OF CONSTRUCTION SECTION 602
 CONSTRUCTION TYPE: 3B PROTECTED
 BUILDING IS SPRINKLERED PER CODE REQUIREMENTS

MacLeod Structural Engineers, PA		
404 Main Street Gorham, Maine 04038 207.839.0980		
Moody's Collision Center Presumpscot Street Portland, Maine		
TITLE: SECOND FLOOR PLAN		
DATE: 01/10/13	DRAWN BY: BIM	DRAWING NUMBER:
SCALE: as noted	PROJ NO: 2013-109	A2

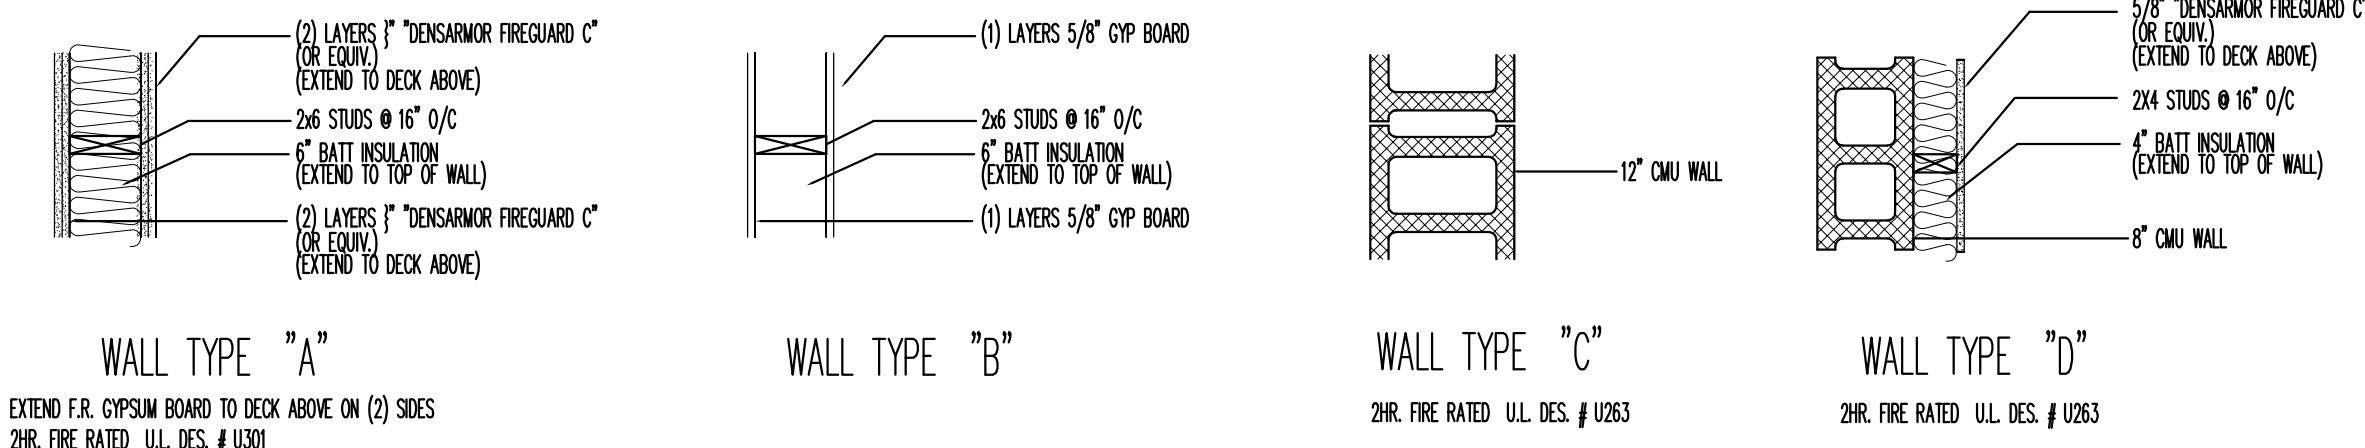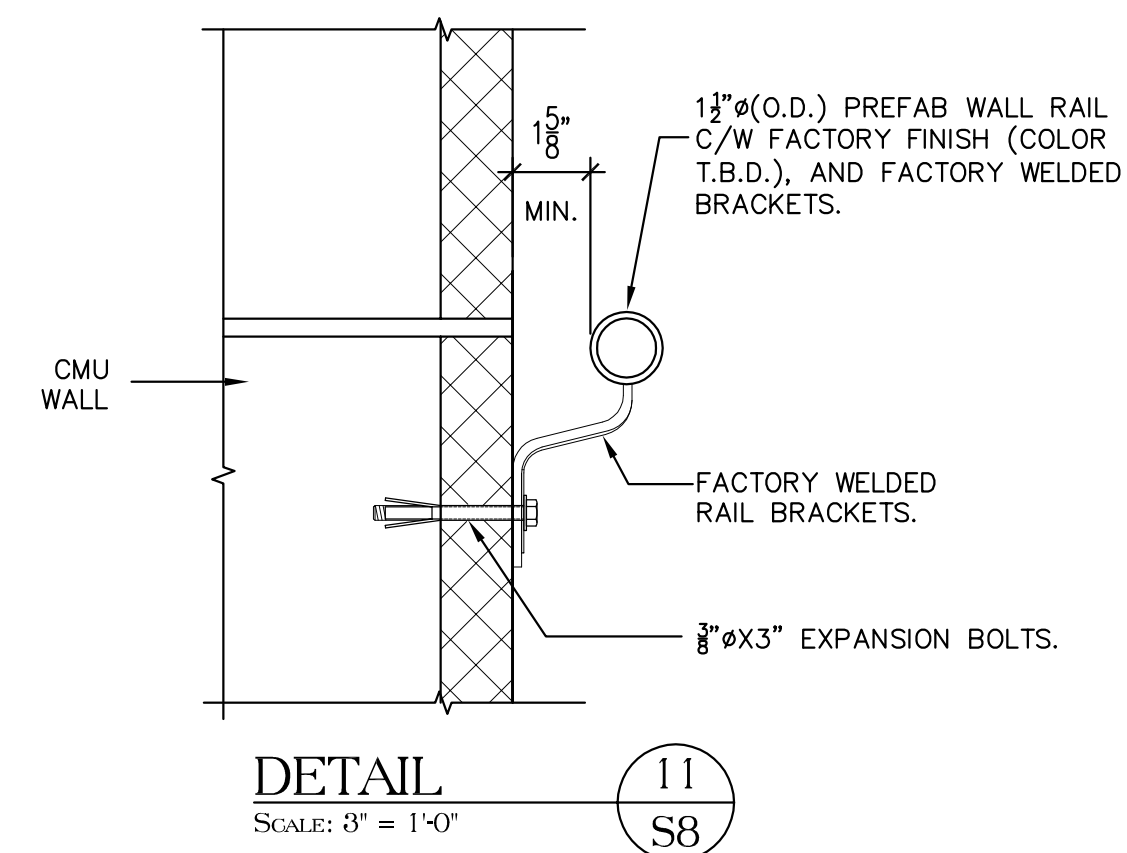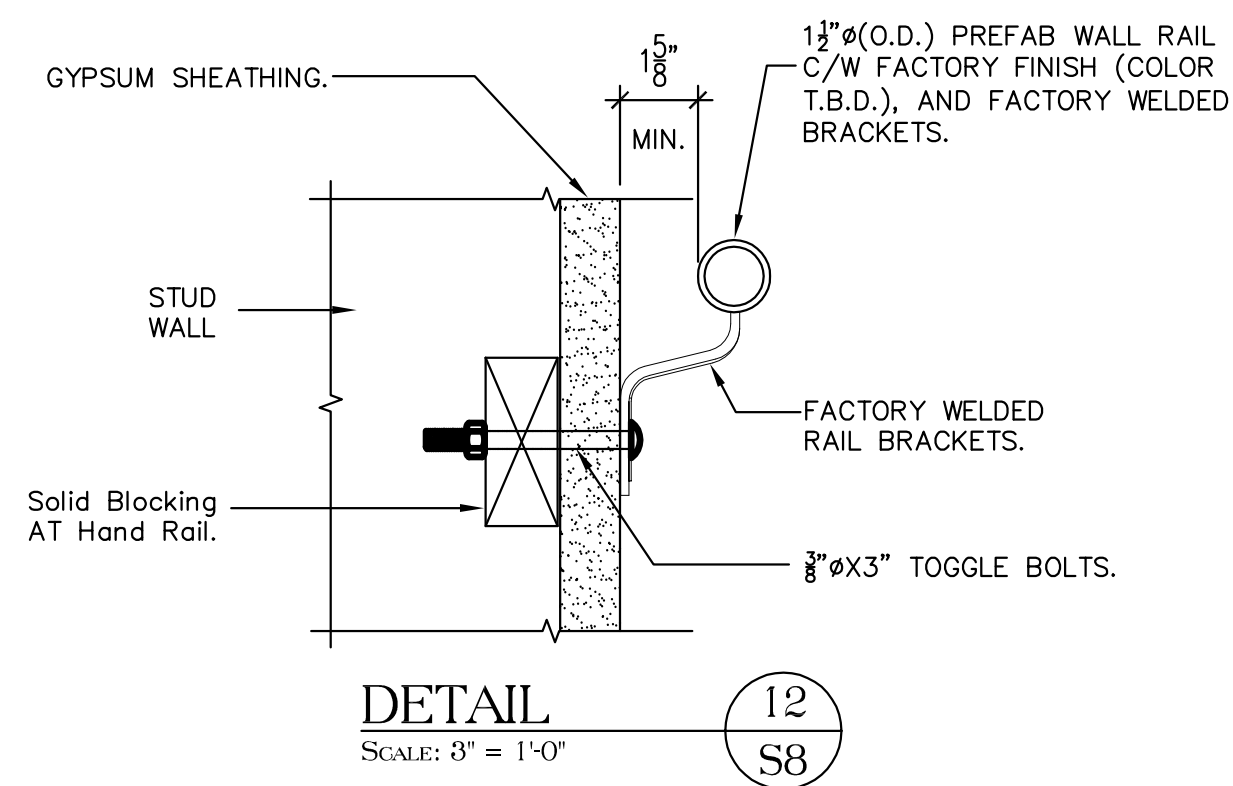


EXISTING WALL TYPES

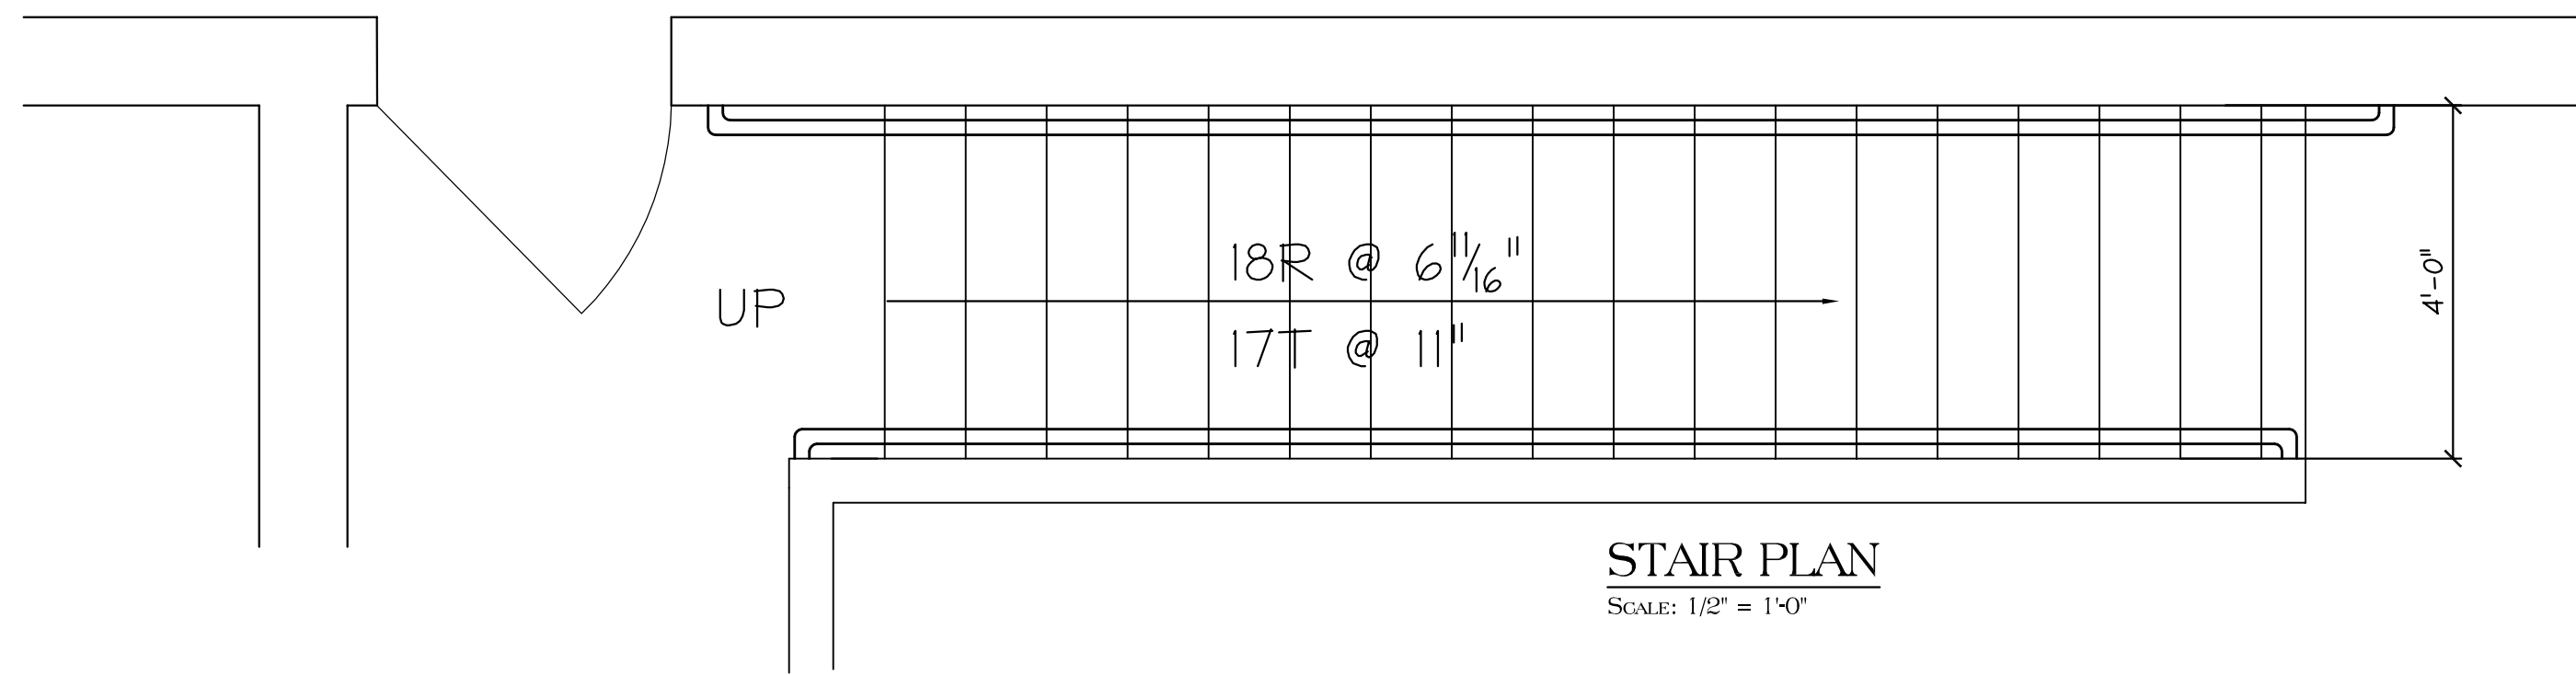

EXISTING DOOR SCHEDULE


DOOR #	SIZE	LABEL	MTR'L	ELEV	MT'R'L	ELEV	TYPE
101	3070	---	MT'L INS.	F	HM	I	PANIC HARDWARE & EXT. PULL
102	(2) 3070	2 HOUR	MT'L INS.	F/F	HM	I	
103	3070	2 HOUR	MT'L INS.	F	HM	I	

NOTE - ALL 3070 DOORS TO HAVE LEVER HANDLES


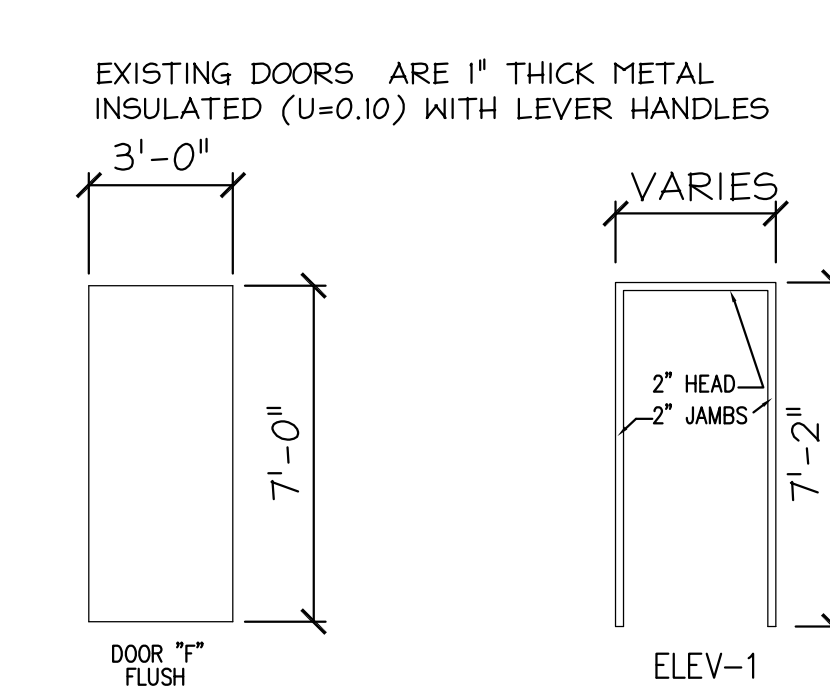


EXISTING WINDOW SCHEDULE

TYPE	SIZE	MTR'L	TYPE	REMARKS
A	8'-0" W x 4'-0" H	ALUMINUM	FIXED GLASS	

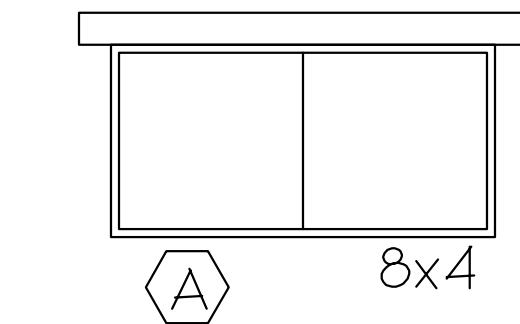


WINDOW NOTES:
GLAZING TO BE 3/4" THICK LOW "E" INSULATED UNITS W/ "CLEAR" GLASS
U-VALUE = 0.46 MIN.
SHGC VALUE = 0.54 MIN.

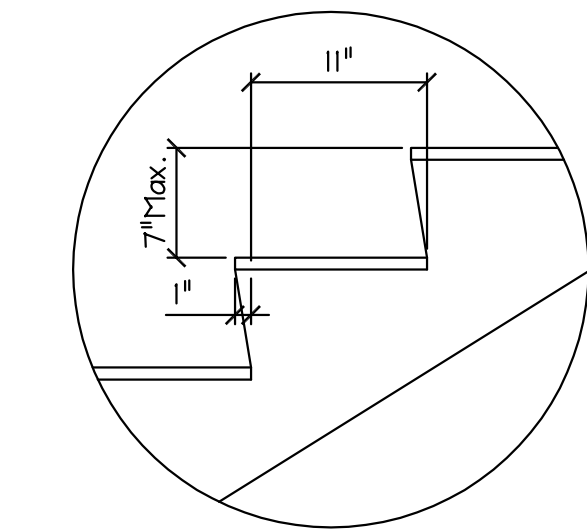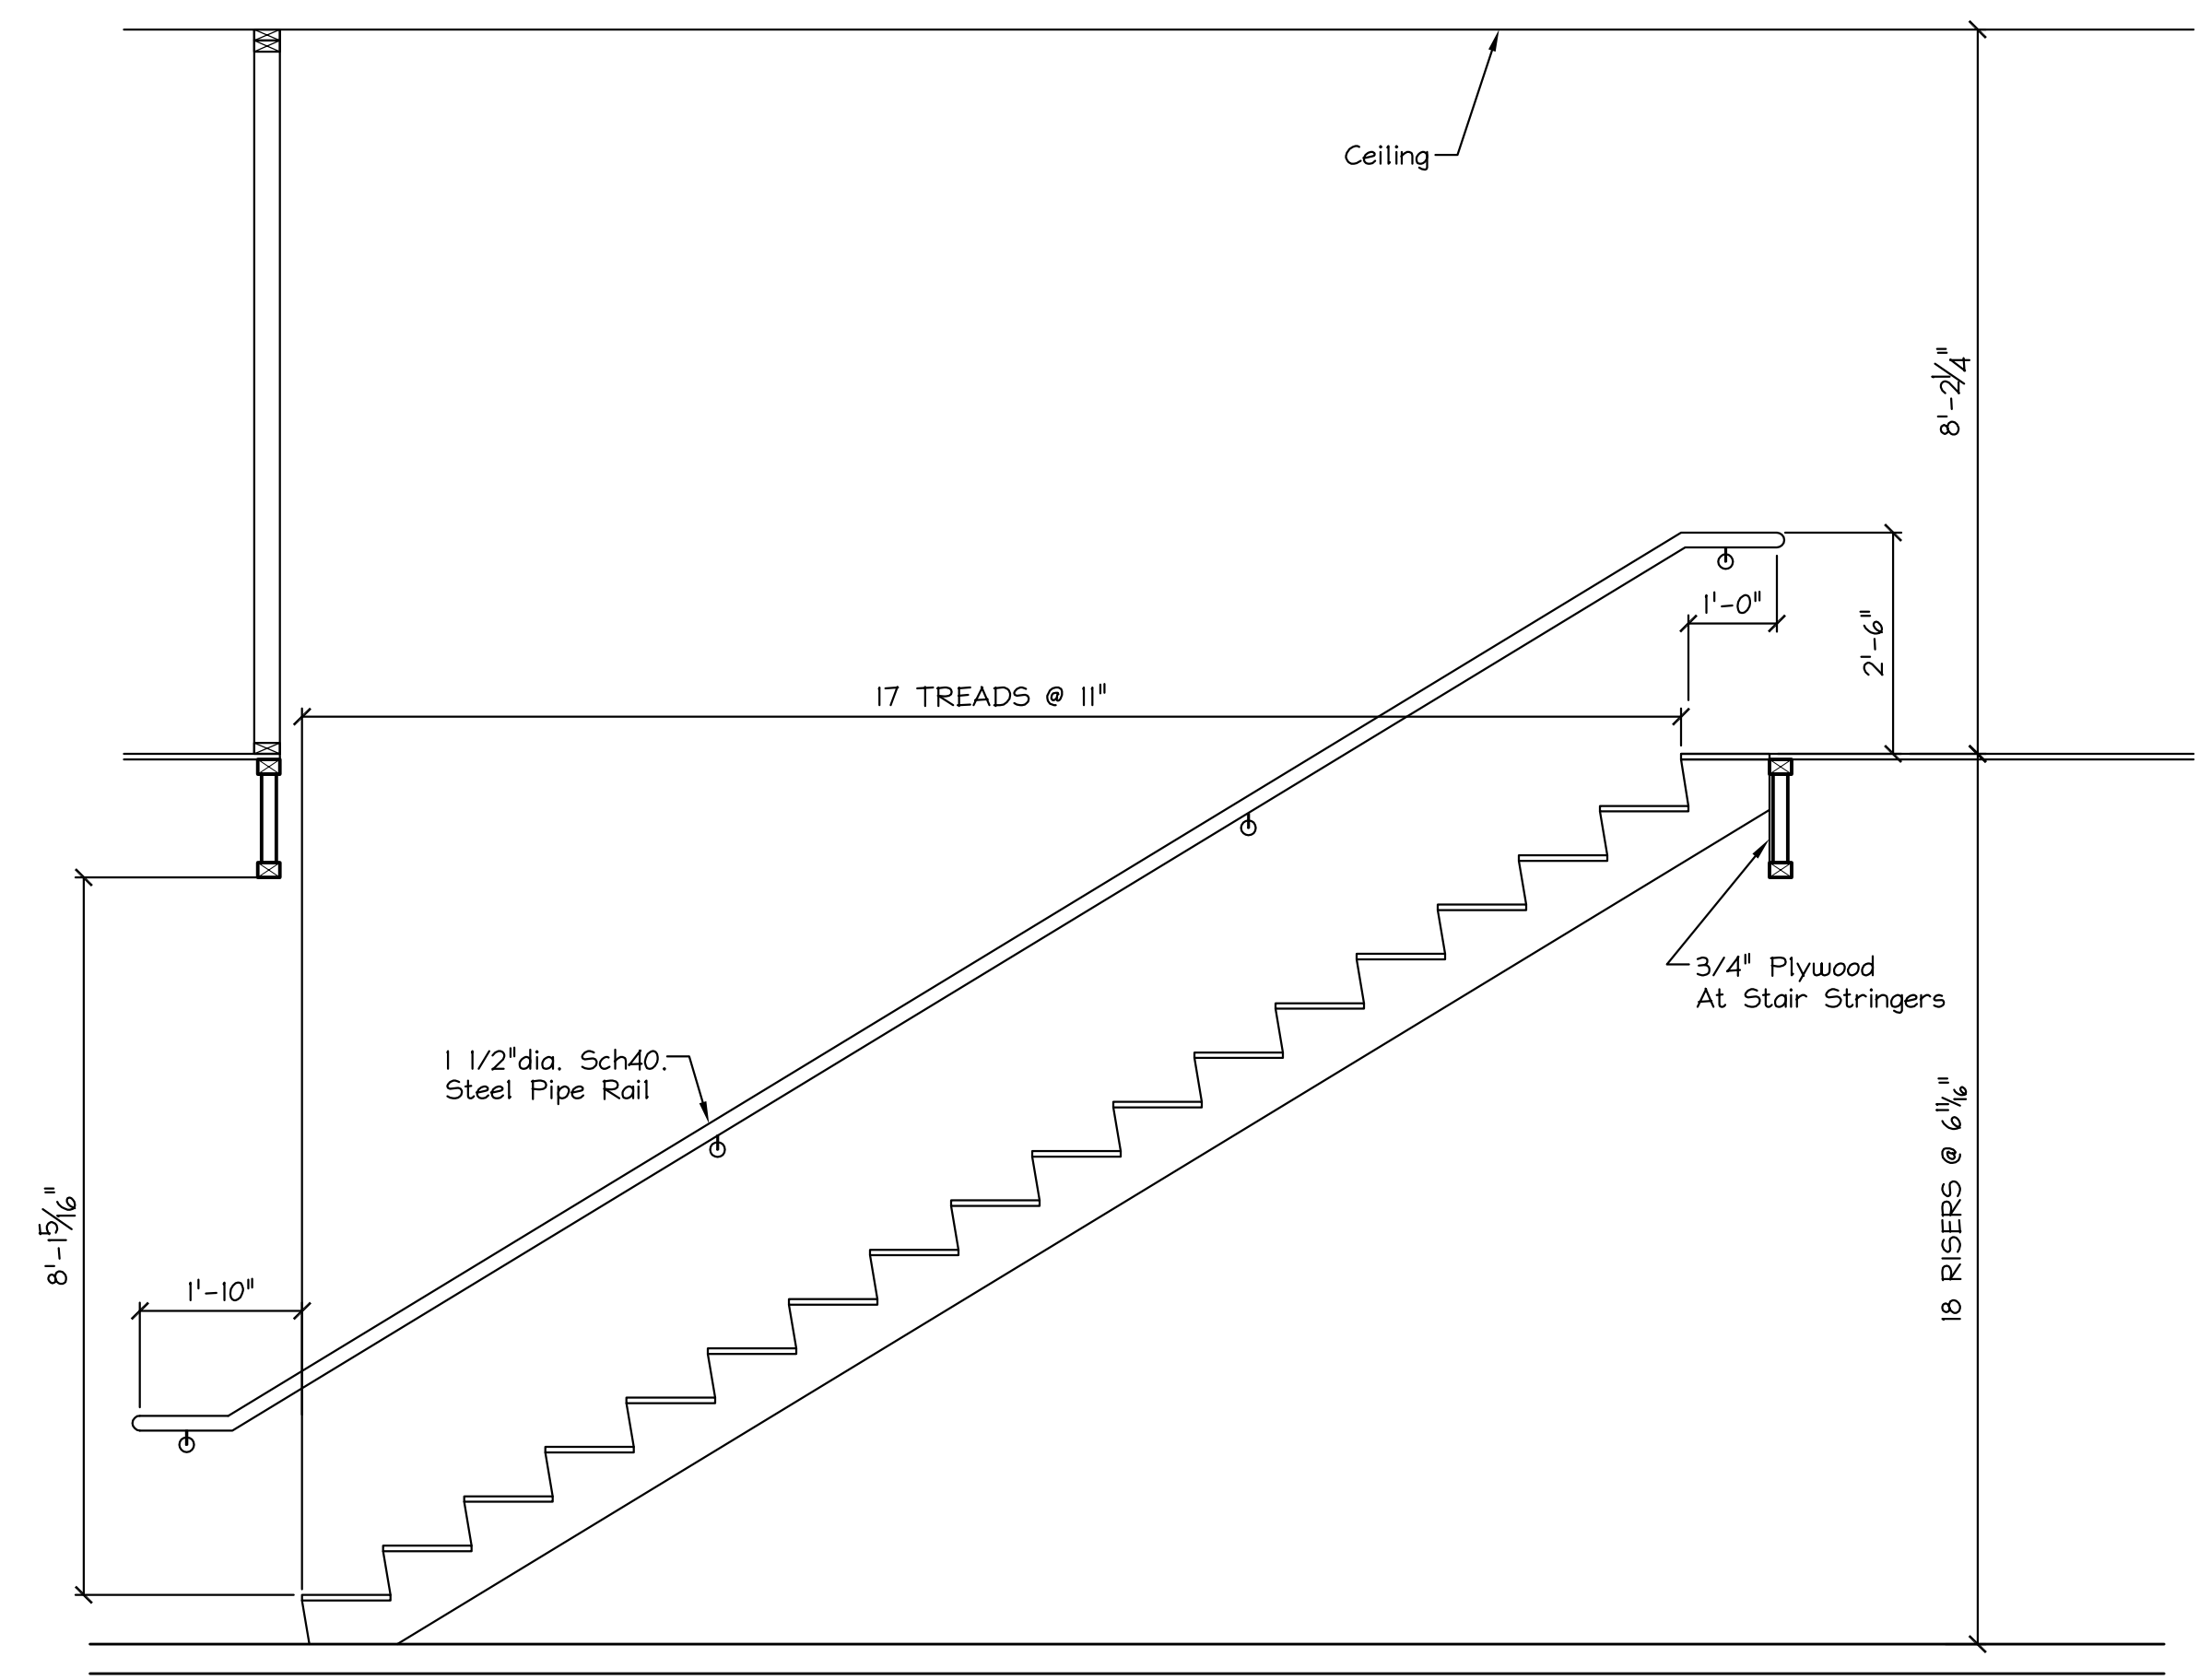

Typical Stair Detail

EXISTING STAIR DETAIL
SCALE: 1/2" = 1'-0"

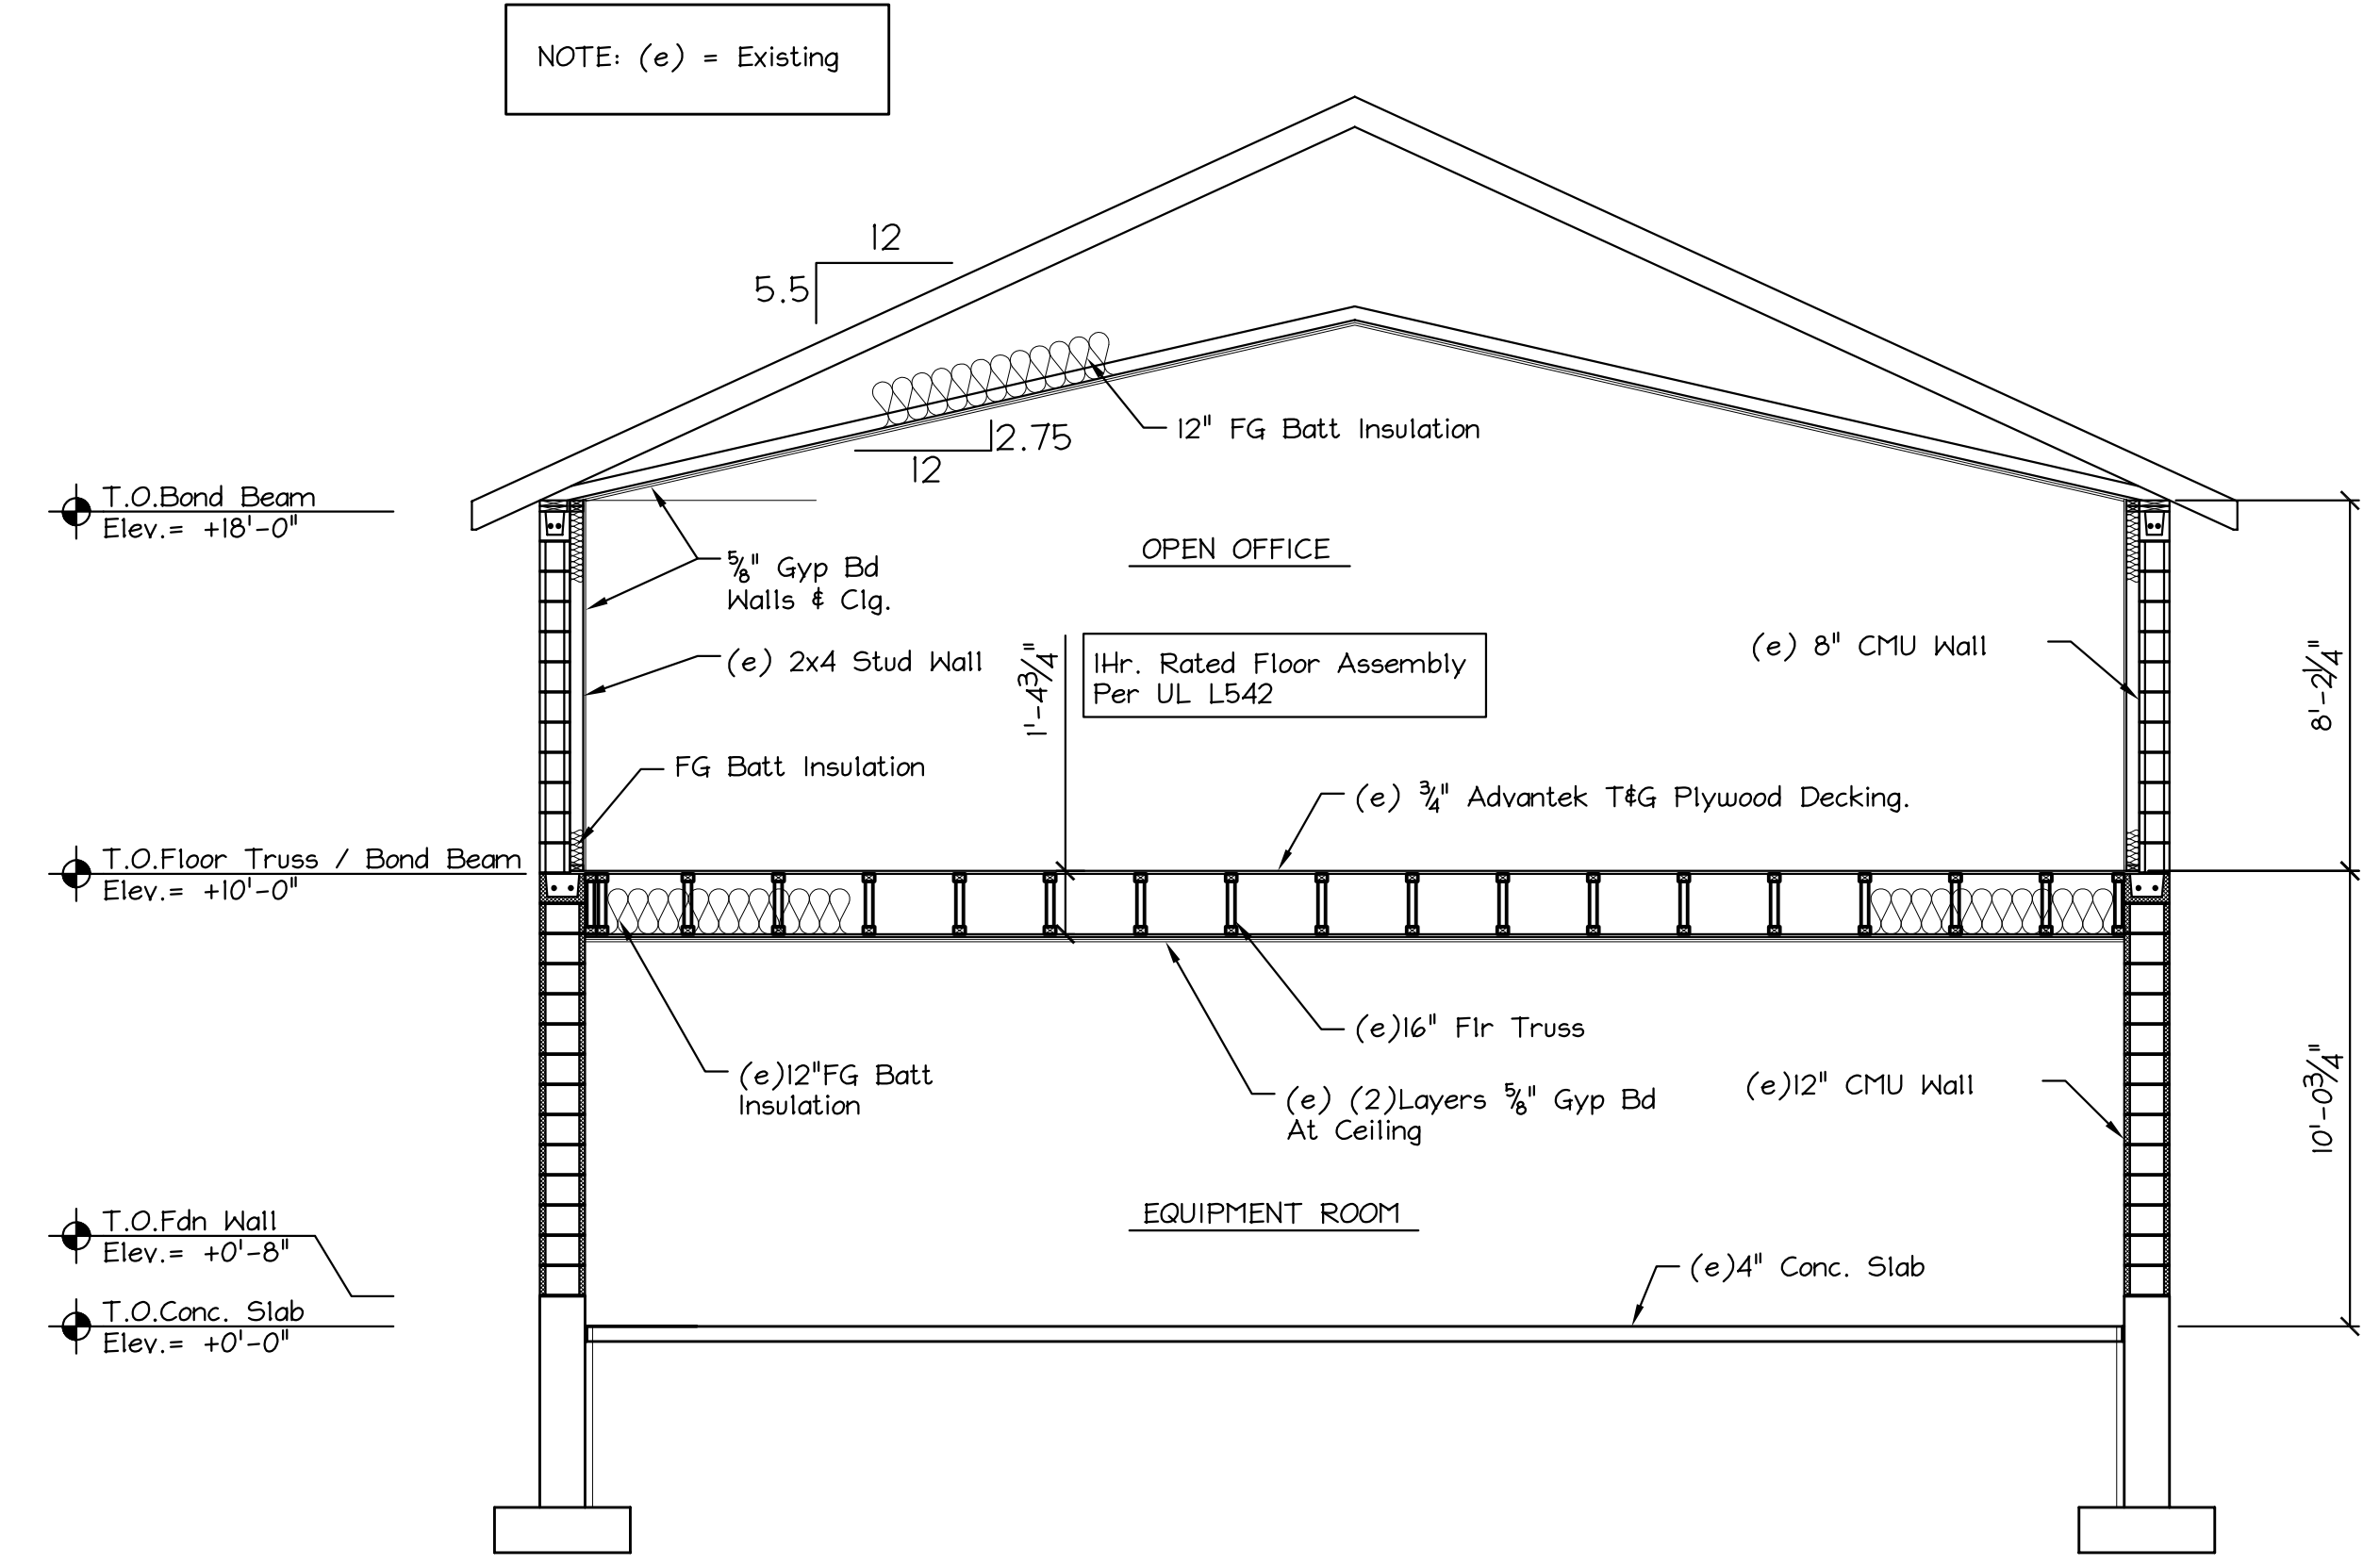

SECTION
SCALE: 1/4" = 1'-0"

MacLeod
Structural Engineers, PA
404 Main Street, Gorham, Maine 04038 207.839.0880
Moody's Collision Center
Presumpscot Street
Portland, Maine
LIGHT GAGE METAL FRAMING
TITLE: DETAILS
DATE: 01/10/13 DRAWN BY: BIM DRAWING NUMBER:
SCALE: as noted PROJ NO: 2013-109 A3