
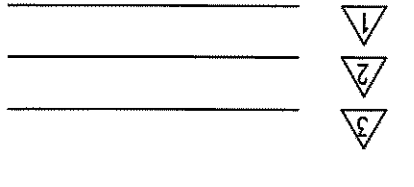


SCALE: as noted	PROJ. NO. 2015-293
DATE: 1/15/16	DRAWN BY: BMM
DRAWING NUMBER: S2.0	
TITLE: ROOF FRAMING PLAN	
PORTLAND, MAINE	
Moody's Building Addition	
MACLEOD	
STRUCTURAL ENGINEERS, P.A. 90 Bridge Street Suite 202 Westbrook, Maine 04092 207.539.0990	

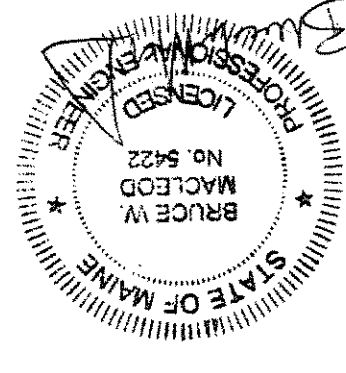

FOR PERMIT - 2/19/16


Roof Framing Notes

Underside Of Truss Elev. = Varies (See Building Sections)

All Wood Trusses Are At 24"o.c. Spacing.
See Sheets 57 Thru 59 For Truss Profiles.

See Archt. Dwg. For Additional Information.
NOTE: Verify All Wall Opening Locations/Size
And Locate Exhaust Fans Per Owner.
For Additional Notes & Schedules, See Dwg. S1.
Indicates Span Direction Of 5/8" CDX

NOTE: Structural Precast Size/Design By Others

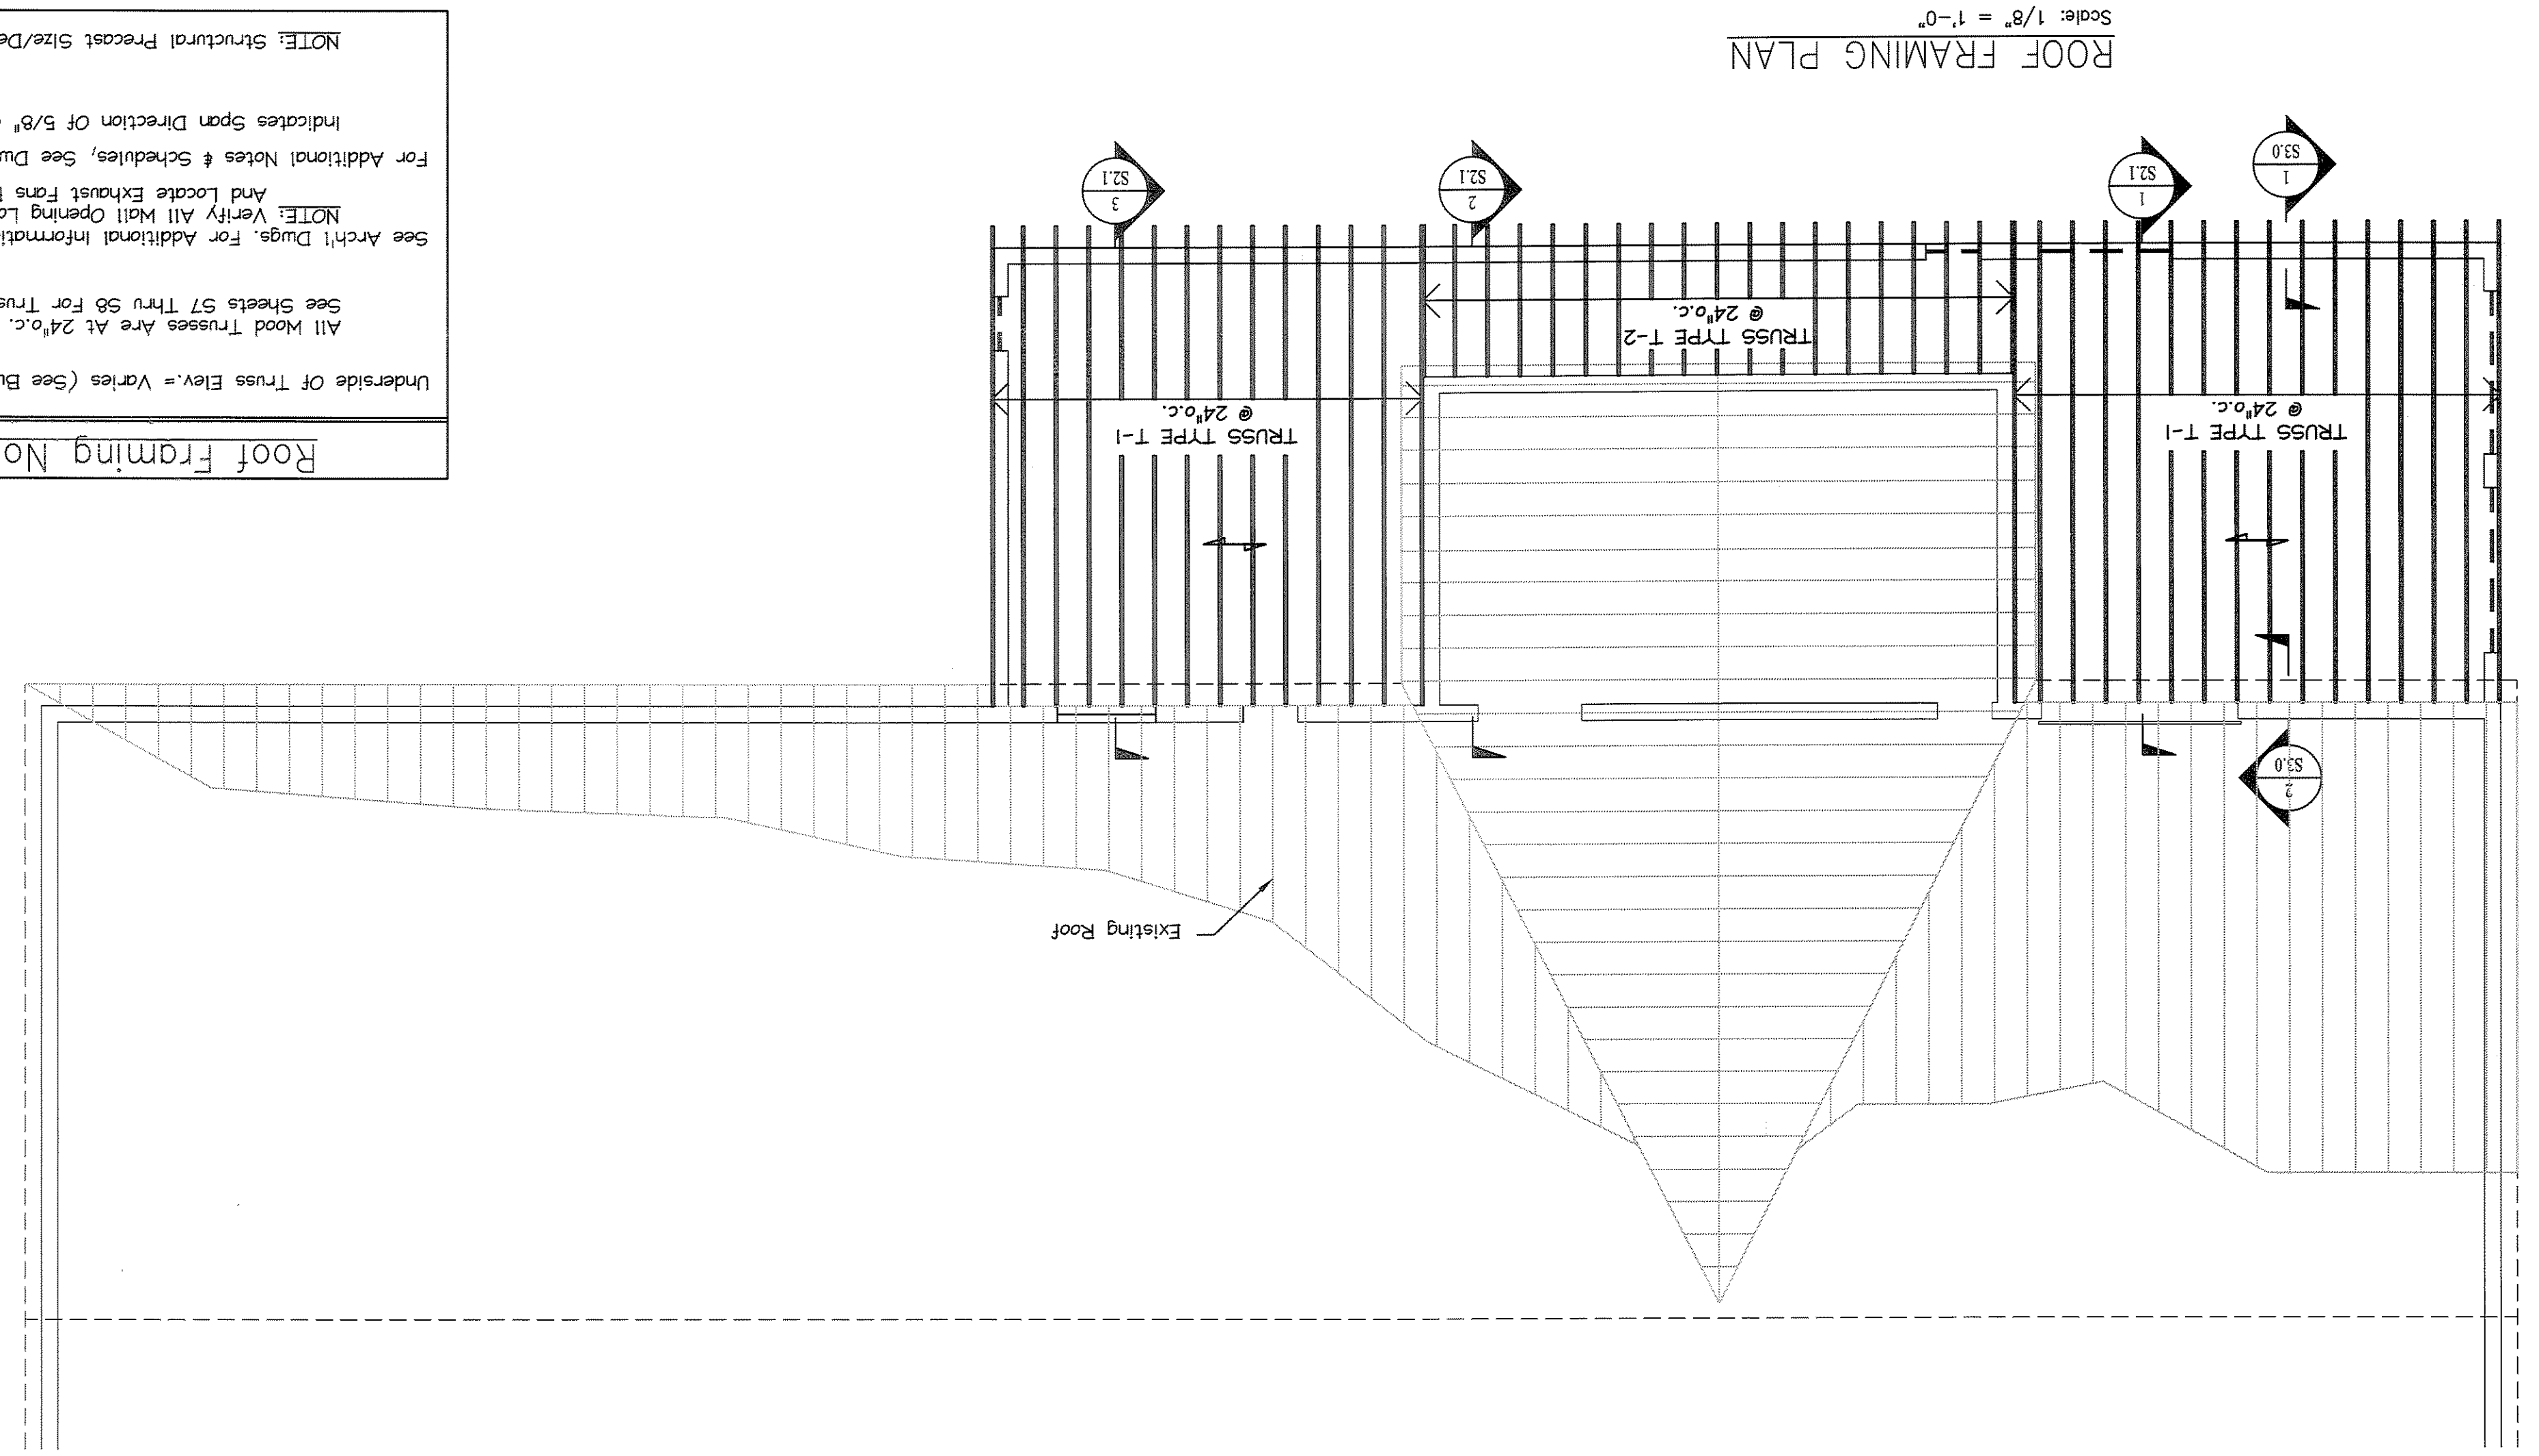

Scale: 1/8" = 1'-0"
ROOF FRAMING PLAN