

NOTE: CONTRACTOR SHALL INSTALL EROSION CONTROL BLANKETS SUCH AS CURLEX 11 EROSION CONTROL BLANKET FROM AMERICAN EXCELSIOR COMPANY OR APPROVED EQUAL ON ALL ALL 2:1 SLOPES.

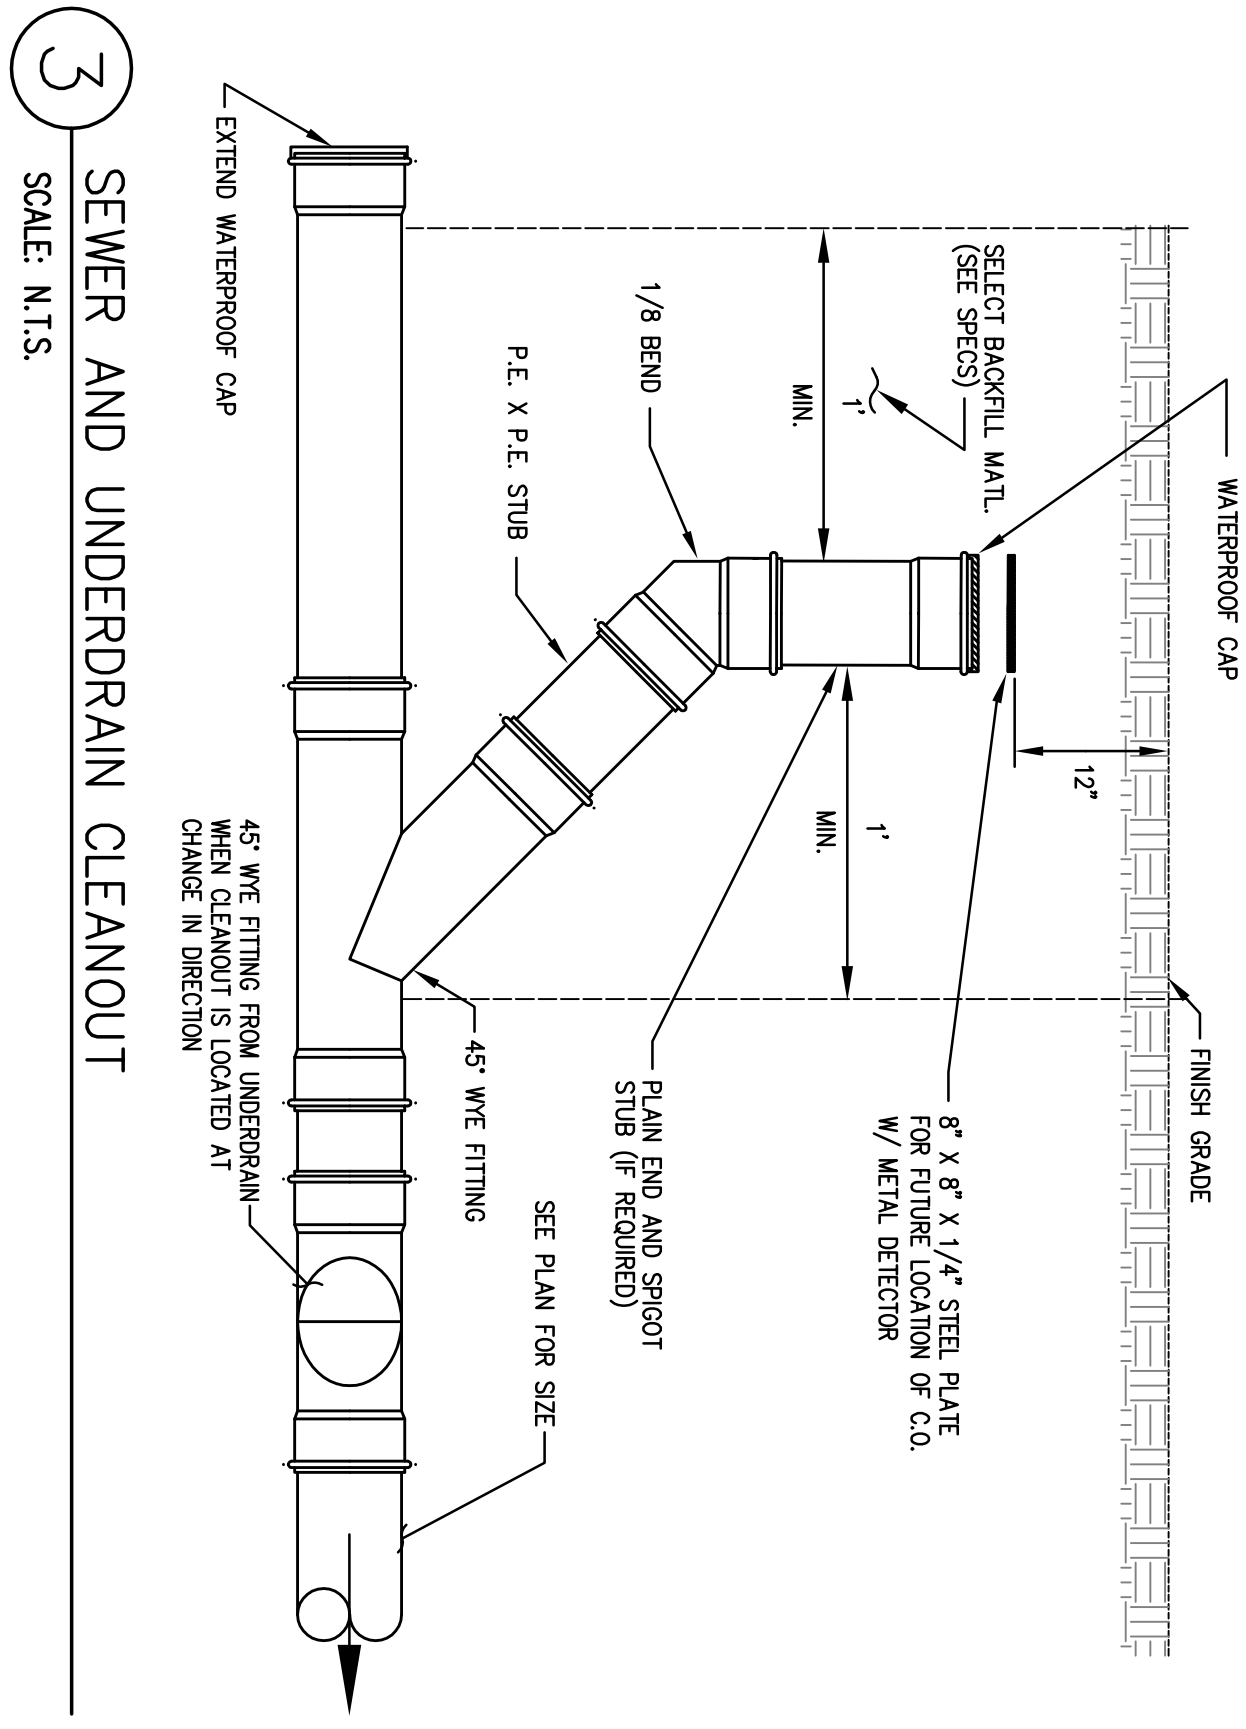
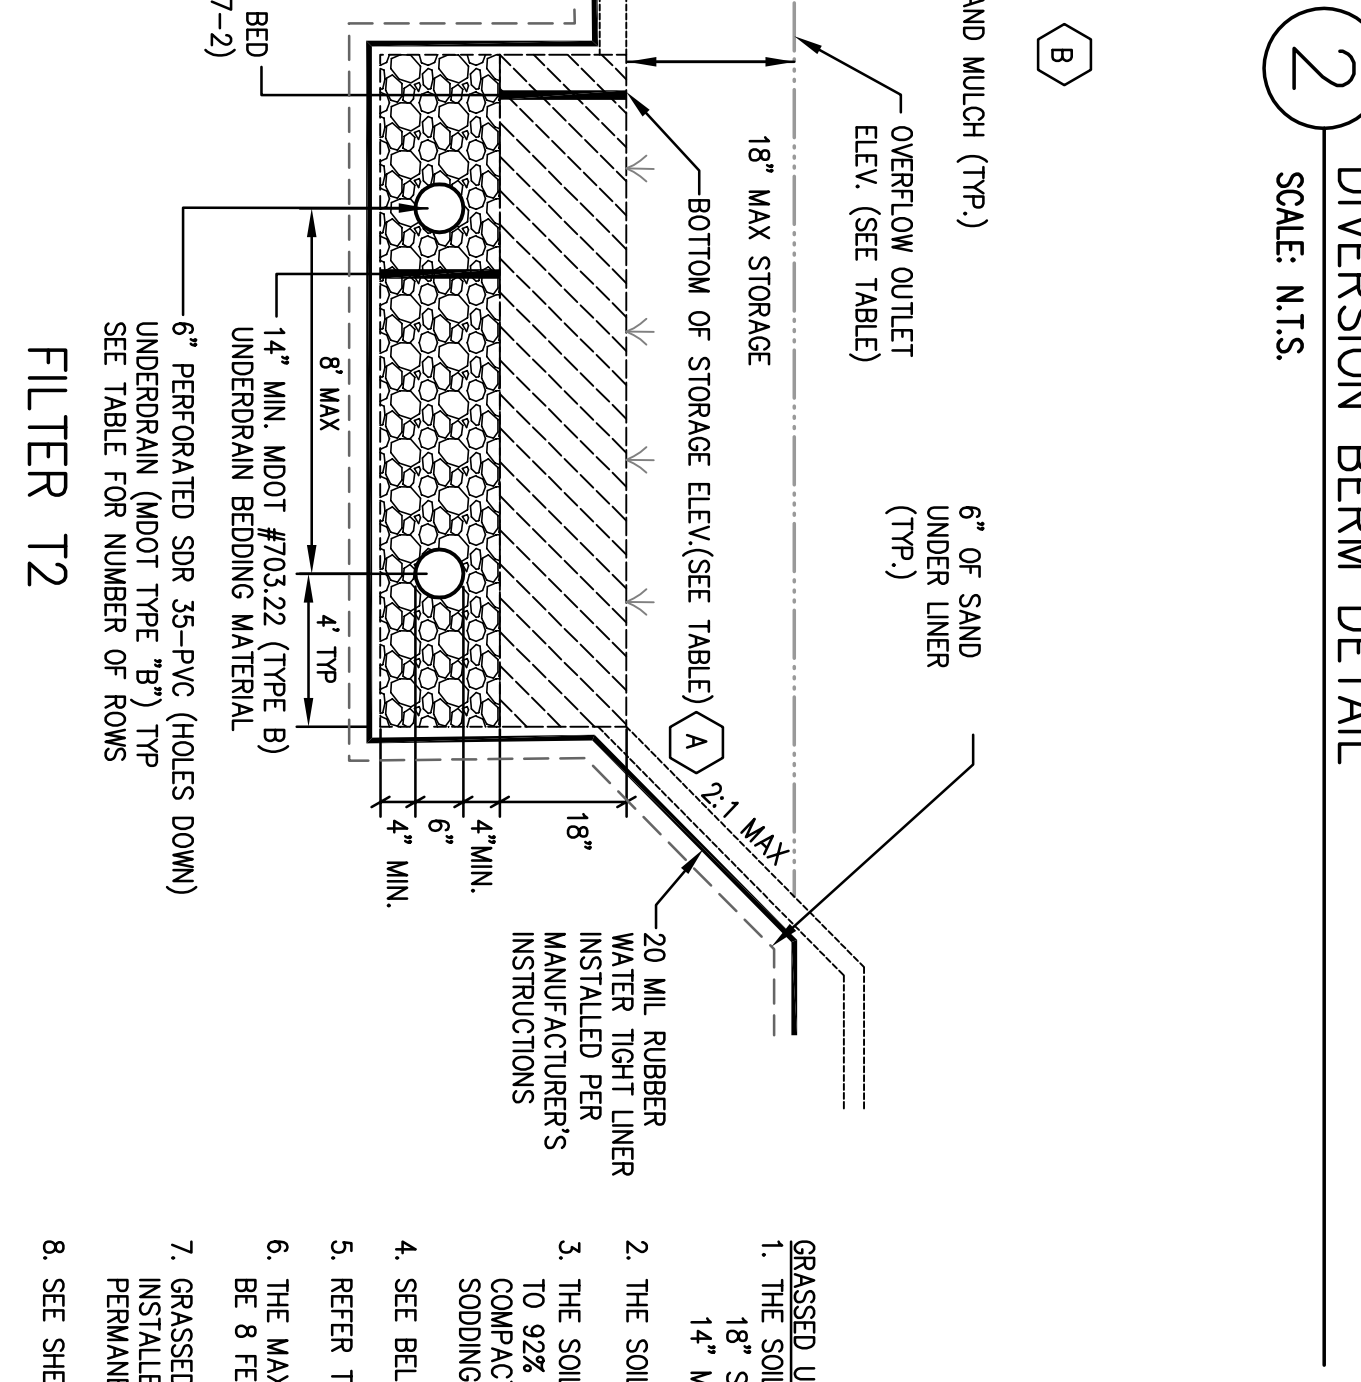
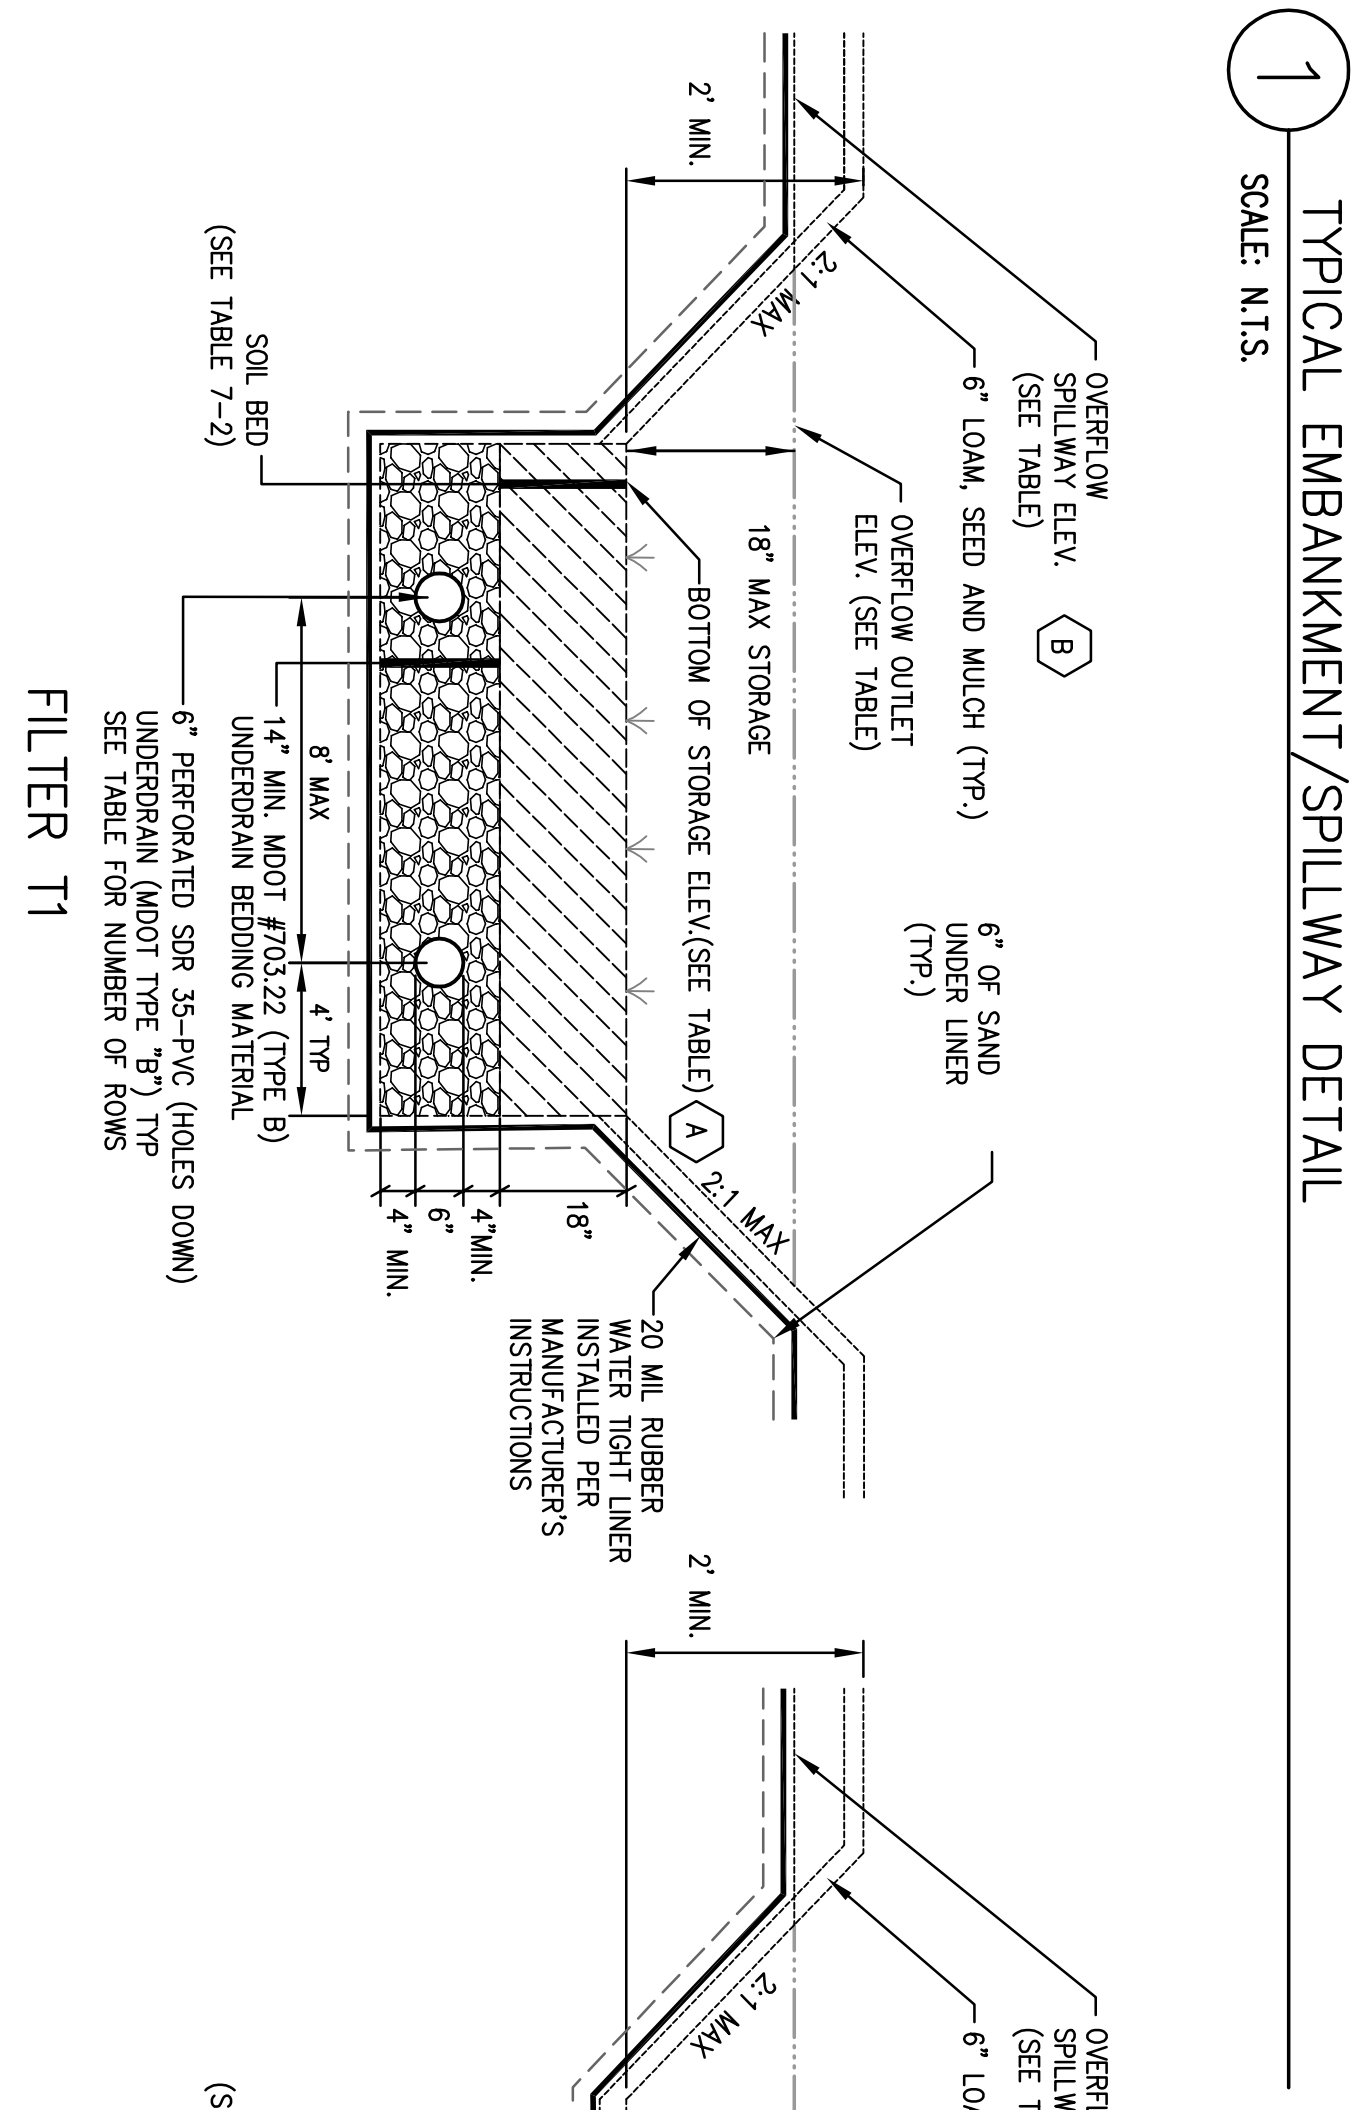
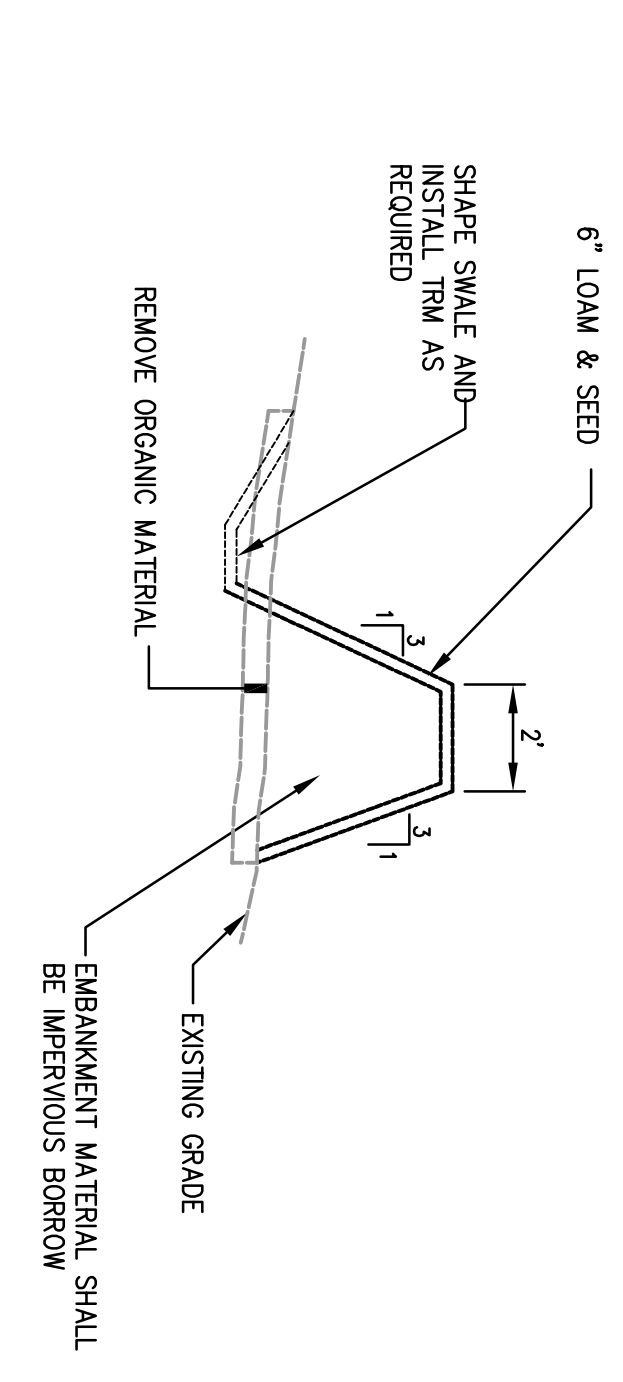
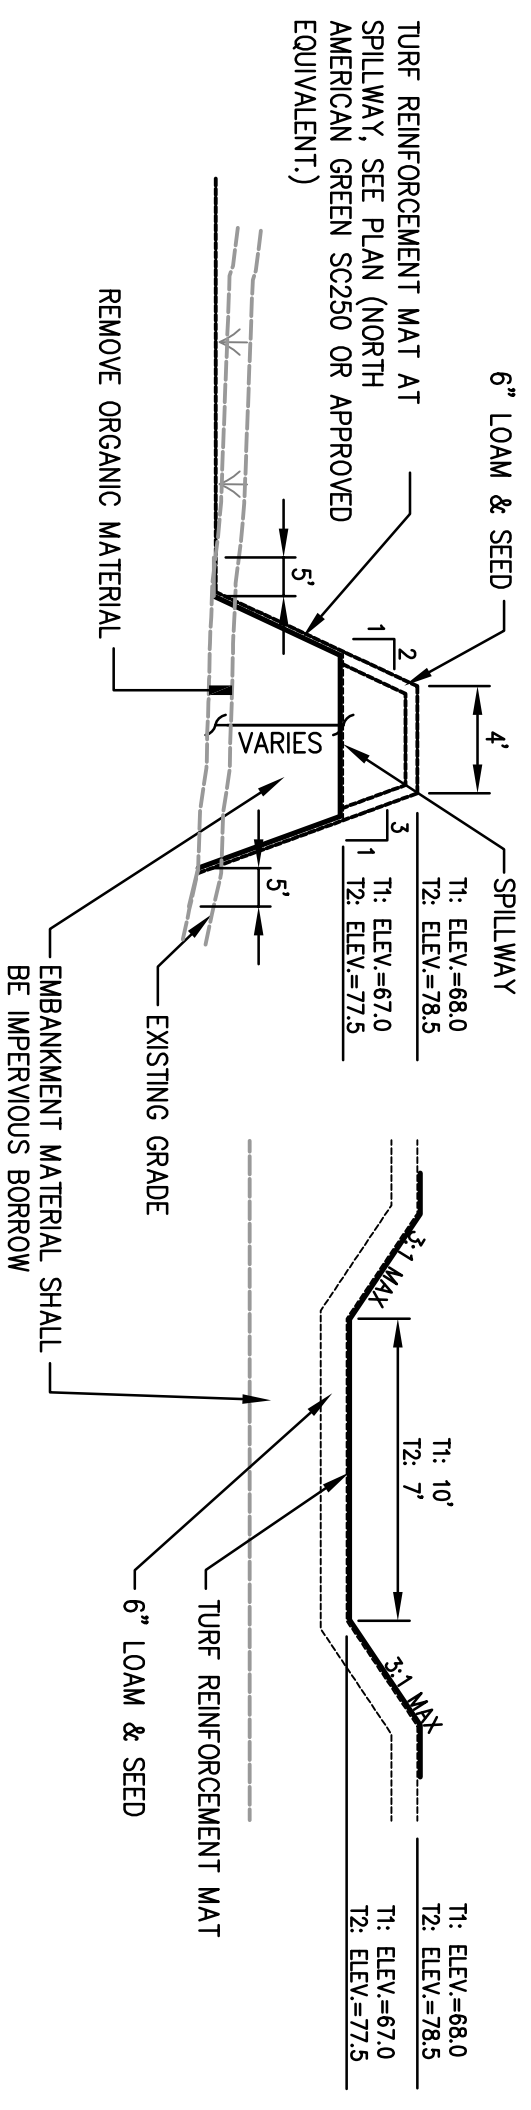


Table 7-1  
MDOT Specifications for Underdrains (MDOT #703.22)



Stew Size	Underdrain Type B	% by Weight
1"	90-100	
1 1/2"	75-100	
#4	50-100	
#20	15-80	
#50	0-15	
#200	0-5	

Table 7-2  
Soil Filter Media, 18" Deep

Filter Media	Mixture by Volume	Specification
Sand	50%-55%	MDOT Specification #703.01 Fine Aggregate for Concrete (see table 7-3)
Topsoil	20%-30%	Loamy sand topsoil with minimum 25% fines passing the #20 sieve
Mulch	20%-30%	Moderately fine, shredded bark or wood chips (not to exceed 1/2" maximum lump size) with less than 5% passing the 200 sieve

Table 7-3  
MDOT Specifications for Aggregate (MDOT #703.01)

Stew Size	% by Weight
3/8"	100
#4	95-100
#8	80-100
#16	50-85
#30	25-60
#60	10-30
#100	2-10
#200	0-5

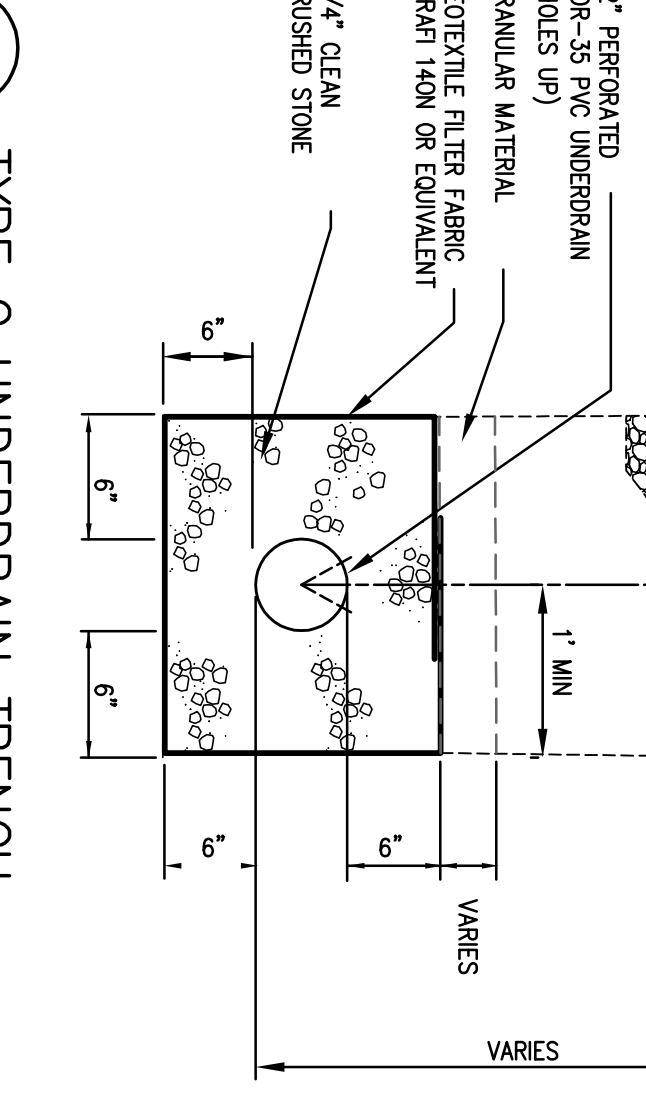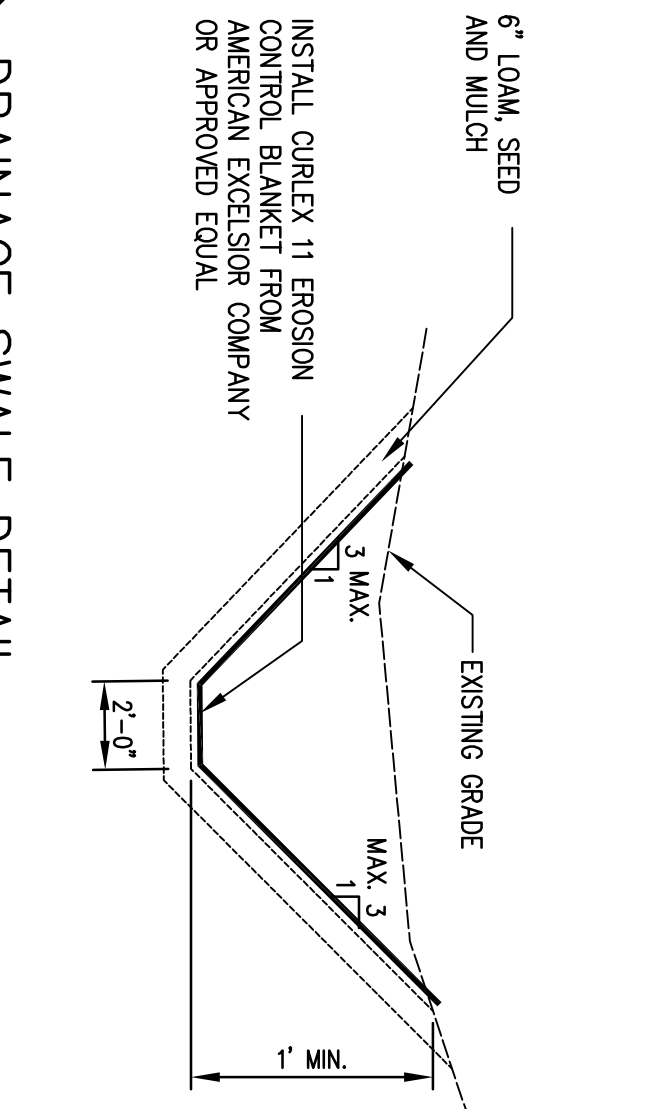


REV.	DATE	BY	CHKD.	APPD.	REV.	DATE	STATUS
A	1/01/13	DEPT.	PBB	TWS			
B	1/9/13	DEPT.	PBB	PBB			
C	2/8/13	DEPT.	PBB	TWS			
D	2/19/13	DEPT.	PBB	TWS			

REVISIONS AND ISSUED TO THE CITY OF PORTLAND FOR FINAL SUBDIVISION REVIEW

ISSUED TO THE CITY OF PORTLAND FOR FINAL SUBDIVISION REVIEW

ISSUED TO THE TOWN OF FALMOUTH FOR PRELIMINARY PLAN REVIEW

SUBMITTED TO CITY OF PORTLAND FOR WORKSHOP STATUS

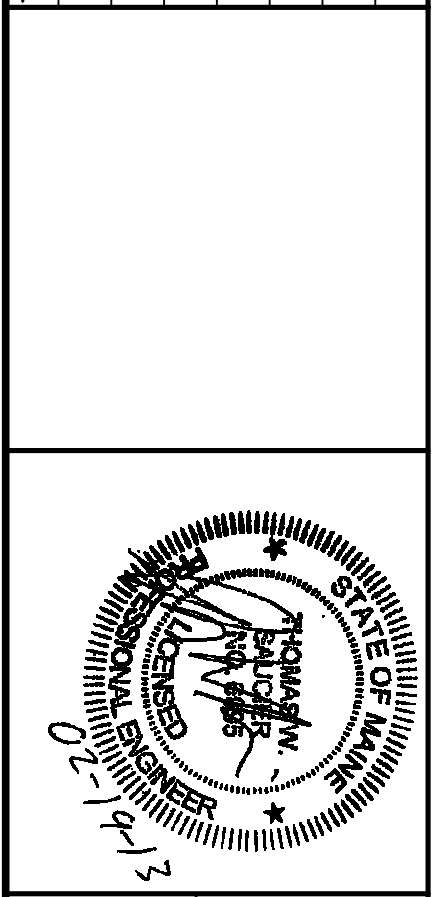

LAND DESIGN SOLUTIONS  
LAND PLANNING, SITE PLANNING & LANDSCAPE ARCHITECTURE

TPO PROPERTIES, LLC  
30 LEDGENWOOD DRIVE, FALMOUTH, MAINE 04104

DESIGN: PBB  
DRAWN: DEPT

CHKD: PBB

DATE: MAY 2012

SCALE: AS NOTED

PROJ. NO. C-302

DWG. NO. C-302

REV. D

OLD BARN ESTATES  
1082 OCEAN AVENUE, PORTLAND, MAINE

SITE DETAILS