

GRASSED UNDERDRAINED SOIL FILTER NOTES:

1. THE SOIL BED SHALL CONSIST OF THE FOLLOWING: 18" SOIL FILTER BED (SEE TABLE 7-2) 14" MDOT #703.22 (TYPE B) (SEE TABLE 7-1)

- 2. THE SOIL BED SHALL BE 18 INCHES IN DEPTH.
- 3. THE SOIL BED MATERIAL SHALL BE LIGHTLY COMPACTED (90% TO 92% STANDARD PROCTOR) USING WATER. IF HEAVY COMPACTION OCCURS, ROTOTILL AGAIN PRIOR TO SEEDING OR SODDING.
- 4. SEE LANDSCAPE PLAN FOR SEEDING INFORMATION.
- 5. REFER TO GRADING PLANS FOR UNDERDRAIN LAYOUT.
- 6. THE MAXIMUM DISTANCE BETWEEN UNDERDRAIN PIPES SHALL BE 8 FEET.
- 7. GRASSED UNDERDRAINED SOIL FILTER MEDIA SHALL NOT BE INSTALLED UNTIL THE TRIBUTARY AREA HAS BEEN PERMANENTLY STABILIZED.


## GRASSED UNDERDRAINED SOIL FILTER - TYP. CROSS SECTION SCALE: N.T.S.

GRASSED UNDERDRAINED SOIL FILTER SCHEDULE											
	Grassed Underdrained Soil Filter Filter #	BOTTOM ELEV.	FILTER LENGTH	OVERFLOW OUTLET	ROWS OF PIPE PER FILTER	UNDERDRAIN INVERT	UNDERDRAIN OUTLET INVERT	PEAK WATER ELEVATION			
								2 YEAR STORM	10 YEAR STORM	25 YEAR STORM	50 YEAR STORM
	T1	65.5	110'	67.0	2	63.2	63.1	67.1	67.3	67.3	67.3
	T2	76.0	106'	77.5	2	73.7	73.5	77.3	77.7	77.7	77.8

Table 7—1 MDOT Specifications for Underdrains (MDOT #703.22)					
Sieve Size	% by Weight				
Underdrain Type B					
1"	90–100				
1/2"	75–100				
#4	50-100				
#20	15-80				
#50	0–15				
#200	0-5				

S	Table 7-2 Soil Filter Media, 18" Deep (Option 2)					
Filter Media	Mixture by Volume	Specification				
Sand	50%-55%	MDOT Specification #703.01 Fine Aggregate for Concrete (see Table 7-3)				
Topsoil	20%-30%	Loamy sand topsoil with minimal clay content and between 15 to 25% fines passing the #200 sieve				
Mulch	20%-30%	Moderately fine, shredded bark or wood fiber mulch(organic material — well composed with no manure or stump grindings) with less than 5% passing the 200 sieve				


Table 7-3 MDOT Specifications for Aggregate (MDOT #703.01)					
Size	% by Weight				
	100				
	95–100				
	80-100				
	50-85				
	25-60				
	10-30				
	2–10				
	0-5				
	Aggregate (M				

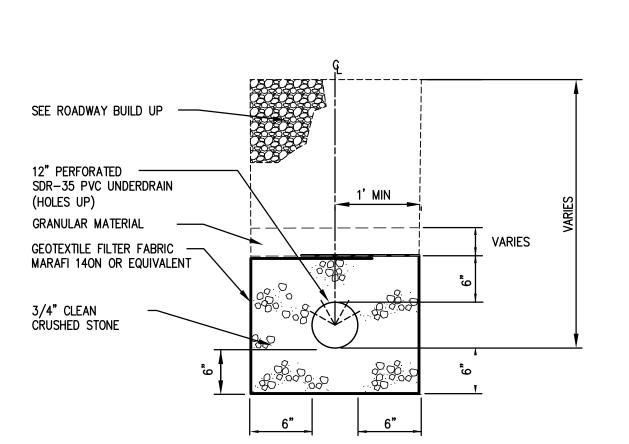




1/01/13

REV. DATE

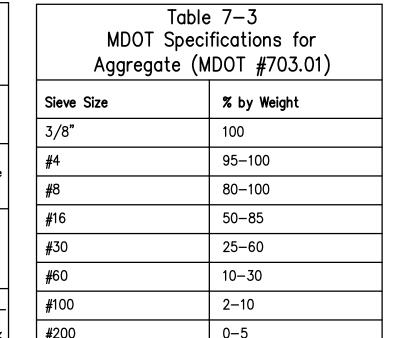

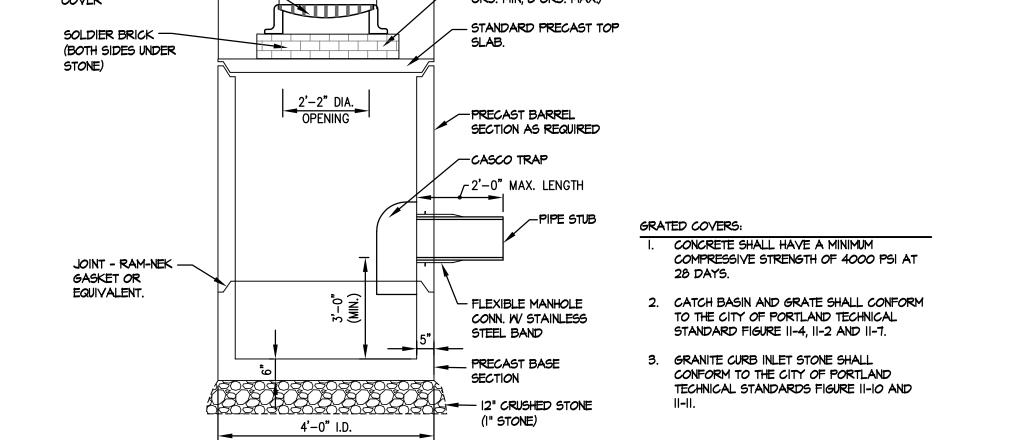





STANDARD CITY OF

TYPE "D" FRAME AND

PORTLAND CATCH BASIN

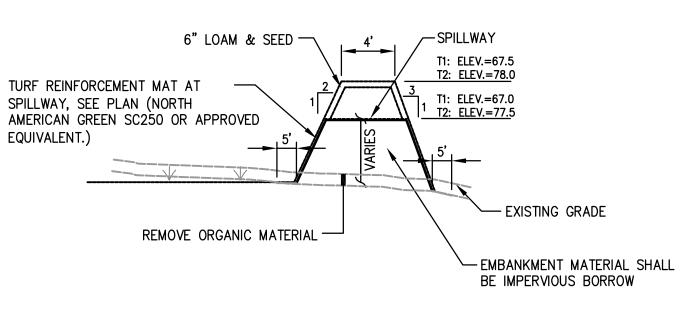



TYPICAL EMBANKMENT/SPILLWAY DETAIL

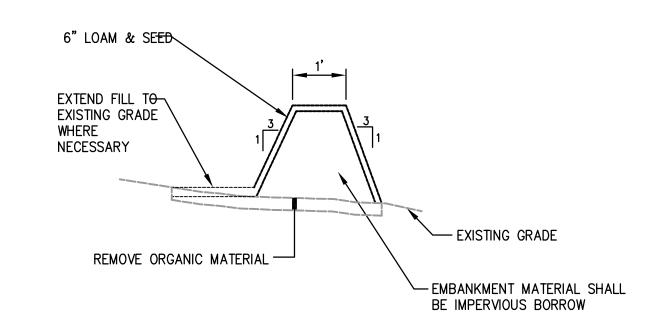

INTERCEPTOR SWALE DETAIL SCALE: N.T.S.

I. CONSTRUCT LEVEL LIP ON ZERO PERCENT GRADE TO

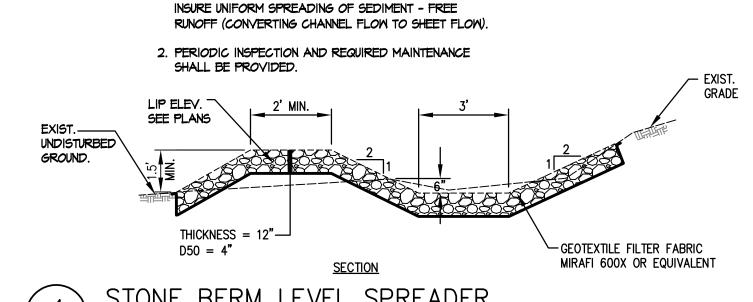

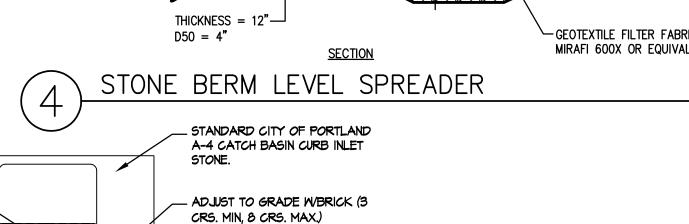

\*\*\* EXCAVATED MATERIAL MUST BE REVIEWED AND APPROVED BY THE OWNER'S REPRESENTATIVE PRIOR TO INSTALLATION.

GRANULAR MATERIAL TO BE SAND OR GRAVEL. TYPICAL TRENCH SECTION

COPPER

TRENCH BACKFILL SCHEDULE

PIPE MATERIAL | PIPE BEDDING

3/4" CRUSHED

3/4" CRUSHED

GRANULAR MATERIAL

STONE

TPO PROPERTIES, LLC

30 LEDGEWOOD DRIVE, FALMOUTH, MAINE 04104

SCALE: N.T.S.		
LAND DESIGN SOLUTIONS	DESIGN: PBB	OLD BARN ESTATES  1062 OCEAN AVENUE, PORTLAND, MAINE
LAND PLANNING, SITE PLANNING & LANDSCAPE ARCHITECTURE	DRAWN: DEPT.	1002 002/11 /(1002, 10/12/1140, 14/1142
P.O. Roy 316 160 Languageds Road Cumbaniand ME 04081 to 1/207) 636 1717	CHKD: PBB	SITE DETAILS
P.O. Box 316, 160 Longwoods Road, Cumberland, ME 04081 tel:(207) 939-1717		SITE DETAILS

DATE: MAY 2012

SCALE: AS NOTED

— OBSERVATION RISER (LEBARON

COVER OR APPROVED EQUAL)

(SOLID WALL)

UNDERDRAIN BACKFILL

- UNPAVED AREAS

& PIPE AND TRENCH

- 6" LOAM (SEED AND MULCH)

- SIDE OF TRENCH MAY BE

SLOPED BACK TO MEET

SAFETY REQUIREMENTS

WHERE EXTRA WIDTH IS

- TRENCH WIDTH SHALL BE

GRANULAR OR CRUSHED

MAINTAINED TO TOP OF

STONE BACKFILL

MAX TRENCH WIDTH "A"

C - 302

4.0

4.0

5.0 5.0 5.0 5.0

6.0

POSSIBLE

- DEPTH VARIES

MATERIAL

I. DIMENSION "B" SHALL BE SUFFICIENT TO ALLOW CRUSHED STONE BEDDING TO BE PLACED AND COMP-CTED UNDER THE

PIPE DIAMETER "D"

2. PIPE TRENCH INSTALLATION SHALL CONFORM TO THE CITY OF PORTLAND TECHNICAL STANDARDS FIGURE II-12.

HAUNCHES OF THE PIPE; BUT IN ALL CASES THE DIMENSION SHALL BE AT LEAST 9".

FINISH GRADE

- SUBGRADE

L-825 TOP W/ L-09-CD

- FINISH GRADE

GRANULAR -

45° WYE (SOLID -

UNDERDRAIN CLEANOUT

PAVED AREAS -

OVER SEWER, ROOF DRAINS OR WATER PIPE B

PAVEMENT BUILDUP

SEE APPROPRIATE

TYPICAL PAVEMENT

SECTION

COMMON BACKFILL FROM TRENCH-

GRANULAR BORROW (IF ORDERED).

EXCAVATION (INCIDENTAL) OR

PROVIDE 2 LAYERS OF 2" RIGID

STYROFOAM INSULATION IF COVER

IS LESS THAN 5', STAGGER JOINTS

3/4" CRUSHED STONE OR

SAND 12" ABOVE PIPE.

PIPE SIZE AS NOTED -

3 /4" CRUSHED STONE

PIPE BEDDING TO

ESTABLISH TRENCH

2" CRUSHED STONE

INITIAL BACKFILL

3/4" CRUSHED

3/4" CRUSHED

GRANULAR MATERIAL

STONE

STONE

BACKFILL

\*\*\*EXCAVATED MATERIAL

\*\*\*EXCAVATED MATERIAL

\*\*\*EXCAVATED MATERIAL

\*\*\*EXCAVATED MATERIAL

OR GRANULAR BORROW

NO.

DWG. NO.

OR GRANULAR BORROW

OR GRANULAR BORROW

OR GRANULAR BORROW

SPRINGLINE.

PROFILE

ON PLANS

MATERIAL

6" UNDERDRAIN —

GEOTEXTILE FILTER FABRIC -

SCALE: N.T.S.

JUTE PACKING —

