


SUBDIVISION DRIVE TURNAROUND

PAVED AREAS

NOTE: CONTRACTOR TO VERIFY UTILITY INSTALLATION WITH APPROPRIATE UTILITY COMPANY PRIOR TO INSTALLATION. FINISH GRADE-COMPACTED BACK FILL-PLASTIC CABLE MARKER -CONTINUOUS IN TRENCH (12" BELOW GRADE). 2" CABLE TV — PRIMARY ELECTRIC CABLE -USE 4" DIA. SCHED. 40 PVC ELECT. CONDUIT UNDER PAVED AREAS AND 6" MIN. WHEN DEPTH OF BURY IS - COMMUNICATION CABLE USE 4" PVC (SCHED. WHEN DEPTH OF BURY IS 40) CONDUIT FOR MAIN CABLES AND 2" PVC LESS THAN 2'-6" 6" MIN. SEPARATION — (SCHED. 40) CONDUIT FOR SERVICE FEEDS UNDER PAVED AREAS. SECONDARY OR SERVICE CABLE — USE 2" (MIN.) DIA. SCHED. 40 PVC ELECT. CONDUIT UNDER


TRENCH SECTION - ELECTRIC, TELEPHONE/CABLE scale: N.T.S.

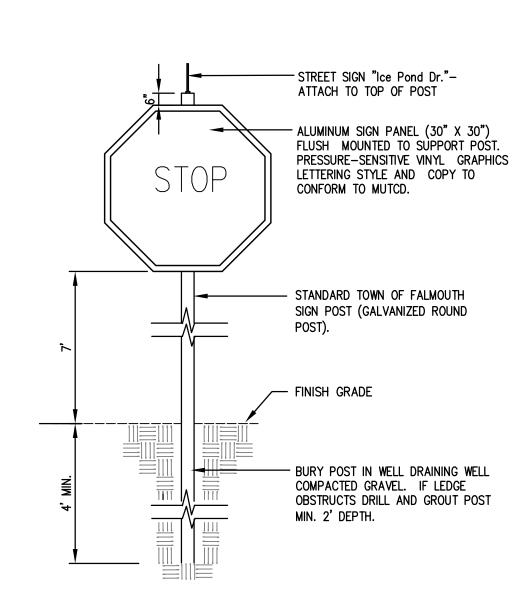

STOP SIGN AND STREET SIGN SCALE: N.T.S.

NOTES:

- I. CROSSMALKS SHALL CONFORM TO THE REQUIREMENTS OF THE AMERICANS WITH DISABILITIES ACT AND ALL LOCAL CODES AND MUTCD STANDARDS.
- 2. ALL PAINT SHALL BE LEAD FREE, FAST DRYING, 100% ACRYLIC WATERBORNE TRAFFIC PAINT WITH SILICA SAND FOR SKID RESISTANCE, MEETING THE REQUIREMENTS OF TT-P-1952E TYPE I & II. PAINT SHALL BE APPLIED AS SPECIFIED BY THE MANUFACTURER.
- 3. TOWN OF FALMOUTH ENGINEER TO APPROVE THE LAYOUT OF CROSSWALKS PRIOR TO PAINTING.

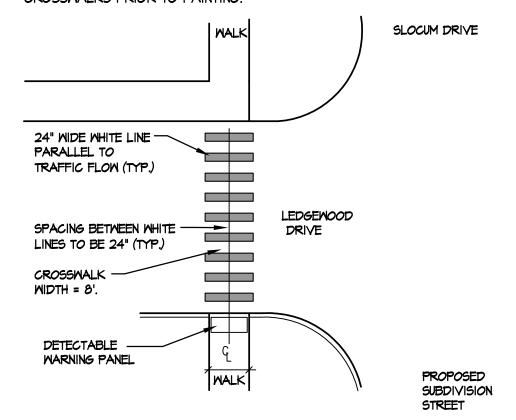


PAINTED CROSSWALK


SCALE: NTS

NOTES


- I. DIMENSIONS ARE SUBJECT TO CHANGE IN FIELD. ALL SLOPES AND DIMENSIONS TO COMPLY WITH A.D.A. REQUIREMENTS.
- 2. CONTRACTOR TO INSTALL 24" WIDE DETECTABLE WARNING STRIP PER ADA GUIDELINES AND THE TOWN OF FALMOUTH. PANEL TO BE THE DURALAST, CAST IRON PANEL WITH A NATURAL FINISH BY EJ COMPANY, MATCHING PANELS USED IN THE COMPLETED LEDGEWOOD DRIVE RECONSTRUCTION PROJECT.
- 3. CONCRETE PANELS SHALL BE CAST IN PLACE, 5" THICK AND MEET SPECIFICATIONS FOR MAINE D.O.T. CLASS A STRUCTURAL CONCRETE, MINIMUM COMPRESSIVE STRENGTH 4,000 PSI. CONCRETE SHALL BE SEALED PRIOR TO SETTING PANELS. THE EXPOSED CONCRETE BORDER SHALL RECEIVE A GROOVED EDGE BETWEEN THE PANEL AND THE CONCRETE, ALONG WITH A UNIFORM BROOM FINISH PERPENDICULAR TO TRAFFIC FLOW.

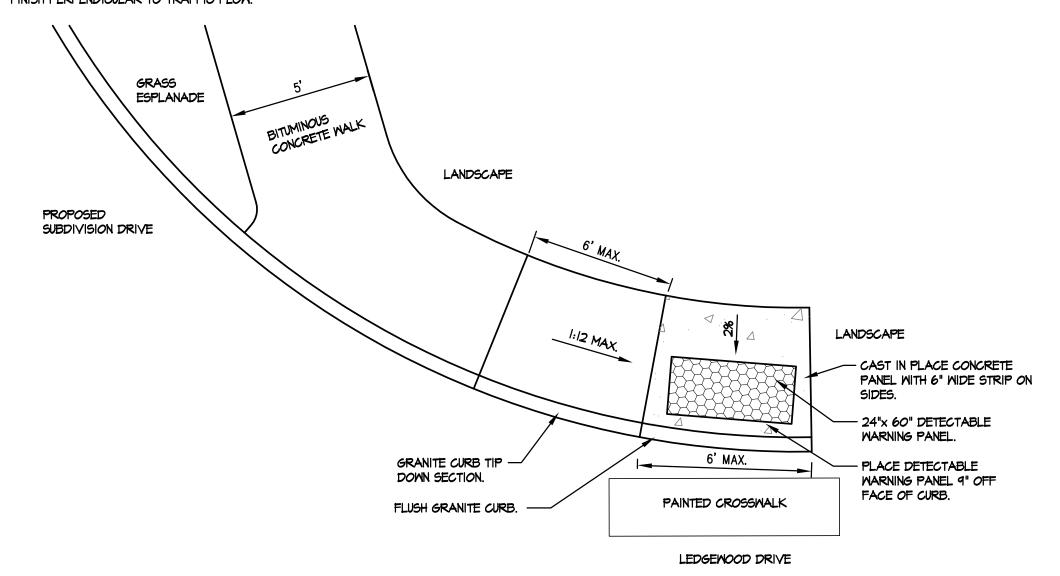

SIDEWALK RAMP DETECTABLE WARNING PANEL

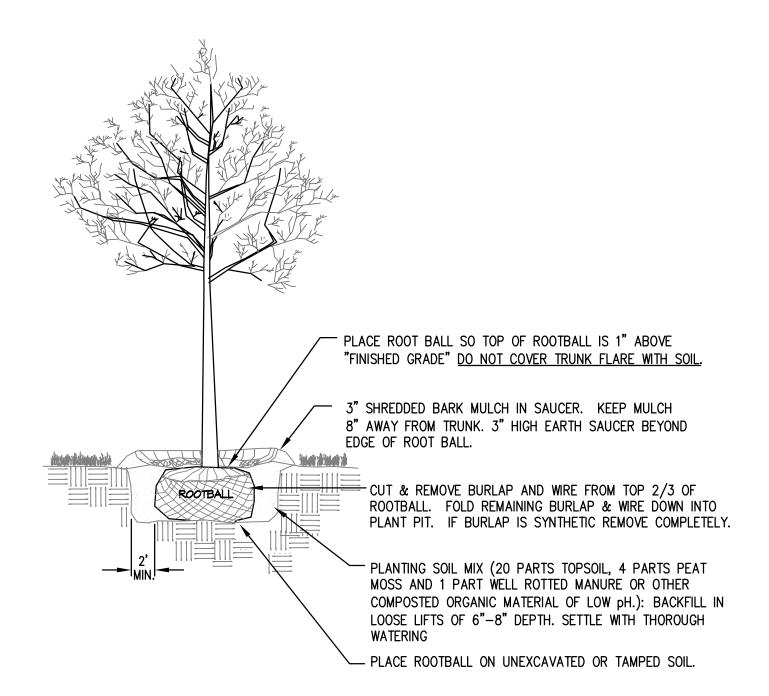


6 DECIDUOUS TREE PLANTING
SCALE: NTS

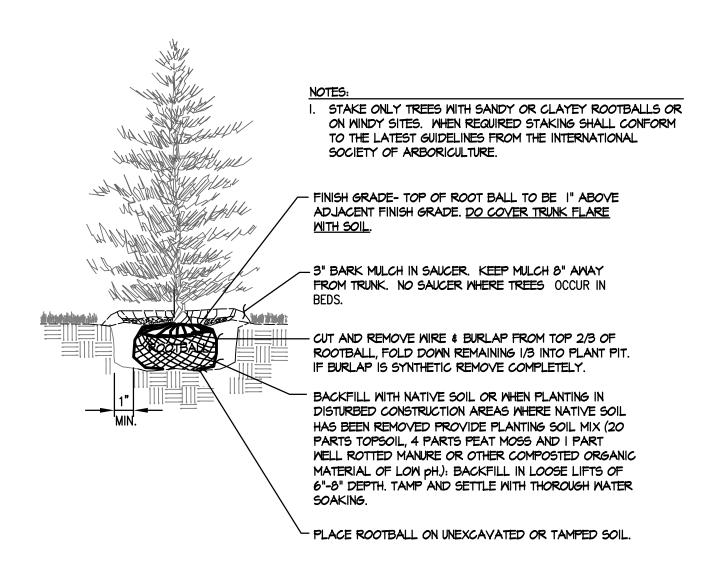

EVERGREEN TREE PLANTING

С	4/11/13	REVISED PEDESTRIAN WALKWAY ASSOCIATED DETAIL	DEPT.	PBB	TWS						
В	3/4/13	ISSUED TO THE TOWN OF FALMOUTH FOR FOR FINAL SUBDIVISION REVIEW	DEPT.	PBB	TWS						
Α	2/8/13	ISSUED TO THE CITY OF PORTLAND FOR FINAL SUBDIVISION REVIEW	DEPT.	PBB	PBB						
REV.	DATE	STATUS	BY	CHKD.	APPD.	REV.	DATE	STATUS	BY	CHKD.	APPD.

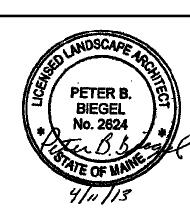

LAND DESIGN SOLUTIONS	DESIGN: PBB	OLD BARN ESTATES				
LAND PLANNING, SITE PLANNING & LANDSCAPE ARCHITECTURE	DRAWN: DEPT.	1062 OCEAN AVENUE, PORTLAND, MAINE				
P.O. Box 316, 160 Longwoods Road, Cumberland, ME 04081 tel:(207) 939-1717	CHKD: PBB		SITE DETAILS			
CLIENT:	1					
TPO PROPERTIES, LLC	DATE: MAY 2012	PROJ. NO.	– REV.			
30 LEDGEWOOD DRIVE, FALMOUTH, MAINE 04104	SCALE: AS NOTED	DWG.	C-304			