


NOTE: CONTRACTOR SHALL INSTALL EROSION CONTROL BLANKETS SUCH AS CURLEX 11 EROSION CONTROL BLANKET FROM AMERICAN EXCELSIOR COMPANY OR APPROVED EQUAL

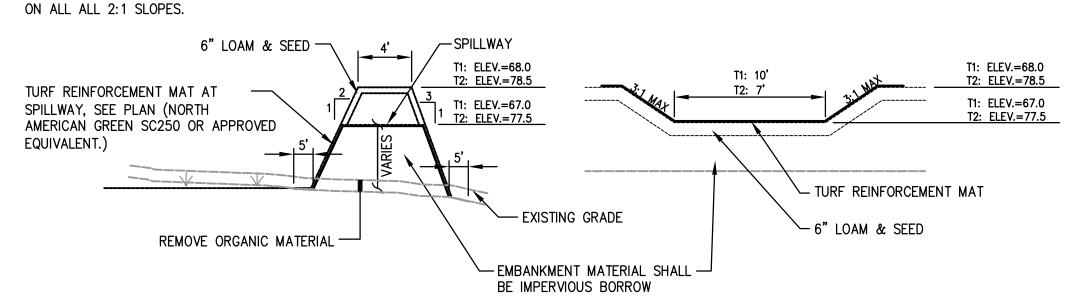

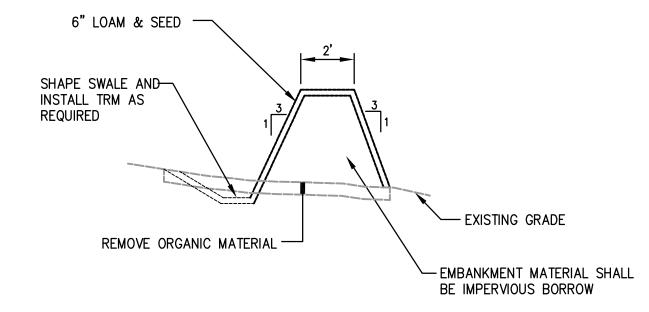

1) TYPICAL EMBANKMENT/SPILLWAY DETAIL SCALE: N.T.S.

DIVERSION BERM DETAIL SCALE: N.T.S.

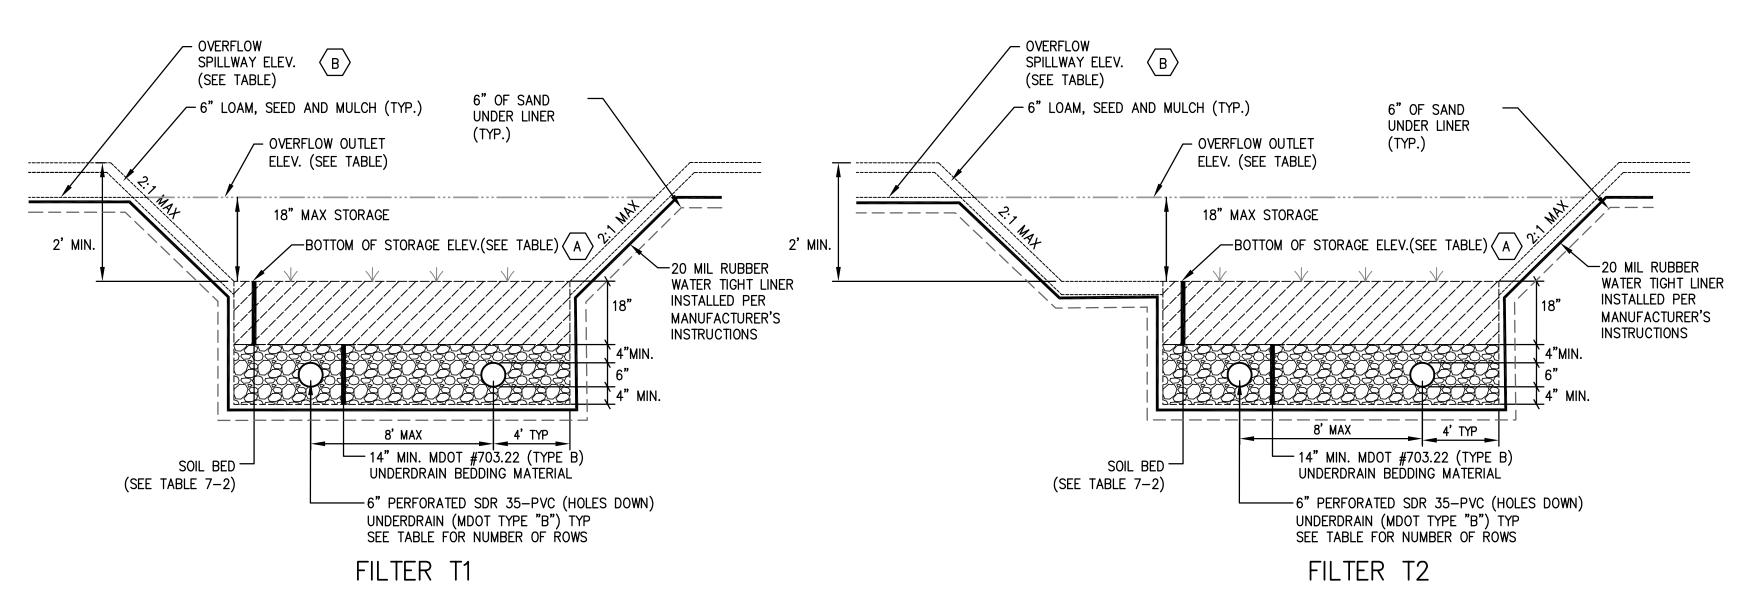


GRASSED UNDERDRAINED SOIL FILTER NOTES:

1. THE SOIL BED SHALL CONSIST OF THE FOLLOWING:

18" SOIL FILTER BED (SEE TABLE 7-2)


14" MDOT #703.22 (TYPE B) (SEE TABLE 7-1)

- 2. THE SOIL BED SHALL BE 18 INCHES IN DEPTH.
- 3. THE SOIL BED MATERIAL SHALL BE LIGHTLY COMPACTED (90% TO 92% STANDARD PROCTOR) USING WATER. IF HEAVY COMPACTION OCCURS, ROTOTILL AGAIN PRIOR TO SEEDING OR SODDING
- 4. SEE BELOW FOR SEEDING INFORMATION.
- 5. REFER TO GRADING PLANS FOR UNDERDRAIN LAYOUT.
- 6. THE MAXIMUM DISTANCE BETWEEN UNDERDRAIN PIPES SHALL BE 8 FEET.
- 7. GRASSED UNDERDRAINED SOIL FILTER MEDIA SHALL NOT BE INSTALLED UNTIL THE TRIBUTARY AREA HAS BEEN PERMANENTLY STABILIZED.
- 8. SEE SHEET C-201 FOR EXTENTS OF FILTER MEDIA.

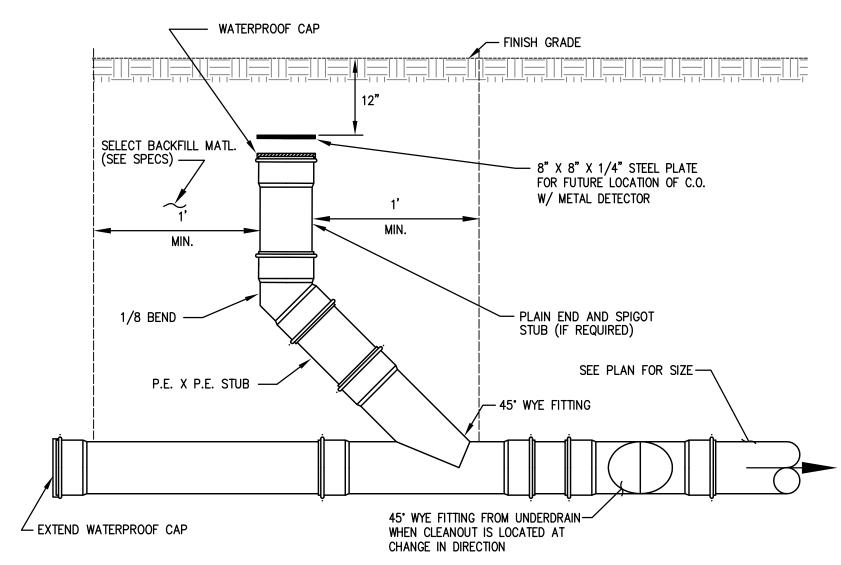

SEWER AND UNDERDRAIN CLEANOUT SCALE: N.T.S.

- NOTES:
 1. CONSTRUCT LEVEL LIP ON ZERO PERCENT GRADE TO INSURE UNIFORM SPREADING OF SEDIMENT FREE RUNOFF (CONVERTING CHANNEL FLOW TO SHEET FLOW).
- 2. PERIODIC INSPECTION AND REQUIRED MAINTENANCE SHALL BE PROVIDED.
- 3. TURF REINFORCEMENT MAT IS A SUITABLE SUBSTITUTE FOR RIPRAP. PROVIDE SPECIFICATIONS TO ENGINEER FOR APPROVAL.

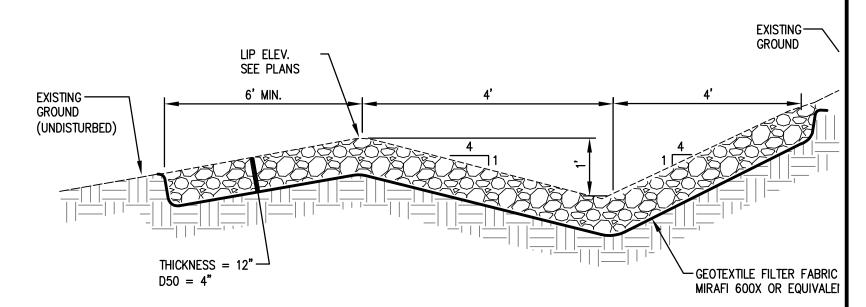

RIPRAP LEVEL SPREADER - TYPICAL SECTIONS

GRASSED UNDERDRAINED SOIL FILTER - TYP. CROSS SECTION SCALE: N.T.S.

	GRASSED UNDERDRAINED SOIL FILTER SCHEDULE										
	GRASSED UNDERDRAINED SOIL FILTER	BOTTOM ELEV.	FILTER	OVERFLOW OUTLET	ROWS OF PIPE PER	UNDERDRAIN INVERT	UNDERDRAIN OUTLET		PEAK WATER	R ELEVATION	
	FILTER #	$\langle A \rangle$	LENGTH	B	FILTER	IIIVEIXI	INVERT	2 YEAR STORM	10 YEAR STORM	25 YEAR STORM	100 YEAR STORM
	T1	65.5	110'	67.0	2	63.2	63.1	67.1	67.3	67.3	67.4
	T2	76.0	106'	77.5	3	73.7	73.5	77.3	77.7	77.7	77.8

GRASSED UNDERDRAINED SOIL FILTER SEEDING NOTES:


1. THE SOIL BED SHALL BE SEEDED WITH THE CONSERVATION II
MIX AS MIXED AND PACKAGED BY SEEDWAY, LLC AND
DISTRIBUTED BY R.E. BELANGER & SON OF LEWISTON, MAINE
(207) 576-5845 OR APPROVED EQUIVALENT.


- 2. CONSERVATION II MIX IS COMPRISED OF THE FOLLOWING PLANT SPECIES:
- 25% CREEPING RED FESCUE20% PERENNIAL RYEGRASS
- 20% ANNUAL RYEGRASS
- 15% K-31 TALL FESCUE15% KENTUCKY BLUEGRASS

5% WHITE CLOVER

3. SEEDING RATE PER THE DISTRIBUTOR TO BE 60-70 LBS PER ACRE WHEN BROADCAST.

JION	10	DL	00-7	U	LDS	FLI	`		
								OAM, MUL	

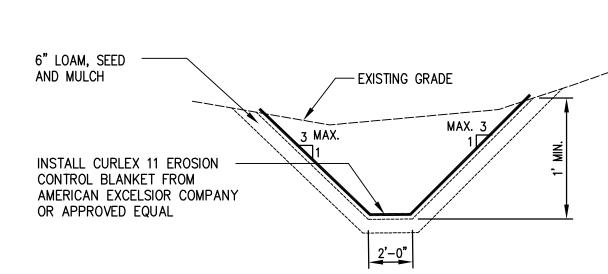

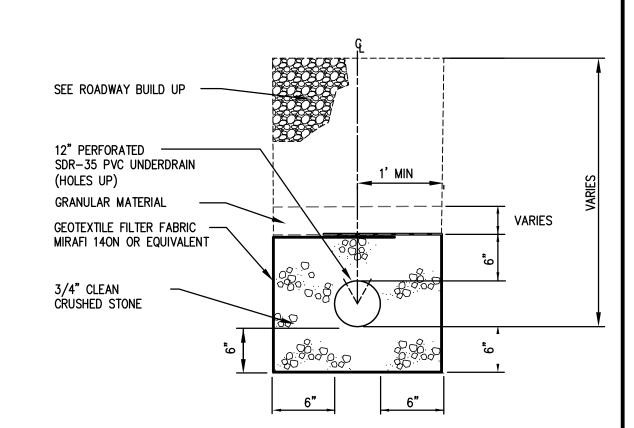

6 DRAINAGE SWALE DETAIL SCALE: N.T.S.

$\overline{7}$	TYPE C	UNDERDRAIN	TRENCH
$\left(\right) / \int$	SCALE: N.T.S	•	


Table 7-1 MDOT Specifications for Underdrains (MDOT #703.22)								
Sieve Size	% by Weight							
Underdrain Type B								
1"	90–100							
1/2"	75–100							
#4	50-100							
#20	15-80							
#50	0–15							
#200	0-5							

Filter Media	Mixture by Volume	Specification
Sand	50%-55%	MDOT Specification #703.01 Fine Aggregate for Concrete (see Table 7-3)
Topsoil	20%-30%	Loamy sand topsoil with minimal clay content and between 15 to 25% fines passing the #200 sieve
Mulch	20%-30%	Moderately fine, shredded bark or wood fiber mulch(organic material well composed with no manure or stump grindings) with less than 5% passing the 200 sieve

Table 7-2

Table 7-3 MDOT Specifications for Aggregate (MDOT #703.01)								
Sieve Size	% by Weight							
3/8"	100							
#4	95–100							
#8	80–100							
#16	50-85							
#30	25-60							
#60	10-30							
#100	2–10							
#200	0-5							

Ē												
Date												
s Plot												
s\Detail	Ε	3/4/13	ISSUED TO THE TOWN OF FALMOUTH FOR FOR FINAL SUBDIVISION REVIEW	DEPT.	PBB	TWS						
an\Dwg	D	2/19/13	REVISED AND ISSUED TO THE CITY OF PORTLAND FOR FINAL SUBDIVISION REVIEW	DEPT.	PBB	TWS						
Donov	С	2/8/13	ISSUED TO THE CITY OF PORTLAND FOR FINAL SUBDIVISION REVIEW	DEPT.	PBB	TWS						
. K:\0	В	1/9/13	ISSUED TO THE TOWN OF FALMOUTH FOR PRELIMINARY PLAN REVIEW	DEPT.	PBB	PBB						
g Name	Α	1/01/13	SUBMITTED TO CITY OF PORTLAND FOR WORKSHOP	DEPT.	PBB	TWS						
Drawin L	REV.	DATE	STATUS	BY	CHKD.	APPD.	REV.	DATE	STATUS	BY	CHKD.	. API

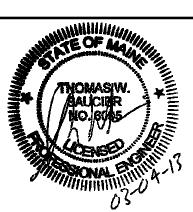

LAND DESIGN SOLUTIONS	DESIGN: PBB	OLD BARN ESTATES	
LAND PLANNING, SITE PLANNING & LANDSCAPE ARCHITECTURE	DRAWN: DEPT.	1062 OCEAN AVENUE, PORTLAND, MAINE	
P.O. Box 316, 160 Longwoods Road, Cumberland, ME 04081 tel:(207) 939-1717	CHKD: PBB	SITE DETAILS	
CLIENT:			
TPO PROPERTIES, LLC	DATE: MAY 2012	PROJ. NO.	٧.
30 LEDGEWOOD DRIVE, FALMOUTH, MAINE 04104	SCALE: AS NOTED	DWG. NO. C-302	-