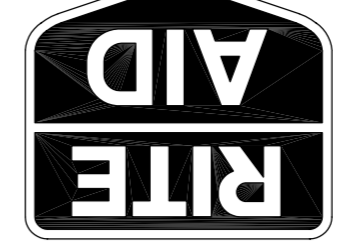


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ISSUED FOR BUILDING PERMIT/CC BIDDING
10-27-06


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Project No.: 0525
Date: 10-27-06
Title: ROOF PLAN
Sheet No.: A-105

A-105

- SHEET NOTES**
- REFRIGERATION COMPRESSOR UNIT PROVIDED BY RITE AID ON 6X6 P.T. DUNNAGE PROVIDED BY G.C.
 - ROOF DRAIN AND WALL SCUPPER LOCATION, SEE DETAIL A10 AND A13/A-501 FOR MORE INFORMATION.
 - TAPERED INSULATION CRICKET 1/2" x 12"
 - LINE OF HORIZONTAL ROOF DRAINS, RUN IN PLENUM SLOPE 1/8" x 12" TYPICAL.
 - 80 MIL WALKWAY MEMBRANE, SEE DETAIL D13/A-501 FOR MORE INFORMATION.
 - 80 MIL WALKWAY MEMBRANE, COLOR TO BE DIFFERENT FROM ROOF.
 - PACKAGED ROOF TOP UNIT LOCATIONS, SEE MECHANICAL DRAWINGS FOR MORE INFORMATION.
 - SATELLITE DISH AND MOUNTING PAD SUPPLIED AND INSTALLED BY RITE AID. A PRE-INSTALLATION SURVEY SHALL BE CONDUCTED BY THE INSTALLATION COMPANY TO VERIFY LINE OF SIGHT. FINAL LOCATION OF DISH TO BE DETERMINED AFTER THE SURVEY. SEE DETAIL D10/A-501 FOR ROOF PENETRATION.
 - GAS LINE, SEE MEP-101 FOR MORE INFORMATION.
 - PIPE CURB LOCATION, SEE DETAIL 07/A-501 FOR MORE INFORMATION.
 - ROOF DRAIN TIED DIRECTLY INTO STORM WATER SYSTEM. OVER FLOW DRAIN DISCHARGES ONTO DRIVE THRU DR SIBEWACK AT ENTRY. RE: A15/A-501.
 - MEMBRANE ROOF, SLOPE 1/4" x 12" TYPICALLY. RE: A-501 INFORMATION, FLASHING PER 07/A-501.
 - LINE OF METAL PANELS BELOW.
 - GAS PIPE PENETRATION SEE DETAIL K10/A-501
 - GAS VENT FOR UH-1. RE: C13/M-201.
 - EXHAUST VENT CAP FROM EF-2.
 - PRE FINISHED METAL COPING.
 - DISH NETWORK SATELLITE ON 2' x 4' PAD.
 - GOOSE NECK WIRE CHASE THRU ROOF SEE DETAIL D10/A-501.
 - USE OF THE EDGE-LOCK FACIA COPING SYSTEM SHALL BE DETERMINED AFTER THE SURVEY. THE PARAPET SHALL BE INSTALLED WITH THE SHEETS RUNNING PARALLEL TO LONG SIDE OF BUILDING LAP SEAMS IN DIRECTION OF WATER FLOW.
 - CONDENSING UNIT (CU-1) AND EQUIPMENT PAD ON ROOF. SEE ROOF PLAN RE: MEP-101.
 - METAL AWNING (REFER TO EXTERIOR ELEVATIONS SHEET A-201).

GENERAL NOTES

LEGEND

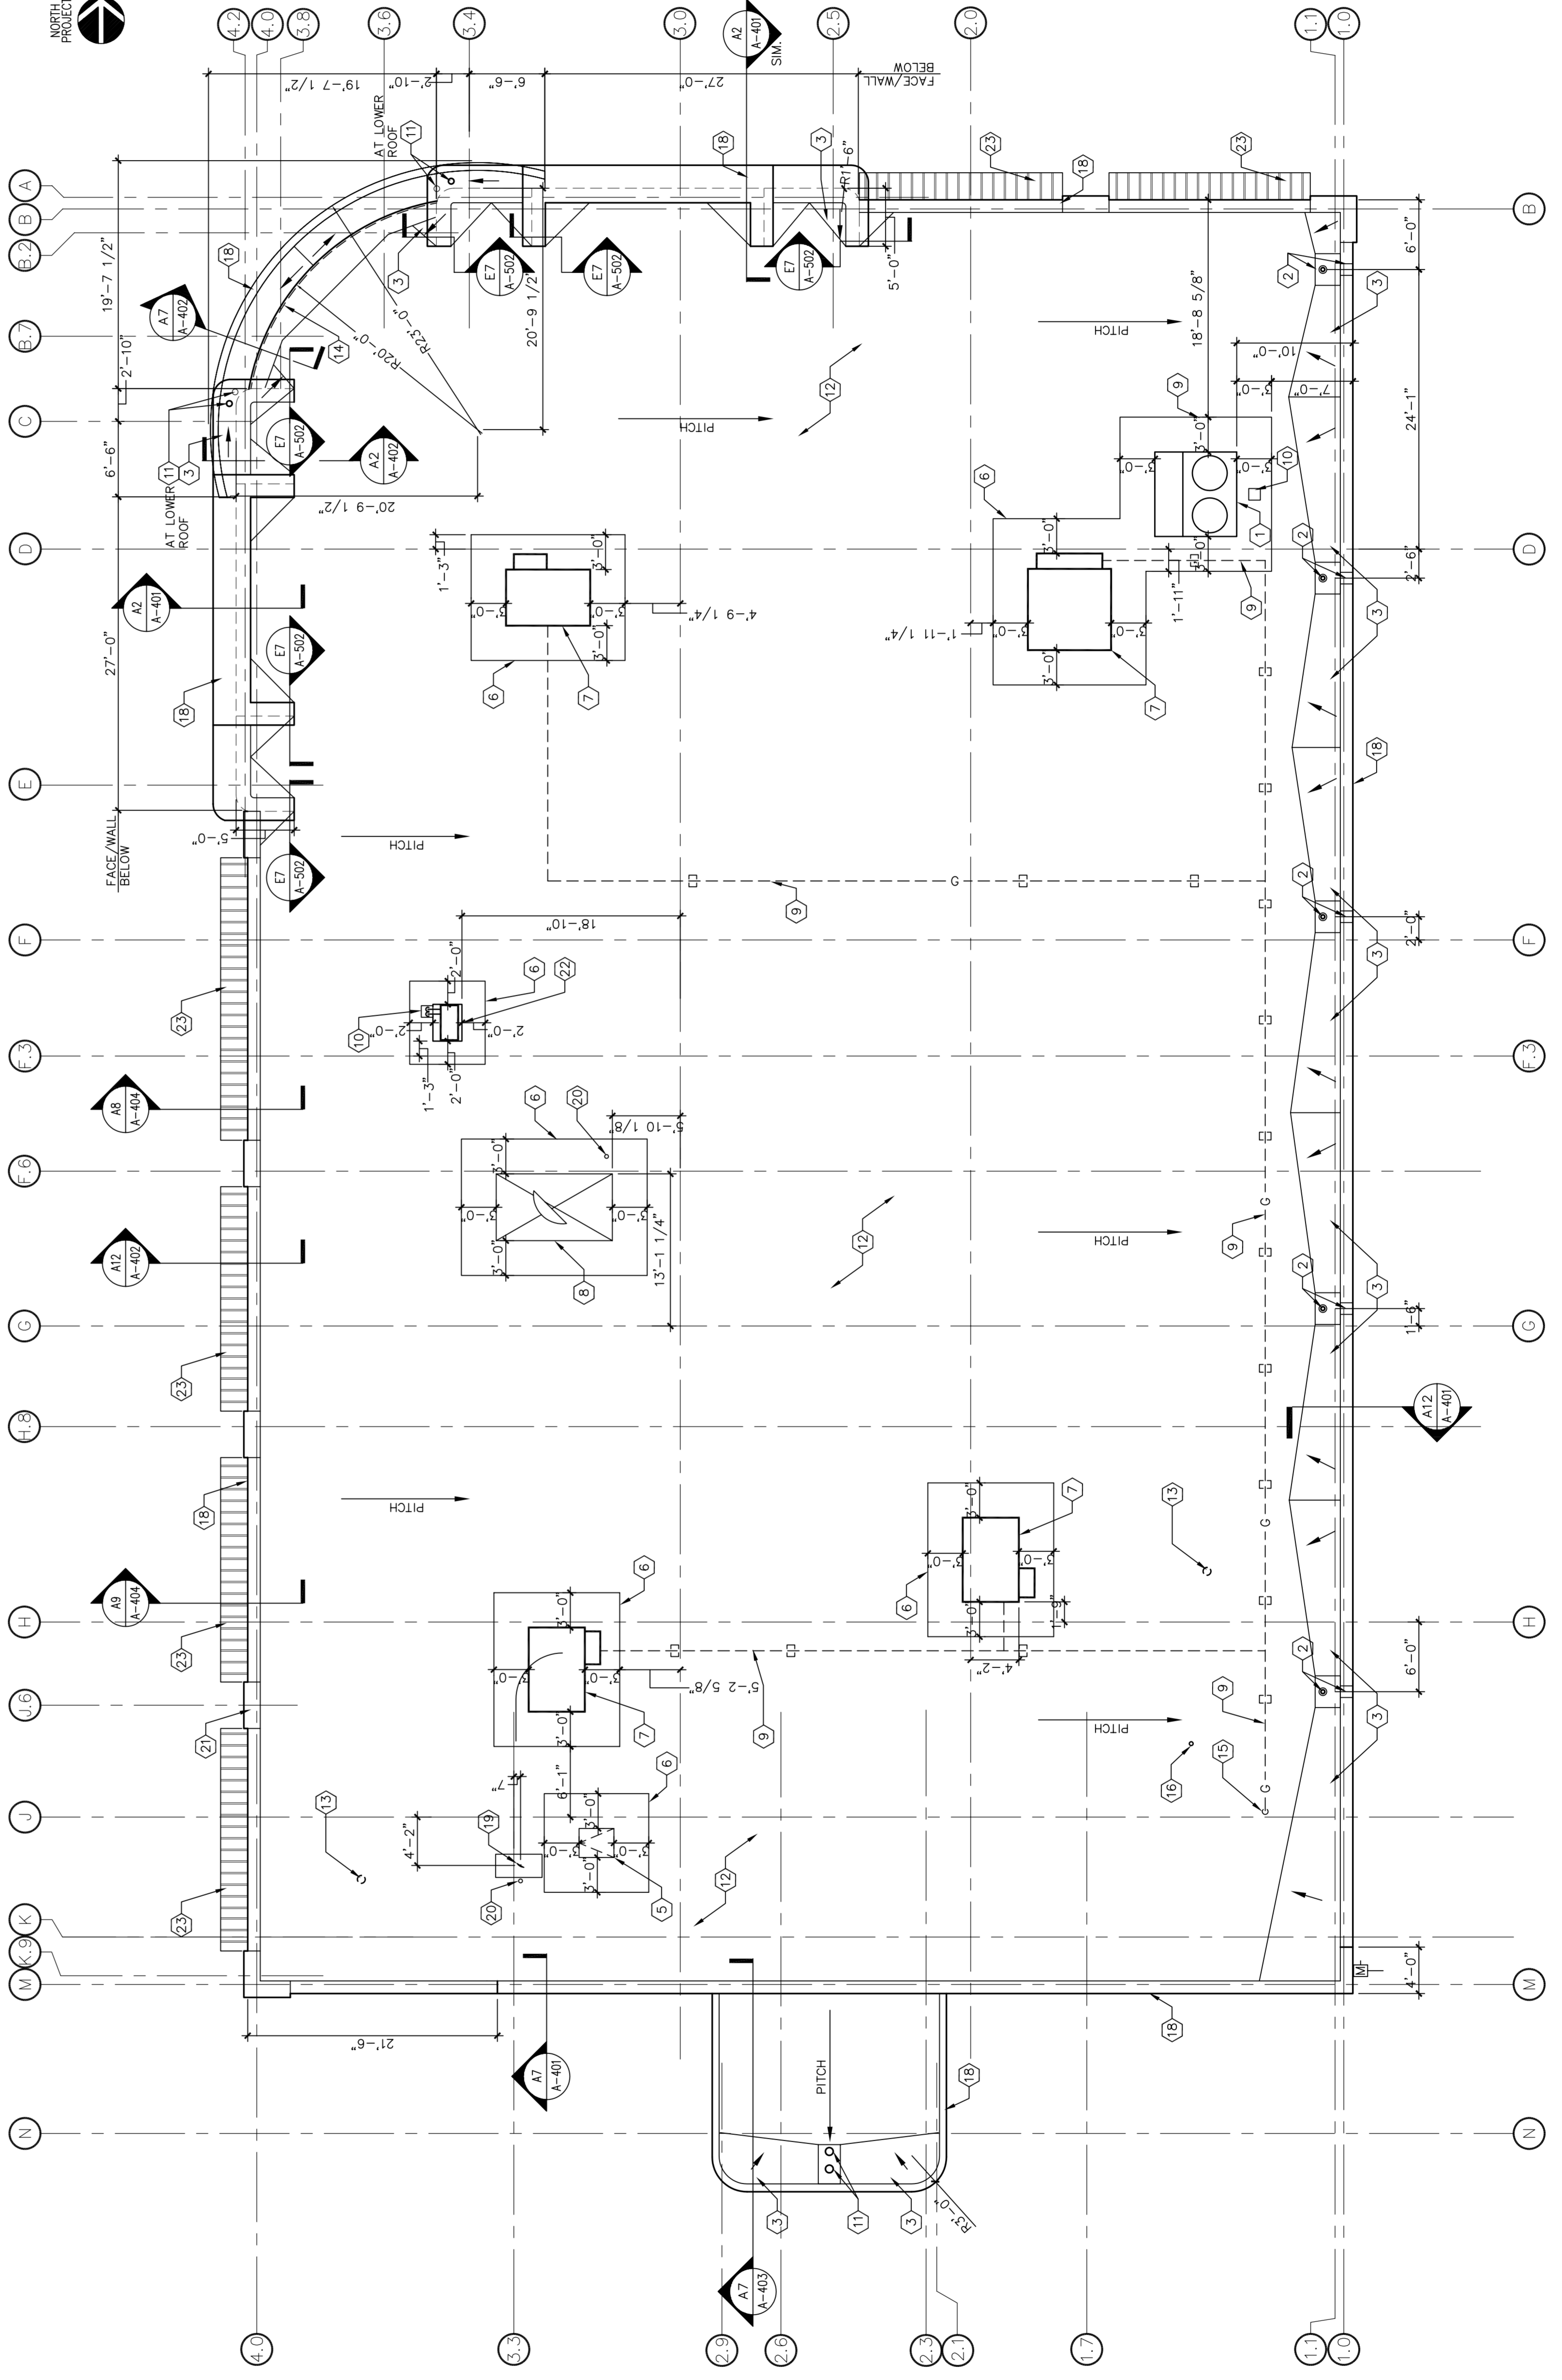

A3 ROOF PLAN
1/8" = 1'-0"