

### DISPLAY THIS CARD ON PRINCIPAL FRONTAGE OF WORK



# CITY OF PORTLAND BUILDING PERMIT

This is to certify that

HVAC Services Inc.,

Located At 27 NORTHPORT

has permission to

Install a Trane unit On the roof

provided that the person or persons, firm or corporation accepting this permit shall comply with all of the provisions of the Statues of Maine and of the Ordinances of the City of Portland regulating the construction, maintenance and use of the buildings and structures, and of the application on file in the department.

Notification of inspection and written permission procured before this building or part thereof is lathed or otherwise closed-jn, 48 HOUR NOTICE IS REQUIRED.

A final inspection must be completed by owner before this building or part thereof is occupied. If a certificate of occupancy is required, it must be procured prior to occupancy.

Fire Prevention Officer

Code Enforcement Officer / Plan Reviewer

THIS CARD MUST BE POSTED ON THE STREET SIDE OF THE PROPERTY.

PENALTY FOR REMOVING THIS CARD.

### **BUILDING PERMIT INSPECTION PROCEDURES**

Please call 874-8703 or 874-8693 (ONLY)

or email: buildinginspections@portlandmaine.gov

With the issuance of this permit, the owner, builder or their designee is required to provide adequate notice to the city of Portland Inspections Services for the following inspections. Appointments must be requested 48 to 72 hours in advance of the required inspection. The inspection date will need to be confirmed by this office.

- Please read the conditions of approval that is attached to this permit!! Contact this office if you have any questions.
- Permits expire in 6 months. If the project is not started or ceases for 6 months.
- If the inspection requirements are not followed as stated below additional fees may be incurred due to the issuance of a "Stop Work Order" and subsequent release to continue.
- 1. Final Commercial

The project cannot move to the next phase prior to the required inspection and approval to continue, REGARDLESS OF THE NOTICE OF CIRCUMSTANCES.

IF THE PERMIT REQUIRES A CERTIFICATE OF OCCUPANCY, IT MUST BE PAID FOR AND ISSUED TO THE OWNER OR DESIGNEE BEFORE THE SPACE MAY BE OCCUPIED.

Job ID: <u>2010-12-150-FAFS</u> Located At: <u>27 NORTHPORT</u> CBL401 - - A - 005 - 027 - - - -

# PORTLAND MAINE

Strengthening a Remarkable City, Building a Community for Life • www.portlandmaine.gov

Director of Planning and Urban Development Penny St. Louis Littell

### **Conditions of Approval:**

### Fire

- 1. Installation shall comply with City Code Chapter 10.
- 2. Installation shall comply with NFPA 211, *Standard for Chimneys, Fireplaces, Vents, and Solid Fuel–Burning Appliances*; NFPA 54, *National Fuel Gas Code*, NFPA 70, *National Electrical Code a*nd the manufacturer's published instructions.

### Fire

- 1. The sprinkler system shall be installed in accordance with NFPA 13.
- 2. The Fire Department will require knox locking caps on all Fire Department Connections on the exterior of the building.
- 3. Installation of a sprinkler or fire alarm system requires a Knox Box to be installed per city ordinance.

### **Building**

- 1. Application approval based upon information provided by applicant. Any deviation from approved plans requires separate review and approval prior to work.
- 2. All penetrations between dwelling units and dwelling units and common areas shall be protected with approved firestop materials, and recessed lighting/vent fixtures shall not reduce the (1 hour) required rating per Sec. 712 of IBC and R317.3.1.2 of the IRC
- 3. The installation must comply with the State of Maine Gas Regulations.
- 4. Maintain proper setbacks from property lines/buildings and proper clearances from vertical openings when direct venting.

### City of Portland, Maine - Building or Use Permit Application

389 Congress Street, 04101 Tel: (207) 874-8703, FAX: (207) 8716

Job No: 2011-1113	Date Applied: 12/28/2010		CBL: 401 A - 005 - 027 -			
SEQUENCE 1 - HVAC/FIR Location of Construction: 27 NORTHPORT DR	Owner Name: BEAN INC LL		Owner Address: 15 CASCO ST FREEPORT, ME - M	1AINE 04033		Phone:
Business Name:	usiness Name:  Contractor Name:  HVAC Services INC.			ss: westbrook, me		Phone: 854-4822
essee/Buyer's Name: Phone:			Permit Type: FIRE ALARM - Fire	e Alarm		Zone: B-2
Past Use:	Proposed Use:		Cost of Work: 19000.000000			CEO District
SAME: OFFICES – INSTALL HVAC SY		STEM	Fire Dept:	Approved ⊕ C C Denied N/A	conditions	Inspection: Use Group: Type:
			Signature: BAC	lubile) 5	5	Signature:
Proposed Project Descriptio HVAC SYSTEM	n:		Pedestrian Activi	ties District (P.A.D.	.)	
Permit Taken By:			<u></u>	Zoning Approv	al	
		Special Z	one or Reviews	Zoning Appeal	Historic F	reservation
<ol> <li>This permit application Applicant(s) from meet Federal Rules.</li> <li>Building Permits do not septic or electrial work.</li> <li>Building permits are vo within six (6) months o False informatin may ir permit and stop all work.</li> </ol>	ing applicable State and t include plumbing, oid if work is not started f the date of issuance. envalidate a building k.  f record of the named property, his authorized agent and I agree the code official's authorized re	Date: Of CERTII	one sion  MinMM  FICATION  posed work is authorized all applicable laws of the same content of the same	ms jurisuiction, in addit	Does no Require: Approve Approve Denied Date:	ed w/Conditions  a authorized by york described in
						21/2/

### Fire conditions

Installation shall comply with City Code Chapter 10.

Installation shall comply with NFPA 211, Standard for Chimneys, Fireplaces, Vents, and Solid Fuel-Burning Appliances; NFPA 54, National Fuel Gas Code, NFPA 70, National Electrical Code and the manufacturer's published instructions.

### **Job Summary Report** Job ID: 2010-12-150-FAFS

**Public Building Flag:** N

Job Description:

**Square Footage:** 

Report generated on Feb 8, 2011 2:36:11 PM

Page 1

Job Type:

Fire Alarm / Suppression

Fire Alarm

Job Year:

2010

**Building Job Status Code:** 

Permit Issued

292

**Tenant Name:** 

**Job Application Date:** 

**Tenant Number:** 

**Estimated Value: Related Parties:** 

19,000

BEAN LL

Pin Value:

Property Owner

Owner Contractor

ELECTRICAL CONTRACTOR

HVAC Services Inc. - HVAC Services Inc. HVAC Services

MECHANICAL CONTRACTOR

Inc.

				Job	Charges				
Fee Code Description	Charge Amount	Permit Charge Adjustment	Net Charge Amount	Payment Date	Receipt Number	Payment Amount	Payment Adjustment Amount	Net Payment Amount	Outstanding Balance
Job Valuation Fees	\$210.00		\$210.00	12/23/10	425	\$210.00		\$210.00	\$0.00

### Location ID: 49586

							Locatio	n Details				
Alternate Id	Parcel Nur	nber	Census Tract	GIS X	GIS Y	GIS Z	GIS Reference	Longitude	Latitude			
	401 A 005 0	27						-70.285095	43.700152			
					Loc	ation Typ	e Subdivision	Code Sub	division Sub Co	de Related Persons	Address(es)	-
					1						27 NORTHPORT DRIVE	_
Location Use	Code V	ariance Code	use Zo	ne Code		Fire Zone Code	Inside O		District Code	General Location Code	Inspection Area Code	Jurisdiction Code
COMMERCIAL CONDOS			BUSINESS COMMUNI								DISTRICT 5	
							Structu	e Details	<b>3</b>			
Structure:	Commerc	ial Off	fice "Martin	's Poin	t"							
Occupancy 1	ype Code:						9.50		,,,,,,,,,,,,,,,,,,,,,,,,,,,,,,,,,,,,,,,			
Structure	Type Code	Str	ucture Status	Type S	quare I	ootage	Estimated Valu	e	Address	_		
Office & Profes	ssional Buildir	gs 0						27 NOF	THPORT DRIVE	_		
Longitude L	atitude GI	SX G	ISY GISZ G	SIS Refe	rence					User Defined Prop	erty Value	

Permit #: 20111113

Permit Data									
Location Id	Structure Desci	ription	Permit Status	Permit Description	Issue Date	Reissue Date	Expiration Date		
49586	Commercial Office "Ma	artin's Point"	Initialized	Install a Trane unit On the	roof				
				Inspec	tion Details			P. W.	
Inspection I	d Inspection Type	Inspection	Result Status	Inspection Status Date	Scheduled Start	Timestamp R	esult Status Date	Final Inspection Flag	
				Fee	s Details				
Fee Code Description			Charge stment	Permit Charge Adj Remark	•	. •	ayment Pay Amount	ment Adjustment Amount	Payment Adj Comment
Desc. iper									

### Permit #: FIRE ALARM-431

Permit Data								
Location Id	Structure Descriptio	n Permit Status	Permit Description	Issue Date	Reissue Date	e Expiration	Date	
49586	Location Permit	Final Insp Comp Inst	tall Fire Alarm main entrance vestibule	2 1/18/11		7/17/11	,,,,,,,,,,,,,,,,,,,,,,,,,,,,,,,,,,,,,,,	
		110000000000000000000000000000000000000	Inspection	Details				
Inspection Ic	Inspection Type	Inspection Result State	us Inspection Status Date Sch	eduled Start 1	Timestamp Re	esult Status D	ate Final Inspection Flag	
			Fees De	tails	7-10-1-1			
Fee Code	Charge	Permit Charge	Permit Charge Adj Payn	nent Re	ceipt Pa	ayment	Payment Adjustment	Payment Ad



# CITY OF PORTLAND, MAINE

## Division of Building Inspections

Original Receipt

. \
20
Received from HVA Colores On C
Location of Work 37 Oct Rot
Cost of Construction \$Building Fee \$ Permit Fee \$
Permit Fee \$ Site Fee \$
ALLE HOO V
Certificate of Occupancy Fee \$
Building (IL) Plumbing (IS) Total:
Building (IL) Plumbing (I5) Electrical (I2) Site Plan (U2)
Other
CBL: 401 A00500
Check #: 393 88 Total Collected 2, 930 50
No work is to be started until permit issued.
Please koop avisis de la
Please keep original receipt for you records.
aken by:



White - Inspection

Yellow - File

Pink - Applicant's

Gold - Assessor's Copy


APPLICATION FOR PERMIT
HEATING OR POWER EQUIPMENT

FILL IN AND SIGN WITH INK

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i e		

401 A005027

To the INSPECTOR OF BUILDINGS, PORTLAND, ME.	
The undersigned hereby applies for a permit to i	nstall the following heating, cooking or power equipment in
accordance with the Laws of Maine, the Building Code	of the City of Portland, and the following specifications:
Location / CBL 27 NORTH POINT DVIVE IN Name and address of owner of appliance MARTINS & PHOLOS INSTANCES INSTANCES IN THE SERVICES INSTANCES IN THE SERVICES I	
Location of appliance:	Type of Chimney:
Basement Floor	☐ Masonry Lined
☐ Attic Roof	Factory built
Type of Fuel:	D. M. I
Gas Oil Solid	Metal
y one a solution	Factory Built U.L. Listing #
Appliance Name: TRANE	Direct Vent
U.L. Approved Yes No	TypeUL#
Will appliance be installed in accordance with the manufacture's installation instructions? Yes  No  IF NO Explain:	Type of Fuel Tank  Oil Gas  Dept. of Building Inspections City of Portland Maine  Size of Tank
The Type of License of Installer:	1/4
Master Plumber #	Number of Tanks/U ///:
□ Solid Fuel #	Distance from Tank to Center of Flame feet.
□ Oil #	000 5
□ Gas # PNT 1138	Cost of Work: \$ 490,000
Other	Permit Fee: \$ 2 0000
Approved	Approved with Conditions
Fire:	☐ See attached letter or requirement
Ele.:	
Bldg.:	Inspector's Signature Date Approved
Si is all is the same	
Signature of Installer	Bunt (shars

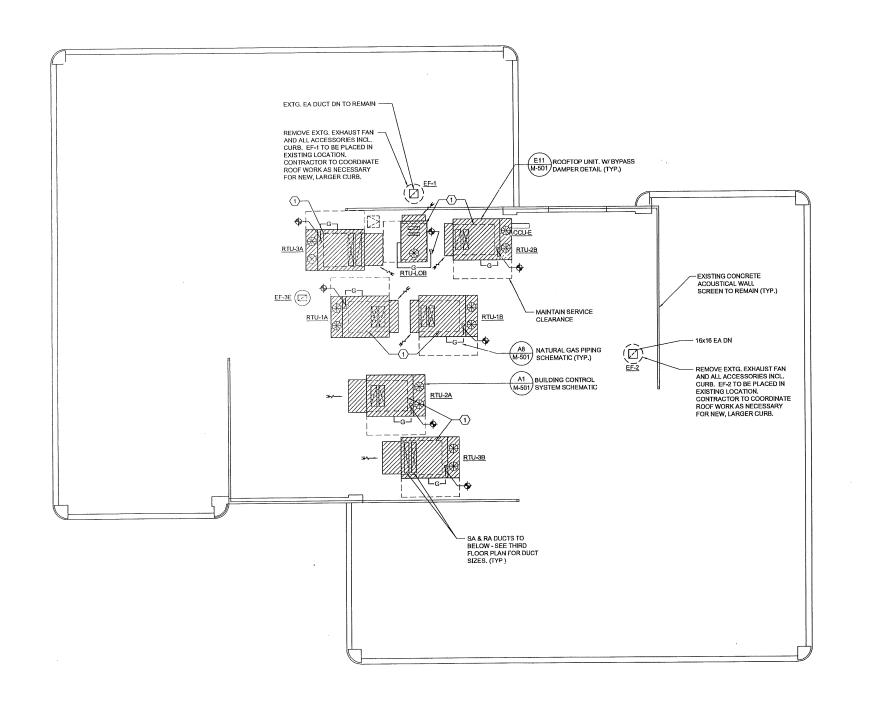

### **GENERAL NOTES:**

- REMOVE ALL EXISTING DIFFUSERS & BRANCH DUCTS, EXCEPT IN LOBBY/PUBLIC AREAS.
- 2. DIFFUSER BRANCH DUCT SIZES SHALL BE EQUAL TO DIFFUSER CONNECTION SIZE
- DIRECT OUTERMOST SLOT OF LINEAR SLOT DIFFUSER AT EXTERIOR WALL; REMAINDER OF SLOTS TO BE SET TO PROJECT AIRFLOW ALONG CEILING & AWAY FROM EXTERIOR
- ALL NEW CONTROL WIRING TO BE PLENUM RATED.
- ALL EXISTING FIRE DAMPERS (TO REMAIN):
  DISCONNECT FIRE DAMPER FUSE AND
  OPERATE DAMPER WITH NORMAL SYSTEM AIR
  FLOW TO INSURE PROPER DAMPER
  OPERATION. VISUALLY INSPECT, TEST, AND
  CONFIRM FOR EACH EXISTING FIRE DAMPER.
  VISUALLY INSPECT AND CONFIRM THAT EACH
  FIRE DAMPER IS PROPERLY SEALED AND
  INSTALLED TO MAINTAIN PROPER FIRE
  SEPARATION AND INTEGRITY, NOTIFY
  PROJECT ENGINEER IMMEDIATELY OF ANY
  AND ALL MALFUNCTIONING FIRE DAMPERS OR
  IMPROPER INSTALLATIONS, RESET ALL FIRE
  DAMPERS AT CONCLUSION OF TESTING OF
  EACH DAMPER.
- 6. ALL EXISTING DUCTS SCHEDULED TO REMAIN
  "AS-IS". CLEAN ALL EXISTING SUPPLY AIR,
  RETURN AIR & EXHAUST AIR DUCTWORK.
  COMPANYSUPERVISOR MUST BE NATIONALLY
  CERTIFIED TO PERFORM CLEANING AND
  FOLLOW CURRENT NADCA STANDARDS.
  CLEANING SHALL BE COMPLETED PRIOR TO
  FINAL AIR BALANCING. PROVIDE INSULATED &
  GASKETED ACCESS DOORS FOR DUCT
  ACCESS DURING CLEANING. REPAIR AND/OR
  REPLACE ANY DETERIORATED OR DAMAGED
  DUCT LINER OR FLEXIBLE DUCT.
- 7. EXISTING ELECTRIC RESISTANCE HEAT & ASSOCIATED THERMOSTATS SHALL REMAIN AS IS,
- 8. TAG & LABEL ALL NEW HVAC EQUIPMENT & CONTROL DEVICES.
- ALL EXTG, DUCT SMOKE DETECTORS TO REMAIN, CLEAN & TEST TO CONFIRM PROPER OPERATION, NOTIFY OWNER/ENGINEER OF ANY NONOPERABLE DEVICES.

### **TECHNICAL NOTES:**

(1) EXISTING CURB TO REMAIN. ADAPTER CURB FOR NEW UNIT TO BE INSTALLED ON TOP OF EXTG, CURB, FIELD VERIFY AND COORDINATE NEW RTU & CURB ADAPTERS WITH EXISTING ROOF CURB LOCATIONS AND CONSTRUCTION, AS REQUIRED FOR PROPER INSTALLATION AND TO MEET MANUFACTURERS REQUIREMENTS FOR OPERATION AND MAINTENANCE.

2	REISSUED	12.03.10
1	REISSUED	10.20.10
0	CONSTRUCTION DOCS	10.20.10
PEV	DESCRIPTION	DATE

### CONSTRUCTION DOCUMENTS 12.03.10







ARCHITECTS · ENGINEERS WWW.WBRCAE.COM
BANGOR, MAINE 207-947-4511
PORTLAND, MAINE 207-828-4511
SARASOTA, FLORIDA 941-556-075

MARTIN'S POINT HEALTH CARE NORTHPORT PLAZA HVAC RENOVATIONS


A/E OF RECORD:

MECHANICAL ROOF PLAN

SHEET TITLE:			
WBRC CAD FILE:	-	3626.00 - M-104	
PROJECT No.	3626.00	GRAPHIC SCALE:	-
SCALE:	AS NOTED		١^
PM:	RLR	SHEET No.	
DRAWN BY:	CGB	M-104	
A/E OF RECORD:	RLR	© toward 2010 and	L

A1	MECHANICAL ROOF PLAN

1/8" = 1'-0"

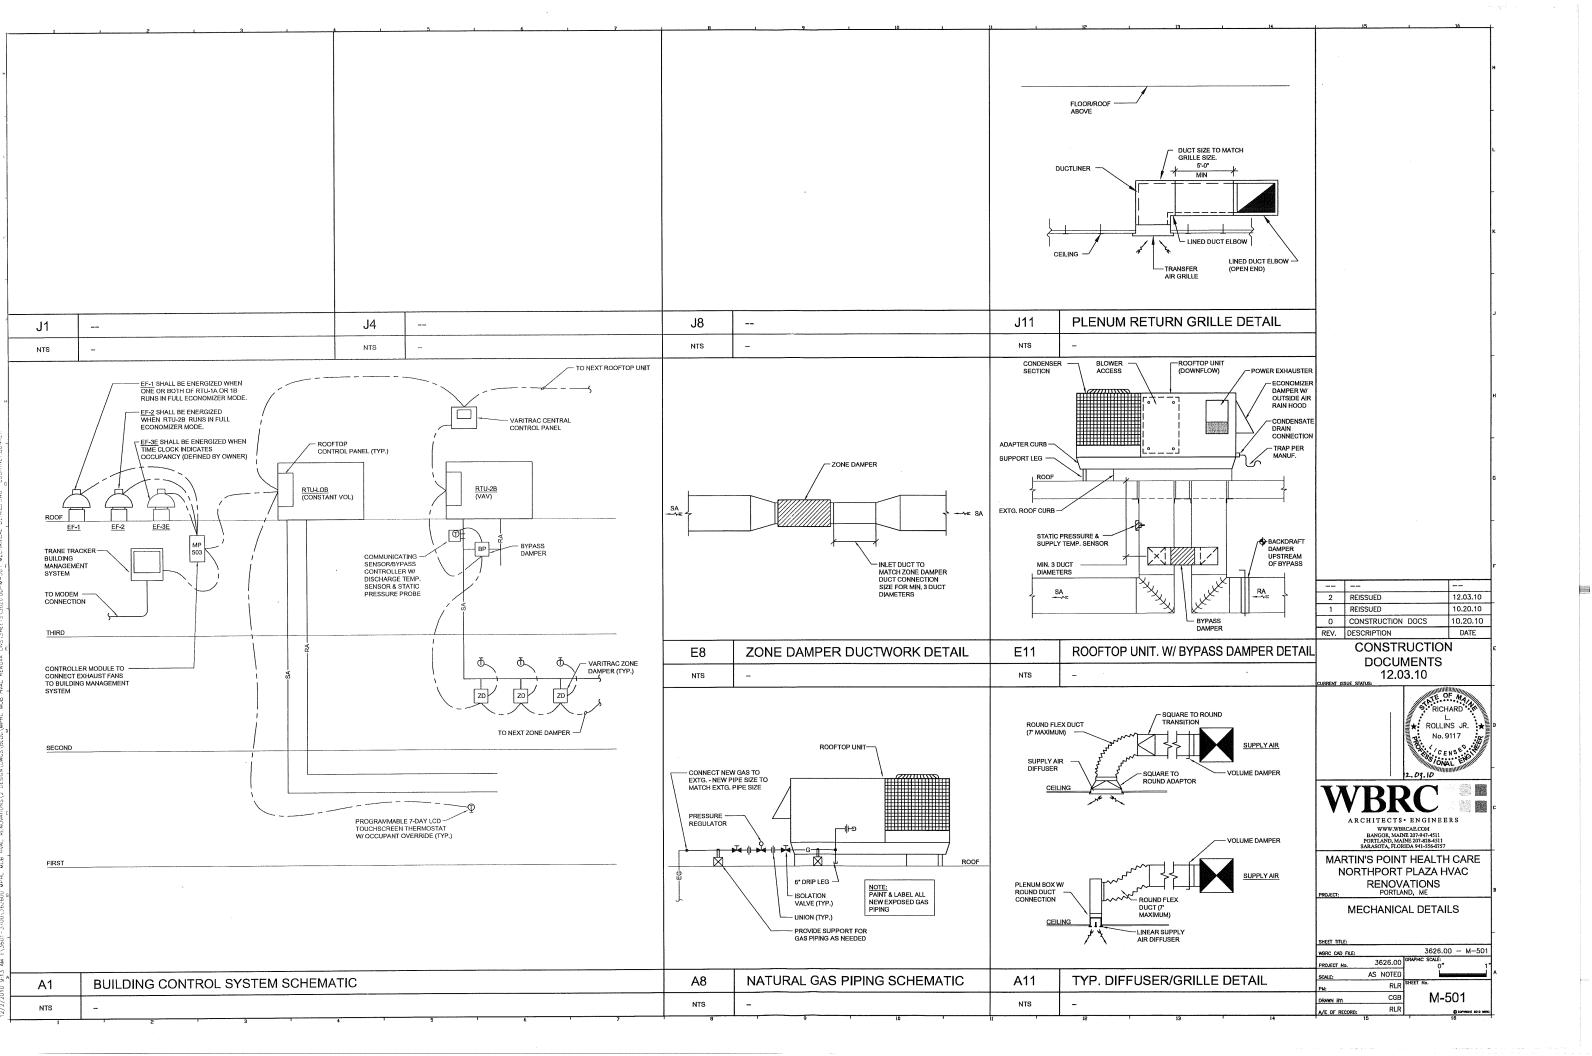

	ZOI	NE DAMPE	R SCHE	DULE		
UNIT	AREAS SERVED	MODEL	MAX. CFM	DUCT SIZE (WxH)	FPM	NOTES
ZD-1A-1	CAFETERIA (1A)	VARA-8R-B	1640	16x10	1477	①
ZD-1A-2	KITCHEN (1B)	VADA-06-B	200	6.6	1020	1
ZD-1A-3	CONFERENCE (1C)	VARA-5R-B	800	12x8	1200	①
ZD-1A-4	CONFERENCE (1D)	VARA-5R-B	800	12x8	1200	①
ZD-1A-5	CONFERENCE (1E)	VARA-7R-B	1040	16x8	1170	1
ZD-1A-6	BREAK ROOM (1F)	VADA-06-B	290	6°Ø	1480	1
ZD-1B-1	CONFERENCE (1G)	VARA-6R-B	960	14x8	1233	1
ZD-1B-2	EXT OFF (1H,1P,1Q)	VARA-5R-B	840	12x8	1260	1
ZD-1B-3	INTERIOR OFFICES	VADA-08-B	480	8°Ø	1375	①
ZD-1B-4	SE OPEN OFFICES	VARA-8R-B	1320	16x10	1190	1
ZD-1B-5	SE OPEN OFFICES	VARA-8R-B	1320	16x10	1190	0
ZD-1B-6	CONFERENCE (1S)	VADA-10-B	640	10°Ø	1173	0
						T
ZD-2A-1	OFFICE (2A)	VADA-06-B	200	6°Ø	1020	1
ZD-2A-2	NORTH OPEN OFFICES	VARA-7R-B	1120	16×8	1260	①
ZD-2A-3	NORTHEAST OPEN OFFICES	VARA-8R-B	1280	16x10	1153	①
ZD-2A-4	NORTHWEST OPEN OFFICES	VARA-8R-B	1400	16x10	1261	①
ZD-2A-5	WEST OPEN OFFICES	VARA-5R-B	800	12x8	1200	①
ZD-2A-6	OFFICES (2B & 2C)	VADA-08-B	400	8°Ø	1146	①
ZD-2A-7	BREAK ROOM	VADA-06-B	160	6*Ø	816	①
20 201	DAD WHESH	***************************************		1		
ZD-2B-1	PENOBSCOT ROOM	VADA-10-B	600	10°Ø	1100	0
ZD-2B-2	SE OPEN OFFICES	VARA-7R-B	1040	16x8	1170	1
ZD-2B-3	SOUTH OPEN OFFICES	VARA-9R-B	1760	20x10	1267	0
ZD-2B-4	SOUTHWEST OPEN OFFICES	VARA-8R-B	1580	16x10	1423	1
ZD-2B-5	SOUTHWEST OPEN OFFICES	VARA-8R-B	1580	16x10	1423	1
ZD-2B-6	OFFICES (2D & 2E)	VADA-06-B	160	6*Ø	816	1
ZD-28-7	CONFERENCE (2F)	VADA-08-B	320	8*Ø	916	1
				1		
ZD-3A-1	OFFICE (3A)	VADA-08-B	320	8*Ø	916	1
ZD-3A-2	NORTHEAST OPEN OFFICES	VARA-8R-B	1240	16x10	1116	1
ZD-3A-3	OFFICES (3B & 3C)	VADA-10-B	760	10*Ø	1395	①
ZD-3A-4	NORTHWEST OPEN OFFICES	VARA-9R-B	2000	20x10	1440	1
ZD-3A-5	OFFICE (3D)	VADA-10-B	680	10°Ø	1248	0
ZD-3A-6	ACADIA ROOM	VARA-5R-B	840	12x8	1260	0
	7.0.00710071					
ZD-3B-1	OFFICES (3J)	VADA-06-B	240	6*Ø	1225	1
ZD-3B-1	SOUTHEAST OPEN OFFICES	VARA-8R-B	1320	16x10	1190	<u>0</u>
ZD-3B-2 ZD-3B-3	SOUTH OPEN OFFICES	VARA-9R-B	1600	20x10	1152	0
ZD-3B-3 ZD-3B-4	OFFICES (3G & 3H)	VADA-10-B	720	10°Ø	1321	0
ZD-3B-4 ZD-3B-5	SOUTHWEST OPEN OFFICES	VARA-9R-B	2000	20x10	1440	<u> </u>
ZD-3B-6	OFFICES (3E & 3F)	VADA-10-B	640	10"Ø	1175	0
ZD-3B-6 ZD-3B-7	OFFICES (3K)	VADA-06-B	80	6*Ø	408	0

VARIABLE VOLUME BOX SCHEDULE NOTES:

1 BASED ON TRANE VARITRAC

BYPASS DAMPER SCHEDULE								
TAG	SERVES	CFM	MODEL	DUCT SIZE	FPM	NOTES		
BPD-1A	RTU-1A	4000	VARA-2R-J	16x16	2,250	102		
BPD-1B	RTU-1B	4000	VARA-2R-J	16x16	2,250	02		
BPD-2A	RTU-2A	4000	VARA-2R-J	16x16	2,250	102		
BPD-2B	RTU-2B	4000	VARA-2R-J	16x16	2,250	102		
BPD-3A	RTU-3A	4800	VARA-3R-J	20x20	1,730	102		
BPD-3B	RTU-3B	4800	VARA-3R-J	20x20	1,730	102		
						I		

BYPASS DAMPER SCHEDULE NOTES:

① BASED ON TRANE VARITRAC

② CFM BASED ON 80% OF RTU AIRFLOW

	ROOFTOP UNIT SCHEDULE															
	NOMINA			INDOO				MIN. OA		1				OUTDOOR F	MIN. BRANCH	FUSE SIZE
UNIT	COOLIN	G CF	A ESF	P B⊦	IP	MOTOR HP	DRIVE	CFM	VOLTS/PH/HZ	QTY	PRESSOF		OOR FAN	FLALRA	CIRCUIT (AMPS)	(MAX.)
RTU-1A	12 1/2	500	0 1.5	3.3	22	3.0	BELT	300	208/3/60	2	25.0/1		10.6/81	3.2/8.8	65	80
RTU-1A	12 1/2	500				3.0	BELT	300	208/3/60	2	25.0/1		10.6/81	3.2/8.8	65	80
RTU-2A	12 1/2	500				3.0	BELT	300	208/3/60	2	25.0/1		10.6/81	3,2/8,8	65	80
RTU-2B	12 1/2	500				3.0	BELT	300	208/3/60	2	25.0/1		10.6/81	3.2/8.8	65	80
RTU-3A	15	600				5.0	BELT	300	208/3/60	2	29.5/2		10.6/81	3.2/8.8	72	90
RTU-3B	15	600				5.0	BELT	300	208/3/60	2	29.5/2		10.6/81	3.2/8.8	72	90
RTU-LOB	5	200				1.0	BELT	200	208/3/60	1	17,6/1		2.5/6.6	5.0/32.2	29	45
GAS HEAT PERFORMANCE																
UNIT	INP HIGH	UT LOW	OU1 HIGH	LOW	EAT	TEMP		EL.	AFUE %	G	AS CONN			MMENDED PRESS.	BURNER TYPE	<u> </u>
RTU-1A	350	70	284	57	54	35-65		M GAS	80		3/4"			.0 IN. WC	INDIRECT / MODUL	ATING
RTU-1B	350	70	284	57	54	35-65			80		3/4*			.0 IN, WC	INDIRECT / MODUL	
RTU-2A	350	70	284	57	54	35-65			80		3/4"			.0 IN. WC	INDIRECT / MODUL	ATING
RTU-2B	350	70	284	57	54	35-65			80		3/4"		2.5-14	.0 IN. WC	INDIRECT / MODUL	ATING
RTU-3A	350	70	284	57	56	35-65			80		3/4"		2.5-14	.D IN. WC	INDIRECT / MODUL	ATING
RTU-3B	350	70	284	57	56	35-65			80		3/4"		2,5-14	.D IN, WC	INDIRECT / MODUL	ATING
RTU-LOB	130	N/A	104	N/A	51	35-65			79		1/2"		4.5-14	.0 IN, WC	INDIRECT / SINGLE S	STAGE
						COOL	ING PERFC	RMANCE			UNIT WEIGHT	MODE			NOTES	
UNIT	CAP.			ILE CLG. (MBH)	EER	SEER	POWER NPUT (KW)	O.A. D.B. TEMI	EAT DB/WB	REFRIG	(LBS.)	MODE	١			
RTU-1A	156	5.6	1	15.1	12.0	-	12.33	95°F	80/67	R-410A	2550		E3 (1)(2)	<b>5</b> 70		(6) (17) (18) (19
RTU-1B	150			15.1	12.0		12,33	95°F	80/67	R-410A	2550		E3 (1)(2)	(a) (a) (	0 (0) (0) (0) (0) (0)	(ii) (ii) (ii) (ii)
RTU-2A	150			15.1	12.0		12.33	95°F	80/67	R-410A	2550	YCD151	E3 (1)(2)	(5)(6)(7)(	3)(9)(1)(1)(12) (4)(15)	(18) (17) (18)
RTU-2B	156		1	15,1	12,0	-	12,33	95°F	80/67	R-410A	2550		E3 (1)(2)	(5) (7)	3 9 (9 (1) (2 (4) (5) 3 9 (9) (1) (2 (4) (5) 3 9 (9) (2 (3) (4) (5) 3 9 (9) (2 (3) (4) (5)	(a) (7) (b) (c)
RTU-3A	190		1.	45.8	12.0	-	14.83	95°F	80/67	R-410A	2650	YCD181	E3 (1)	3 567( 3 567)	3 (9 (0) (2 (3 (4) (5 3) (9 (0) (2 (3 (4) (5	(18) (17) (18)
RTU-3B	190			45.8	12.0	-	14.83	95°F	80/67	R-410A	2650	YCD181		3 567	3)9)(1) (2)(3)(4)(5)	(6) (17) (18)
RTU-LOB	63		1 4	7.3	-	15.0	4.83	95°F	80/67	R-410A	1160	YHC060	E3 (1)	(4)(5) (7)(	3)(9) (12) (14)(15)	(16) (17) (18) (19

(1) BASED ON TRANE

(2) PROVIDE W/ OFFSET INSULATED ADAPTER CURB TO ALLOW NEW UNIT TO BE PLACED ON EXTG. TRACE BYC-130 CURB.

(3) PROVIDE W/ OFFSET INSULATED ADAPTER CURB TO ALLOW NEW UNIT TO BE PLACED ON EXTG. TRACE BYC-170 CURB.

(4) PROVIDE W/ OFFSET INSULATED ADAPTER CURB TO ALLOW NEW UNIT TO BE PLACED ON EXTG. TRACE BYC-100 CURB.

(5) MOTORIZED ECONOMIZER W/ RAIN HOOD & COMPARATIVE ENTHALPY CONTROLS.

6 UNIT POWERED RELIEF FAN - 208V/3
(7) 2\* PLEATED MERV 8 FILTERS

PREMIED MERY 9 FILENCE
 HINGED ACCESS DOORS
 PREMIUM EFFICIENCY INDOOR FAN MOTOR
 PROVIDE W/TXV REFRIGERENT METERING

PROVIDE W/ HIGH STATIC FAN PACKAGE

12 STAINLESS STEEL HEAT EXCHANGER

PROVIDE W/ OVERSIZED FAN MOTOR & DRIVE
 PROVIDE W/ VERTICAL FURNACE FLUE EXTENSION

(B) PROVIDE W YEARIGAL FURNACE FLUE EXTENSION
(B) PROVIDE W YOUTHED COZ SENSOR & DEMAND CONTROL VENTILATION CONTROLS.
(B) PROVIDE W/TRANE COMMUNICATION INTERFACE BOARD FOR CONNECTION TO VARITIERA CENTRAL CONTROL PANEL.
(F) DEMAND CONTROL VENTILATION, ECONOMIZER CONTROL & SEER/EER TO COMPLY W' "EFFICIENCY MAINE" BUSINESS PROGRAM PRESCRIPTIVE CASH INCENTIVES.
(F) EXTERNAL STATIC PRESSURE INCLUDES ADDITIONAL PRESSURE DROP FROM ECONOMIZER AND AIR FILTERS. ESP EQUAL TO 1.22' W/O ECONOMIZER AND FILTERS.

19 BAROMETRIC RELIEF DAMPER

DIFFUSER/GRILLE AND REGISTER SCHEDULE									
DESCRIPTION	NECK SIZE W'xH'	MAX. CFM	S.P.	THROW (FT)	NC	TYPE	MODEL NO.	MOUNTING	NOTES
CEILING SUPPLY DIFFUSER	8'Ø	250	0,064	3-4-8	<15	PLAQUE	24x24 SPD TYPE 31	LAY-IN	00
CEILING SUPPLY DIFFUSER	10°Ø	350	0,077	3-5-9	<15	PLAQUE	24x24 SPD TYPE 31	LAY-IN	00
LINEAR SUPPLY DIFFUSER	10°Ø	250	0.066	7-11-21	<15	(2) 1* SLOTS	48° TBD-3100	LAY-IN	023 023
LINEAR SUPPLY DIFFUSER	10 <b>"</b> Ø	325	0.077	9-13-27	<15	(3) 1° SLOTS	48" TBD-3100	LAY-IN	①②③
CEILING RETURN GRILLE	14x14	800	0,066	-	<15	EGG CRATE	80-TBP	LAY-IN	①②
CEILING RETURN GRILLE	22x22	1800	0.047	-	<15	EGG CRATE	80-TBP	LAY-IN	<b>①</b> ②
	DESCRIPTION CEILING SUPPLY DIFFUSER CEILING SUPPLY DIFFUSER LINEAR SUPPLY DIFFUSER LINEAR SUPPLY DIFFUSER CEILING RETURN GRILLE	DESCRIPTION	DESCRIPTION	DESCRIPTION   NECK SIZE   WAX.   S.P.   CFM   *WC   W3H*   CFM   *WC   CEILING SUPPLY DIFFUSER   8*9   250   0.084   CEILING SUPPLY DIFFUSER   10*9   350   0.077   CEILING RETURN GRILLE   14x14   800   0.068   CEILING RETURN GRILLE   14x14   0.060   0.068   CEILING RETURN GRILLE   14x14   0.060   0.068   CEILING RETURN GRILLE   14x14   0.06	DESCRIPTION   NECK SIZE   WAX.   S.P.   CFM   'WC   (FT)	DESCRIPTION   NECK SIZE   MAX.   S.P.   THROW   (FT)   NC	DESCRIPTION   NECK SIZE   WAX.   S.P.   THROW   (FT)   NC   TYPE	DESCRIPTION   NECK SIZE   MAX.   S.P.   THROW   (FT)   NC   TYPE   MODEL NO.	DESCRIPTION

DIFFUSER/GRILLE SCHEDULE NOTES:

① BASED ON PRICE
② WHITE FINISH
③ FACTORY INSTALLED EXTERNAL FIBERGLASS PLENUM INSULATION

EXHAUST FAN SCHEDULE									
UNIT	AREA(S) SERVED	MODEL	CFM	ESP	MOTOR HP	BRAKE HP	VOLTS/Ø	RPM	NOTES
EF-1	FIRST FLOOR PLENUM EXH.	ACEB210C6B	4,000	0.50	3/4	0.73	115/1/60	823	102346
EF-2	SECOND FLOOR PLENUM EXH.	ACEB165C5B	2,000	0.50	1/2	0,322	115/1/60	940	102346
EF-3	FIRST FLOOR SHOWER	GC-320	100	0,25	-	47W	115/1/60	1073	(1) (6)
FF-4	FIRST FLOOR SHOWER	GC-320	100	0.25	T -	47W	115/1/60	1073	(1) (6)

EXHAUST FAN SCHEDULE NOTES:

BASED ON LOREN COOK
 24\* HIGH INSULATED ROOF CURB W/ DAMPER TRAY

PREMIUM EFFICIENT TEFC MOTOR
 BACKDRAFT DAMPER

(S) BELT GUARD & TENSIONER
(E) WHITE ALUMINUM GRILLE, FAN SPEED CONTROLLER, ISOLATION KIT, EAVE CAP (COLOR TO MATCH EXTG. SOFFIT COLOR).

2	REISSUED	12.03.10
1	REISSUED	10.20.10
0	CONSTRUCTION DOCS	10.20.10
RFV.	DESCRIPTION	DATE

CONSTRUCTION DOCUMENTS 12.03.10






MARTIN'S POINT HEALTH CARE NORTHPORT PLAZA HVAC RENOVATIONS PORTLAND, ME

MECHANICAL SCHEDULES

WBRC CAD FILE:			3626.00 - M-6
PROJECT No.	3	626.00	GRAPHIC SCALE: O"
SCALE:	AS	NOTED	
PM:		RLR	SHEET No.
DRAWN BY:		CGB	M-601

RLR

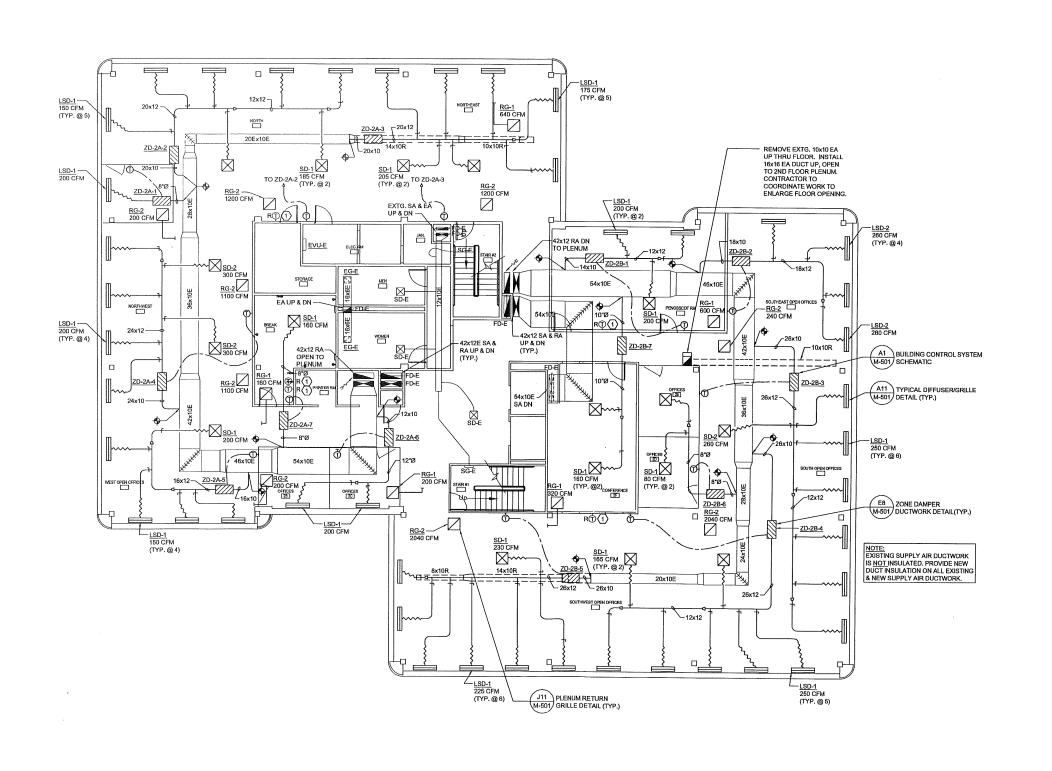

### **GENERAL NOTES:**

- REMOVE ALL EXISTING DIFFUSERS & BRANCH DUCTS, EXCEPT IN LOBBY/PUBLIC AREAS.
- 2. DIFFUSER BRANCH DUCT SIZES SHALL BE EQUAL TO DIFFUSER CONNECTION SIZE,
- 3. DIRECT OUTERMOST SLOT OF LINEAR SLOT DIFFUSER AT EXTERIOR WALL; REMAINDER OF SLOTS TO BE SET TO PROJECT AIRFLOW ALONG CEILING & AWAY FROM EXTERIOR WALL WINDOWS.
- ALL NEW CONTROL WIRING TO BE PLENUM RATED.
- 5. ALL EXISTING FIRE DAMPERS (TO REMAIN):
  DISCONNECT FIRE DAMPER FUSE AND
  OPERATE DAMPER WITH NORMAL SYSTEM AIR
  FLOW TO INSURE PROPER DAMPER
  OPERATION. VISUALLY INSPECT, TEST, AND
  CONFIRM FOR EACH EXISTING FIRE DAMPER
  VISUALLY INSPECT AND CONFIRM THAT EACH
  FIRE DAMPER IS PROPERLY SEALED AND
  INSTALLED TO MAINTAIN PROPER FIRE
  SEPARATION AND INTEGRITY. NOTIFY
  PROJECT ENGINEER IMMEDIATELY OF ANY
  AND ALL MALFUNCTIONING FIRE DAMPERS OR
  IMPROPER INSTALLATIONS. RESET ALL FIRE
  DAMPERS AT CONCLUSION OF TESTING OF
  EACH DAMPER.
- 6. ALL EXISTING DUCTS SCHEDULED TO REMAIN 'AS-IS', CLEAN ALL EXISTING SUPPLY AIR, RETURN AIR & EXHAUST AIR DUCTWORK. COMPANY/SUPERVISOR MUST BE NATIONALLY CERTIFIED TO PERFORM CLEANING AND FOLLOW CURRENT NADCA STANDARDS. CLEANING SHALL BE COMPLETED PRIOR TO FINAL AIR BALANCING, PROVIDE INSULATED & GASKETED ACCESS DODARS FOR DUCT ACCESS DURING CLEANING. REPAIR AND/OR REPLACE ANY DETERIORATED OR DAMAGED DUCT LINER OR PLEVISED DUCT.
- 7. EXISTING ELECTRIC RESISTANCE HEAT & ASSOCIATED THERMOSTATS SHALL REMAIN AS IS,
- 8. TAG & LABEL ALL NEW HVAC EQUIPMENT & CONTROL DEVICES.
- ALL EXTG, DUCT SMOKE DETECTORS TO REMAIN, CLEAN & TEST TO CONFIRM PROPER OPERATION, NOTIFY OWNER/ENGINEER OF ANY NONOPERABLE DEVICES.

### **TECHNICAL NOTES:**

(1) REMOVE EXISTING THERMOSTAT & PROVIDE BLANK COVER.

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2	REISSUED	12.03.10
1	REISSUED	10.20.10
0	CONSTRUCTION DOCS	10.20.10
REV.	DESCRIPTION	DATE

### CONSTRUCTION DOCUMENTS 12.03.10



PROJECT NORTH

RICHARD

RICHARD

ROLLINS JR.

No. 9117

CENS

ONAL

33.10

### ARCHITECTS ENGINEERS WWW.WBRCAECOM

PORTLAND, MAINE 207-828-4511
SARASOTA, FROEIDO 941-556-9757


MARTIN'S POINT HEALTH CARE
NORTHPORT PLAZA HVAC

RENOVATIONS
PORTLAND, ME

SECOND FLOOR MECHANICAL
PLAN


SHEET TITLE:			
WBRC CAD FILE:		3626.00 - M-102	2
PROJECT No.	3626.00	GRAPHIC SCALE:	1
SCALE:	AS NOTED		i
PM:	RLR	SHEET No.	_
DRAWN BY:	CGB	M-102	
A/E OF RECORD:	RLR	Copper too se	~
	15	16	_

<b>A</b> 1	SECOND FLOOR MECHANICAL PLAN
1/8" = 1'-0"	_

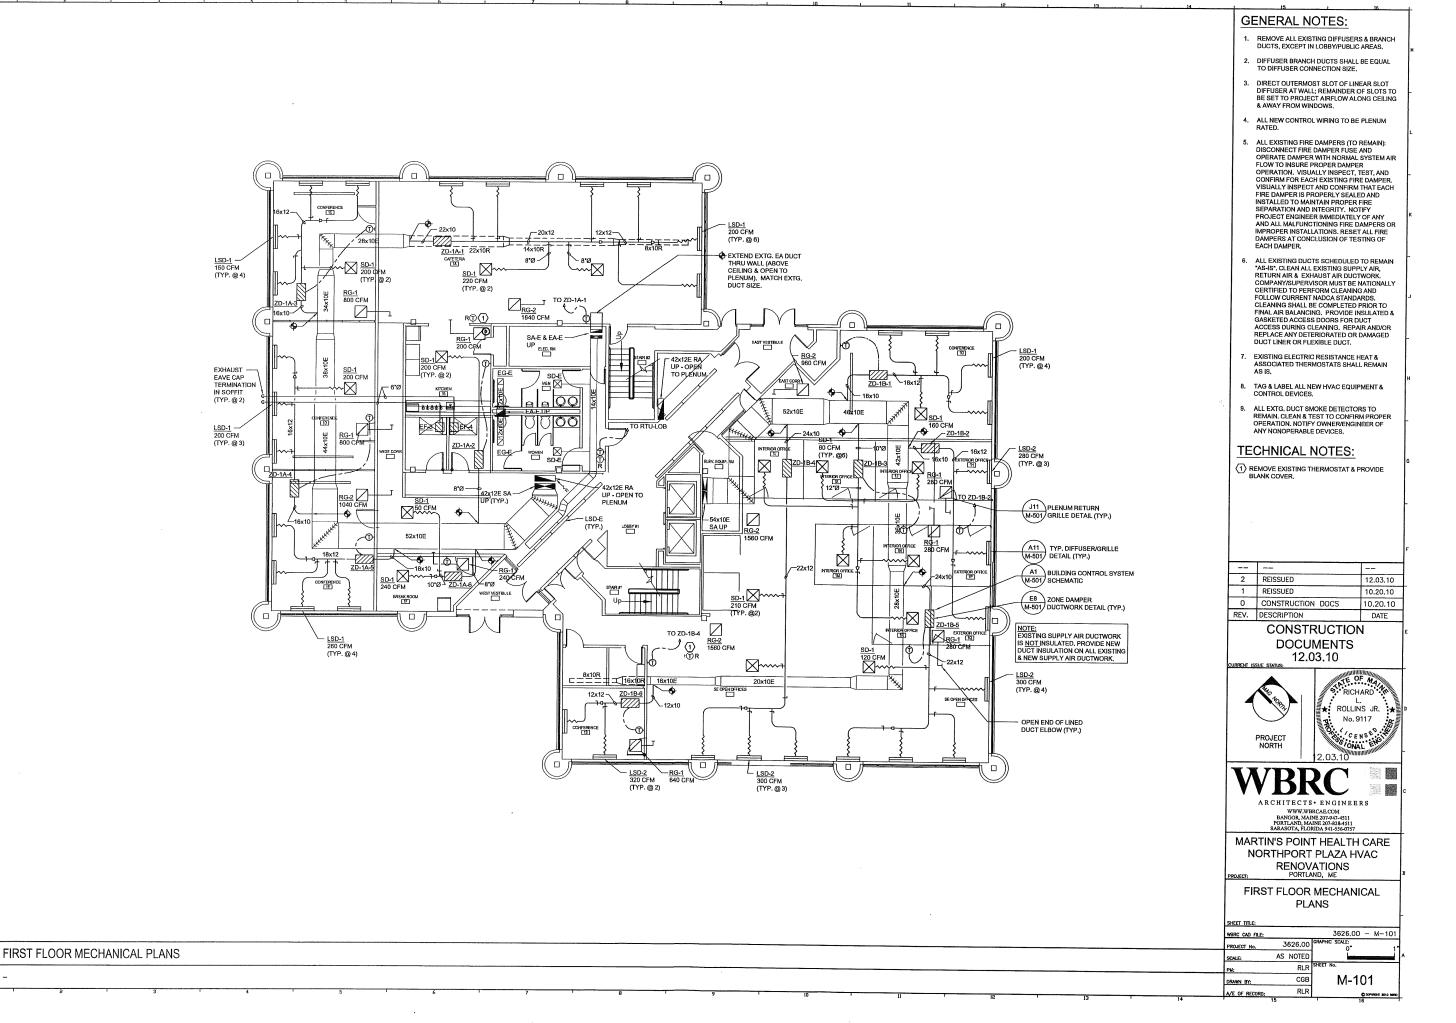

Α1

1/8" = 1'-0"

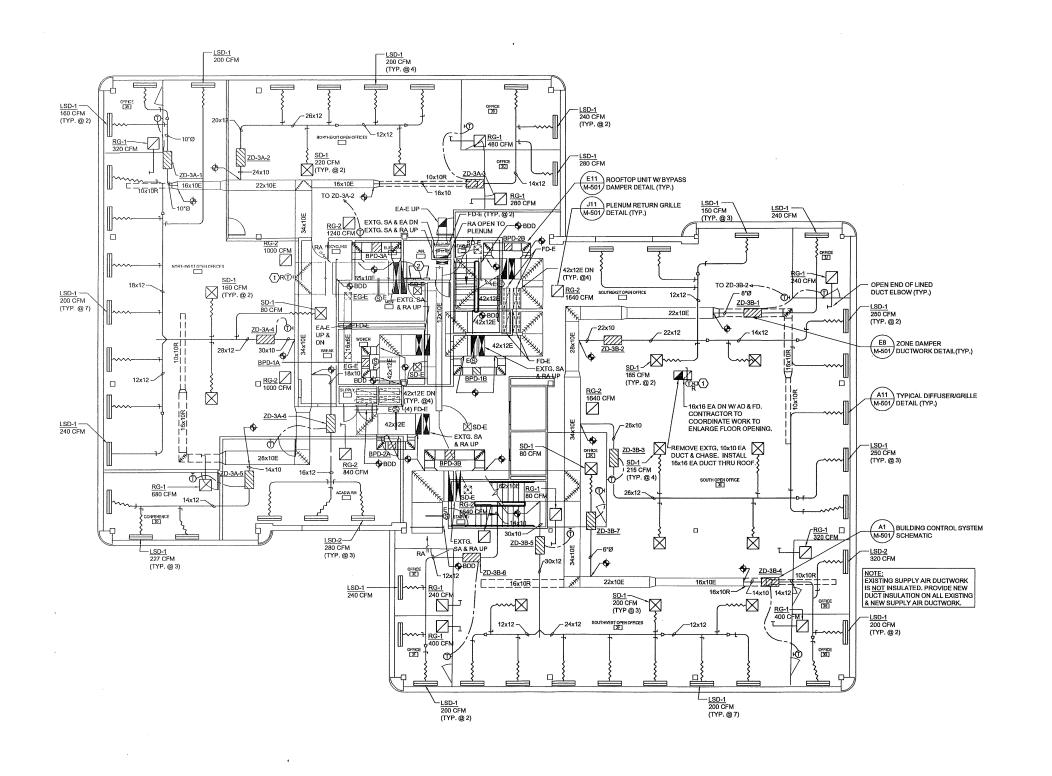

### **GENERAL NOTES:**

- REMOVE ALL EXISTING DIFFUSERS & BRANCH DUCTS, EXCEPT IN LOBBY/PUBLIC AREAS.
- 2. DIFFUSER BRANCH DUCT SIZES SHALL BE EQUAL TO DIFFUSER CONNECTION SIZE.
- DIRECT OUTERMOST SLOT OF LINEAR SLOT DIFFUSER AT EXTERIOR WALL; REMAINDER OF SLOTS TO BE SET TO PROJECT AIRFLOW ALONG CEILING & AWAY FROM EXTERIOR
- 4. ALL NEW CONTROL WIRING TO BE PLENUM RATED.
- DISCONNECT FIRE DAMPERS (TO REMAIN):
  DISCONNECT FIRE DAMPER FUSE AND
  OPERATE DAMPER WITH NORMAL SYSTEM AIR
  FLOW TO INSURE PROPER DAMPER
  OPERATION, VISUALLY INSPECT, TEST, AND
  CONFIRM FOR EACH EXISTING FIRE DAMPER,
  VISUALLY INSPECT AND CONFIRM THAT EACH
  FIRE DAMPER IS PROPERLY SEALED AND
  INSTALLED TO MAINTAIN PROPER FIRE
  SEPARATION AND INTEGRITY, NOTIFY
  PROJECT ENGINEER IMMEDIATELY OF ANY
  AND ALL MALFUNCTIONING FIRE DAMPERS OR
  IMPROPER INSTALLATIONS, RESET ALL FIRE
  DAMPERS AT CONCLUSION OF TESTING OF
- 6. ALL EXISTING DUCTS SCHEDULED TO REMAIN "AS-IS", CLEAN ALL EXISTING SUPPLY AIR, RETURN AIR & EXHAUST AIR DUCTWORK, COMPANY/SUPERVISOR MUST BE NATIONALLY CERTIFIED TO PERFORM CLEANING AND FOLLOW CURRENT NADCA STANDARDS.
  CLEANING SHALL BE COMPLETED PRIOR TO FINAL AIR BALANCING, PROVIDE INSULATED & GASKETED ACCESS DOORS FOR DUCT ACCESS DURING CLEANING, REPAIR AND/OR REPLACE ANY DETERIORATED OR DAMAGED DUCT LINER OR FLEWBILE DUCT.
- EXISTING ELECTRIC RESISTANCE HEAT & ASSOCIATED THERMOSTATS SHALL REMAIN AS IS,
- TAG & LABEL ALL NEW HVAC EQUIPMENT & CONTROL DEVICES.
- ALL EXTG, DUCT SMOKE DETECTORS TO REMAIN, CLEAN & TEST TO CONFIRM PROPER OPERATION, NOTIFY OWNER/ENGINEER OF ANY NONOPERABLE DEVICES.

#### TECHNICAL NOTES:

- (1) REMOVE EXISTING THERMOSTAT & PROVIDE BLANK COVER,
- (2) (7) STANDARD TRANE "VARITRAC" CENTRAL CONTROL PANELS LOCATED IN JANITOR CLOSET, ONE PER RIV. ALL CONTROL PANELS CONNECTED TO (1) TRANE "TRACKER" BUILDING MANAGEMENT SYSTEM WILD TOUCH SCREEN AND REMOTE COMMUNICATION CAPABILITIES WI MODEM CONNECTION FOR OFF-SITE ACCESS TO ALL RIVIS FOR PROGRAMMING, MONITORING & TROUBLESHOOTING.

2	REISSUED	12.03.10
1	REISSUED	10.20.10
0	CONSTRUCTION DOCS	10.20.10
RFV.	DESCRIPTION	DATE

### CONSTRUCTION DOCUMENTS 12.03.10







A R C H I T E C T S \* E N G I N E E I

WWW.WBRCAE.COM

BANGOR, MAINE 207-947-4511

PORTLAND, MAINE 207-828-4511

MARTIN'S POINT HEALTH CARE NORTHPORT PLAZA HVAC RENOVATIONS PORTLAND, ME

THIRD FLOOR MECHANICAL PLAN

SHEET TITLE:		
WBRC CAD FILE:		3626.00 - M-103
PROJECT No.	3626.00	GRAPHIC SCALE:  0" 1"
SCALE:	AS NOTED	200000000000000000000000000000000000000
PM:	RLR	SHEET No.
DRAWN BY:	CGB	M-103
	DID	

A1 THIRD FLOOR MECHANICAL PLAN

1/8" = 1'-0"