


SECOND FLOOR FRAMING PLAN
Scale: 1/4" = 1'-0"

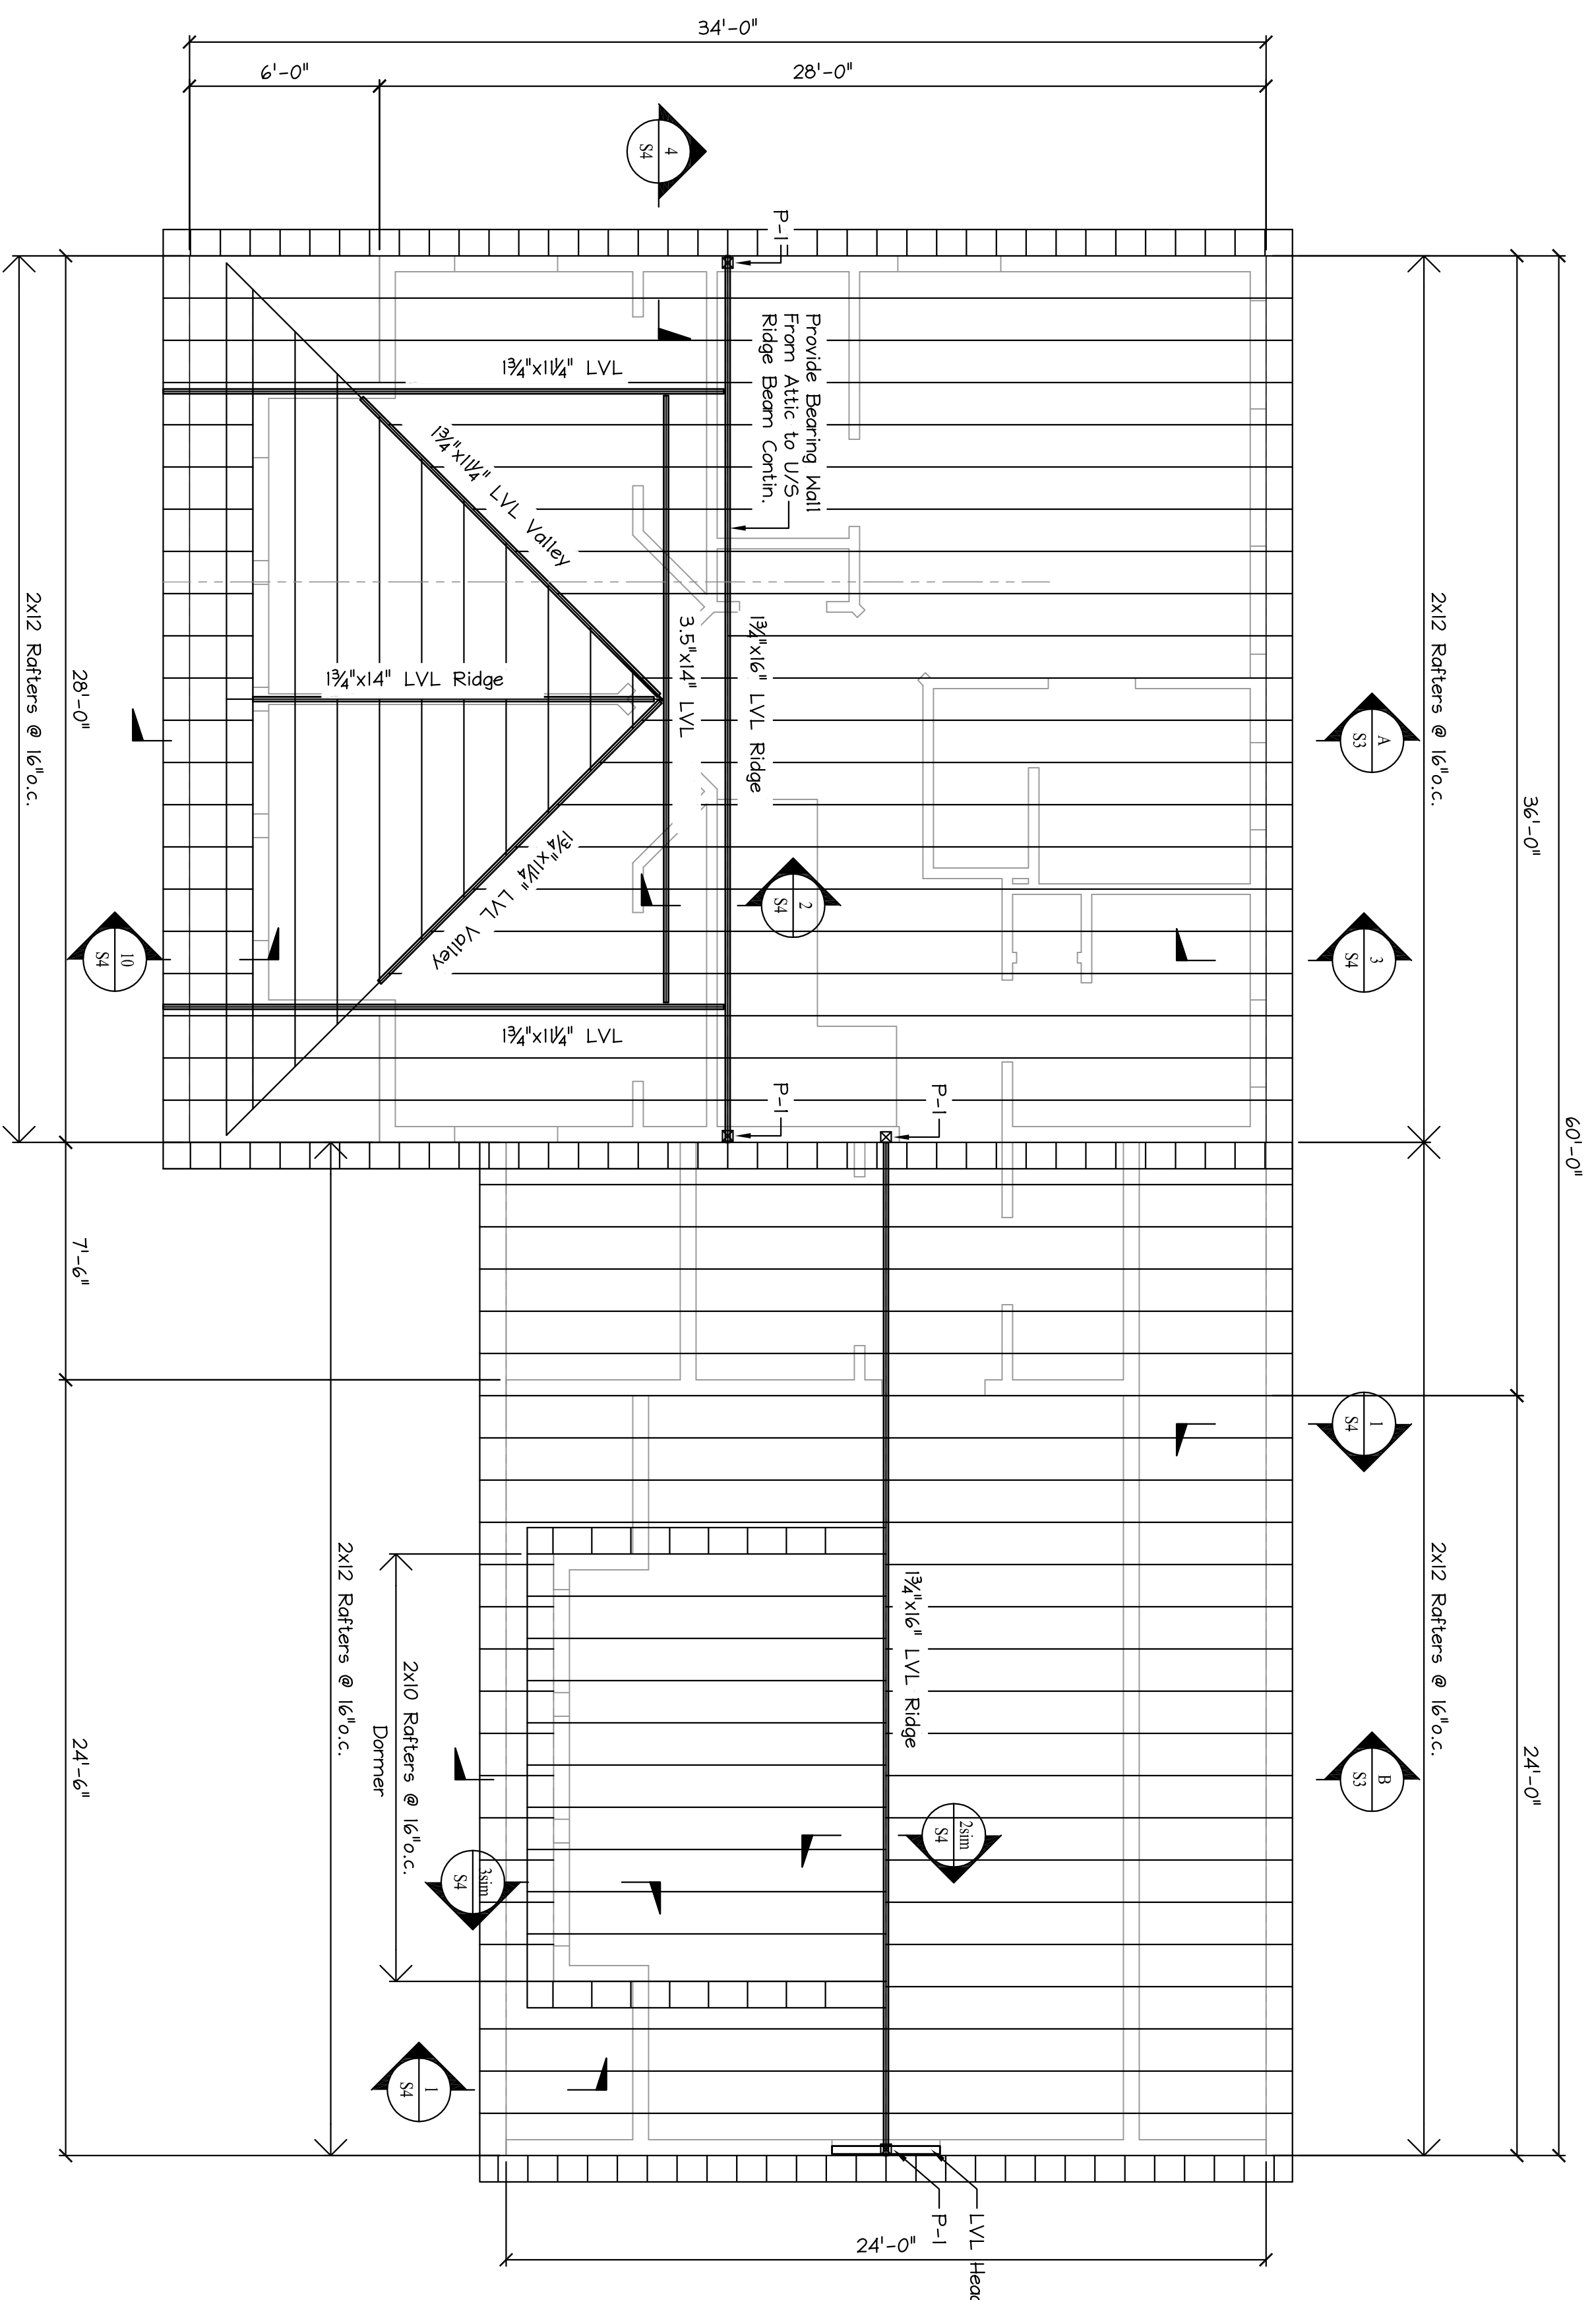



ROOF FRAMING PLAN
Scale: 1/4" = 1'-0"

OPENING HEADER SCHEDULE		
SPAN	DESCRIPTION	JACK STUDS / KING STUDS (NUMBER)
3FT	(3) 2x6's	(1) Stud / (1) Studs
4FT	(3) 2x10's	(1) Stud / (1) Studs
6FT	(3) 2x12's	(2) Stud / (2) Studs
8FT	3 1/2" x 9 1/4" LVL	(2) Stud / (2) Studs
10FT	3 1/2" x 11 1/4" LVL	(3) Stud / N / A
12FT	3 1/2" x 11 1/4" LVL	(3) Stud / N / A
15FT	5 1/4" x 11 1/4" LVL	(3) Stud / N / A

POST SCHEDULE

MARK	DESCRIPTION
P-1	5 1/2" x 5 1/2" PSL Post
P-2	5 1/2" x 3 1/2" PT Post
P-3	(4) 2x6 Post
P-4	3 1/2" x 3 1/2" PSL Post

ISSUED FOR PERMIT
10/19/17

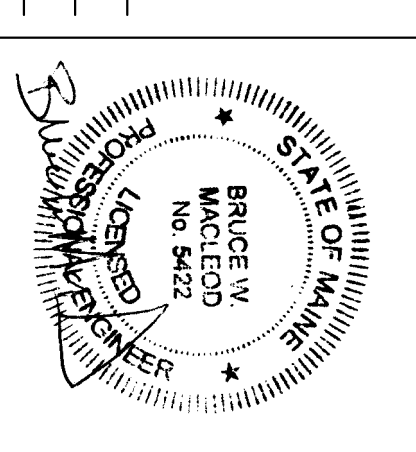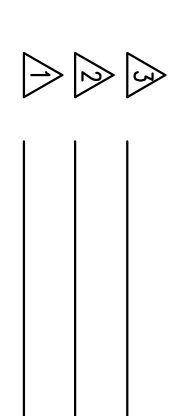

MACLEOD
STRUCTURAL ENGINEERS, PA
1000 Pine Street, Suite 200, Portland, ME 04101
Tel: 33 Penning Road
Portland, Maine

Revges Residence

DATE: 10/16/17
DRAWN BY: BWM
SCALE: as noted

TITLE: FRAMING PLANS
DRAWING NUMBER: S-21