

## Hudson Design Groupuc 1600 OSGOOD STREET BUILDING 20 NORTH, SUITE 3090 N. ANDOVER, MA 01845 FAX: 19781 336-5586

**Vert<u>70</u>n**wireless

# Verizon wireless

# PORTLAND 3 ME 476 SUMMIT STREET PORTLAND, ME 04103



#### DIRECTIONS TO SITE:

GET ON I-495 N FROM FRIBERG PKWY AND MA-9 E/STATE HWY 9 E/BOSTON WORCESTER TURNPIKE. HEAD NORTHWEST ON FRIBERG PKWY TOWARD RESEARCH DR TURN LEFT ONTO RESEARCH DR. TURN RIGHT TO MERGE ONTO MA-9 E/STATE HWY 9 E/BOSTON WORCESTER TURNPIKE. MERGE ONTO I-495 N VIA THE RAMP TO LOWELL. FOLLOW I-495 N AND I-95 N TO ME-100 S/ME-26 S IN FALMOUTH. TAKE EXIT 53 FROM I-95 N. MERGE ONTO I-495 N CONTINUE ONTO EXIT 60 (SIGNS FOR ROUTE 286/BEACHES/SALISBURRY) MERGE ONTO I-95 N. ENTERING NEW HAMPSHIRE KEEP LEFT AT THE FORK TO STAY ON I-95 N. ENTERING MAINE TAKE EXIT 53 TOWARD MAINE ME 26 W/MAINE ME 100 W/FALMOUTH CONTINUE ON ME-100 S/ME-26 S. DRIVE TO SUMMIT ST IN PORTLAND TURN RIGHT ONTO LAMBERT ST. TURN LEFT ONTO SUMMIT ST DESTINATION WILL BE ON THE LEFT. 476 SUMMIT ST. PORTLAND. ME 04103

#### **CONSULTANT TEAM**

#### PROJECT ENGINEER

HUDSON DESIGN GROUP, LLC 1600 OSGOOD STREET BUILDING 20 NORTH, SUITE 3090 NORTH ANDOVER, MA 01845 TEL: 1-(978)-557-5553 FAX: 1-(978)-336-5586

#### SURVEYOR

NORTHEAST SURVEY CONSULTANTS 116 PLEASANT ST. SUITE 302 EASTHAMPTON, MA 01027 TEL: 1-(413)-203-5144

#### PROJECT SUMMARY

SITE NAME: PORTLAND 3 ME

SITE ADDRESS: 476 SUMMIT STREET PORTLAND, ME 04103

APPLICANT: VERIZON WIRELESS

400 FRIBERG PARKWAY WESTBOROUGH, MA 01581

ZONING DISTRICT: R2

ZONING JURISDICTION: CITY OF PORTLAND, ME

**LATITUDE:** N43' 43' 01.74"

**LONGITUDE:** W70° 17′ 44.60″

**PARCEL ID:** 384-A021 & 385-C002

PROPERTY OWNER:

GRACE BAPTIST CHURCH
476 SUMMIT STREET
PORTLAND, ME 04103

SHE	SHEET INDEX	
SHT. NO.	DESCRIPTION	
NO. T-1 C-1 C-2 C-3 A-1 A-2 A-3	TITLE SHEET ABUTTERS PLAN EXISTING CONDITIONS SITE PLAN COMPOUND PLAN ELEVATION EROSION CONTROL NOTES & DETAIL	

#### DIG SAFE

3 WORKING DAYS

BEFORE YOU DIG

CALL TOLL FREE 888-DIG-SAFE

UNDERGROUND SERVICE ALERT

SHE

0 07/17/15 FOR ZONING

CHECKED BY:

APPROVED BY

**SUBMITTALS** 

PORTLAND 3 ME

SITE ADDRESS:


476 SUMMIT STREET PORTLAND, ME 04103

DPH

TITLE SHEET

SHEET NUMBER

T-1

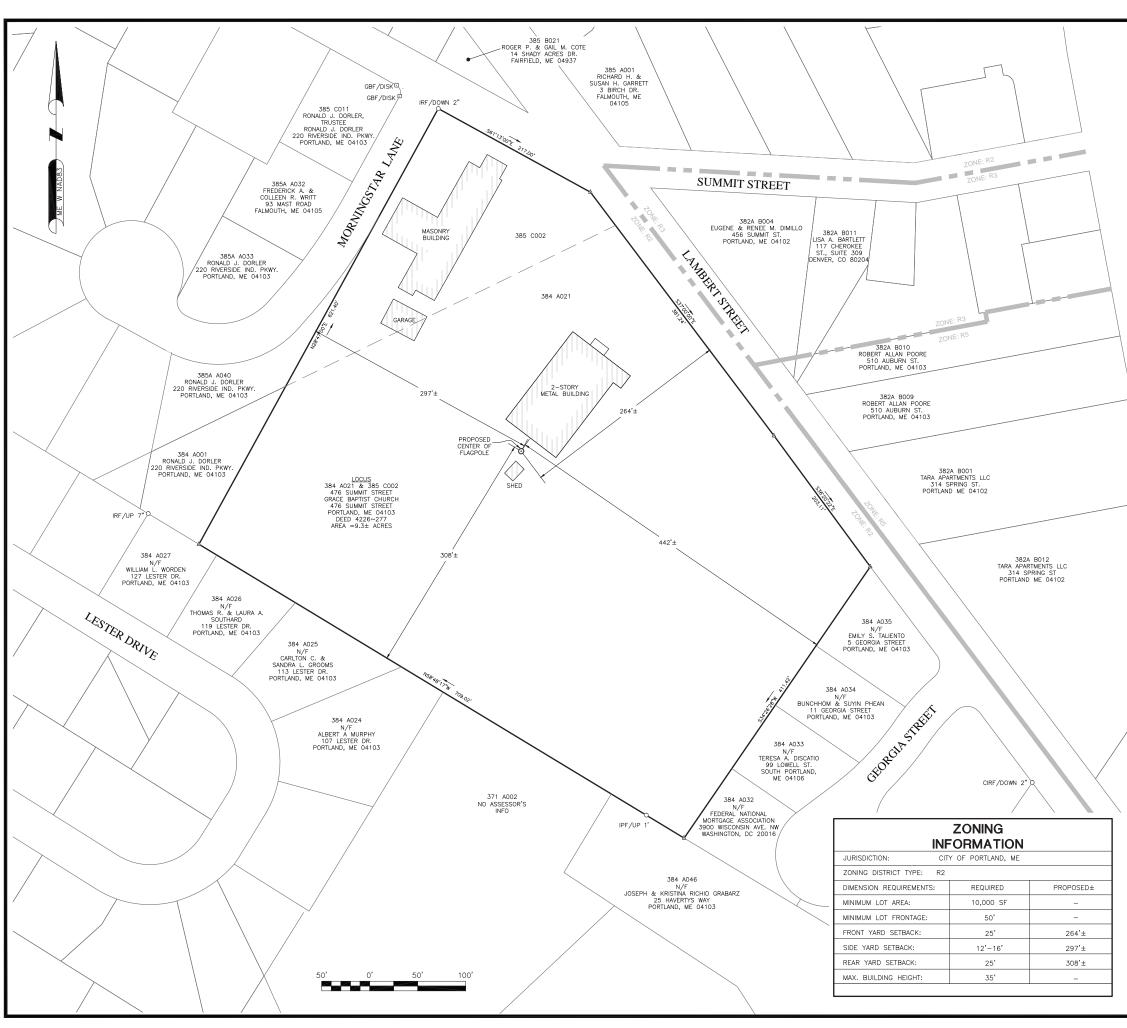

#### **LEGEND**

PROPERTY LINE - SUBJECT PARCEL ABUTTERS PROPERTY LINE

CONTOUR LINE UNDERGROUND UTILITY LINE ─ ○ GUARD RAIL

CHAIN LINK FENCE PAINTED WHITE LINE

PAINTED YELLOW LINE

CONIFEROUS TREE

CATCH BASIN

ROOF DRAIN POST/BOLLARD

WATER GATE VALVE

MANHOLE, UNKNOWN

DRAIN MANHOLE TELEPHONE MANHOLE

0 GAS METER

m

GAS GATE VALVE

UTILITY POLE SIGN

● ☐ MONUMENTS, AS DESCRIBED

Δ CALCULATED POINT

#### SITE SPECIFIC NOTES:

1. FIELD SURVEY DATE: 03-26-2015

2. HORIZONTAL DATUM: NORTH AMERICAN DATUM OF 1983 (NAD83)

NORTH AMERICAN VERTICAL DATUM 3. VERTICAL DATUM:

OF 1988 (NAVD88)

GRACE BAPTIST CHURCH 476 SUMMIT STREET 4. OWNER:

PORTLAND ME 04103

5. SITE NAME: PORTLAND 3 ME

476 SUMMIT STREET PORTLAND, ME 04103 6. SITE ADDRESS

> BELL ATLANTIC MOBILE OF MASSACHUSETTS CORPORATION, LTD.,

d/b/a VERIZON WIRELESS

CITY OF PORTLAND 8. JURISDICTION: CUMBERLAND COUNTY

9. TAX ID: 384-A021 & 385-C002

10. DEED REFERENCE: BOOK 4226 PAGE 277

11. PLAN REFERENCE: NONE

7. APPLICANT:

12. ZONING DISTRICT: R2

13. THE HORIZONTAL DATUM AND VERTICAL DATUM WERE DERIVED FROM A DUAL FREQUENCY GPS SURVEY.

14. ALL UNDERGROUND UTILITY INFORMATION PRESENTED HEREON WAS DETERMINED FROM SURFACE EVIDENCE AND PLANS OF RECORD. ALL UNDERGROUND UTILITIES SHOULD BE LOCATED IN THE FIELD PRIOR TO COMMENCEMENT OF ALL SITE WORK. CALL DIGSAFE 1-800-322-4844 A MINIMUM OF 72 HOURS PRIOR TO PLANNED ACTIVITY.

15. ACCORDING TO FEDERAL EMERGENCY MANAGEMENT AGENCY MAPS, THE PROPOSED IMPROVEMENTS ON THIS PROPERTY ARE LOCATED IN AN AREA DESIGNATED AS ZONE X (UNSHADED), AREAS DETERMINED TO BE OUTSIDE 500-YEAR FLOODPLAIN.
COMMUNITY PANEL NO. 2300510002C
EFFECTIVE DATE: 12-08-1998

16. FIELD SURVEY BY EDM TOTAL STATION.

#### 17. THIS IS NOT A BOUNDARY SURVEY.

18. ALL PROPERTY LINES SHOWN ARE FROM PLANS & DEEDS OF RECORD AND ARE APPROXIMATE ONLY.

19. ABUTTING PROPERTY LINES, ABUTTING STREET LINES AND ABUTTING BUILDING LOCATIONS ARE AS TAKEN FROM GIS AND ARE APPROXIMATE ONLY.



WESTBOROUGH, MA 01581

(508) 330-3330 TEL



SUILDING 20 NORTH, SUITE 3090 TEL: (978) 557-5553 N. ANDOVER, MA 01845 FAX: (978) 336-5586







APPROVED BY

SUBMITTALS.

DFS

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REV.	DATE	DESCRIPTION	BY
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PORTLAND 3 ME


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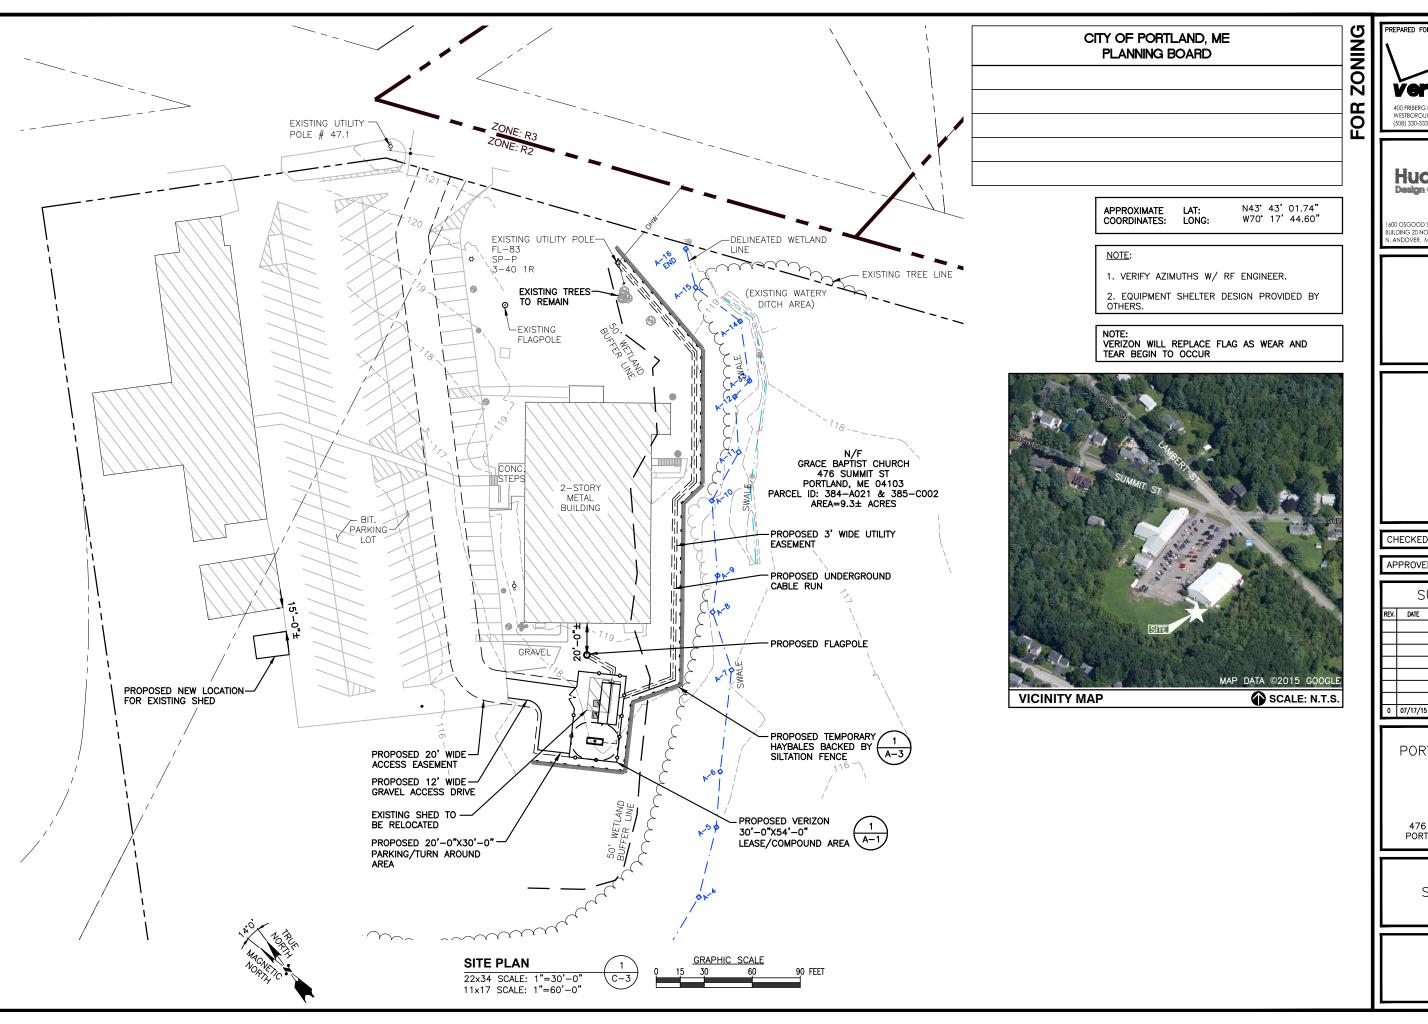
476 SUMMIT STREET PORTLAND, ME 04103

SHEET TITLE

ABUTTERS PLAN

SHEET NUMBER



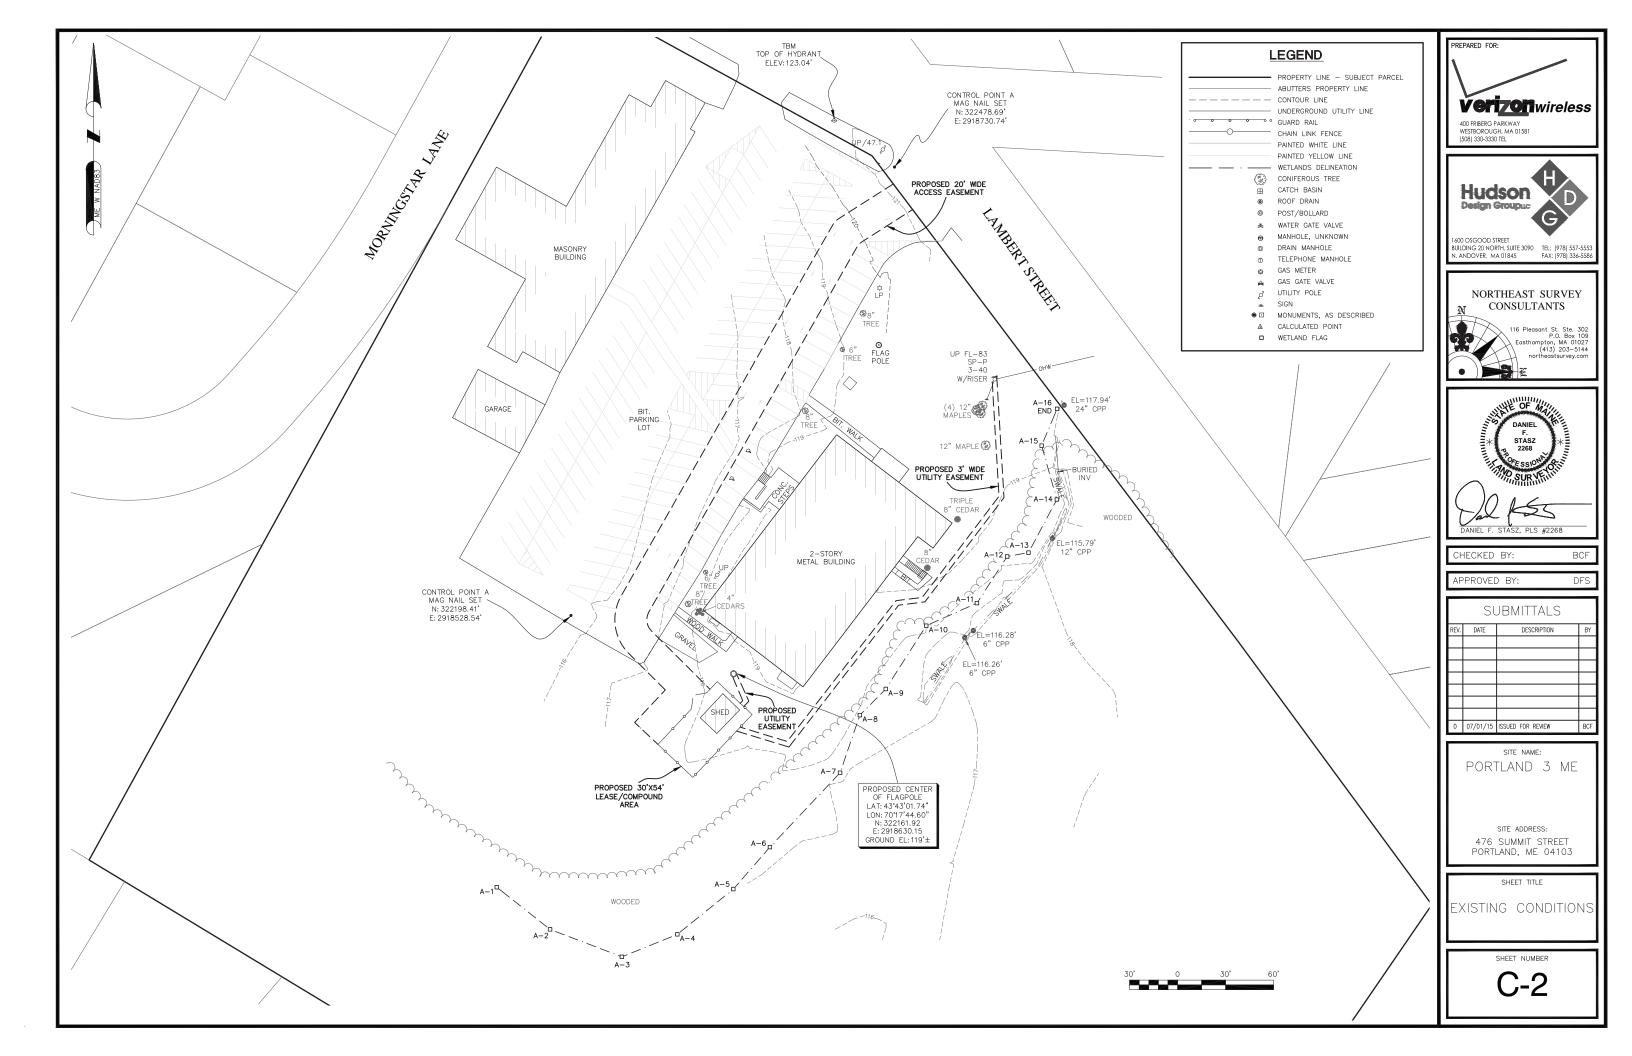

**Vertzon**wireless 400 FRIBERG PARKWAY WESTBOROUGH, MA 01581 (508) 330-3330 TEL

> Hudson Design Groupus 600 OSGOOD STREET

BUILDING 20 NORTH, SUITE 3090 TEL: (978) 557-555 N. ANDOVER, MA 01845 FAX: (978) 336-558

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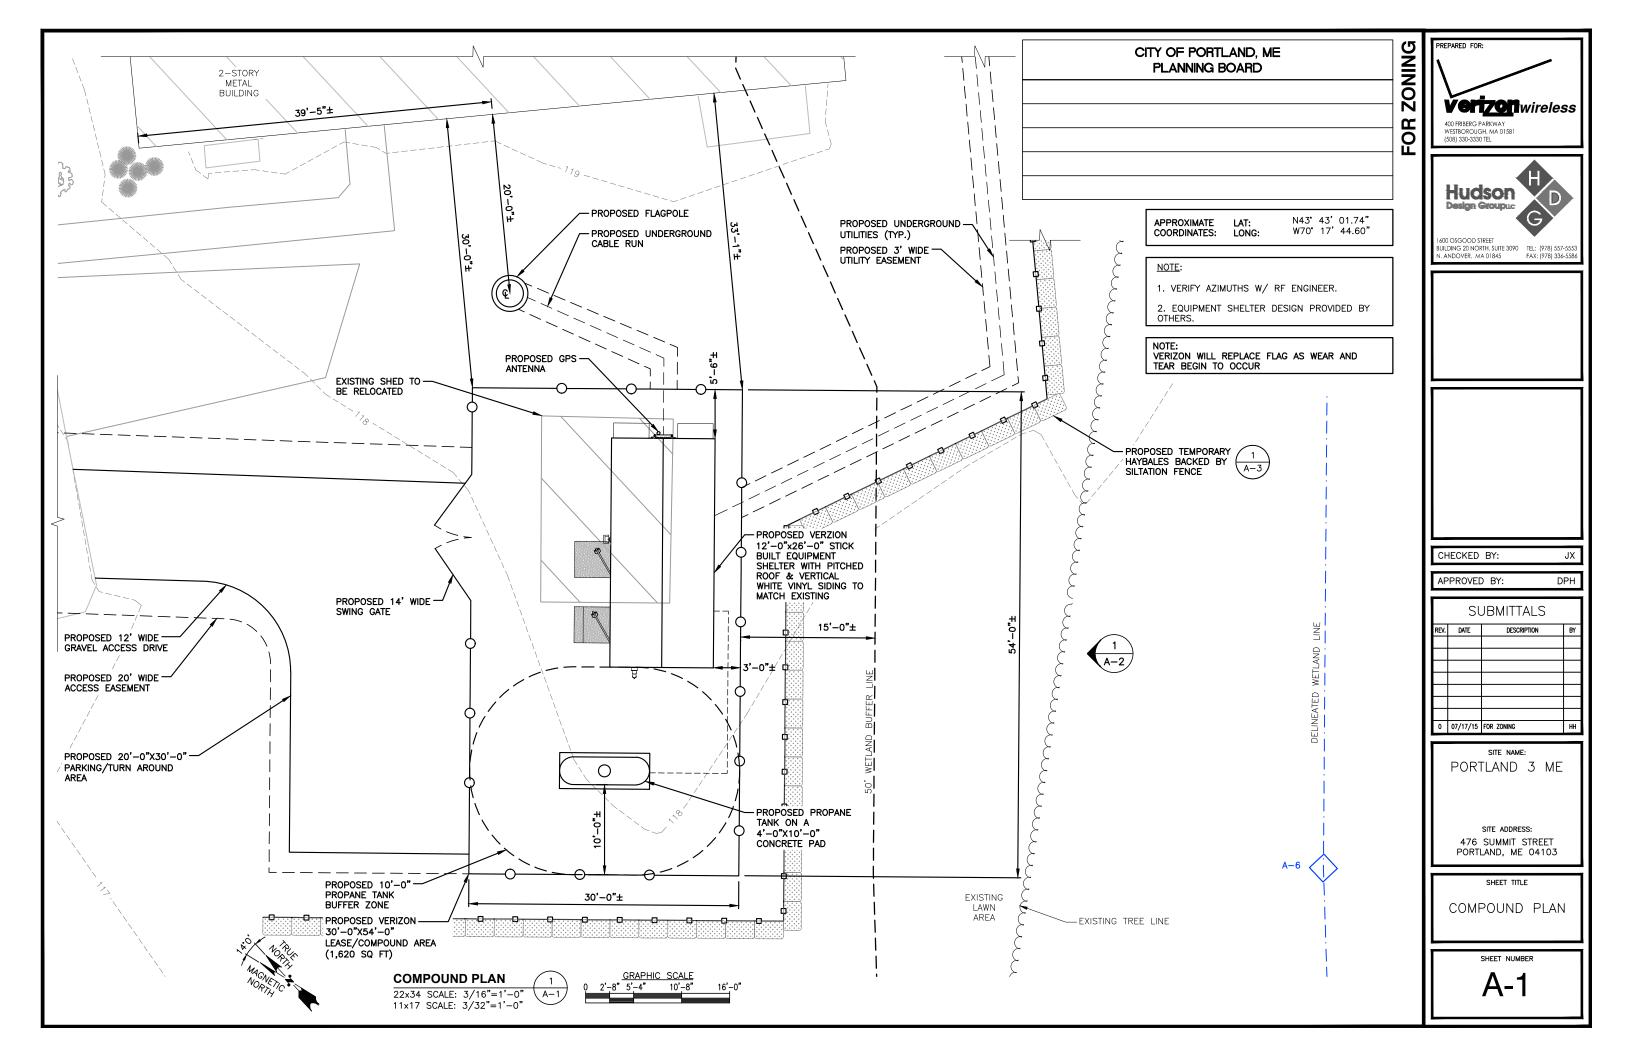
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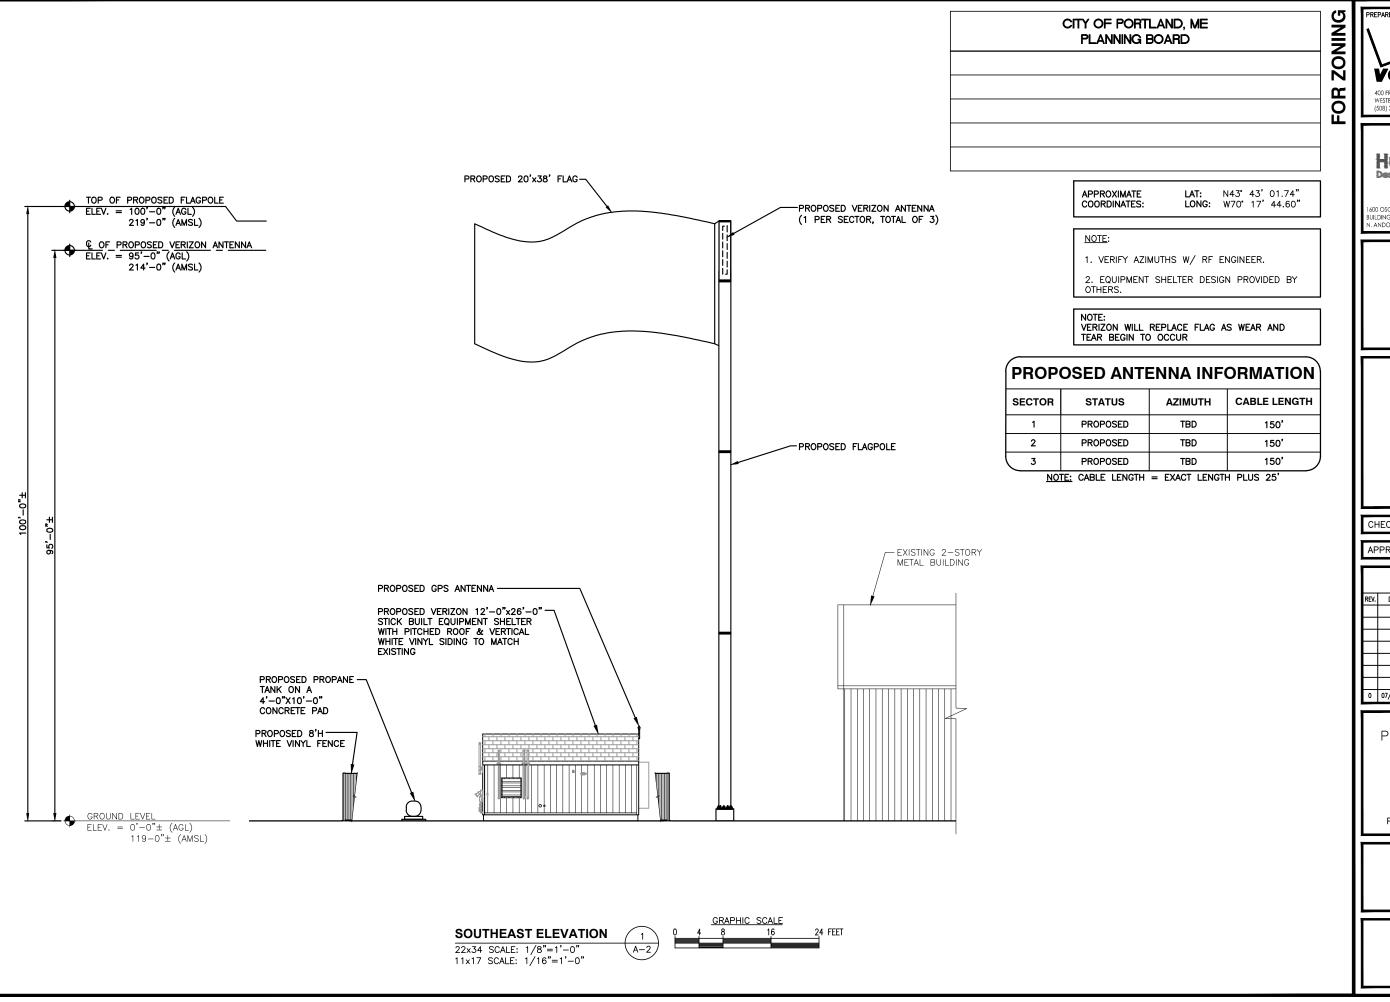
SITE ADDRESS: 476 SUMMIT STREET PORTLAND, ME 04103

SHEET TITLE

SITE PLAN

C-3









1600 OSGOOD STREET BUILDING 20 NORTH, SUITE 3090 TEL: {978} 557-5553 N. ANDOVER, MA 01845 FAX: {978} 336-5586

CHECKED BY:

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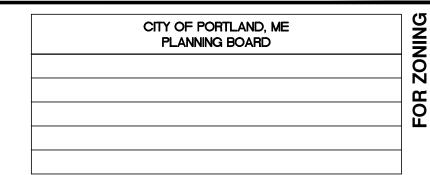
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SHEET TITLE

ELEVATION

SHEET NUMBER

A-2







FAX: (978) 336-558

### BUILDING 20 NORTH, SUITE 3090 TEL: (978) 557-5 ANDOVER MA 01845

#### CONSTRUCTION SPECIFICATION - SILT FENCE:

- 1. THE GEOTEXTILE FABRIC SHALL MEET THE DESIGN CRITERIA FOR SILT FENCES.
- 2. THE FABRIC SHALL BE EMBEDDED A MINIMUM OF 8 INCHES INTO THE GROUND AND THE SOIL COMPACTED OVER THE EMBEDDED FABRIC.
- 3. WOVEN WIRE FENCE SHALL BE FASTENED SECURELY TO THE FENCE POSTS WITH WIRE TIES OR STAPLES.
- 4. FILTER CLOTH SHALL BE FASTENED SECURELY TO THE WOVEN WIRE FENCE WITH TIES SPACED EVERY 24 INCHES AT THE TOP, MID-SECTION AND BOTTOM.
- 5. WHEN TWO SECTIONS OF FILTER CLOTH ADJOIN EACH OTHER, THEY SHALL BE OVERLAPPED BY 6 INCHES, FOLDED, AND STAPLED.
- 6. FENCE POSTS SHALL BE A MINIMUM OF 36 INCHES LONG AND DRIVEN A MINIMUM OF 16 INCHES INTO THE GROUND. WOOD POSTS SHALL BE OF SOUND QUALITY HARDWOOD AND SHALL HAVE A MINIMUM CROSS SECTIONAL AREA OF 3.0 SQUARE INCHES.
- 7. MAINTENANCE SHALL BE PERFORMED AS NEEDED TO PREVENT BULGES IN THE SILT FENCE DUE TO DEPOSITION OF SEDIMENT.

#### MAINTENANCE - SILT FENCE

- SILT FENCES SHALL BE INSPECTED IMMEDIATELY AFTER EACH RAINFALL AND AT LEAST DAILY DURING PROLONGED RAINFALL. ANY REPAIRS THAT ARE REQUIRED SHALL BE MADE IMMEDIATELY.
- 2. IF THE FABRIC ON A SILT FENCE SHOULD DECOMPOSE OR BECOME INEFFECTIVE DURING THE EXPECTED LIFE OF THE FENCE, THE FABRIC SHALL BE REPLACED PROMPTLY.
- 3. SEDIMENT DEPOSITS SHOULD BE INSPECTED AFTER EVERY STORM EVENT. THE DEPOSITS SHOULD BE REMOVED WHEN THEY REACHED APPROXIMATELY ONE-HALF THE HEIGHT OF THE BARRIER.
- SEDIMENT DEPOSITS THAT ARE REMOVED OR LEFT IN PLACE AFTER THE FABRIC HAS BEEN REMOVED SHALL BE GRADED TO CONFORM WITH THE EXISTING TOPOGRAPHY AND VEGETATED.
- 5. REMOVE ALL SEDIMENTATION CONTROLS AFTER SOIL IS STABILIZED.


#### **EROSION CONTROL MEASURES:**

- 1. DISTURBED AREAS SHALL BE KEPT TO THE MINIMUM AREA NECESSARY TO CONSTRUCT THE ROADWAYS AND ASSOCIATED DRAINAGE FACILITIES.
- 2. HAY BALE BARRIERS AND SEDIMENT TRAPS SHALL BE INSTALLED AS REQUIRED. BARRIERS AND TRAPS ARE TO BE MAINTAINED AND CLEANED UNTIL ALL SLOPES HAVE A HEALTHY STAND OF GRASS.
- 3. BALED HAY AND MULCH SHALL BE MOWINGS OF ACCEPTABLE HERBACEOUS GROWTH, FREE FROM NOXIOUS WEEDS OR WOODY STEMS, AND SHALL BE DRY. NO SALT HAY SHALL BE USED.
- 4. FILL MATERIAL SHALL BE FREE FROM STUMPS, WOOD, ROOTS, ETC.
- 5. STOCKPILED MATERIALS SHALL BE PLACED ONLY IN AREAS SHOWN ON THE PLANS. STOCKPILES SHALL BE PROTECTED BY SILTATION FENCE AND SEEDED TO PREVENT EROSION. THESE MEASURES SHALL REMAIN UNTIL ALL MATERIAL HAS BEEN PLACED OR DISPOSED OFF SITE.
- 6. ALL DISTURBED AREAS SHALL BE LOAMED AND SEEDED. A MINIMUM OF 4 INCHES OF LOAM SHALL BE INSTALLED WITH NOT LESS THAN ONE POUND OF SEED PER 50 SQUARE YARDS OF AREA.
- 7. APPLICATION OF GRASS SEED, FERTILIZERS AND MULCH SHALL BE ACCOMPLISHED BY BROADCAST SEEDING OR HYDROSEEDING AT THE RATES OUTLINED BELOW:

	LIMESTONE:	/5-100 LBS./1,000 SQ F1
	FERTILIZER:	RATE RECOMMENDED BY MANUFACTURER
	MULCH:	HAY MULCH APPROXIMATELY 3 TON/ACRE UNLESS
EROSION		CONTROL MATTING IS USED
	SEED MIX:	(SLOPES LESS THAN 4:1) LBS./ACRE
		CREEPING RED RESCUE 20
		TALL RESCUE 20
		REDTOP <u>2</u> 42
		42

(SLOPES GREATER THAN 4:1) LBS./ACRE CREEPING RED RESCUE 20 20 TALL RESCUE BIRDSFOOT TREEFOIL

- 8. AFTER ALL DISTURBED AREAS HAVE BEEN STABILIZED THE TEMPORARY EROSION CONTROL MEASURES ARE TO BE REMOVED.
- 9. ALL CATCH BASIN INLETS WILL BE PROTECTED WITH LOW POINT SEDIMENTATION BARRIER.
- 10. ALL STORM DRAINAGE OUTLETS WILL BE STABILIZED AND CLEANED AS REQUIRED, BEFORE THE DISCHARGE POINTS BECOME OPERATIONAL.
- 11. ALL DEWATERING OPERATIONS MUST DISCHARGE DIRECTLY INTO A SEDIMENT FILTER AREA.
- 12. NO DISCHARGE SHALL BE DIRECTED TOWARDS ANY PROPOSED DITCHES, SWALES, OR PONDS UNTIL THEY HAVE BEEN PROPERLY STABILIZED.

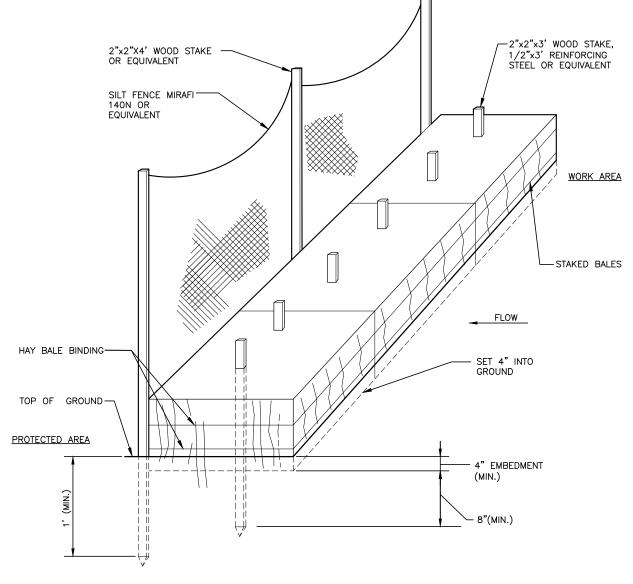

**HAY BALES / SILT FENCE DETAIL** SCALE: N.T.S. A-3 CHECKED BY: APPROVED BY

**SUBMITTALS** DESCRIPTION 0 07/17/15 FOR ZONING

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PORTLAND 3 ME

SITE ADDRESS: 476 SUMMIT STREET PORTLAND, ME 04103

SHEET TITLE **EROSION CONTROL** NOTES & DETAIL