

1 DEMOLITION PLAN SCALE: 1/8" = 1'-0"

2 PARTITION DETAIL SCALE: 1/2" = 1'-0"

EXISTING CONDITIONS GENERAL NOTE:
 BY THE G.C. SHALL NOTIFY THE ARCHITECT WHERE THE EXISTING CONDITIONS DEMAND VARIANCE FROM THE ARCHITECT'S INTENT. ON-SITE CONDITIONS INCLUDING THE LOCATION & VERIFICATION OF ALL STRUCTURAL CONDITIONS. THE EXISTING CONDITIONS SHALL BE VERIFIED BY THE G.C. TO REMOVE EXISTING MASONRY PER, EXISTING CANOPY COLUMN TO REMAIN. G.C. TO VERIFY SIZE OF PIER BELOW X.3/X.A & REPORT TO STRUCTURAL ENGINEER.

DEMOLITION SPECIFICATIONS:

1. GENERAL
 A. SUBMIT FOR APPROVAL, SELECTIVE DEMOLITION SCHEDULE, INCLUDING SCHEDULE AND METHODS FOR CAPPING AND CONTINUING UTILITY SERVICES. USE ADEQUATE NUMBERS OF SKILLED WORKERS WHO ARE THOROUGHLY TRAINED AND EXPERIENCED IN THE NECESSARY CRAFTS AND WHO ARE FAMILIAR WITH THE SPECIFIED REQUIREMENTS AND THE METHODS NEEDED FOR PROPER PERFORMANCE OF THE WORK OF THIS SECTION.
 B. ALL WORK SHALL COMPLY WITH THE RULES AND REGULATIONS OF THE DIVISION OF INDUSTRIAL SAFETY, OSHA, 29 CFR 10 AND ALL OTHER LOCAL, STATE AND FEDERAL AGENCIES AND AUTHORITIES HAVING JURISDICTION.
 C. DEMOLITION CONTRACTOR SHALL COORDINATE AND BE RESPONSIBLE FOR ALL CITY OF PORTLAND AND STATE OF MAINE REQUIREMENTS FOR PROTECTION OF PERSONS, PROPERTY, BARRICADES, TEMP, LIGHTING, ETC. FOR THE DURATION OF THE DEMOLITION CONTRACT.
 D. GENERAL CONTRACTOR SHALL COORDINATE AND BE RESPONSIBLE FOR ALL CITY OF PORTLAND AND STATE OF MAINE REQUIREMENTS FOR PROTECTION OF PERSONS, PROPERTY, BARRICADES, TEMP, LIGHTING, ETC. FOR THE DURATION OF THE DEMOLITION CONTRACT.
 E. GENERAL CONTRACTOR TO PROVIDE AND COORDINATE A SCHEDULE FOR DEMOLITION TO CONFORM WITH SCHEDULING FOR OTHER TRADES REQUIRED TO COMPLETE OR PERFORM A DIRECTLY RELATED PORTION OF WORK. THE G.C. SHALL COORDINATE WITH OWNER AND ADJUSTERS REGARDING DEMOLITION, NOISE, ETC. PRIOR TO CONSTRUCTION AT A PRE-CONSTRUCTION CONFERENCE.
 F. OTHER TRADES REQUIRED TO COMPLETE OR PERFORM A DIRECTLY RELATED PORTION OF WORK. THE G.C. SHALL COORDINATE WITH OWNER AND ADJUSTERS REGARDING DEMOLITION, NOISE, ETC. PRIOR TO CONSTRUCTION AT A PRE-CONSTRUCTION CONFERENCE.

2. HANDLING
 A. WHEN THE NATURE OF DEMOLITION WORK REQUIRES THEIR USE, ERECT AND MAINTAIN DUST CHUTES & BARRIERS FOR THE DISPOSAL OF MATERIALS, RUBBISH, AND DEBRIS.
 B. REMOVE AND SALVAGE DEBRIS FROM THE SITE AS IT ACCUMULATES ON A DAILY BASIS. DO NOT STORE, SETTLE, BURN, OR OTHERWISE DISPOSE OF DEBRIS IN SUCH A MANNER AS TO PRESENT A HAZARD TO THE PUBLIC. ALL PAYMENTS AND AREAS ADJACENT TO AND LEADING FROM THE SITE, CLEAN AND FREE OF MUD, DIRT, AND DEBRIS AT ALL TIMES. ALL MATERIALS SHALL BE DISPOSED OF IN A LEGAL MANNER OFF-SITE.
 C. ERECT AND MAINTAIN TEMPORARY BRACING, SHORING FOR CONSTRUCTION EQUIPMENT, GIBBSING & OTHER TEMPORARY SUPPORTS AS REQUIRED. ANY AND ALL FORMS OF SCAFFOLDING, PARTITIONS, BARRICADES, WARNING SIGNS, LIGHTS, AND GUARDS NECESSARY TO PROTECT ADJACENT BUILDING OCCUPANTS, AND WORKERS FROM INJURY, AND/OR DAMAGE, ALL IN ACCORDANCE WITH APPLICABLE RULES AND REGULATIONS, COMPLY WITH APPLICABLE REQUIREMENTS OF OSHA AND OTHER GOVERNING BODIES HAVING JURISDICTION AT THE SITE.
 D. DO NOT DAMAGE BUILDING ELEMENTS AND IMPROVEMENTS INDICATED TO REMAIN. ITEMS OF SALVAGE VALUE WHICH ARE NOT INCLUDED ON SCHEDULE OF SALVAGE ITEMS TO BE RETURNED TO OWNER SHALL BE REVIEWED WITH OWNER AS TO WHETHER THEY CAN BE REMOVED FROM THE SITE AND DISPOSED OF USING LEGAL METHODS.
 E. DO NOT CLOSE OR OBSTRUCT THE MEANS OF EGRESS, CORRIDORS, OR OTHER OCCUPIED SPACES. REVIEW ANY SCHEDULE OR PHASING ISSUES EOR, BKA ARCHITECTS AND CITY OF PORTLAND, ME. PROJECT REPRESENTATIVE, DO NOT INTERFERE WITH THE WRITTEN PERMISSIONS OF THE OWNER OR AUTHORITY HAVING JURISDICTION. IF NECESSARY, PROVIDE TEMPORARY UTILITIES.
 F. CEASE OPERATIONS IF PUBLIC SAFETY OR REMAINING STRUCTURES ARE ENDANGERED. PERFORM TEMPORARY CORRECTIVE MEASURES UNTIL OPERATIONS CAN BE CONTINUED PROPERLY.
 G. SEQUENCING AND EXECUTION
 A. BY CAREFUL STUDY OF THE CONTRACT DOCUMENTS, DETERMINE THE LOCATION AND EXTENT OF SELECTIVE DEMOLITION TO BE PERFORMED.
 B. VISIT THE SITE AND VERIFY THE EXTENT AND LOCATION OF SELECTIVE DEMOLITION REQUIRED PRIOR TO STARTING THE WORK.
 C. IDENTIFY LIMITS OF SELECTIVE DEMOLITION.
 1. CAREFULLY INTERFERE WITH THE WORK OF OTHER CONTRACTORS.
 2. MARK INTERFERENCE SURFACES AS REQUIRED TO ENABLE WORKMAN TO ALSO IDENTIFY ITEMS TO BE REMOVED AND SORTED FOR RECYCLING. INTACT, ITEMS TO BE SALVAGED AND/OR FOR REUSE AND RELOCATION, AND ITEMS TO BE REMOVED AND SORTED FOR RECYCLING.
 C. PREPARE AND FOLLOW AN ORGANIZED PLAN FOR DEMOLITION AND REMOVAL OF ITEMS.
 1. SHUT OFF, CAP, AND OTHERWISE PROTECT EXISTING UTILITY LINES IN ACCORDANCE WITH THE REQUIREMENTS OF THE PUBLIC AGENCY OR UTILITY HAVING JURISDICTION. NOTIFY DIG-SAFE AND CITY OF PORTLAND, ME, PRIOR TO EXCAVATION.
 2. COMPLETELY REMOVED ITEMS SCHEDULED TO BE SO DEMOLISHED AND REMOVED, LEAVING SURFACES CLEAN, SOUND, AND READY TO RECEIVE NEW MATERIALS SPECIFIED ELSEWHERE. IN ALL ACTIVITIES, COMPLY WITH PERMITTING REGULATIONS & GOVERNMENTAL AGENCIES HAVING JURISDICTION.
 D. USE MEANS NECESSARY TO PREVENT DUST BECOMING A NUISANCE TO WORKERS IN THE BUILDING, THE PUBLIC, NEIGHBORING BUILDINGS, AND TO OTHER WORK BEING PERFORMED.
 E. SCHEDULE & EXECUTE DEMOLITION WORK TO ENSURE SAFETY OF PERSONS AND ADJACENT PROPERTY AGAINST DAMAGE BY WIND-BLOWN OR FALLING DEBRIS.
 F. IN THE EVENT DEMOLITION OF ITEMS NOT SO SCHEDULED, PROMPTLY REPLACE SUCH ITEMS TO THE APPROVAL OF THE ARCHITECT AT AN ADDITIONAL INCREASE IN COST OR TIME TO THE OWNER.
 G. WHERE EXISTING CONSTRUCTION TO REMAIN IS AFFECTED BY DEMOLITION OR INSTALLATION OF NEW WORK, PATCH, REPAIR OR REPLACE THE WORK AT SURFACES WHICH HAVE BEEN DAMAGED AND FINISH TO MATCH EXISTING (T.M.E.) ADVISORY CONSTRUCTION.
 H. FINISH NEW AND EXISTING SURFACES AS SCHEDULED, CLEAN EXISTING SURFACES OF DIRT, GREASE, AND LOOSE PAINT BEFORE REFINISHING.
 I. COORDINATE THE REMOVAL, RELOCATION, REPLACEMENT, RE-USE, SHUT-OFF, STUB-OFF, CAPPING-OFF, OR UPGRADING OF ALL EXISTING PLUMBING, HVAC, FIRE ALARM, SECURITY AND ELECTRICAL SYSTEMS, EQUIPMENT, AND APPURTENANCES - INCLUDING, BUT NOT LIMITED TO, UTILITIES, CONDUITS, PANELS, PIPES, FLEXIBLES, CONTROLS, VALVES, CONTROLS, PANELS, AND CONDUIT DURING CONSTRUCTION.
 J. COORDINATE THE REMOVAL, RELOCATION, REPLACEMENT, RE-USE, SHUT-OFF, STUB-OFF, CAPPING-OFF, OR UPGRADING OF ALL EXISTING PLUMBING, HVAC, FIRE ALARM, SECURITY AND ELECTRICAL SYSTEMS, EQUIPMENT, AND APPURTENANCES - INCLUDING, BUT NOT LIMITED TO, UTILITIES, CONDUITS, PANELS, PIPES, FLEXIBLES, CONTROLS, VALVES, CONTROLS, PANELS, AND CONDUIT DURING CONSTRUCTION.
 K. COORDINATE THE REMOVAL, RELOCATION, REPLACEMENT, RE-USE, SHUT-OFF, STUB-OFF, CAPPING-OFF, OR UPGRADING OF ALL EXISTING PLUMBING, HVAC, FIRE ALARM, SECURITY AND ELECTRICAL SYSTEMS, EQUIPMENT, AND APPURTENANCES - INCLUDING, BUT NOT LIMITED TO, UTILITIES, CONDUITS, PANELS, PIPES, FLEXIBLES, CONTROLS, VALVES, CONTROLS, PANELS, AND CONDUIT DURING CONSTRUCTION.
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 M. COORDINATE THE REMOVAL, RELOCATION, REPLACEMENT, RE-USE, SHUT-OFF, STUB-OFF, CAPPING-OFF, OR UPGRADING OF ALL EXISTING PLUMBING, HVAC, FIRE ALARM, SECURITY AND ELECTRICAL SYSTEMS, EQUIPMENT, AND APPURTENANCES - INCLUDING, BUT NOT LIMITED TO, UTILITIES, CONDUITS, PANELS, PIPES, FLEXIBLES, CONTROLS, VALVES, CONTROLS, PANELS, AND CONDUIT DURING CONSTRUCTION.
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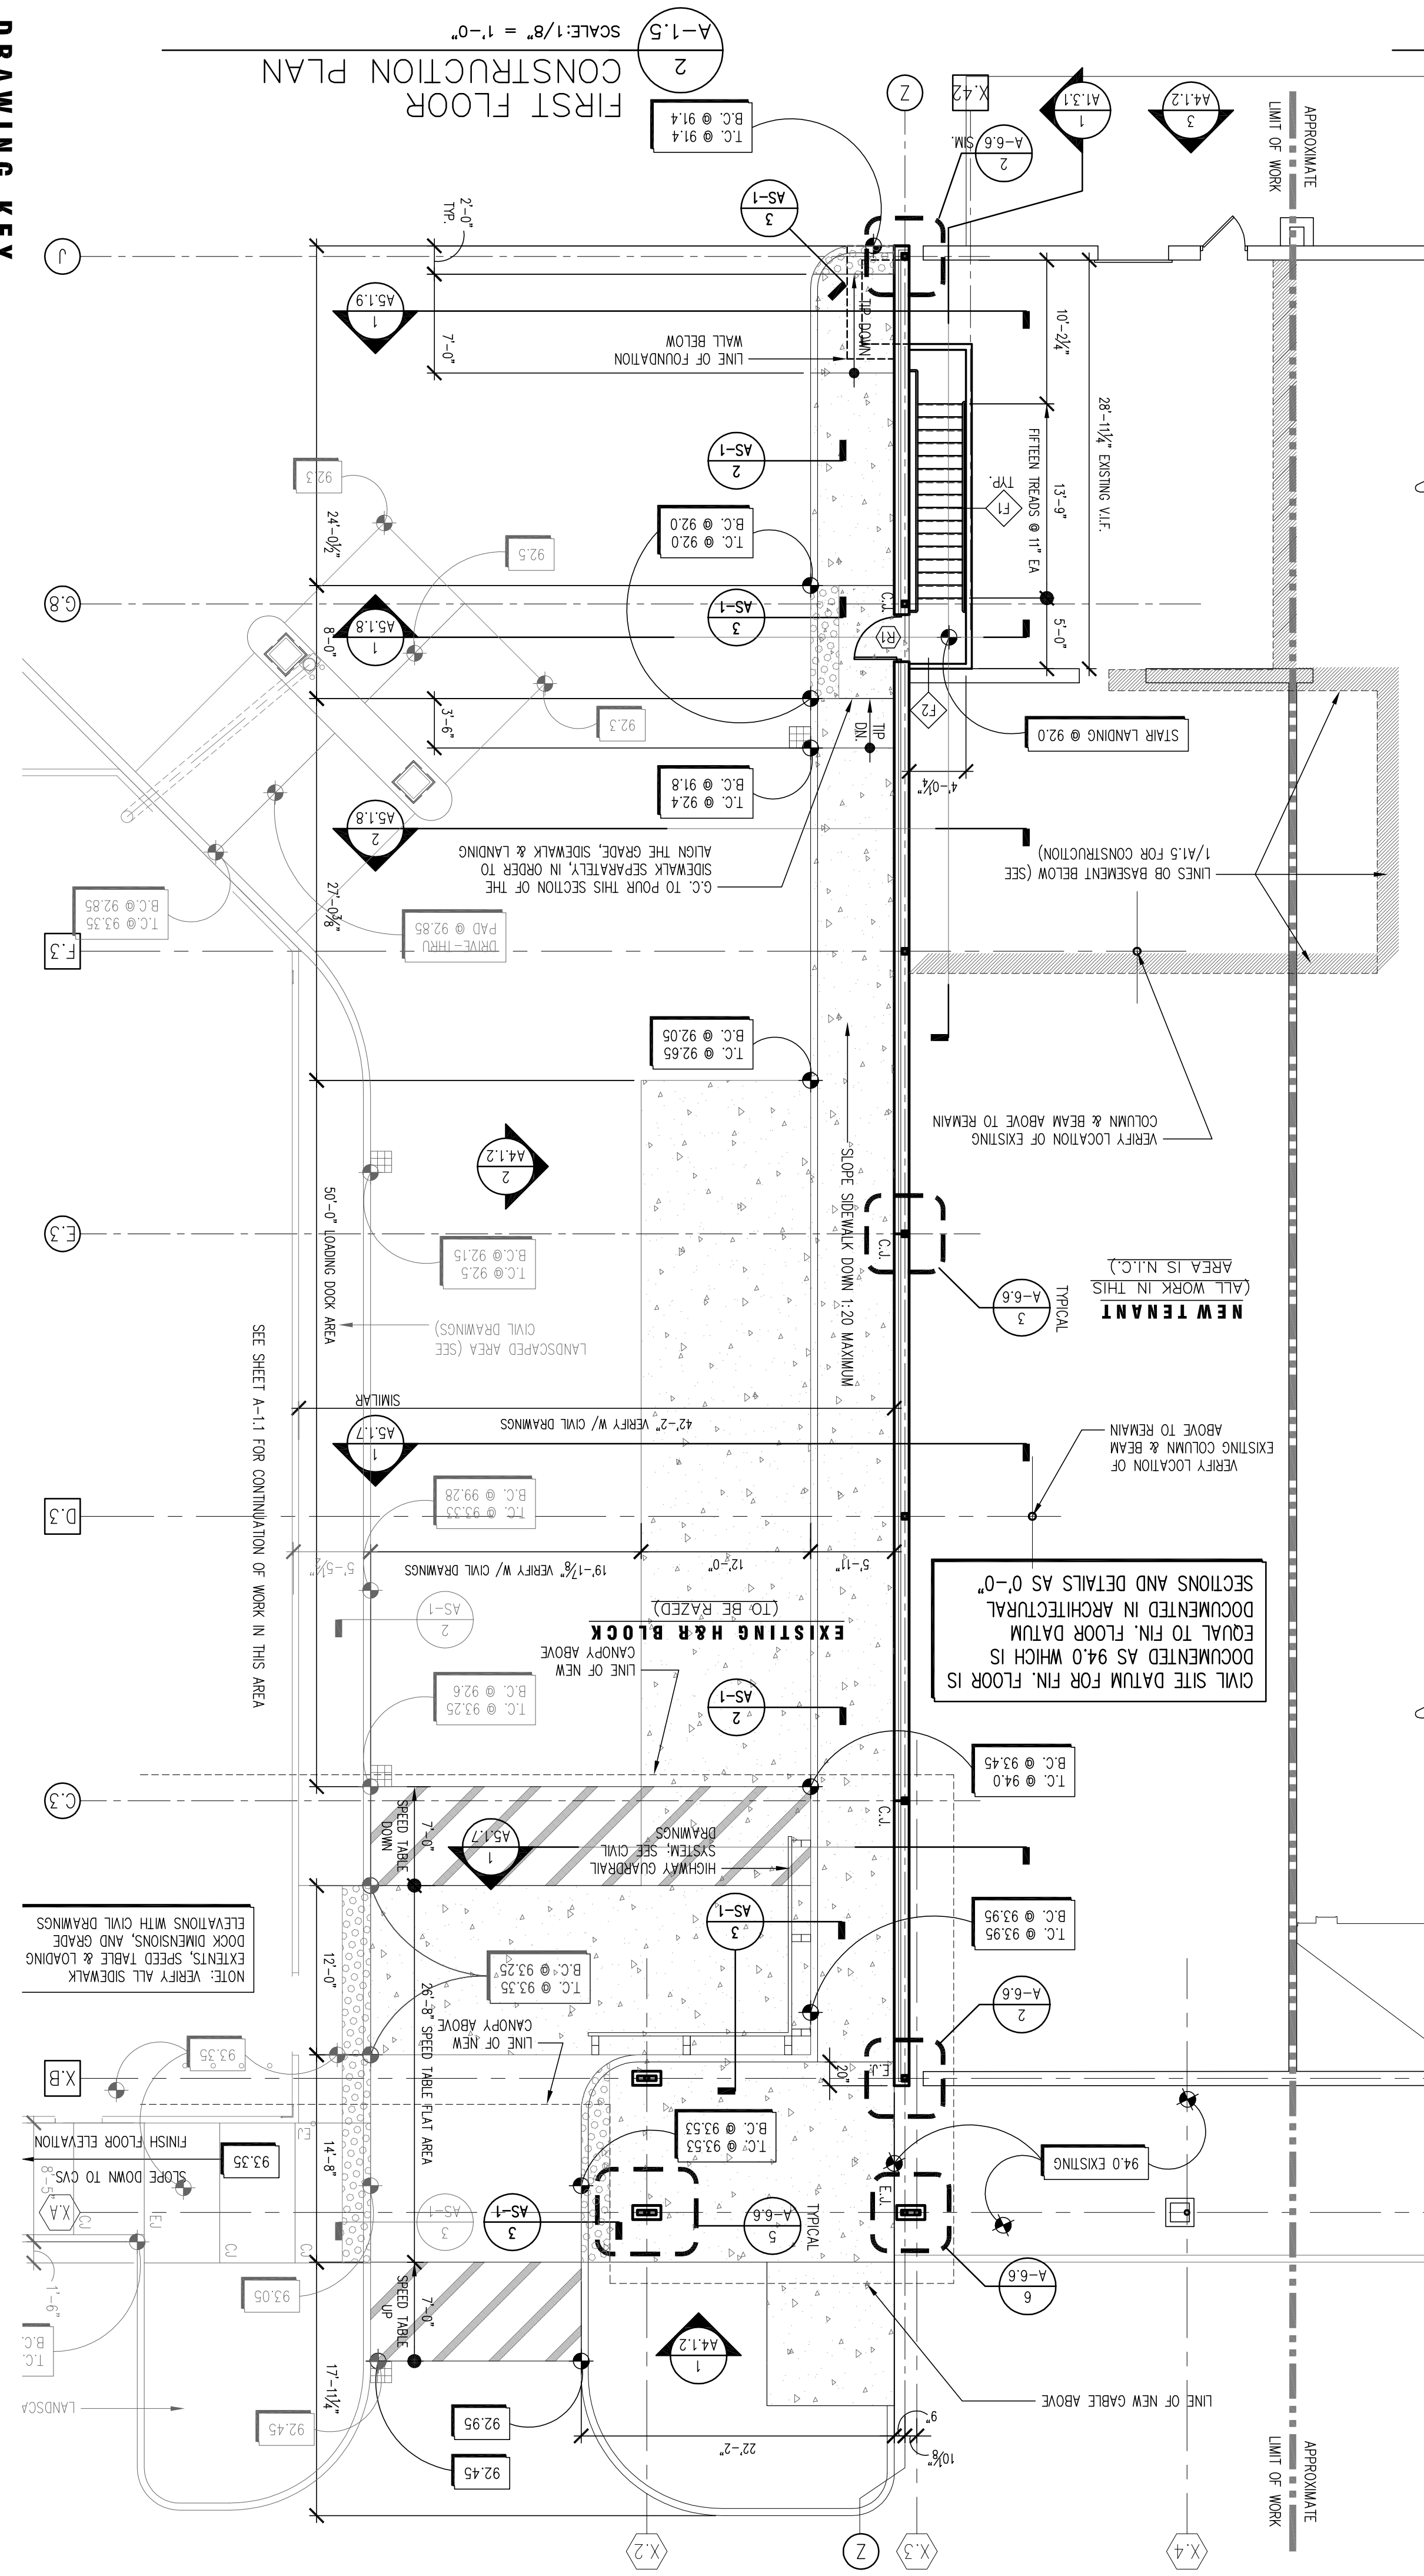
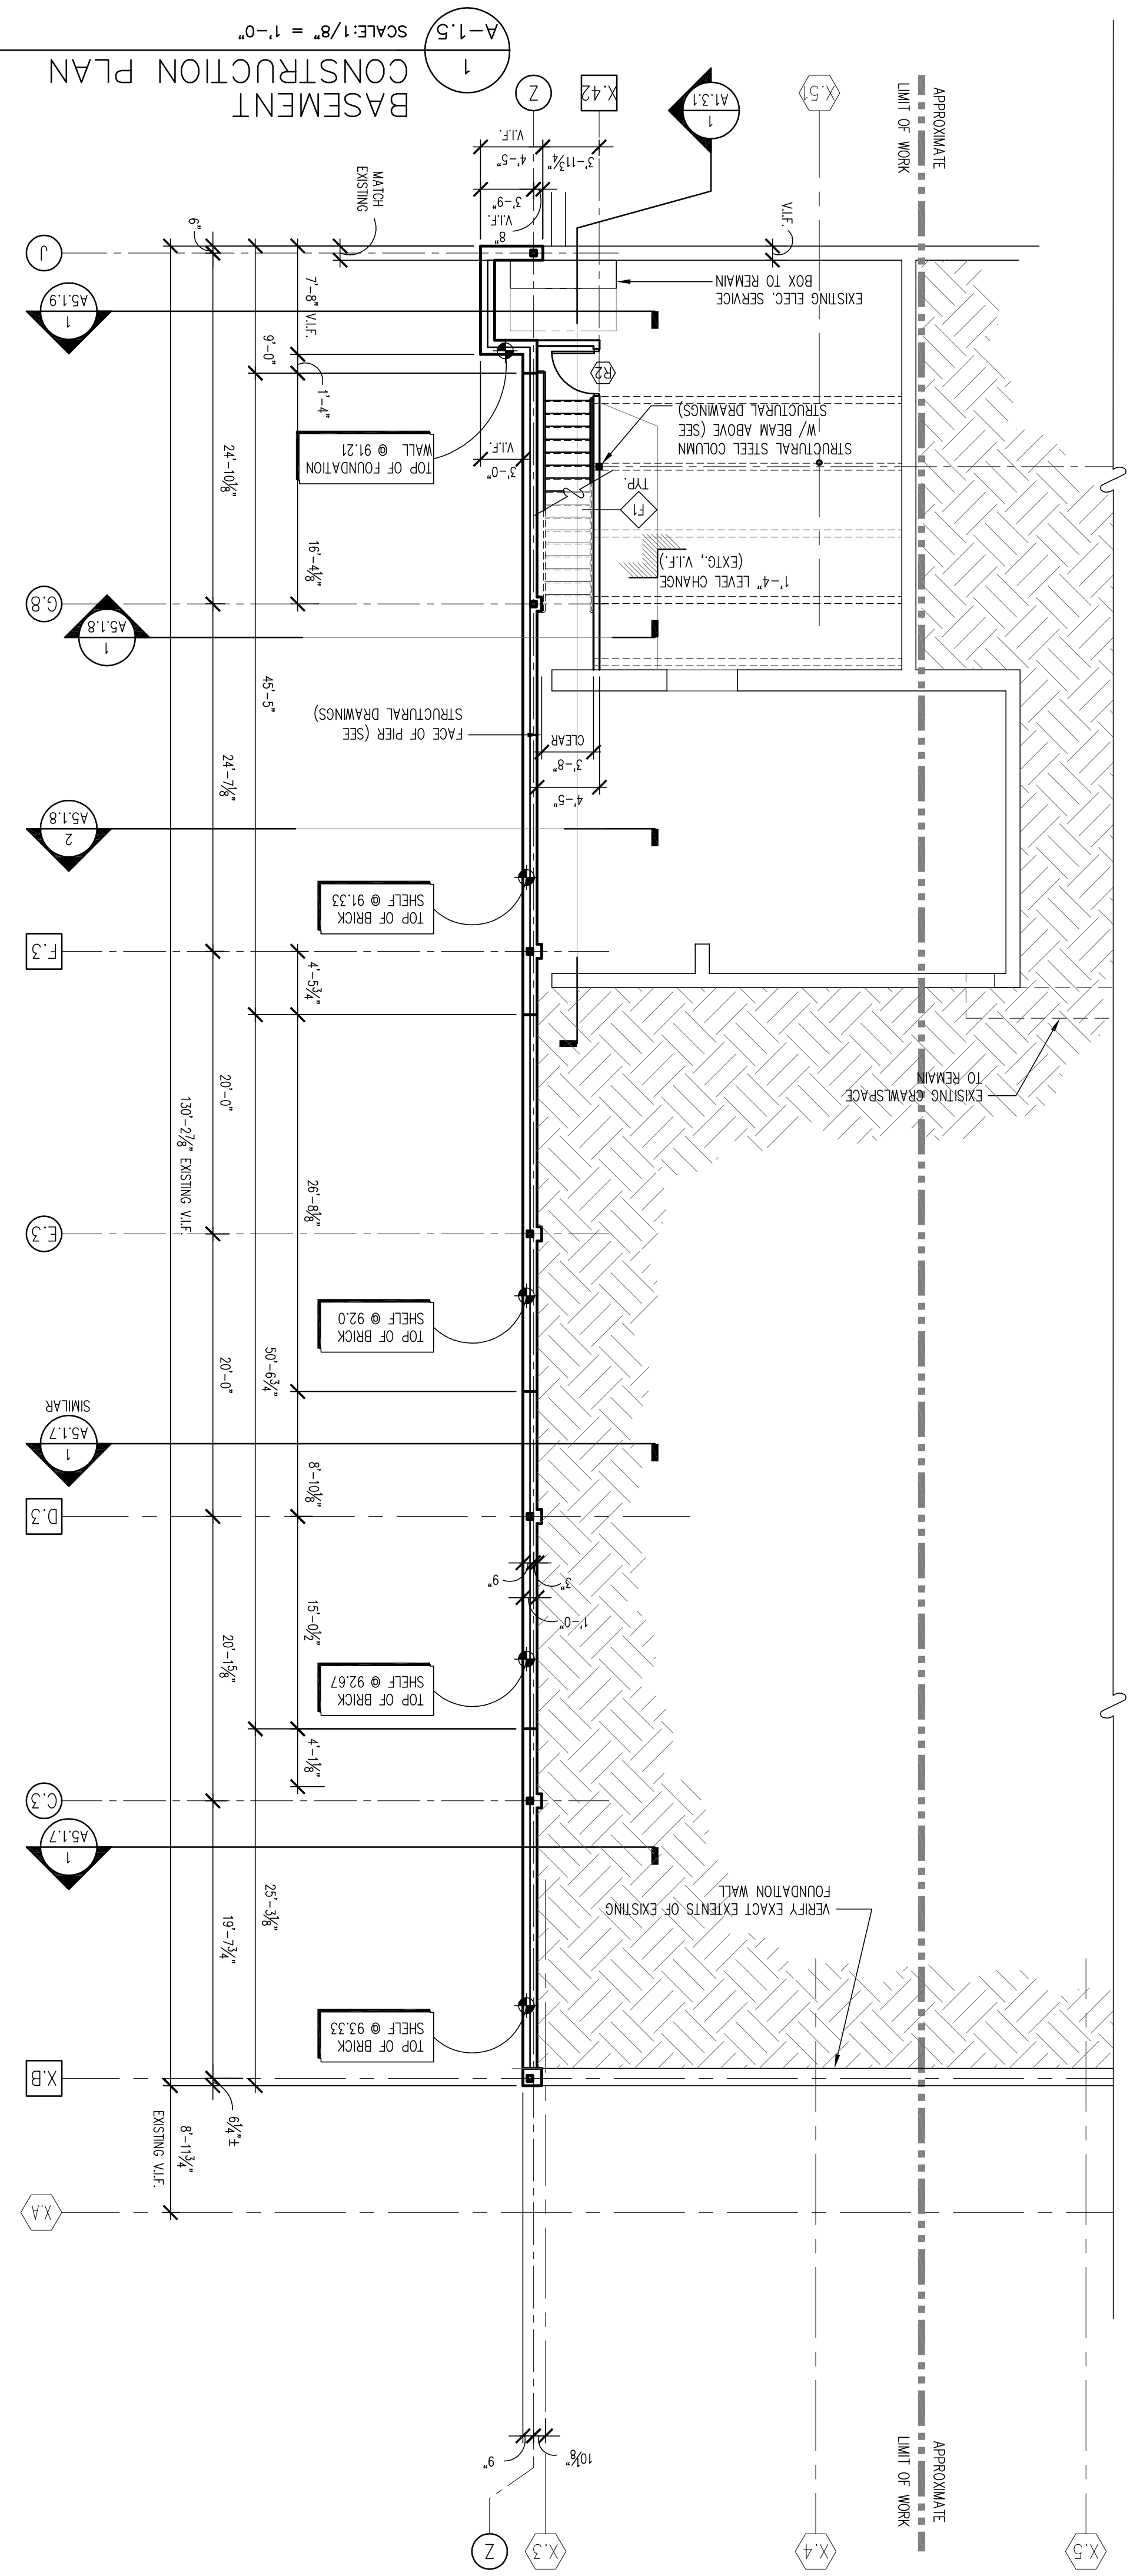
NEW
 STORE NUMBER: 329
 91 AUBURN STREET
 PORTLAND, MAINE

DEVELOPER:
 A & D REALTY, LLC
 5 MILITIA DRIVE
 LEXINGTON, MA 02421

REVISIONS:

DRAWING BY: RTK
DATE: XX/XX/XX
JOB NUMBER: 209017
TITLE: DEMOLITION PLANS & NOTES
SHEET NUMBER: D-1.1

COMMENTS:
 PROCESS - NOT FOR CONSTRUCTION (8/3/09)



DRAWING KEY

- (X2) EXISTING COLUMN LINE TO REMAIN
- (X1) EXISTING COLUMN LINE TO BE DEMOLISHED
- (A) NEW COLUMN LINE
- (A) WITH NEW COLUMN CONSTRUCTION
- (X2) EXISTING WALL OR LINE TO REMAIN
- (X1) EXISTING WALL OR ITEM TO BE DEMOLISHED
- (A) NEW TEMPORARY PARTITION (SEE DETAIL 2/D-1)
- (A) NEW WALL OR PARTITION
- (A) NEW DOOR AND FRAME ASSEMBLY TO BE DEMOLISHED
- (A) NEW DOOR AND FRAME ASSEMBLY TO REMAIN

DESIGN/BUILD NOTES

- The G.C. and the DESIGN/BUILD (D/B) SUBCONTRACTORS SHALL BE RESPONSIBLE FOR PROVIDING COMPLETE D/B PLUMBING, FIRE PROTECTION, H.V.A.C., A.V. SYSTEMS, SMOKE & HEAT DETECTORS, ELECTRICAL DESIGN AND LAYOUT DRAWINGS WITH CALCULATIONS & LOADS WHICH CONFORM TO ALL STATE AND LOCAL CODES, STAMPED AND CERTIFIED BY A REGISTERED P.E. AS REQUIRED BY THE TOWN OF PLYMOUTH BUILDING & FIRE DEPT'S. AT THE TIME OF PERMIT & AT THE TIME OF PROJECT CLOSE-OUT, THIS INCLUDES ANY ENERGY CONSERVATION DATA AND MATERIALS AS REQUIRED PER THE I.E.C.C. (INTERNATIONAL ENERGY CONSERVATION CODE).
- The G.C. SHALL BE RESPONSIBLE FOR COORDINATING WITH THE CITY OF PORTLAND, MAINE, FIRE DEPARTMENT, CONFORM TO RHODE ISLAND BUILDING CODE FIRE REGULATIONS AND NFPA-10.
- COORDINATE BLOCKING FOR ALL WALL MOUNTED EQUIPMENT AND ACCESSORIES.
- PERFORM ALL WORK IN ACCORDANCE WITH THE R.I.B.C., AND ADAAG, AS WELL AS ALL MUNICIPAL BYLAWS AND FIRE SAFETY STATUTES.
- The G.C. SHALL BE RESPONSIBLE FOR D/B SUBCONTRACTOR'S CONFORMANCE TO R.I.B.C. REQUIREMENTS FOR MECHANICAL AND ELECTRICAL SYSTEM AND COMPONENT SEISMIC PERFORMANCE.
- ALL CONSTRUCTION SHALL CONFORM TO THE TENETS OF AIA DOCUMENT A201: GENERAL CONDITIONS OF THE CONTRACT FOR CONSTRUCTION.
- The G.C. SHALL COORDINATE THE WORK OF ALL TRADES REGARDING CEILING-MOUNTED AND ABOVE-CEILING-MOUNTED EQUIPMENT, DEVICES AND FIXTURES.
- The G.C. AND D/B ELECTRICAL SUBCONTRACTOR SHALL BE RESPONSIBLE FOR THE ELECTRICAL DESIGN, ENGINEERING, LAYOUT, AND INSTALLATION TO SUIT THE WORK. HE/SHE SHALL COORDINATE POWER, WIRING AND CABLEING, LIGHTING, DEVICES, EQUIPMENT, TERMINATIONS, CIRCUITS AND PANEL LOCATION, COORDINATE ANY SPECIAL ELECTRICAL DEVICES OR EQUIPMENT REQUIREMENTS WITH THE OWNER PRIOR TO WORK. USE THE ARCHITECTURAL DRAWINGS AS GUIDE ONLY.
- The G.C. AND D/B ELECTRICAL SUBCONTRACTOR SHALL REVIEW LIGHT FIXTURE SPECIFICATIONS WITH ARCHITECT AND OWNER PRIOR TO THE WORK.
- The G.C. AND D/B ELECTRICAL SUBCONTRACTOR SHALL BE RESPONSIBLE FOR CONFORMING TO NEC & ALL LATEST EDITIONS FOR ALL ELECTRICAL WORK.
- CONFIRM TO M.B.C., NFPA 70 & ADAAG MOUNTING HEIGHTS OF ALL DEVICES AND FIRE ALARM SYSTEM COMPONENTS.
- The D/B E.C. SHALL PROVIDE I.E.C.C. CALCULATIONS AND NARRATIVE FOR POWER AND LIGHTING AS REQUIRED BY THE TOWN OF PORTLAND.
- The D/B E.C. SHALL REVIEW EXISTING FIRE ALARM SYSTEM & BEACONS, EXIT DIRECTED BY THE TOWN OF PORTLAND FIRE DEPARTMENT & ALL AUTHORITIES HAVING JURISDICTION.
- COORDINATE WITH THE TOWN OF PORTLAND FIRE DEPARTMENT, CONFORM TO R.I.B.C. FIRE RES. AND NFPA-10. COORDINATE AND PROVIDE RELATED SIGNAGE.
- COORDINATE MASTER BOX, KNOX BOX, AND BEACON LOCATIONS WITH THE ELECTRICAL/FIRE ALARM DRAWINGS AND THE TOWN OF PORTLAND FIRE DEPARTMENT'S REQUIREMENTS, COORD. FINAL LOCATIONS W/ ARCHITECT.
- The GENERAL CONTRACTOR (G.C.) SHALL FIELD VERIFY ALL DIMENSIONS & CONDITIONS PRIOR TO THE WORK AND SHALL NOTIFY THE ARCHITECT REGARDING ANY DISCREPANCIES.
- The G.C. SHALL SUBMIT ALL SHOP DRAWINGS, SAMPLES, CATALOG CUTS ETC., INCLUDING COLOR CHARTS FOR PAINTS AND STAINS FOR ALL EXTERIOR AND INTERIOR FINISHES, TO THE ARCHITECT FOR SECTION REVIEW AND APPROVAL PRIOR TO FABRICATION, ORDERING, OR INSTALLATION. PRIORITIES ANY ABOVE-CEILING-MOUNTED EQUIPMENT, DEVICES AND FIXTURES.
- PERFORM ALL WORK IN ACCORDANCE WITH THE R.I.B.C., M.A.A.B., AND ADAAG, AS WELL AS ALL LOCAL CODES AND ORDINANCES.
- The G.C. AND SUBCONTRACTORS SHALL BE RESPONSIBLE FOR ALL PERMITS, FEES AS REQUIRED BY THE TOWN OF PORTLAND.
- The G.C. SHALL BE RESPONSIBLE FOR DAILY REMOVAL AND LEGAL DISPOSAL OF ALL DEBRIS OFF SITE.
- INSTALL A CONTINUOUS SEALANT BEAD ON BACKER ROD AT ALL JUNCTURES OF DISSIMILAR MATERIALS (E.G.: METAL TO CON., STEEL TO ALUMINUM) AND ALL MATERIAL JOINTS AS REQUIRED BY THE MANUFACTURER'S SPECIFICATIONS AND RECOMMENDATIONS, INDUSTRY STANDARDS AND GOOD PRACTICE.
- COORDINATE SOILD F.O.I.T.W. BLOCKING FOR ALL WALL MOUNTED EQUIPMENT AND ACCESSORIES, INCLUDING ITEMS NOTED BY M.A.B. SECTIONS 5 & 5.6. ADDITIONALLY, F.O.I.T.W. SHALL BE USED WHEREVER WOOD IS USED, UNLESS OTHERWISE ALLOWED BY MA 780 CMR OR OTHER APPLICABLE CODES.
- COORDINATE WITH THE TOWN OF PORTLAND FIRE DEPARTMENT, CONFORM TO R.I.B.C. FIRE RES. AND NFPA-10. COORDINATE AND PROVIDE RELATED SIGNAGE.
- FILL ALL VOIDS AT EXTERIOR WALL NOT VENTED TO THE EXTERIOR W/ZERO-DRAFT FOAM INSULATION LIMITATIONS ETC. BY LT GA MTL SUPPLIER/SUB-CONTRACTOR.

GENERAL NOTES

- COORDINATE THE ARCHITECTURAL CIVIL ENGINEER WITH THE ELECTRICAL, PLUMBING, FIRE PROTECTION, H.V.A.C. AND ELECTRICAL/FIRE ALARM DRAWINGS FOR THE VERIFICATION OF ALL PROJECT REQUIREMENTS WITH THE WORK OF ALL TRADES.
- REFER TO THE CIVIL ENGINEERING DRAWINGS FOR GRADING, UNDERGROUND AND SURFACE UTILITIES, SITE IMPROVEMENTS, REMAINING WALLS, UNDERGROUND DRAINAGE, DETENTION BASINS, EXTERIOR WALKS, PARKING, STRIPING, H.C. SIGNAGE/STAMPS, CURB CUTS, LIGHTING, LANDSCAPING, ETC.
- REFER TO THE ENGINEERED STRUCTURAL DRAWINGS FOR ALL NOTES, INFORMATION, AND DETAILS REGARDING FOOTINGS, FOUNDATIONS, SLABS, REINFORCEMENT, ANCHORING, BRACING, SUPERSTRUCTURE, FRAMING, CONNECTIONS, ETC.
- ALL INTERIOR DIMENSIONS ARE TAKEN FROM FACE OF C.W.B. TO FACE OF C.W.B. UNLESS SPECIFICALLY NOTED OTHERWISE. DO NOT SCALE DRAWINGS. REFER TO ENLARGED PLANS AND DETAILS FOR FURTHER DIMENSIONAL INFORMATION. ALL WORK LINES AND LEVELS SHALL BE LAID OUT BY WRITTEN DIMENSIONS. ANY DEVIATIONS SHALL BE CORRECTED BY THE CONTRACTOR BEFORE HE BEGINS HIS PORTION OF THE WORK. RECORD ALL MODIFICATIONS ON THE "AS-BUILTS" - DAILY.
- THE ENGINEER AND ARCHITECT SHALL BE RESPONSIBLE FOR THE ATTENTION OF ALL PERMITS AND DISCREPANCIES WITH THE CITY OF PORTLAND FIRE DEPARTMENT AND INSTALLATION, CONFORM TO R.I.B.C. FIRE RES. AND NFPA-10. COORDINATE AND PROVIDE RELATED SIGNAGE.
- COORDINATE MASTER BOX, KNOX BOX, AND BEACON LOCATIONS WITH THE ELECTRICAL/FIRE ALARM DRAWINGS AND THE TOWN OF PORTLAND FIRE DEPARTMENT'S REQUIREMENTS, COORD. FINAL LOCATIONS W/ ARCHITECT.
- The GENERAL CONTRACTOR (G.C.) SHALL FIELD VERIFY ALL DIMENSIONS & CONDITIONS PRIOR TO THE WORK AND SHALL NOTIFY THE ARCHITECT REGARDING ANY DISCREPANCIES.
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- PERFORM ALL WORK IN ACCORDANCE WITH THE R.I.B.C., M.A.A.B., AND ADAAG, AS WELL AS ALL LOCAL CODES AND ORDINANCES.
- The G.C. AND SUBCONTRACTORS SHALL BE RESPONSIBLE FOR ALL PERMITS, FEES AS REQUIRED BY THE TOWN OF PORTLAND.
- The G.C. SHALL BE RESPONSIBLE FOR DAILY REMOVAL AND LEGAL DISPOSAL OF ALL DEBRIS OFF SITE.
- INSTALL A CONTINUOUS SEALANT BEAD ON BACKER ROD AT ALL JUNCTURES OF DISSIMILAR MATERIALS (E.G.: METAL TO CON., STEEL TO ALUMINUM) AND ALL MATERIAL JOINTS AS REQUIRED BY THE MANUFACTURER'S SPECIFICATIONS AND RECOMMENDATIONS, INDUSTRY STANDARDS AND GOOD PRACTICE.
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- COORDINATE WITH THE TOWN OF PORTLAND FIRE DEPARTMENT, CONFORM TO R.I.B.C. FIRE RES. AND NFPA-10. COORDINATE AND PROVIDE RELATED SIGNAGE.
- FILL ALL VOIDS AT EXTERIOR WALL NOT VENTED TO THE EXTERIOR W/ZERO-DRAFT FOAM INSULATION LIMITATIONS ETC. BY LT GA MTL SUPPLIER/SUB-CONTRACTOR.

COMMENTS:
PROCESS - NOT FOR CONSTRUCTION (8/3/09)

REVISIONS:

DEVELOPER:
A & D REALTY, LLC
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LEXINGTON, MA 02421

NEW
pharmacy
CVS/

SEAL:

CONSULTANT:

ELECTRICAL NOTES




DESIGN/BUILD NOTES

CONSTRUCTION PLAN & NOTES
TITLE: CONSTRUCTION PLAN
JOB NUMBER: 209017
DATE: XX/XX/XX
DRAWING BY: RTK


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1 STAIR SECTION SCALE: 3/8" = 1'-0"




REMARKS

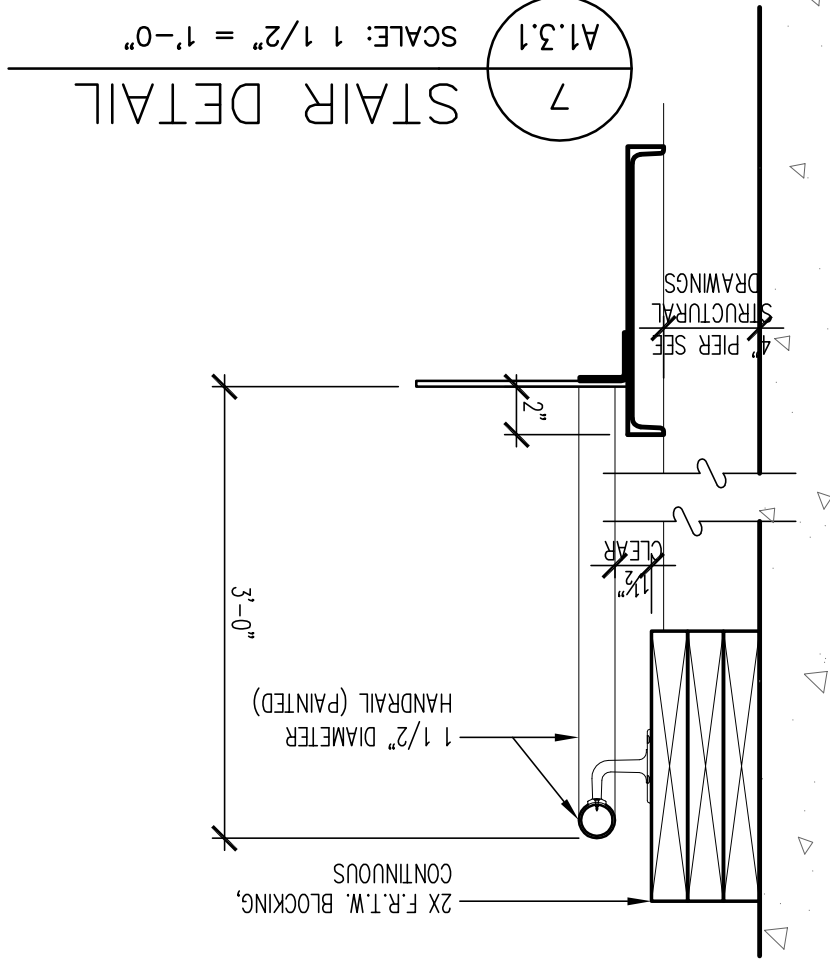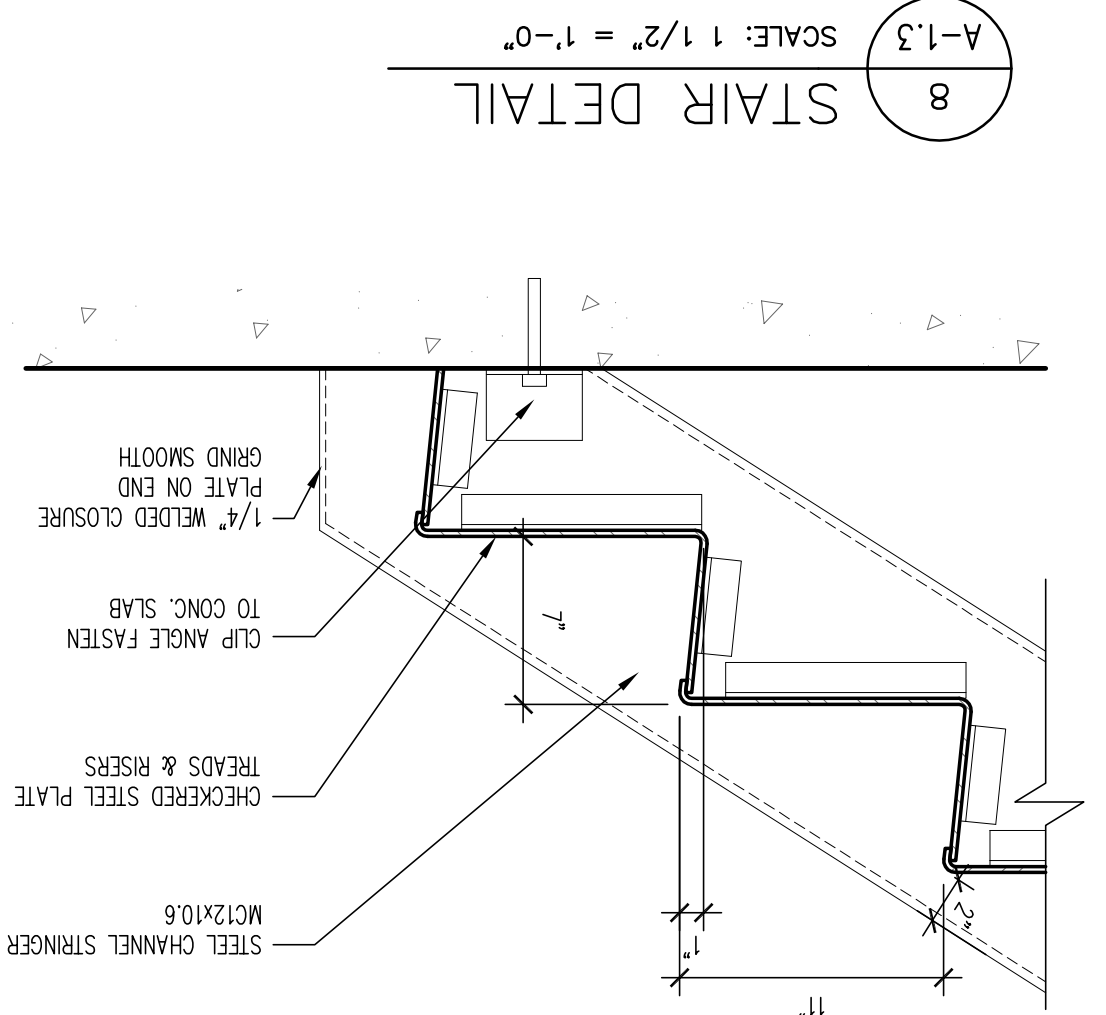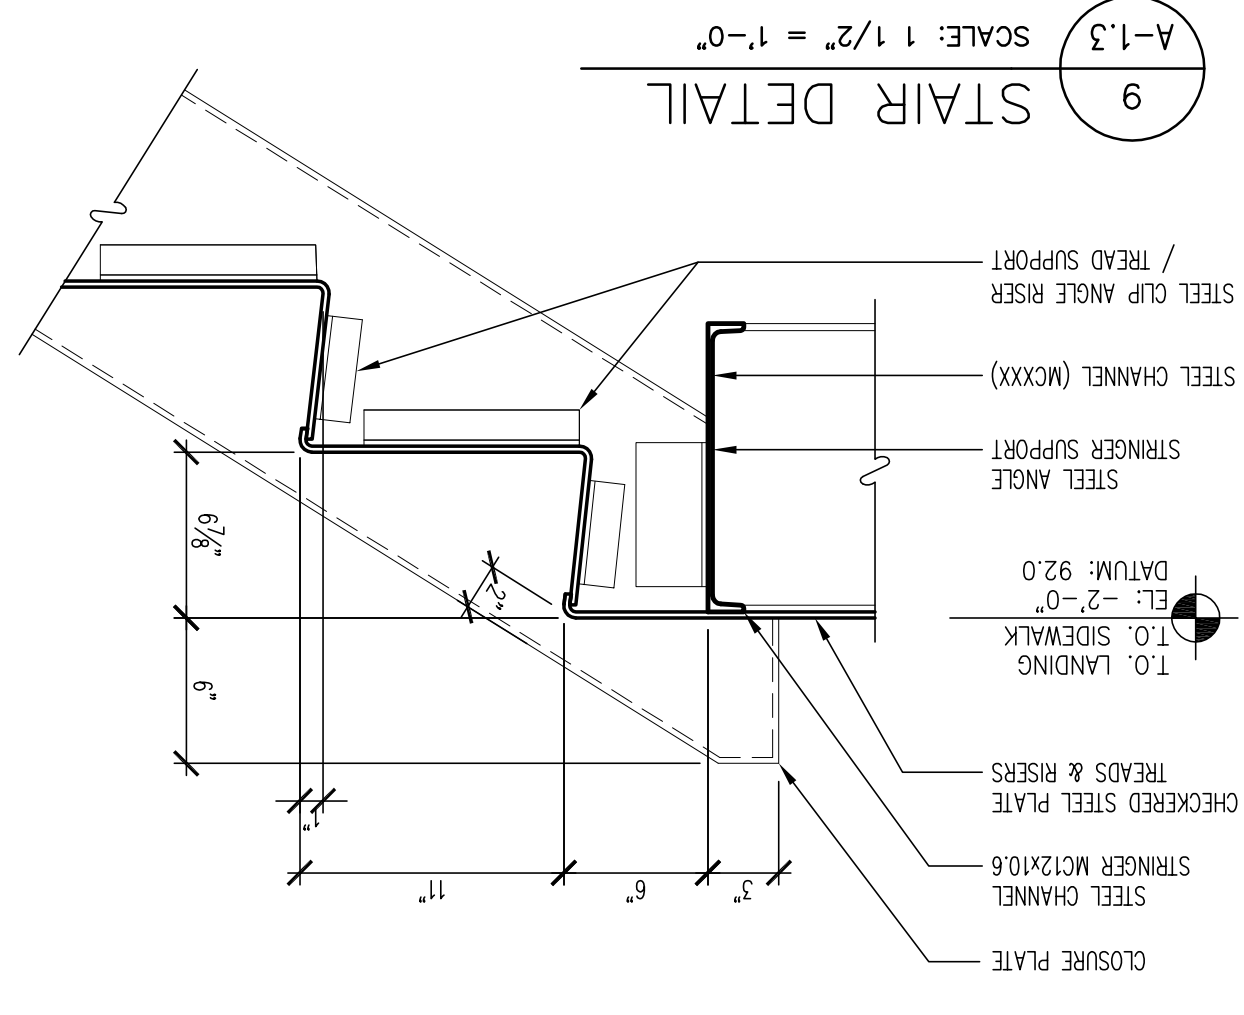- PAIN EXTERIOR SIDE OF SIDE DOOR & FRAME BENJAMIN MOORE #HC-50
- PAIN EXTERIOR SIDE OF DOOR & FRAME BENJAMIN MOORE #319-79 (ATRIUM WHITE)
- PAIN BOTH SIDES OF DOOR & FRAME BENJAMIN MOORE #319-79 (ATRIUM WHITE)
- PROVIDE WEATHER SEALS, 1.5 PR BUTTS NRP, THRESHOLD AND OFFICE LEAFER LOCK SET.


| TAG | TYPE | WD | HGT | THK | MATL | QTY | NO | HTG | NO | HTG | NO | HTG | NO | HTG | NO | HTG | NO | HTG |
|-----|------|-------|-------|--------|-----------|-----|----|-----|----|-----|----|-----|----|-----|----|-----|----|-----|
| R1 | A | 3'-0" | 7'-0" | 1 3/4" | INS. H.M. | | | | | | | | | | | | | |
| R2 | B | 3'-0" | 7'-0" | 1 3/4" | INS. H.M. | | | | | | | | | | | | | |
| | | | | | | | | | | | | | | | | | | |

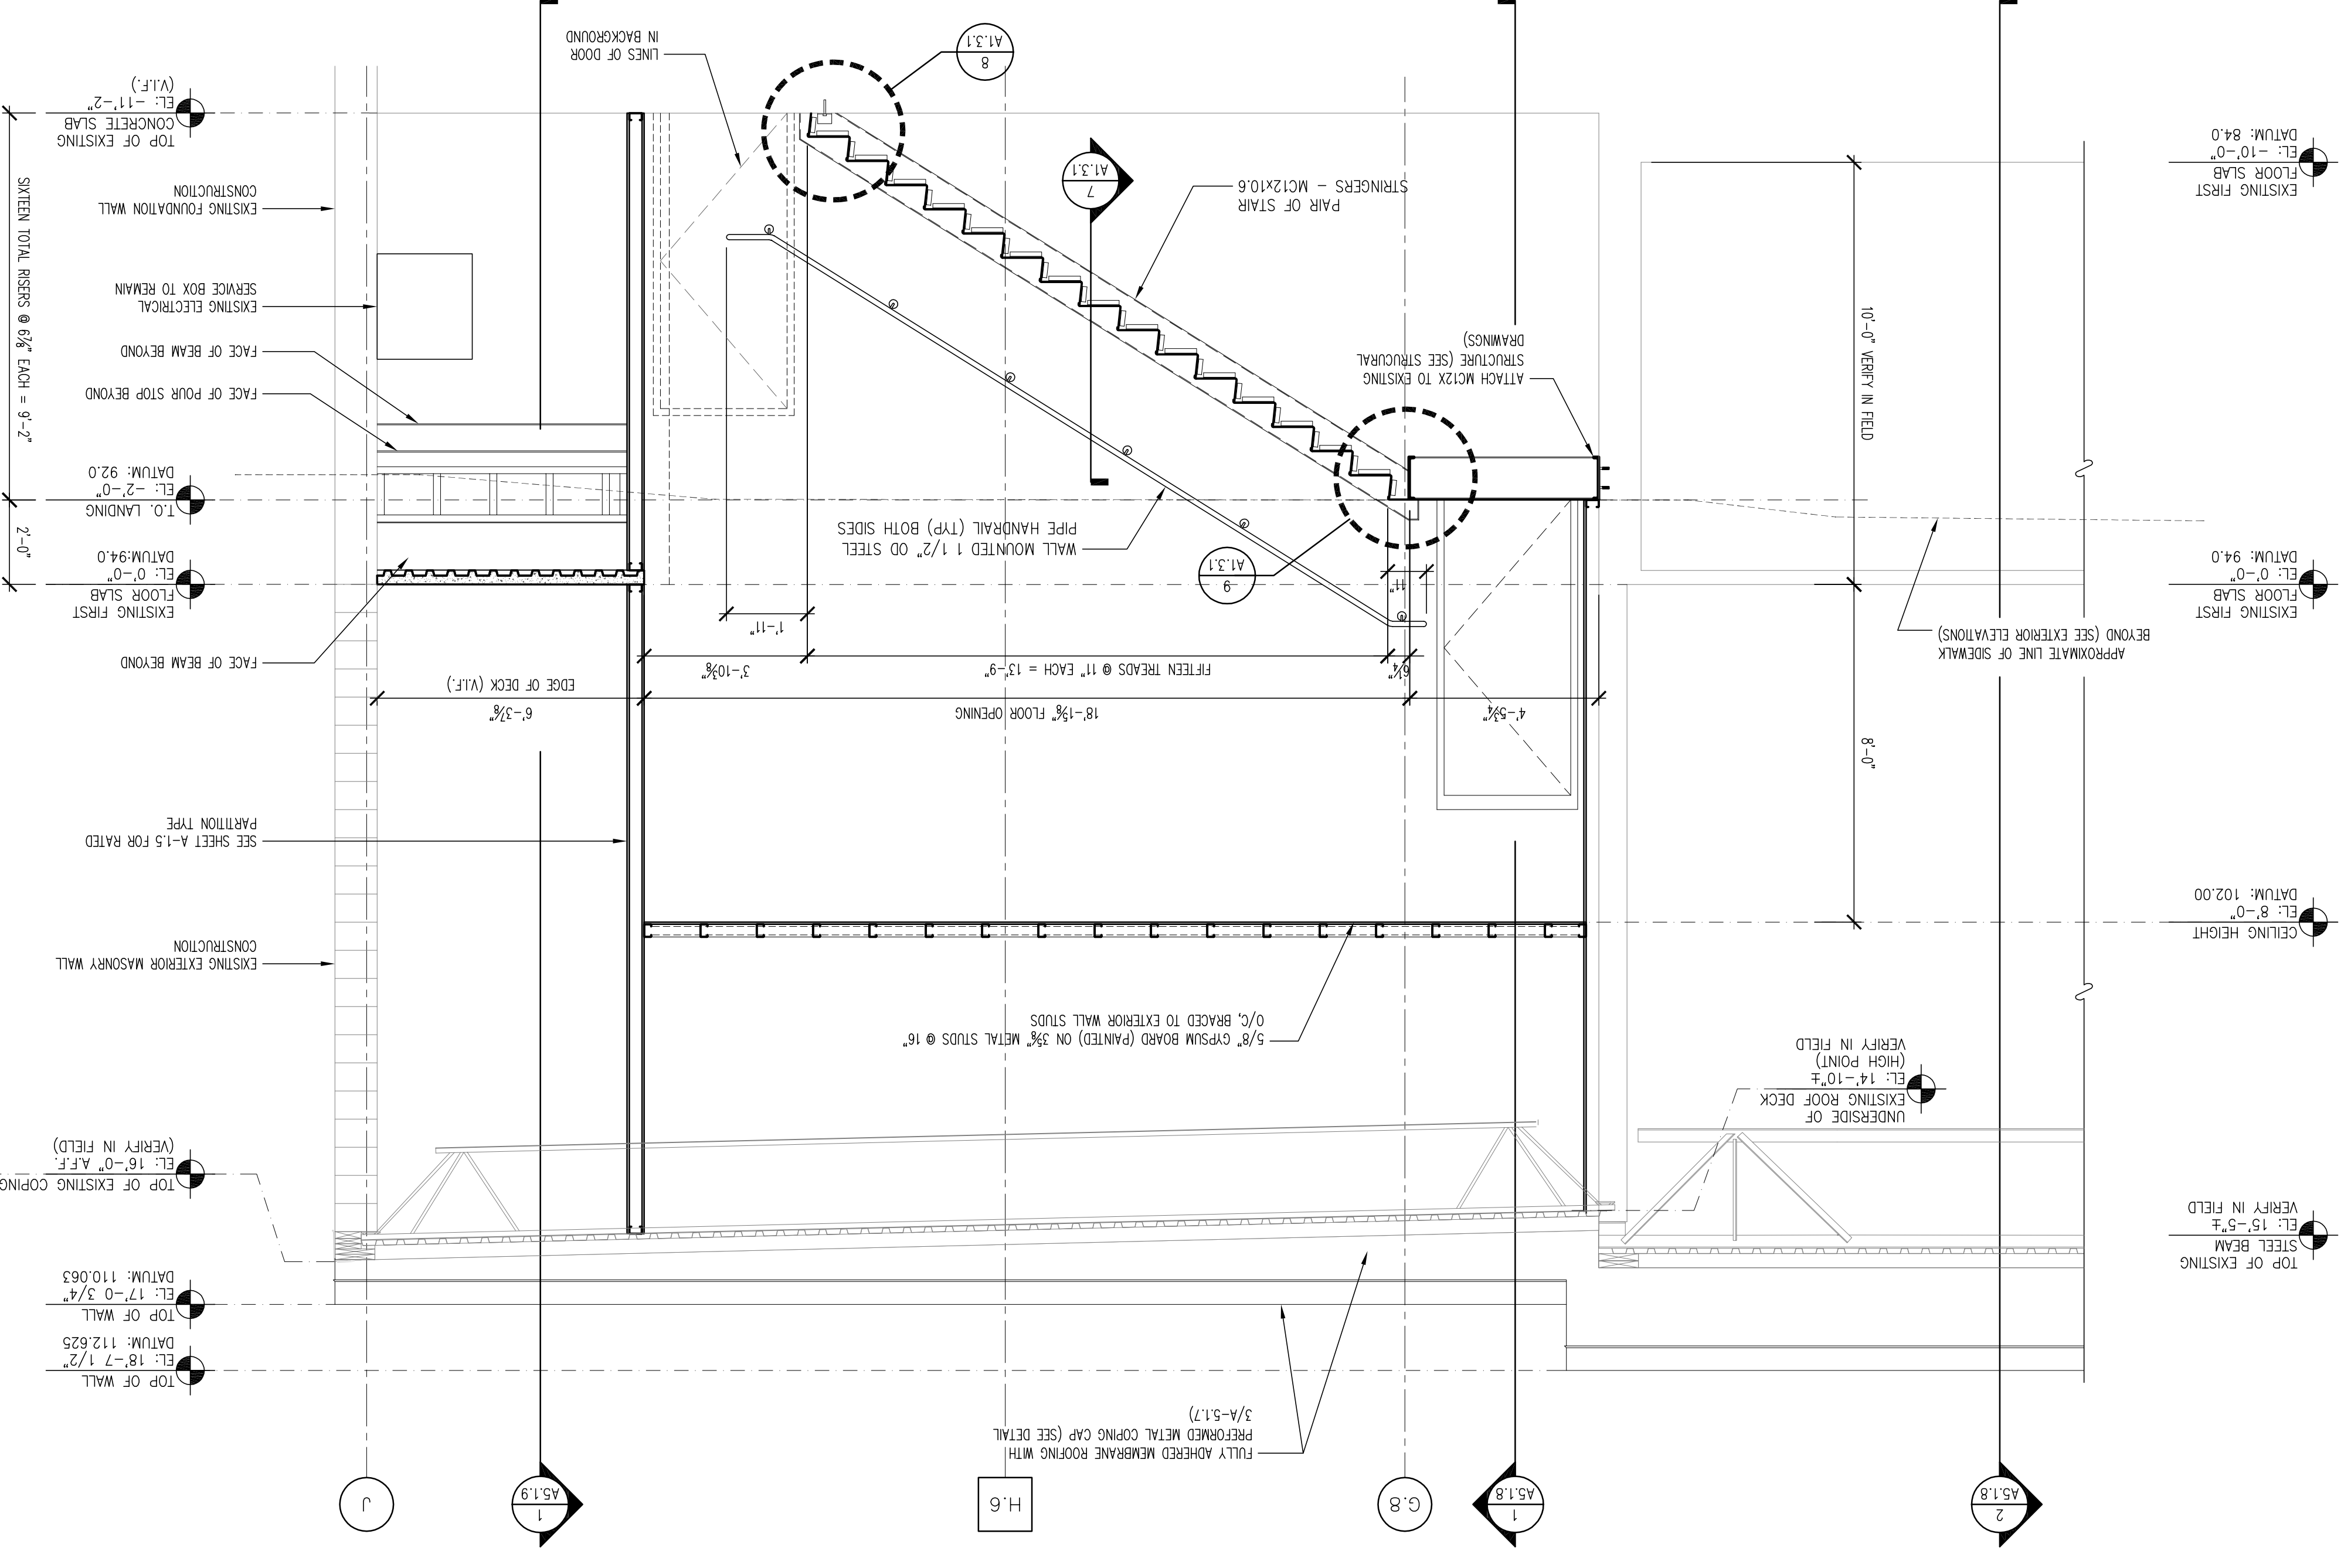DOOR AND FRAME SCHEDULE


5 THRESHOLD DETAIL SCALE: 1 1/2" = 1'-0"

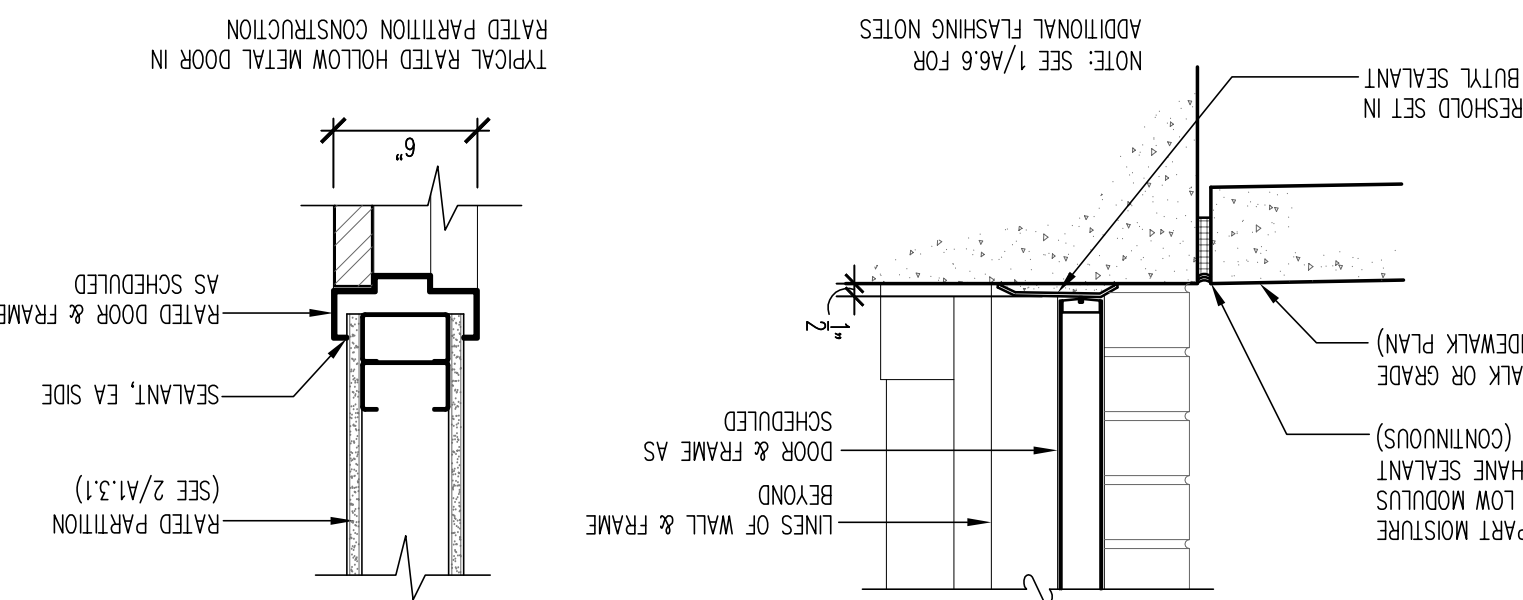


3 HEAD DETAIL SCALE: 1 1/2" = 1'-0"

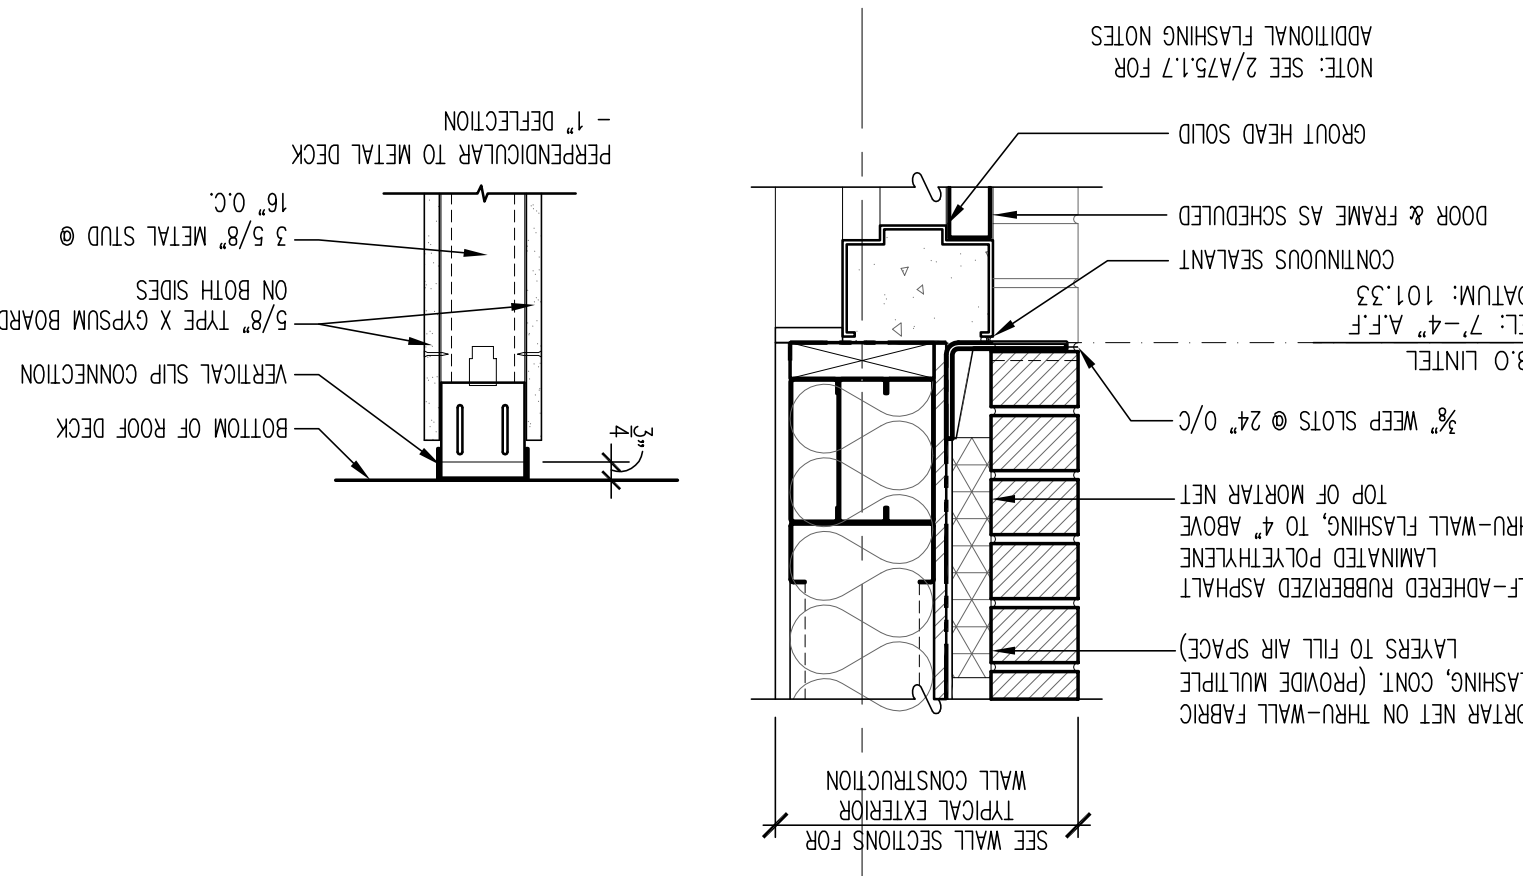


2 PARTITION TYPES SCALE: 1/4" = 1'-0"

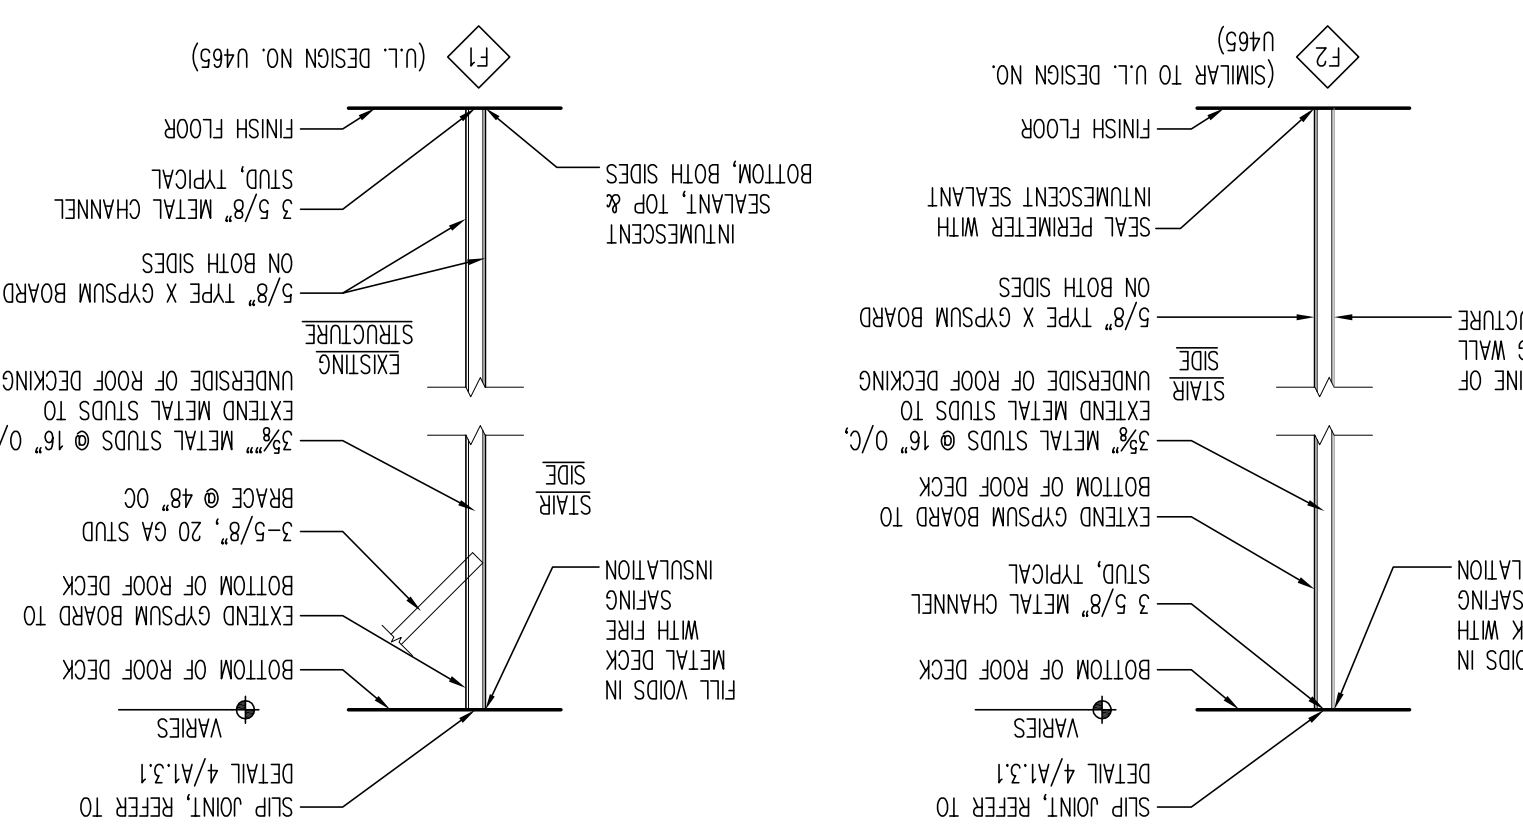

4 PARTITION DETAIL SCALE: 1/4" = 1'-0"

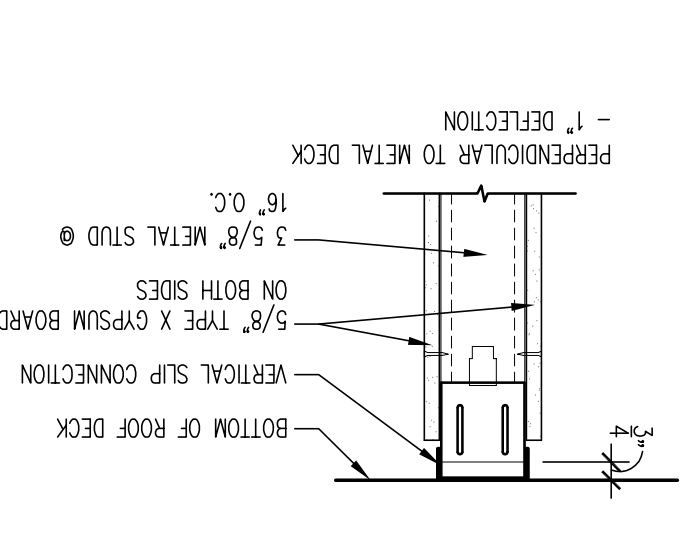

6 HEAD / JAMB DETAIL SCALE: 1 1/2" = 1'-0"

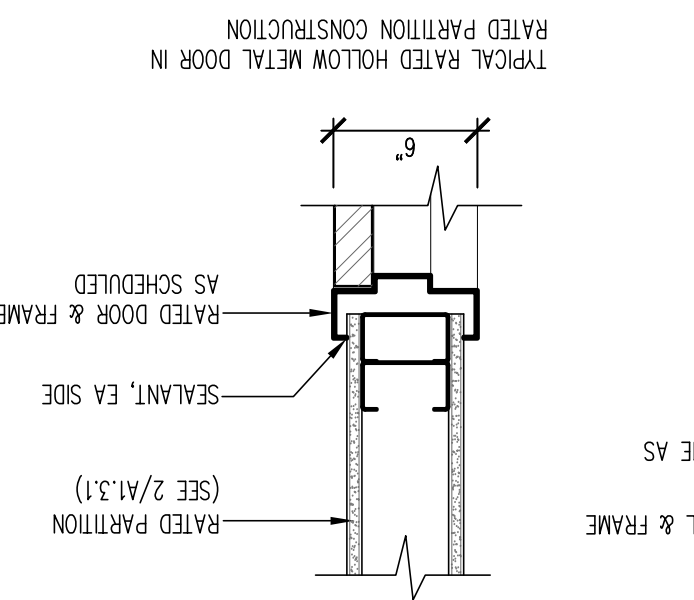

COMMENTS:
 PROCESS - NOT FOR CONSTRUCTION (8/3/09)
 SHEET NUMBER: A-1.3.1
 TITLE: STAIR SECTIONS & DETAILS
 JOB NUMBER: 209017
 DATE: XX/XX/XX
 DRAWING BY: RTK

REVISIONS:
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 PORTLAND, MAINE
 NEW
 CVS/pharmacy




SEAL:

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 fax : 508.584.2914
 e-mail : bka@bkaarch.com



| TAG | MATERIAL/MFG. | COLOR/NO. | NOTES |
|-----|---|-----------------------|---|
| X1 | "BERZALIT" RESIN-BONDED WOOD SIDING PANEL SYSTEM | BENJAMIN MOORE #1800 | AMERICAN 6" EXPOSURE TRADITION (SMOOTH SURFACE); SEE NOTE #4. PROVIDE PAINTED SAMPLE TO ARCHITECT |
| X1A | WOOD SIDING PANEL SYSTEM | BENJAMIN MOORE 319-79 | HERITAGE 6" EXPOSURE TRADITION (SMOOTH SURFACE); SEE NOTE #4. PROVIDE PAINTED SAMPLE TO ARCHITECT |
| X1B | EXTERIOR FACE BRICK | CVS RED | MORTAR COLOR - NATURAL GREY |
| X1C | EXTERIOR CEDAR CLAPBOARD SIDING SYSTEM | | PRIME & PAINT TO MATCH EXISTING |
| X1D | C.M.U. BLOCK (SPLIT FACED), NATURAL GF 000" (TO SINGLE SCORE) | | MANUFACTURED BY GENEST CONCRETE, SANFORD, ME (BTCH KENEDY: 207-324-3250 X155) |
| X1E | EXTERIOR FACE BRICK | | COORDINATE WITH GENEST CONCRETE, SANFORD, ME (BTCH KENEDY: 207-324-3250 X155) |
| X1F | WOOD CROWN MOULDING | | TO MATCH EXISTING |
| X2 | CLOSED CELL PVC TRIM | | SMOOTH FACE, PAINT (TYPICAL AT ALL PVC TRIM) |
| X3 | CLOSED CELL SHEET PVC CLADDING | | PROVIDE PAINT SAMPLE TO ARCHITECT; SEE NOTE #4 |
| X4 | RYPOX DECORATION | | BENJAMIN MOORE 319-79 |
| X5 | WIND/DOOR STOREFRONT "KAMMER" TRIRAB II | | #5914226, COLONIAL WHITE T&L-1-800-366-3698 |
| X6 | 1" INSULATED FLOAT GLASS | | OPAQUE WHITE SPANDEL |
| X6A | 1" INSULATED FLOAT GLASS | | CLEAR |
| X7 | 1/4" LAM SAFETY GLASS | | CLEAR |
| X8 | PERFINISHED METAL COPING CAP | | COLOR TO MATCH ADJACENT VENER MASONRY |
| X9 | FIBERGLASS ASPHALT ARCHITECTURAL ROOF | | G.C. TO SUBMIT SAMPLES APPROVED EQUAL |
| X10 | BENJAMIN MOORE ARJUM WHITE #319-79 | | PROVIDE PAINT SAMPLE TO ARCHITECT; COLOR TO MATCH FACTORY FINISHED WINDOW FRAME ALL EXTERIOR SURFACES NOT FACTORY PRIMED & PAINTED TO RECEIVE X10 |
| X14 | EXTERIOR PIPE BOLTS | | SAFETY YELLOW DEVELUX WB ACRYLIC, 4208 - SERIES, HIGH PERFORMANCE |
| X15 | BENJAMIN MOORE ZALESKI SHOW GUARDS | | PROVIDE TWO ROWS (STAGGERED), @ .36" O/C |
| X19 | STAINLESS STEEL SNOW GUARDS | | MODEL #8 (STAINLESS STEEL) |

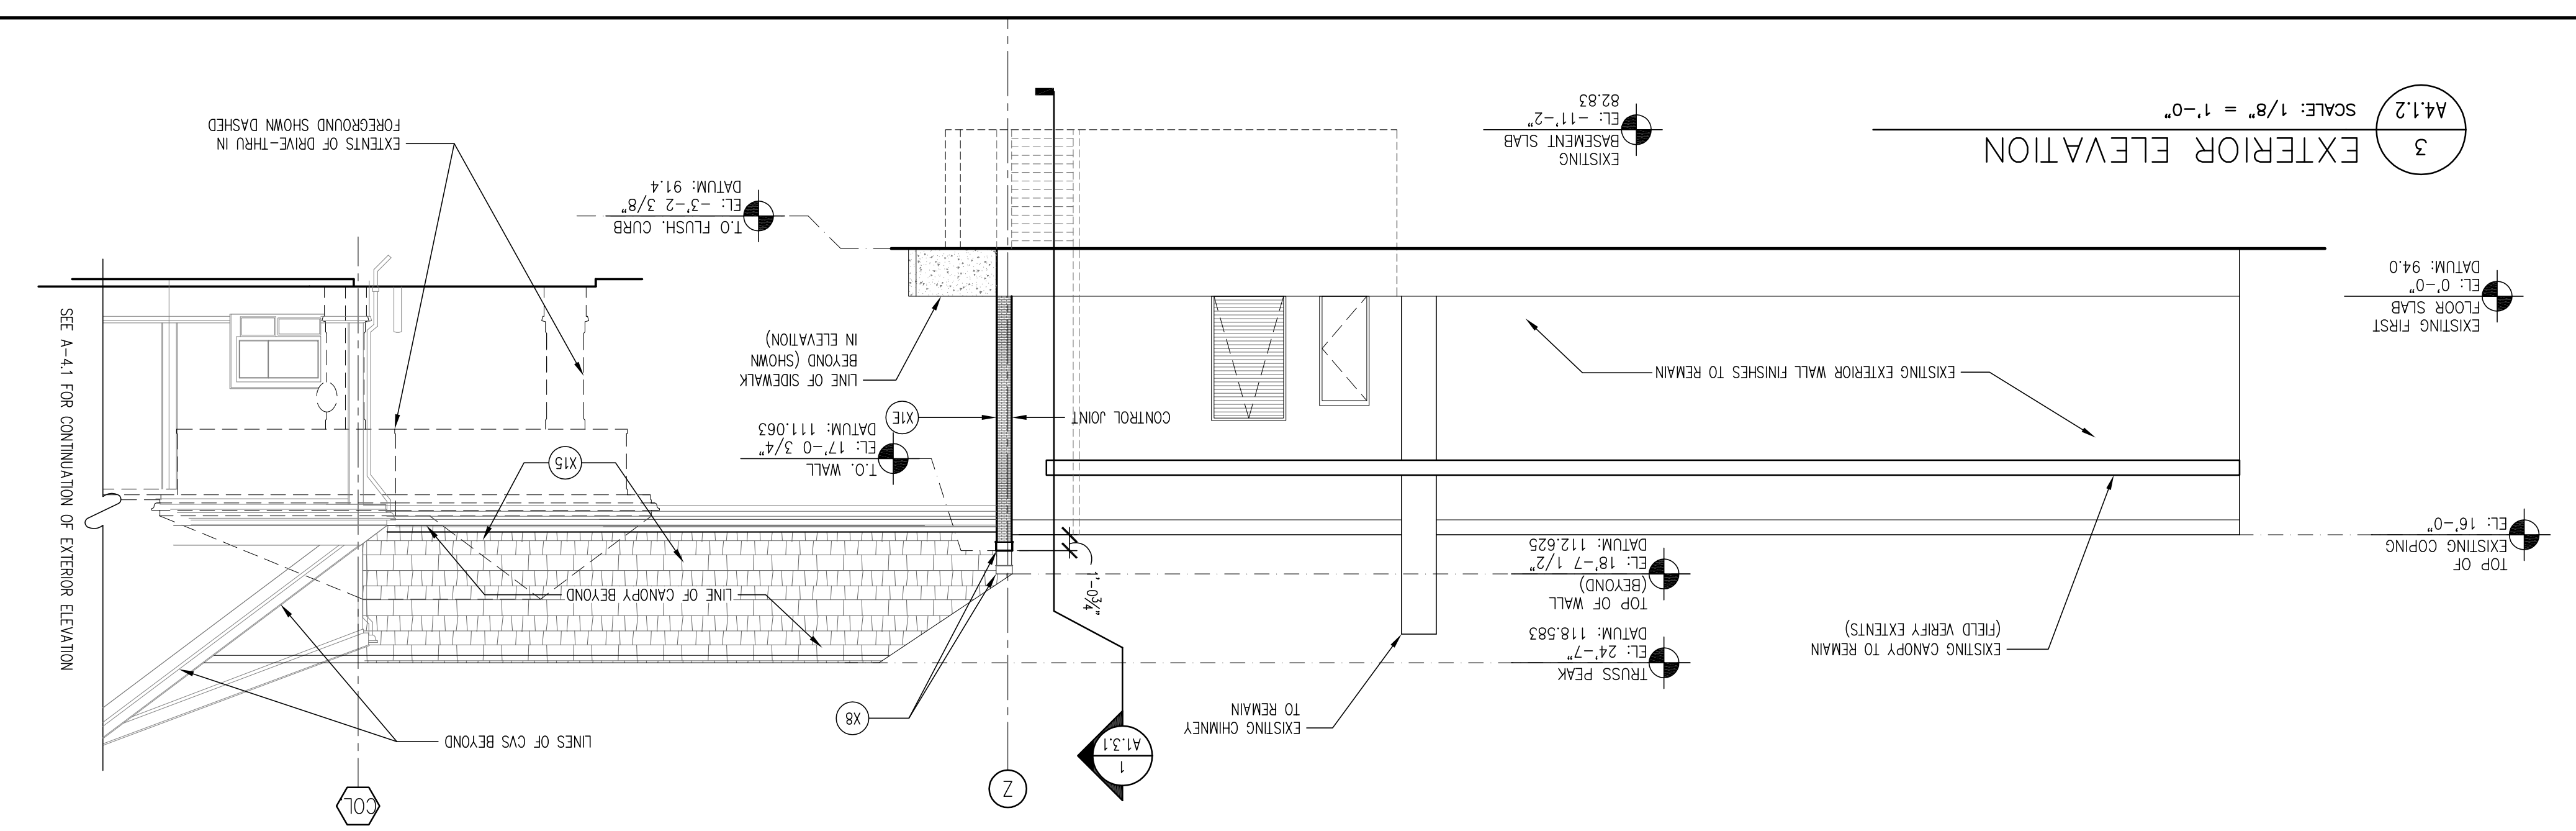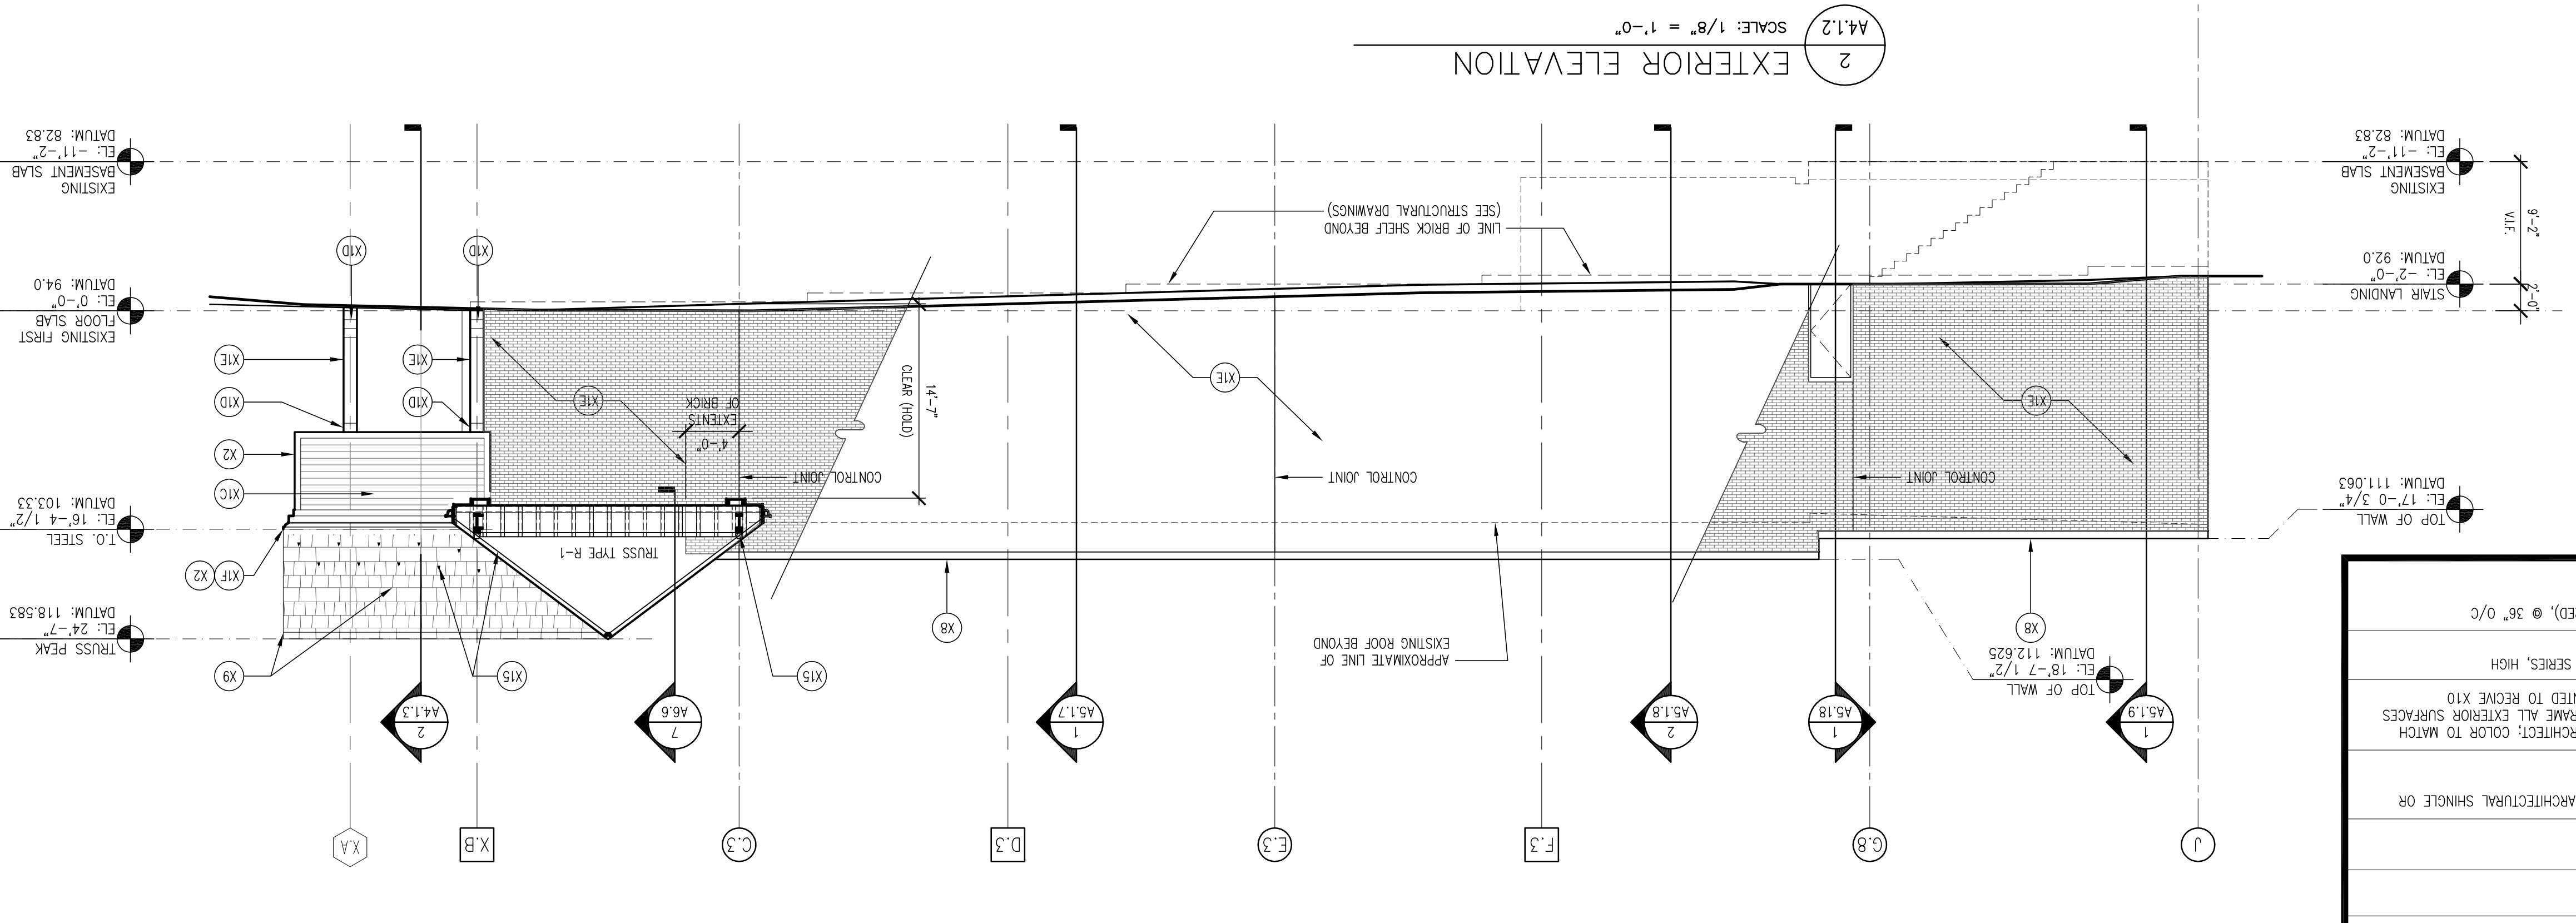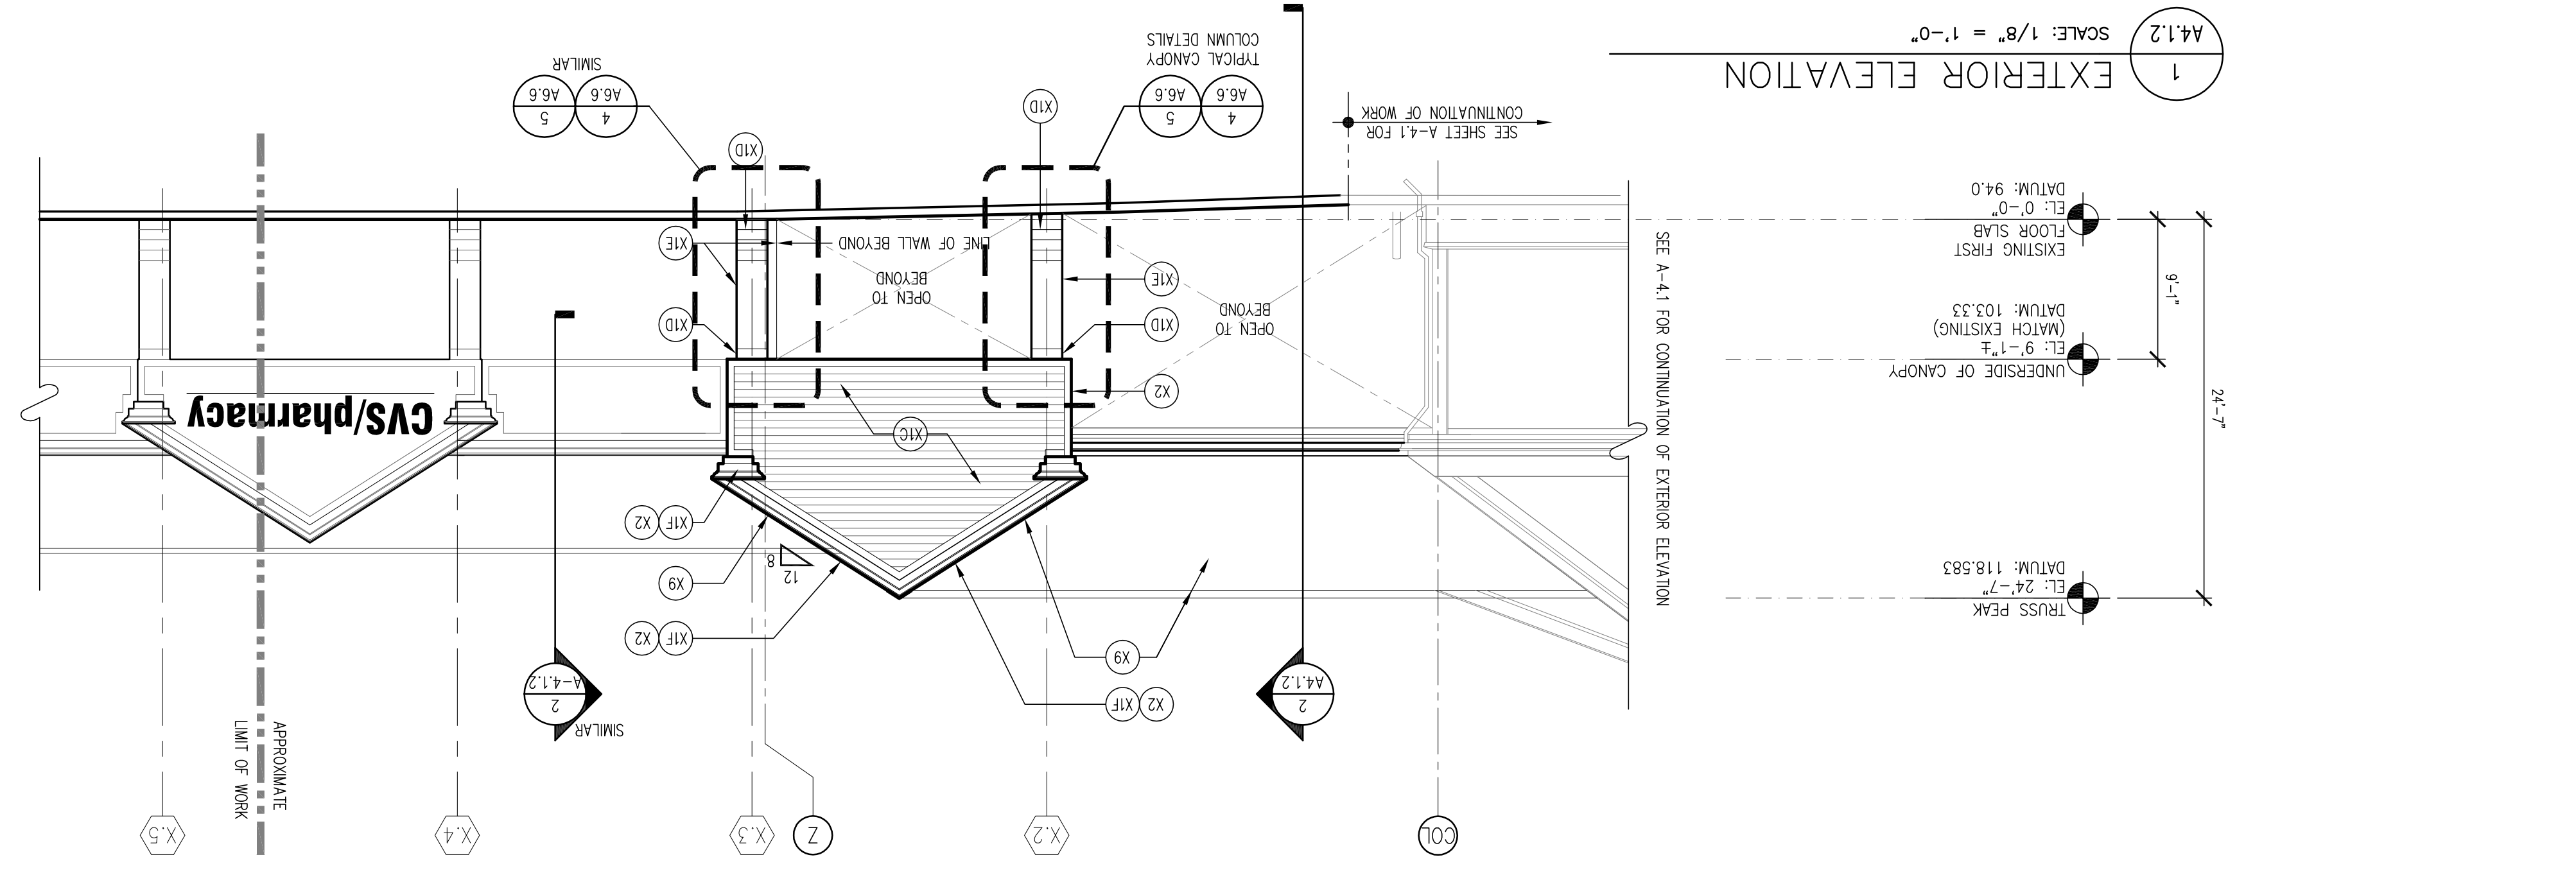

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CVS/pharmacy

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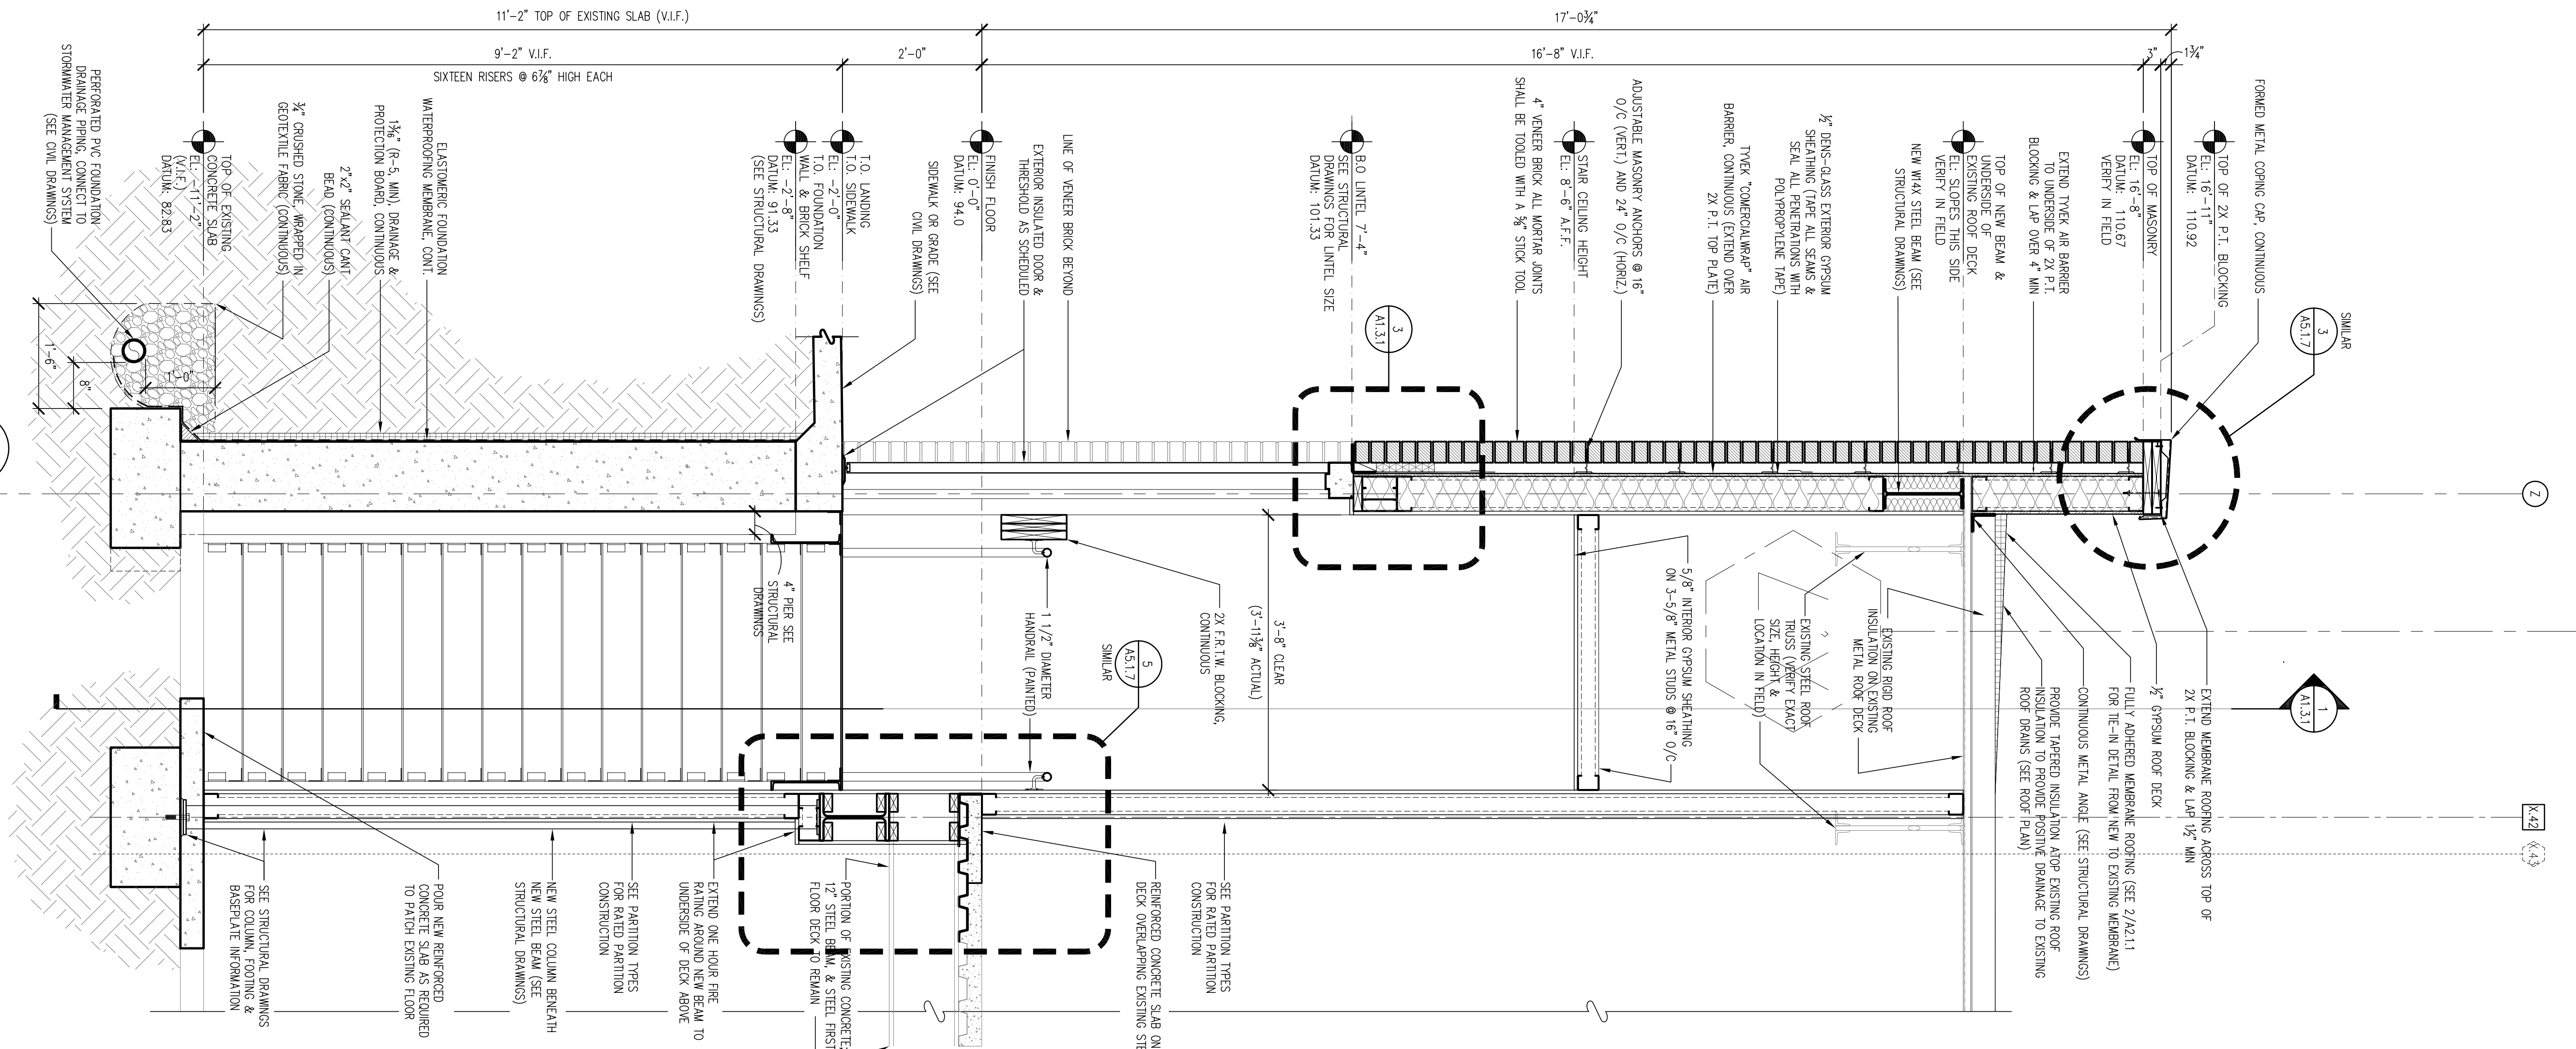
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STORE NUMBER: 329
 NORTGATE PLAZA
 91 AUBURN STREET
 PORTLAND, MAINE

DEVELOPER:
 A & D REALTY, LLC
 5 MILITIA DRIVE
 LEXINGTON, MA 02421


REVISIONS:

| | |
|---------------|-----------------------------|
| DATE: | XX/XX/XX |
| JOB NUMBER: | 209017 |
| TITLE: | EXTERIOR ELEVATIONS & NOTES |
| SHEET NUMBER: | A-4.1.2 |

COMMENTS:
 PROGRESS - NOT FOR CONSTRUCTION (8/3/09)



1 WALL SECTION
A-5.1.8 SCALE: 3/4" = 1'-0"

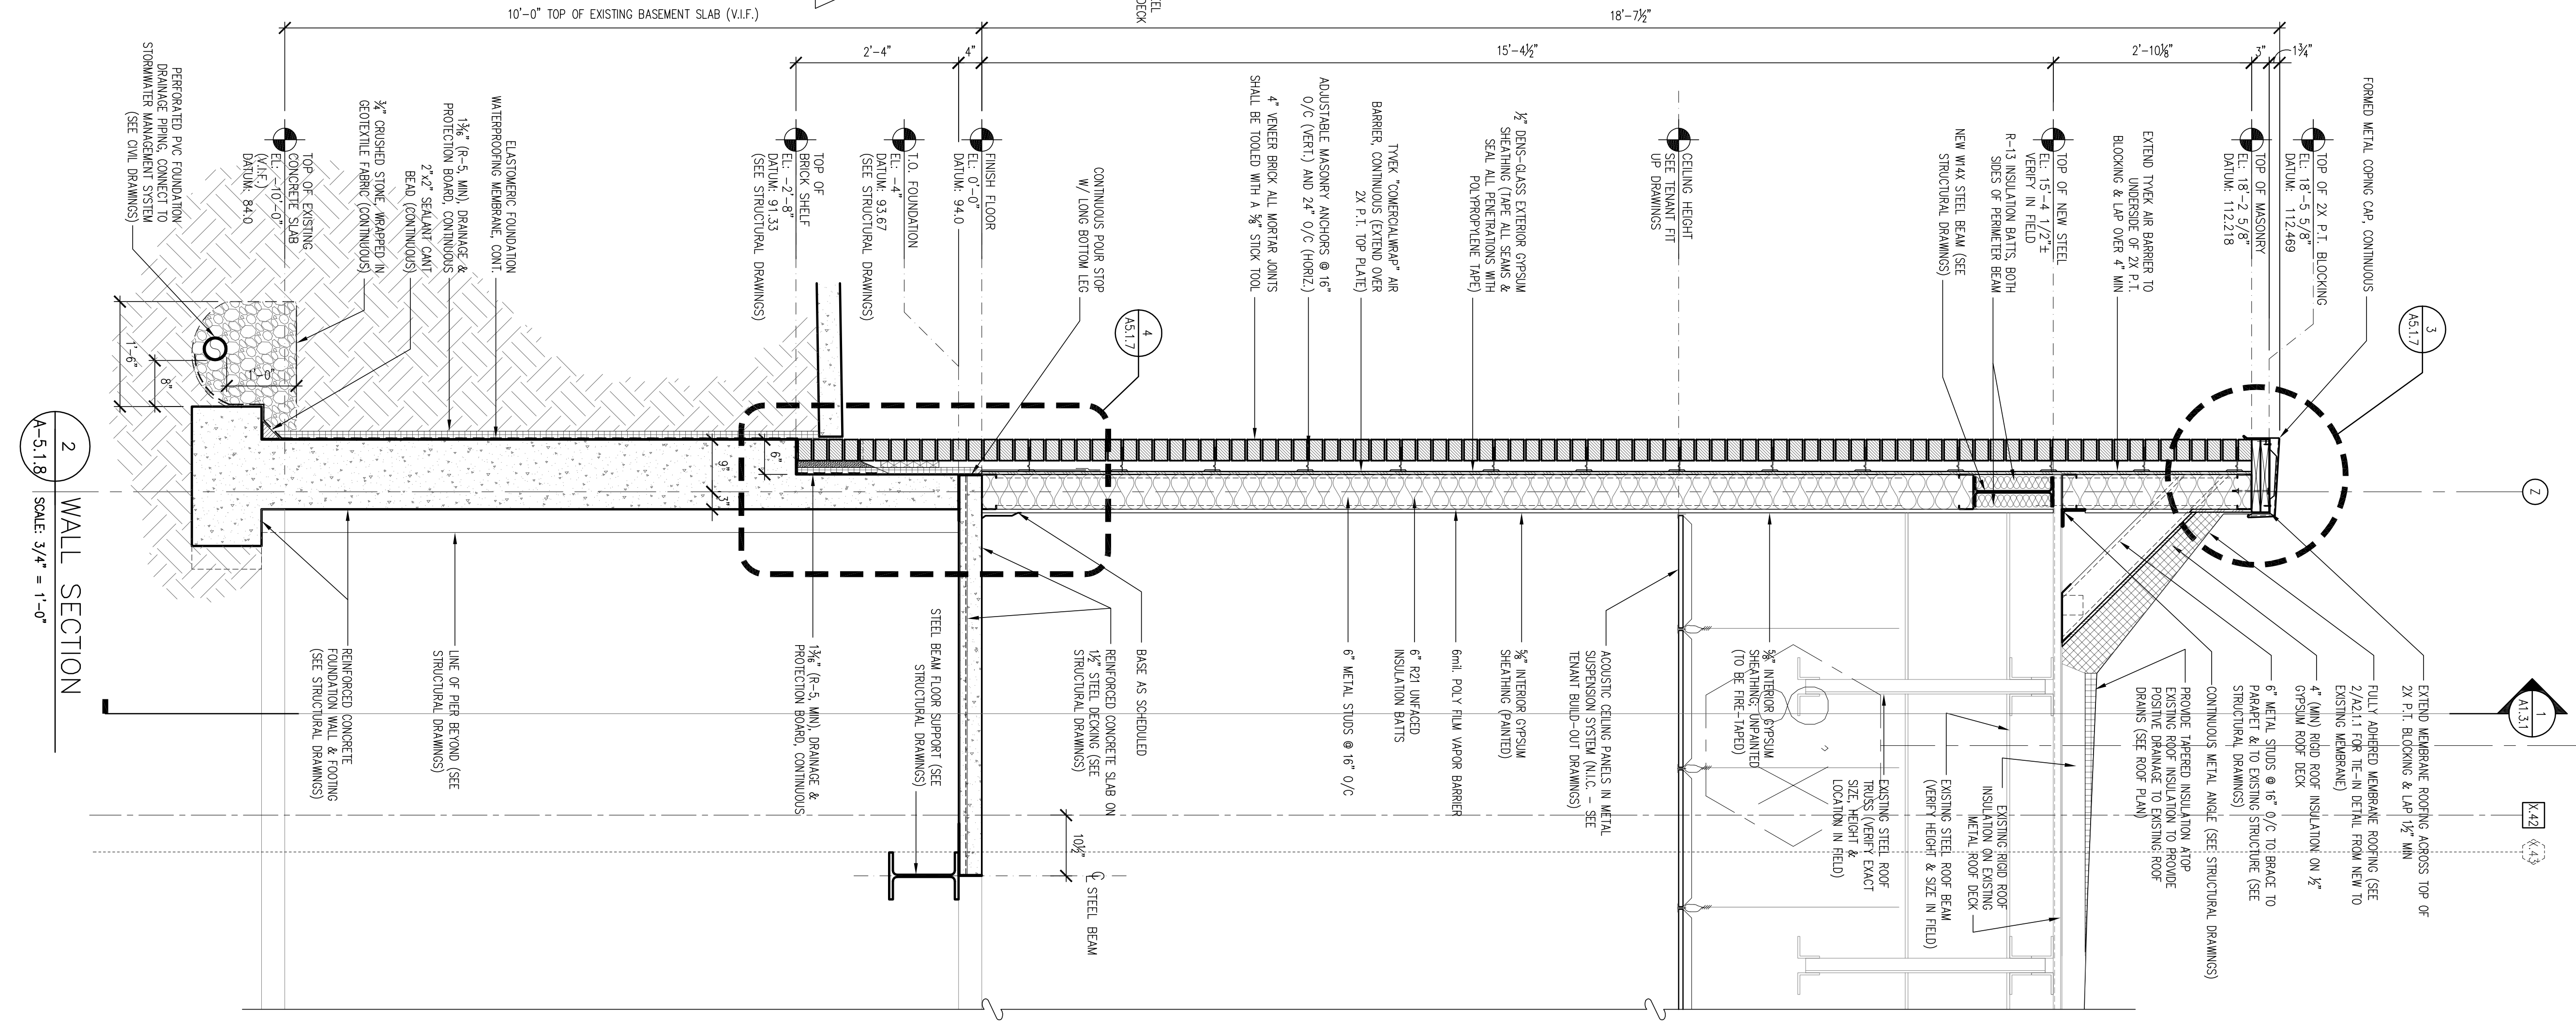

2 WALL SECTION
A-5.1.8 SCALE: 3/4" = 1'-0"

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COMMENTS:
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SHEET NUMBER: A-5.1.8

WALL SECTIONS

DATE: XX/XX/XX
JOB NUMBER: 209017
DRAWING BY: RTK

REVISIONS:

DEVELOPER: A & D REALTY, LLC
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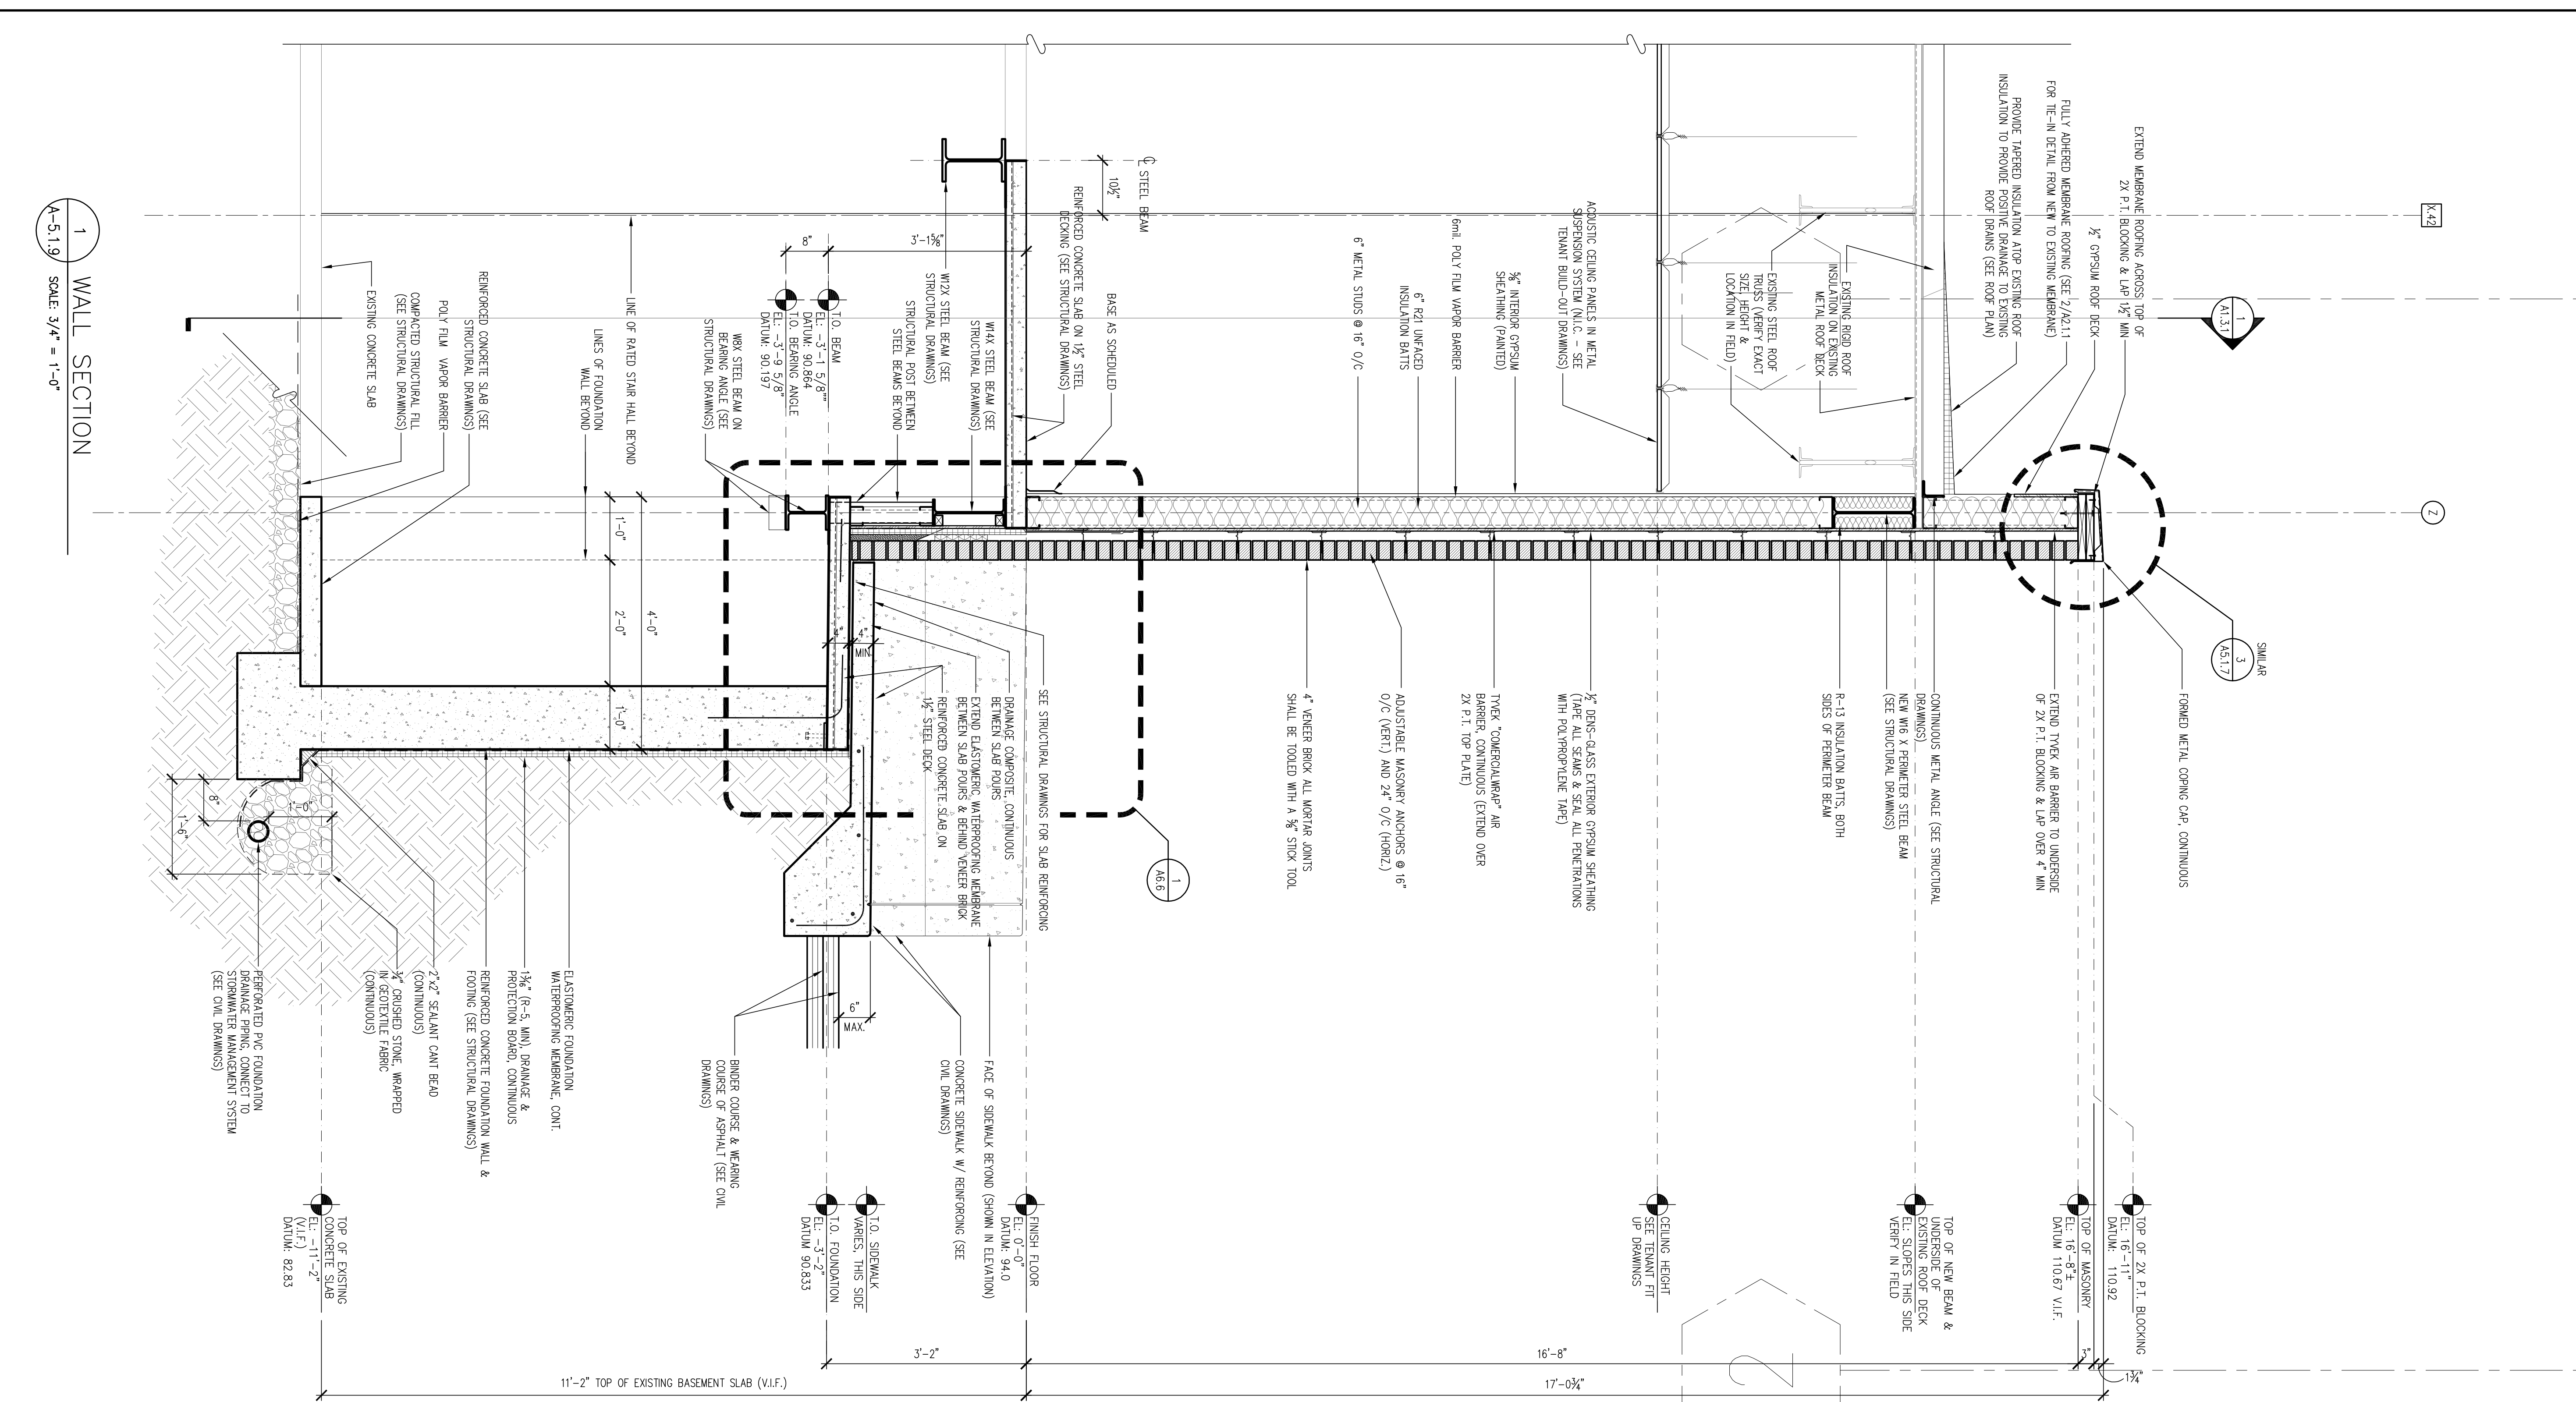
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1 WALL SECTION
SCALE: 3/4" = 1'-0"

| TYPICAL DESIGN CRITERIA - PHASE 1 WORK CVS: PORTLAND, ME #324 | |
|--|--|
| STUD FRAMING | EXTERIOR WALLS 6" (18 GA. MIN - SEE STRUCTURAL DRAWINGS) INTERIOR WALLS SEE PARTITION SCHEDULE |
| INSULATION | FLAT ROOF 2 LAYERS 2" POLYISOCYANURATE FOR R-25 MIN. TAPERED ROOF 2" POLYISOCYANURATE FOR R-25 MIN. SECUREMENT ROOF INSULATION BOARD BY TREKCO POSITIVE DRAINAGE TO EXISTING ROOF DRAINS EXTERIOR ONE LAYER 6" R-21 HIGH DENSITY UNFACED BATT'S FRICTION FIT FOUNDATION TREKCOBRIAN IPI DRAINAGE & PROTECTION BOARD BY TREKCO SEALANTS (3/4" THICK, R-9) SLAB SLAB EDGE: 1" RIGID INSULATION (R-5) CANTY STRYFOAM "CANTY-MATE" RIGID EXPANDED INSULATION POLYSTYRENE INSULATION BY DOW CORNING |
| EXTERIOR SHEATHING | 1/2" DENS-CLASS COLD EXTERIOR GYPSUM SHEATHING |
| EXTERIOR AIR BARRIER SYSTEM | "TUPONIT" TYVEK COMMERCIAL WRAP, LAP JOINTS PER MANUFACTURER'S INSTALLATION INSTRUCTIONS & TAPE WITH TYVEK TAPE, EXTEND PAST TOP OF THRU-WALL FLASHING 4" MIN. & TAPE JOINT WATER-TIGHT "HOUSEWRAP" WILL NOT BE ACCEPTED OR ALLOWED. FASTENERS PRORITE "TUPONIT" TYVEK 170A, WRAP CASE @ 16" O/C HORIZONTALLY & VERTICALLY. USE MANUFACTURER APPROVED STARTERS. TAPE "TUPONIT" TYVEK TAPE, 3" WIDE. |
| BRICK VENER SYSTEM | 4" BRICK VENER W/ BRICK VENER ANCHORING SYSTEM OVER 2" AIR SPACE ON TYPICAL EXTERIOR WALL CONSTRUCTION. |
| ANCHORING SYSTEM | ANCHOR SPACING: VERTICAL: 16" O.C. MAX. HORIZONTAL: 24" O.C. MAX. "TIE-IN" WALL, INC. 0/A 210 GALVANIZED ADJUSTABLE TIE-ANCHORS WITH 5" WIRE X 5" DEEP 3/16" DIA. GALVANIZED TRAPKALE TIES. ANCHORS SHALL BE ATTACHED TO METAL STUD WITH 1/2" X 80/10" OR 1/2" X 12/11H 50,000 PSI STRENGTH STEEL WASHERS. WASHERS SHALL COVER A MAXIMUM OF 2 S.F. PER TIE. AN ALTERNATE ANCHOR SHOULD BE OF EQUAL OR BETTER STRENGTH AND QUALITY. |
| THRU-WALL FLASHING | 2X10" MORTAR NET CANTY WALL DRAINAGE SYSTEM. MADE FROM RECYCLED POLYESTER OR HIGH DENSITY POLYETHYLENE. DRAINAGE CELL VENTS @ 24" O/C (COLOR TO BE CLEAR OR GREY) TO MATCH MORTAR). PROVIDE AT BASE & TOP OF MASONRY WALLS ABOVE 25'-0" HIGH TO EXTEND PAST CMU BACKUP (IF ANY) TO FACE OF DRAINAGE PLANE WEEP TUBES WITH COTTON WICKS WILL NOT ACCEPTED BE ALLOWED |
| SLAB DRAINAGE | TREKCOBRIAN 1000 DRAINAGE COMPOSITE & PROTECTION BOARD BY TREKCO SEALANTS ATOP ELASTOMERIC WATERPROOFING MEMBRANE |
| FOUNDATION WATERPROOFING | TREKCOBRIAN 2300C SINGLE COMPONENT, RABD CURING, FLUID-APPLIED ELASTOMERIC WATERPROOFING MEMBRANE |
| SEALANT | AT EXTERIOR WALL & SIDEWALK INTERSECTION, PROVIDE VULKAN 45 SSI. ONE PART, SEMI-SELF LEVELING POLYURETHANE SEALANT |
| INTERIOR GYPSUM SHEATHING | 5/8" GYPSUM BOARD AS FOLLOWS: ALL GYPSUM BOARD BELOW FINISHED CEILING TO BE TAPERED & PAINTED (I.E. ALL DROPPED GYPSUM BOARD) ALL GYPSUM BOARD ABOVE FINISHED CEILING TO BE FIRE TAPED (I.E. ALL UNDEPOSED OR CONCEALED GYPSUM BOARD) |
| FIRE RESISTANT TREATED WOOD | ALL WOOD (OTHER THAN P.T. ROOF EDGE BLOCKING) INSIDE A SPACE OF NON-COMBUSTIBLE CONSTRUCTION SHALL BE F.R.T.W. TO DAMPKES, SKIN DRUMKS, WOOD SHIMS, BLOCKING, ETC. |

COMMENTS:
A-5.1.9
SHEET NUMBER:
WALL SECTION & DESIGN
JOB NUMBER: 209017
DATE: XX/XX/XX
DRAWING BY: RTK
REVISIONS:

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