GENERAL NOTES

- CODE COMPLIANCE: ALL WORK SHALL CONFORM TO THE LATEST EDITION OF STATE, LOCAL AND OTHER CODES WHICH APPLY TO THIS PROJECT OR HAVE JURISDICTION.
- COORDINATION: IT IS THE RESPONSIBILITY OF THE CONTRACTOR TO COORDINATE ALL DISCIPLINES AND TRADES SO THAT ALL BUILDING SYSTEMS AND COMPONENTS CAN BE ASSEMBLED WITHOUT CONFLICTS. IN THE EVENT THAT THE CONSTRUCTION DOCUMENTS DEFINE CONDITIONS WHICH PROHIBIT OR MAY PROHIBIT SUCH ASSEMBLY, THE CONTRACTOR SHALL BRING TO THE ARCHITECTS ATTENTION, IN WRITING AND IN A TIMELY PASSHON, SUCH CONDITION. THE CONTRACTOR SHALL NOT PROCEED WITH RELATED WORK WITHOUT WRITTEN RESOLUTION OR CLARIFICATION FROM THE ARCHITECT.
- 3. DISCREPANCIES AND CLARIFICATIONS: IT IS THE RESPONSIBILITY OF THE CONTRACTOR TO BRING TO THE ARCHITECTS ATTENTION, IN WRITING, ANY DISCREPANCIES OR AMBIGUITIES IN THE DRAWINGS AND/OR SPECIFICATIONS. THE CONTRACTOR SHALL NOT PROCEED WITH RELATED WORK WITHOUT A WRITTEN RESOLUTION OR CLARIFICATION FROM THE ARCHITECT.
- LAYOUT: UNLESS INDICATED OTHERWISE, CENTER WALL FRAMING AND PARTITION FRAMING ON COLUMN LINES, FLOOR PLAN DIMENSIONS ARE TO CENTERLINE OF FRAMING, FACE OF CONCRETE, FACE OF CMU OR FROM COLUMN CENTER LINES.
- 5. DOOR LOCATIONS: DOOR LOCATIONS NOT DIMENSIONED SHALL BB 6* FROM ADJACENT WALL.
- DRAWING SCALE: WORK FROM THE GIVEN DIMENSIONS ONLY. SCALE IS INDICATED ON THE DRAWINGS FOR CONVENIENCE ONLY. IT IS NOT INTERDED THAT INFORMATION BE DETERMINED BY SCALING THE DRAWINGS SINCE SOME HEMS MAY NOT BE TO SCALE.
- FINISHES: FINISHES OTHER THAN THE STANDARD FINISHES ARE ALL INDICATED ON THE DRAWINGS, CEILING FINISHES ARE SHOWN ON THE REFLECTED CEILING PLANS AND ALL OTHER FINISHES ARE SHOWN ON THE FINISH SCHEDULE AND/OR INTERIOR ELEVATIONS. FERISHES INDICATED FOR A PARTICULAR ROOM OR SPACE ARE APPLICABLE FOR THE ENTIRE ROOM OR SPACE, UNLESS INDICATED OTHERWISE.
- ALL EXPOSED SURFACES ARE TO BE PARITED, WHETHER OR NOT INDICATED ON THE DRAWDING, EXCEPT AS FOLLOWS: WHERE SPECIAL COATINGS ARE INDICATED; PREFINISHED ITEMS, CONCEALED SURFACES; OPERATING PARTS; AND LABELS. EVEN IF PREFINISHED, PART THE FOLLOWING: EXPOSED MECHANICAL EQUIPMENT; FOLLOWING: EXPOSED MECHANICAL EQUIPMENT; FOLLOWING: EXPOSED MECHANICAL EQUIPMENT; SPEAKER GRILLES AND EMERGENCY LIGHTS (BRATTERES AND LAMPS, NOT BULD; ENISHED BULS LUFRACES, EXCEPT AS LISTED ABOVE, ARE NOT TO BE PAINTED. SEE SPECIFICATIONS FOR SCIEDULES SHOWING TYPES OF PAINTS AND SPECIAL COATINGS TO BE USED IN ACCORDANCE WITH MATERIAL BEING PAINTED OR COATED.

ALL WOOD IN CONTACT WITH CONCRETE FLOOR SHALL BE PRESSURE TREATED.

- 9. BUILDING INSULATION: PROVIDE AS INDICATED IN WALL DETAILS AND IN ACCORDANCE WITH PARTITION TYPES, WHETHER OR NOT SHOWN IN DETAILS AND OTHER DETAILS AND O
- BLOCKING: INSTALL BLOCKING BEHIND ALL SURFACE-APPLIED FIXTURES, TRIM, CASEWORK, SHELVES, BRACKETS, TOILET ACCESSORIES, CHAIR RAILS, PICTURE RAILS, GRAB BARS, WHITE BOARDS, MIRRORS, PROJECTIOR SCREENS, BASE MOULDINGS AND AS OTHERWISE REQUIRED, WHEN SUCH ITEMS ARE APPLIED ON STUD WALLS.
- 12. PENETRATIONS AT STRUCTURAL MEMBERS: BEFORE PENETRATING KNISTS, BEAMS OR OTHER STRUCTURAL MEMBERS, CONSULT WITH THE ARCHITECT.
- 13. DAMAGED WORK: BUILDING OR SITE COMPONENTS WHICH ARE AFFECTED BY NEW WORK, DEMOLITION OR WHICH MAY BE DAMAGED BY THE GENERAL CONTRACTOR OR ANY SUBCONTRACTOR SHALL BE REPLACED OR RESTORED TO ORIGINAL CONDITION AND COLOR TO MEET THE APPROVAL OF THE ARCHITECT.
- 14. RATED CONSTRUCTION: PROVIDE RATED CONSTRUCTION AS REQUIRED BY CODE, AS SPECIFIED, AND AS INDICATED ON DRAWINGS. IT IS THE RESPONSIBILITIES OF THE CONTRACTOR TO PROVIDE AND INSTALL ALL COMPORENTS REQUIRED TO CREATE SUCH KATED CONSTRUCTION, EPOLADLESS OF WHEITHER OR NOT SUCH COMPONENTS ARE INDICATED. ROVIDE CONTRUCTY OF SUCH RATED CONSTRUCTION, EPOLADLESS OF WHEITHER OR NOT SUCH COMPONENTS ARE INDICATED. ROVIDE CONTRUCTY OF SUCH RATED CONSTRUCTION AND BETWEEN SPACES, INCLUDING AT CHASES AND AT FLOORS, TO MAINTAIN COMPLETE SEPARATIONS, EVEN IF
- 15. CONTRACTOR SHALL SUBMIT SAMPLES OF ALL INTERIOR FINISHES FOR ARCHITECT'S APPROVAL.

THE DESIGN AND INSTALLATION OF THE ELECTRICAL, HVAC AND FLUMBING SYSTEMS SHALL BE THE RESPONSIBILITY OF THE DESIGN/ BUILD CONTRACTOR, DESIGN SHALL BE IN CONFORMANCE WITH NFFA 101, 7000 EDITION, BOCA, 59 EDITION, MAINE STATE PLUMBING CODE

REFER TO SHEET A/102 FOR ADDITIONAL DEMOLITION REQUIREMENTS (04) (02) (04) (10)

DEMOLITION GENERAL NOTES PATCH AND REPAIR GENERAL NOTES

1. COORDINATION - PRIOR TO ANY DEMOLITION ALL DEMOLITION WORK SHALL BE COORDINATED WITH ALL NEW CONSTRUCTION BY ALL TRADES. CONTRACTOR SHALL REVIEW ALL CONSTRUCTION DOCUMENTS FOR COMPLETE COORDINATION DURING ALL PHASES OF CONSTRUCTION, GENERAL CONTRACTOR SHALL NOTIFY ARCHITECT BY WRITING OF ANY AND ALL FIELD CONSTRUCTION IN THE CONSTRUCTION DOCUMENTS PRIOR TO COMMENCEMENT OF DEMOLITION CONSTRUCTION. IN ABSENCE OF INFORMATION INDICATES OTHERWISE, CONTRACT SHALL BRING AREAS AND SURFACES UP TO STANDARDS OF NEW CONSTRUCTION IN THE AREAS CALLING FOR NEW CONSTRUCTION.

2. DAMAGE - EXISTING BUILDIN 1, BUILDING SYSTEMS AND SITE COMPONENTS WHICH ARE AFFECTED BY NEW CONSTRUCTION, DEMOLITION OR ARE DAMAGED BY THE GENERAL CONTRACTOR OR HIS SUB-CONTRACTORS SHALL BE REPLACED OR RESTORED TO ORIGINAL CONDITION, COLOR AND FRIESH AS DESCRIBED IN THESE DOCUMENTS OR APPROVED BY THE ARCHITECT.

- 3. PATCHING UPON REMOVAL OF ALL DEMOLITION CONSTRUCTION ITEMS AND OTHER COMPONENTS CONTRACTOR SHALL PATCH, REPAIR AND PREPARE ALL SURPACES DAMAGED OR OTHERWISE FOR SMOOTH LEVEL APPLICATION OF FINISHES. UNLESS OTHERWISE INDICATED FENISHES SHALL MATCH EXISTING FINISHES.
- 4. CONCEALED SPACES DAMAGED CONSTRUCTION IN CONCEALED SPACES IS NOT REQUIRED TO BE REPAIRED, EXCEPT AS REQUIRED TO MAINTAIN, FIRE RATINGS,
- 5. EQUIPMENT & FIXTURES NEW OR RELOCATED FIEMS SHALL BE VERIFIED BY CONTRACTOR AS APPROPRIATE TO THE ADJACENT AND CONTIGUIOUS CONSTRUCTION PRIOR TO INSTALLATION OR REINSTALLATION, CONTRACTOR SHALL DETERMINE APPROPRIATE ANCHORING TYPES UNLESS OTHERWISE

RENOVATION GENERAL NOTE

1. LEVEL, AND SMOOTH ALL FLOORS, WALLS AND CHILINGS TO RECEIVE NEW FINISHES AS INDICATED IN THE CONSTRUCTIN DOCUMENTS AND SHALL BE CERTIFIED


DEMOLITION CONSTRUCTION GENERAL NOTES

1. CONTRACTOR SHALL BE RESPONSIBLE FOR SECURITY AND PROTECTION FROM DAMAGE AND WEATHER OF ANY EXPOSED BUILDING COMPONENTS (NEW OR EXISTING) RESULTING FROM DEMOLITION, REMOVALS AND NEW WORK.

2. Refer to Demolition and structural plans for demolition work. Mechanical, electrical, plumbing and site demolition shall be COORDINATED AND PREFORMED WITH AND BY A LICENSED CONTRACTOR APPROPRIATE TO THE REQUIRED WORK.

3, VERIFY STRUCTURAL CONDITIONS WITH DRAWINGS AND ACTUAL CONDITIONS PRIOR TO ANY DEMOLITION CONSTRUCTION. REPORT DISCREPANCIES TO THE ARCHITECT PRIOR TO PROCEEDING WITH THE WORK. CONTRACTOR IS RESPONSIBLE FOR ALL SHORING AND OTHER TEMPORARY SUPPORT METHODS AS MAY BE

4. CONTRACTOR SHALL STOCKPILE AND PROTECT ALL ITEMS REMOVED FROM THE BUILDING FOR THE OWNERS REVIEW. ALL ITEMS THE OWNER DOES NOT KEEP SHALL BE REMOVED FROM THE SITE AND DISPOSED OF LEGALLY.

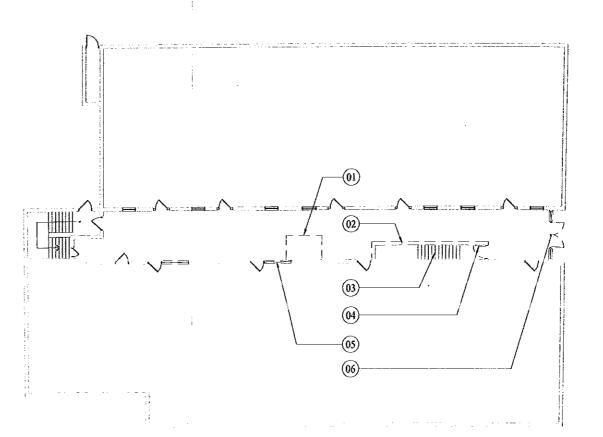


FIRST FLOOR DEMOLITION PLAN

SCALE: 3/32" = 11-0"



DEMOLITION LEGEND FLOOR PLAN

01) SAW CUT CONCRETE SLAB & REMOVE AS REQUIRED FOR NEW ELEVATOR PIT - SHORE AS REQUIRED TO INSURE STRUCTURAL INTEGRITY OF ALL CONSTRUCTION TO REMAIN

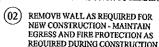



- (04) REMOVE DOOR, DOOR FRAME & ASSOCIATED HARDWARR AS REQUIRED FOR NEW CONSTRUCTION
- (05) REMOVE WINDOW AS REQUIRED FOR NEW CONSTRUCTION
- (06) REMOVE STOREFRONT WINDOW. DOOR, DOOR FRAME & ASSOCIATED HARDWARE AS REQUIRED FOR NEW CONSTRUCTION
- 07) REMOVE FLOOR & STRUCTURE AS REQUIRED FOR NEW ELEVATOR -SHORE AS REQUIRED TO INSURE STRUCTURAL INTEGRITY OF ALL. CONSTRUCTION TO REMAIN
- REMOVE ROOF & STRUCTURE AS REQUIRED FOR NEW ELEVATOR. SHORB AS REQUIRED TO INSURE STRUCTURAL INTEGRITY OF ALL CONSTRUCTION TO REMAIN
- REMOVE ROOFING AS REQUIRED FOR NEW CONSTRUCTION PROTECT FROM WEATHER
- (10) REMOVE GRID & FIXTURES & HVAC GRILLS AS REQUIRED FOR NEW

GENERAL NOTES

- 1. REMOVE ALL CEILING GRIDS AND TILES AS REQUIRED FOR NEW CONSTRUCTION.
- 2. REMOVE ALL WALL COVERINGS AND FINISHES AS REQUIRED FOR APPLICATION OF NEW FINISHES.
- 3. REMOVE ALL FLOOR COVERINGS AND SMOOTH AND LEVEL AS REQUIRED FOR APPLICATION OF NEW
- 4. REMOVE MECHANICAL, ELECTRICAL AND/OR PLUMBING FIXTURES AS REQUIRED FOR NEW CONSTRUCTION - REMOVE ALL. ASSOCIATED SERVICES BACK TO MAIN BRANCH - CAP AS REQUIRED.







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> **AUBURN STREET** RENOVATION

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AUG 0 5 7003 ALUED CONSTRUCTION

8

REVISIONS 5/23/03 ISSUED FOR


S723/03 ISSUED FOR CONSTRUCTION STAIR REVISION STAIR ASSUED FOR AGGIS SUITE

	J
DATE	5/23/03
ROJECT #	090602
RAWNBY:	DMR
HECKED BY:	SWG
RAWD'S SCALE	ASNOTED

SHEET TITLE

FIRST & SECOND FLOOR DEMOLITION PLANS

D101

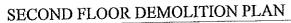

SCALB: 3/32* = 1'-0*

D101/

ROOF DEMOLITION


PLAN

3 PLAN D101 SCALE: 3/32" = 1'-0"







ISSUED FOR CONSTRUCTION

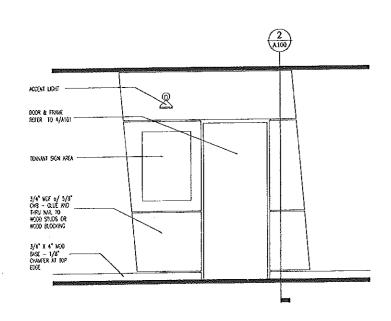




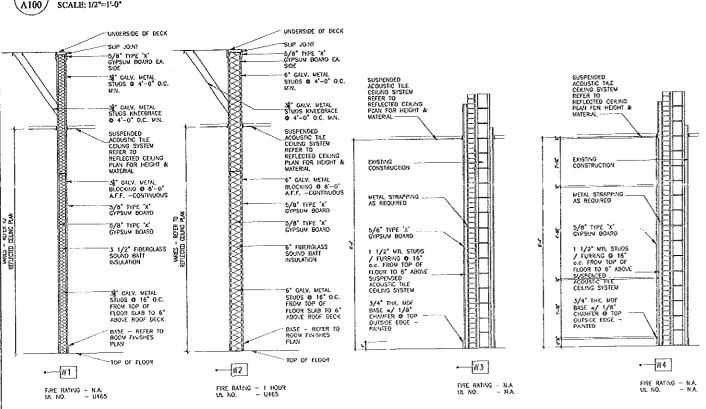

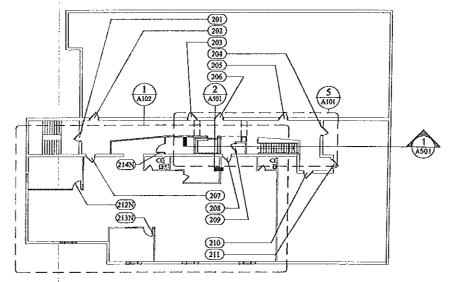

OVERALL SECOND FLOOR PLAN

A100 SCALE: 1/16"=1'-0" REFER TO 5/A101 FOR DOOR TYPES

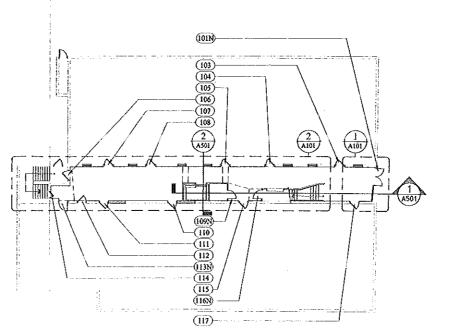

OVERALL FIRST FLOOR PLAN

A100 | SCALE: 1/16"=1'-0"







GAWRON ARCHITECTS
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AUBURN STREET RENOVATION 8

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ALLIED CONSTRUCTION

REVISIONS 1 5/23/03 ISSUED FOR CONSTRUCTION 2 6/05/03 ISSUED FOR STAIR REVISION 3-5/23/03 ISSUED FOR 8/4/02 AEGIS SUITE

DATE: 8/04/03 ROJECT# 090602 DRAWN BY: DMR CHECKED BY 28.0 DRAWING SCALE AS NOTED

SHEET TITLE

OVERALL FIRST & SECOND FLOOR PLAN

CONSTRUCTION DOES NOT INCLUDE MODIFICATIONS OF SIZE OR EGRESS FROM EXISTING TENANT SPACES

GENERAL NOTES:

1. BLEVATOR - BASE: THYSSENKRUPP, MARQUIS 25 OILDRAULIC HOLELESS ELEVATOR SHALL MEBT ALL LOCAL, STATE AND FEDERAL CODES

2. ALL MECHANICAL, ELECTRICAL AND PLUMBING DESIGN SHALL BE PREFORMED BY DESIGN BUILD

REQUIRED AND COORDINATE ALL

DESIGN & INSTALLATION SHALL MEBT ALL LOCAL, STATE &

3. ALL DOOR NUMBERS WITH A 'N'
ARB NEW DOORS AND FRAMES.

ALL OTHERS ARE TO BE NEW DOORS IN EXISTING FRAMES WERE

'LABEL' REQUIREMENTS ARE MEET.

- ALL HARDWARED TO BE COORDINATED WITH OWNER

4. SCOPE OF PROPOSED

CONTRACTOR - CONTRACTOR SHALL DETERMINE ALL WORK

CONSTRUCTION TO REMAIN.

NEW AND EXISTING


FEDERAL CODES

A100

PARTITION TYPES

A100 SCALE: 1/2"=1'-0"

REFER TO 5/A101 FOR DOOR TYPES

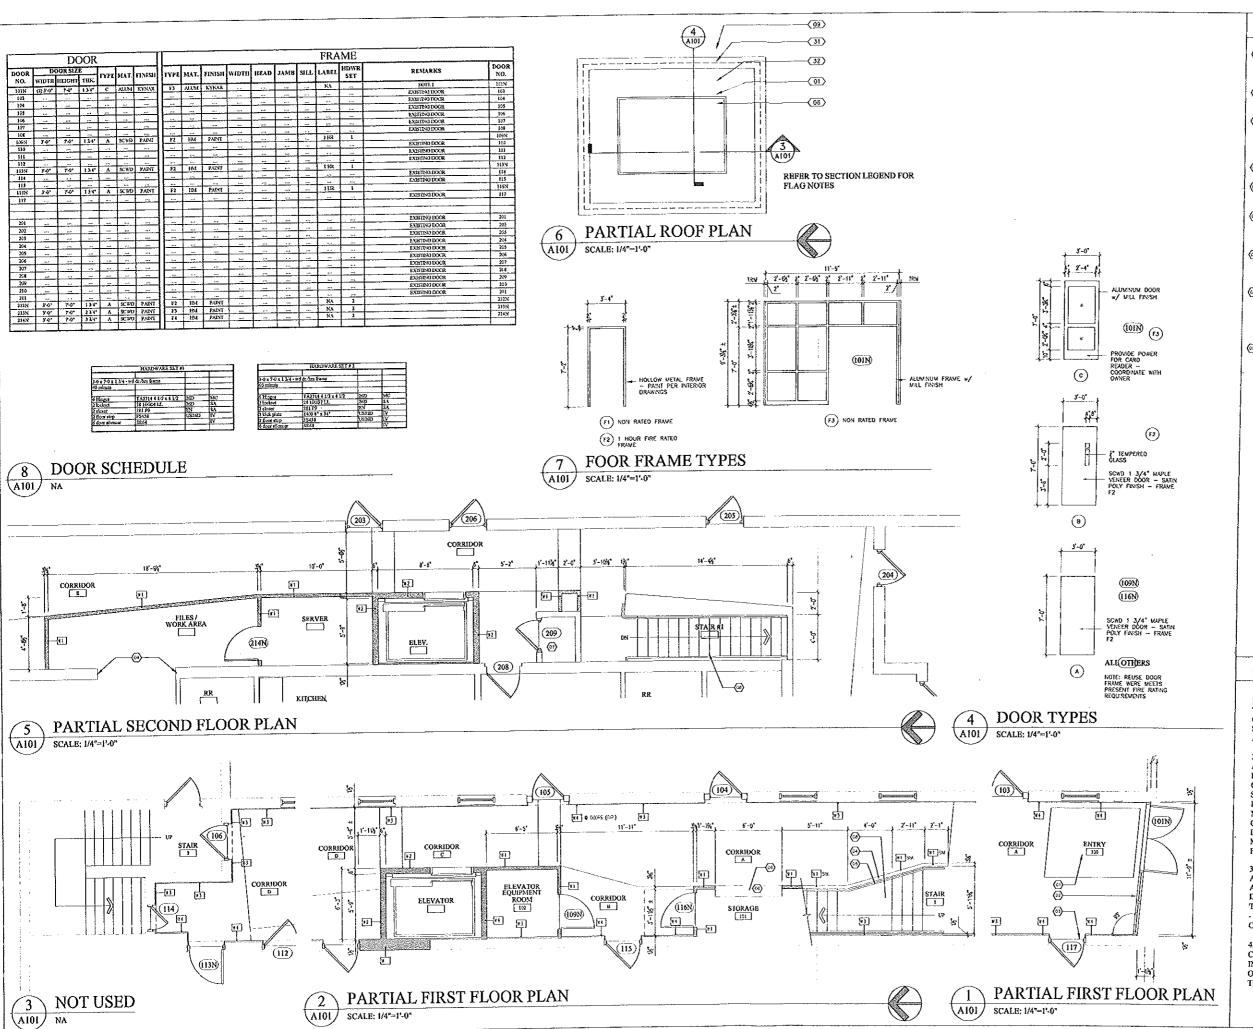

PLAN NOTES:

- WALL OFF MAT SET FLUSH TO CERAMIC TILE - REFER TO FLOOR FINISHES PLAN
- ALUMINUM STOREFRONT WINDOW SYSTEM - REFER TO 7/A101
- (II) TRANSITION STRIP AS REQUIRED FOR SMOOTH LEVEL TRANSITION BETWEEN NEW AND EXISTING FLOOR FINISHES (TYPICAL)
- (a) 5/4" BIRCH CAP REFER TO 5/A501
- HANDRAIL 1 K" DIA STEEL, HANDRAIL SYSTEM PAINTED
- (2) 3614FL MAILBOXES w/ 13 USUAL MAJLBOXES EACH BY MAILBOXES.COM
- TELEPHONE DATA ROOM TO
 REMAIN, PROTECT AS REQUIRED
 DURING CONSTRUCTION
- NEW STAIR OM EXISTING
 STAIRWAY FLOOR OPENING -FIELD VERIFY FOR REQUIRED CLEARANCES PRIOR TO CONSTRUCTION
- OPENING SUPPORT (DESIGN BY L & L STRUCTURAL) PROVIDED BY OWNER - HEADER, (7) 2"X10" MEMBER w/ 3/4" PLYWOOD SPACER TO ACHIEVE 11 1/4" WIDTH OF EXISTING WALL. THE INDIVIDUAL MEMBERS OF THE BUILT-UP HEADER SHALL BE FASTNED TOGETHER WITH TWO ROWS OF 16d NAILS @ 12" o.c. AT THE TOP & BOTTOM OF HEADER. THE NEW HEADER SHALL BEAR ON DOUBLE 2"x12" JACK STUDS w/ A SINGLE FULL HEIGHT 2"x12" KING STUD @ BOTH ENDS OF EACH HEADER. ADDITIONAL SOLID BLOCKING SHALL BE INSTALLED BENEATH THE SECOND FLOOR ALIGNED W EACH DOUBLE JACK STUD (TWO PLACES) THE SOLID BLOCKING SHALL BE INSTALLED IN THE CAVITY CREATED BY THE SECOND FLOOR JOIST SEATS TIGHT BETWEEN THE UNDERSIDE OF THE EXISTING PLYWOOD FLOOR DECK AND THE TOP OF THE MASONRY WALL AT THE FIRST FLOOR BELOW. THE CONTRACTOR SHALL PROVIDE TEMPORARY SUPPORT OF THE EXISTING ROOF STRUCTURE AS REQUIRED TO INSTALL THE NEW HEADERS, DESIGN FOR 7-0" OPENING OR SMALLER

GENERAL NOTES:

- 1. ELEVATOR BASE: THYSSENKRUPP, MARQUIS 25 OILDRAULIC HOLELESS ELEVATOR SHALL MEBT ALL LOCAL, STATE AND FEDERAL CODES
- 2. ALL MECHANICAL, ELECTRICAL AND PLUMBING DESIGN SHALL BE PREFORMED BY DESIGN BUILD CONTRACTOR - CONTRACTOR SHALL DETERMINE ALL WORK REQUIRED AND COORDINATE ALL NEW AND EXISTING CONSTRUCTION TO REMAIN. DESIGN & INSTALLATION SHALL MEET ALL LOCAL, STATE &
- 3. ALL DOOR NUMBERS WITH A 'N' ARE NEW DOORS AND FRAMES. ALL OTHERS ARE TO BE NEW DOORS IN EXISTING FRAMES WERE LABEL' REQUIREMENTS ARE MEET, - ALL HARDWARED TO BE COORDINATED WITH OWNER
- 4. SCOPE OF PROPOSED CONSTRUCTION DOES NOT INCLUDE MODIFICATIONS OF SIZE OR EGRESS FROM EXISTING TENANT SPACES





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AUBURN STREET RENOVATION

94

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ALLIED CONSTRUCTION


REVISIONS 5/23/03 ISSUED FOR CONSTRUCTION STAIR STAIR SEVISION 5/23/03 ISSUED FOR S/3/03 AEGIS SUITE


80403 PROJECT # 050002 DRAWN BY DMR HECKED BY: SWO DRAWING SCALE AS NOTED


SHEET TITLE

FIRST & SECOND FLOOR PLAN ENLARGEMENTS

A101

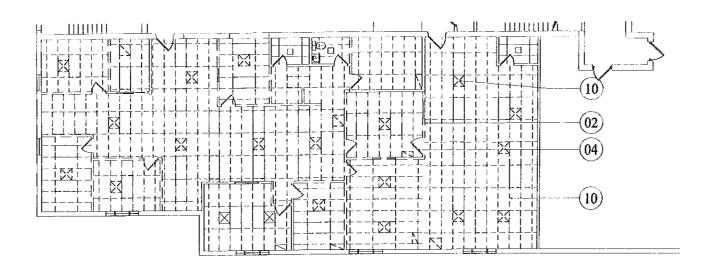

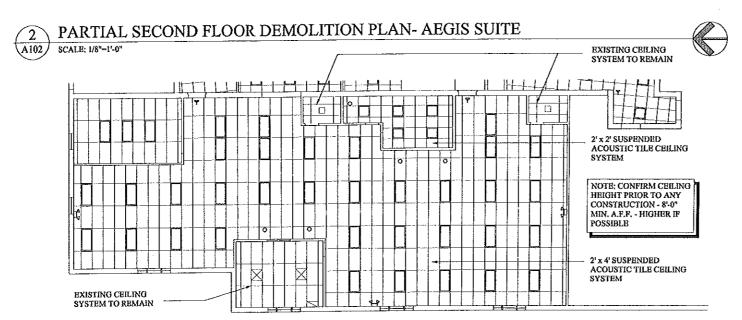

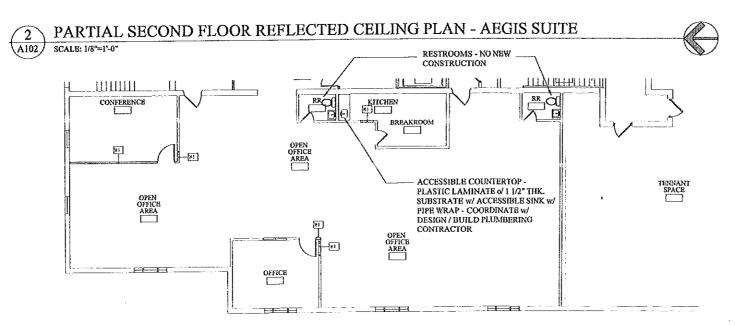

PARTIAL SECOND FLOOR PLAN- AEGIS SUITE A102/ SCALE: 1/8"=1'-0"



DEMOLITION LEGEND FLOOR PLAN

- (01)SAW CUT CONCRETE SLAB & REMOVE AS REQUIRED FOR NEW ELEVATOR PIT - SHORE AS REQUIRED TO INSURE STRUCTURAL INTEGRITY OF ALL CONSTRUCTION TO REMAIN
- REMOVE WALL AS REQUIRED FOR NEW CONSTRUCTION MAINTAIN (02) EGRESS AND FIRE PROTECTION AS REQUIRED DURING CONSTRUCTION
- REMOVE STAIR AS REQUIRED FOR (03) NEW CONSTRUCTION-MAINTAIN EGRESS AND FIRE PROTECTION AS REQUIRED DURING CONSTRUCTION
- REMOVE DOOR, DOOR FRAME & ASSOCIATED HARDWARE AS
- (05) REMOVE WINDOW AS REQUIRED FOR NEW CONSTRUCTION
- REMOVE STOREFRONT WINDOW, DOOR, DOOR FRAME & ASSOCIATED HARDWARE AS REQUIRED FOR NEW (06)
- (07) REMOVE FLOOR & STRUCTURE AS REQUIRED FOR NEW FILEVATOR SHORE AS REQUIRED TO INSURB STRUCTURAL INTEGRITY OF ALL
- (08) REMOVE ROOF & STRUCTURE AS REQUIRED FOR NEW ELEVATOR . SHORE AS REQUIRED TO INSURE STRUCTURAL INTEGRITY OF ALL CONSTRUCTION TO REMAIN
- (09) REMOVE ROOFING AS REQUIRED FOR NEW CONSTRUCTION - PROTECT FROM WEATHER
- (10) REMOVE GRID & FIXTURES & HVAC GRILLS AS REQUIRED FOR NEW CONSTRUCTION

DEMOLITION NOTES

- I. REMOVE ALL CEILING GRIDS AND TILES AS REQUIRED FOR NEW CONSTRUCTION
- 2. REMOVE ALL WALLCOVERINGS AND FINISHES AS REQUIRED FOR APPLICATION OF NEW FINISHES,
- 3. REMOVE ALL FLOOR COVERINGS AND SMOOTH AND LEVEL AS REQUIRED FOR APPLICATION OF NEW
- 4. REMOVE MECHANICAL, ELECTRICAL AND/OR PLAIMBING FIXTURES AS REQUIRED FOR NEW CONSTRUCTION - REMOVE ALL ASSOCIATED SERVICES BACK TO MAIN BRANCH - CAP AS REQUIRED.

REFLECTED CEILING PLAN LEGEND

- 2×2 PARABOLIC LIGHT FOXTURE
- RECESSED FLORESCENT 0 DECORATIVE SUSPENED LIGHT
- SUSPENDED FLORESCENT
- Ø RETURN AST GREET
- M SUPPLY AR GREE
- EMERGENCY LIGHTING WALL PACK
- EXIT SIGN

PLAN NOTES:

- WALL OFF MAT SET FLUSH TO CERAMIC TILE REFER TO FLOOR FINISHES PLAN
- ALUMINUM STOREFRONT WINDOW SYSTEM - REFER TO 7/A101
- TRANSITION STRIP AS REQUIRED FOR SMOOTH LEVEL TRANSITION BETWEEN NEW AND EXISTING FLOOR FINISHES (TYPICAL)
- MANDRAIL 1 1/4" DIA STEEL HANDRAIL SYSTEM - PAINTED
- (2) 3614FL MAILBOXES w/ 13 USUAL MAILBOXES EACH BY MAILBOXES.COM
- TELEPHONE DATA ROOM TO REMAIN, PROTECT AS REQUIRED DURING CONSTRUCTION (07)
- (a) NEW STAIR OM EXISTING STAIRWAY FLOOR OPENING -FIELD VERIFY FOR REQUIRED CLEARANCES PRIOR TO CONSTRUCTION
- OPENING SUPPORT (DESIGN BY L & L STRUCTURAL) - PROVIDED BY OWNER - HEADER, (7) 2"X10" MEMBER w/ 3/4" PLYWOOD SPACER TO ACHIEVE 11 1/4" WIDTH OF EXISTING WALL. THE INDIVIDUAL MEMBERS OF THE BUILT-UP HEADER SHALL BE FASTNED TOGETHER WITH TWO ROWS OF 16d NAILS @ 12" o.c. AT THE TOP & BOTTOM OF HEADER. THE NEW HEADER SHALL BEAR ON DOUBLE 2"x12" JACK STUDS w/ A SINGLB FULL HEIGHT 2"x12" KING STUD @ BOTH ENDS OF EACH HEADER, ADDITIONAL SOLID BLOCKING SHALL BE INSTALLED BENEATH THE SECOND FLOOR ALIGNED W EACH DOUBLE JACK STUD (TWO PLACES) THE SOLID BLOCKING SHALL BE INSTALLED IN THE CAVITY CREATED BY THE SECOND FLOOR JOIST SEATS TIGHT BETWEEN THE UNDERSIDE OF THE EXISTING PLYWOOD FLOOR DECK AND THE TOP OF THE MASONRY WALL AT THE FIRST FLOOR BELOW. THE CONTRACTOR SHALL PROVIDE TEMPORARY SUPPORT OF THE EXISTING ROOF STRUCTURE AS REQUIRED TO INSTALL THE NEW HEADERS, DESIGN FOR 7-0" OPENING OR SMALLER

GENERAL NOTES:

- 1. ELEVATOR BASE: THYSSENKRUPP, MARQUIS 25 OHDRAULIC HOLELESS ELEVATOR SHALL MEET ALL LOCAL, STATE
- 2. ALL MECHANICAL, ELECTRICAL AND PLUMBING DESIGN SHALL BE PREFORMED BY DESIGN BUILD CONTRACTOR - CONTRACTOR SHALL DETERMINE ALL WORK REQUIRED AND COORDINATE ALL NEW AND EXISTING CONSTRUCTION TO REMAIN.
 DESIGN & INSTALLATION SHALL MEET ALL LOCAL, STATE & FEDERAL CODES
- 3. ALL DOOR NUMBERS WITH A 'N' ARE NEW DOORS AND FRAMES.
 ALL OTHERS ARE TO BE NEW DOORS IN EXISTING FRAMES WERE 'LABEL' REQUIREMENTS ARE MEET. - ALL HARDWARED TO BE COORDINATED WITH OWNER
- 4. SCOPE OF PROPOSED CONSTRUCTION DOES NOT INCLUDE MODIFICATIONS OF SIZE OR EGRESS FROM EXISTING TENANT SPACES







AUBURN STREET RENOVATION

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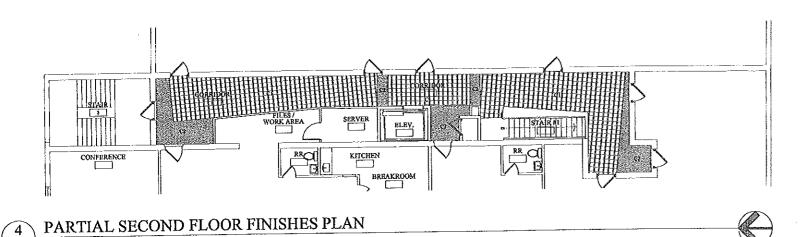
L	ALC:ED	CONSTRUCTION
Γ	RE	VISIONS
D	DATE	DESCRIPTION
1	5/23/03	ISSUED FOR
2	6/05/03	CONSTRUCTI ISSUED FOR
3		STAIR REVISION
3	81463	ISSUED FOR AEGIS SUITE
1		

DATE:	8/04/03
PROJECT#	090602
DRAWN BY:	DMR
HECKED BY:	SWG
DRAWING SCALE	AS NOTED

SHEET TITLE

PARTIAL SECOND FLOOR PLANS AEGIS SUITE

A102



4 PARTIAL SECOND FLOOR FINISHES PLAN SCALE: 1/8*-1'-0' CORRIDOR CORRIDOR CORRIDOR CORRIDOR CORRIDOR CORRIDOR CORRIDOR STAIR STAIR STORAGIB STORA

CALE: 1/8"=1'-0"	
GRB SOFFIT - 'A' GWB of S' MILERANING @ 16' oc. Cl.2	

0 1

PARTIAL FIRST FLOOR REFLECTED CEILING PLAN
SCALE: 1/8"=1'.0"

PARTIAL SECOND FLOOR REFLECTED CEILING PLAN

PARTIAL FIRST FLOOR FINISHES PLAN

(3) (A301)

A301



94 Auburn Street Renovat 090602.

										Trien	Cour	UCabs	
Room #	Room Name	Floor	Grout	Base	Ceiling	North Wall	Fest Was	South Wall	West Wall	Ptd./Stn.	Horz	Vert	Remarks
irst Floor						1						1	
100	Entry	T1/EM1	G1	TB1	ACT	P2	P4	P2	P4	P5	N/A	N/A	
101	Storage	VCT1	N/A	VCB1	GWB,PTO.	P4	P4	P4	P4	25	N/A	N/A	
102	Eley Equip Rm	VCT1	N/A	VCB1	GWB,PTD.	P4	P4	P4	P4	P5	N/A	ΝΆ	
A	Corridor	C1/C2/T1	N/A	VCB1	ACT	P1/P2/P3	. P2	P1/P2/P3	P2	P5	N/A	N/A	See D601 for ptd. Locations
₿	Carridor	C2	N/A	VCB1	GY/B,PTD.	N/A	P2	P1/P2/P3	P2	P5	N/A	₹UA	See D601 for ptd. Locations
C	Corridor	C1/C2	N/A	VCB1	ACT	P1/P2/P3	P2	P1/P2/P3	P2	P5	N/A	N/A	See D601 for ptd. Locations
Ð	Corridor	C1/C2	N/A	VCB1	ACT/GW8,PTO.	P1/P2/P3	P2	P1/P2/P3	P2	P5	N/A	AUA.	See D601 for ptd. Locations
1	Stair	VTN1	N/A		GWB,PTD.	P4	P4	P4	₽1 .	P5	N/A	N/A	
2	Stair	YTN1	N/A		GWB,PTD.	P4	P4	P4	P1	P5	N/A	N/A	
Elev	Elevator										,	•	* Finishes TBO upon cab system selection
Second Floor	i												
. 201	Closet	VCTs	N/A	VCB1	ACT	P4	P4	P4 .	P4	P5	N/A	N/A	
£	Corridor	C1/C2	N/A	VCB1	ACT	P1/P2/P3	P4	P1/P2	P4	P5	N/A	N/A	Sea D601 for ptd. Locations
F	Corridor	C1/C2	N/A	VCBf	ACT	1UA	P1/P2	P1/P2	P4	25			See D601 for ptd. Locations

		INTERI	OR FINISH LEGEN	D	
		Project Title / Name Project Number	94 Aubum Street Renov 090602:00	etion	
oce	Maria	Manufacturer	Protect Color	Size	Frish
Cí	Carpet	Shaw Commercial Contract	Mode (50885), Energetic (85546)	N/A	Factory
C2	Carpet	Shaw Commercial Contract	Zanzibar (50742), Bongo Julce (42545	N/A	Factory
VCT1	Viryl Composition Tile	Mannington Commerical	Designer's Essentials, 235-Moss	12x12	Sealed
EM1	Entrance Mat	Mats Floor Matting	Berber, Light Beige	Roll goods	Factory
T1	Glezed Porcelain Ploor Tile	Dal-TTe	Pietre Vecchie, Champagne PV02	13°x13°	Sealed
G1	Grout	Hydroment Grouts	Arcique White, \$120	N/A	Sealed
V¢81	Vinyl Cove Wall Base	Johnsonite .	Sage-13	8"	Factory
VTN1	Vinyl Tread/Riser System	Johnsonita	Raised round treaditiser combination (RTR), 80 Fewn	Verify in field	Factory
TBS	Gazed Porce ain Wall Base Tile	Del-Tite	Pietre Vecchie, Champagne-PV02, S- 43E9	3'x13'	Seated
Pf	Paint	Sherwin Williams	Ambitious Amber, SW6366	N/A	Satin
P2	Paint	Sherwin Williams	Celery, SV/6421	N/A	Sain
P3	Paint	Sherwin Williams	Artichoka, SW6179	NA	Satin
P4	Paint	Sherwin Williams	Queen Anne's Lace, SW6420	N/A	Satin
P5	Paint, trim	Sherwin Villams	Venetian Lace, SW7119	N/A	Semi-Gloss
CL-1	Ee ceiing system	Armstrong	D∪na	2 x 2	5/16° white grid
ÇL-2	Paint O/ GWB	Sherwin Williams	Bright ceiling white	NA.	Flet

REFLECTED CEILING PLAN LEGEND

2×2 PARABOLIC LIGHT FIXTURE

O RECESSED FLORESCENT

DECORATIVE SUSPENED LIGHT
FOXTURE

PETURN AIR G

EVERGENCY LIGHTING WALL PACK

■ HORN STROBE

EXIT SIGN





GAWRON ARCHITECTS 29 Black Point Road Scarborough, MB 04074

www.gawron.com Tel. 207 . 883 . 6307 Fax. 207 . 883 . 0361

> 94 AUBURN STREET RENOVATION

AUG 0 5 7003
ALLIED CONSTRUCTIO

	·
DATE:	80403
PROJECT #	650602
DRAWNBY:	DMR
СНЕСКЕЮ ВУ:	\$110
DRAWD;G SCALE	AS NOTED


SHEET TITLE

FIRST & SECOND FLOOR PARTIAL REFLECTED CEILING PLAN

A301

O COPYFICHT 1935 - 200 EMPORATION OF BLACK OF PAS OF SEASON OF ESCAN PROSESSION OF

NOTE: ALL FLOORING, CEILINGS, & FINISHES IN AEGIS SUITE SHALL BE SELECTED BY OWNER

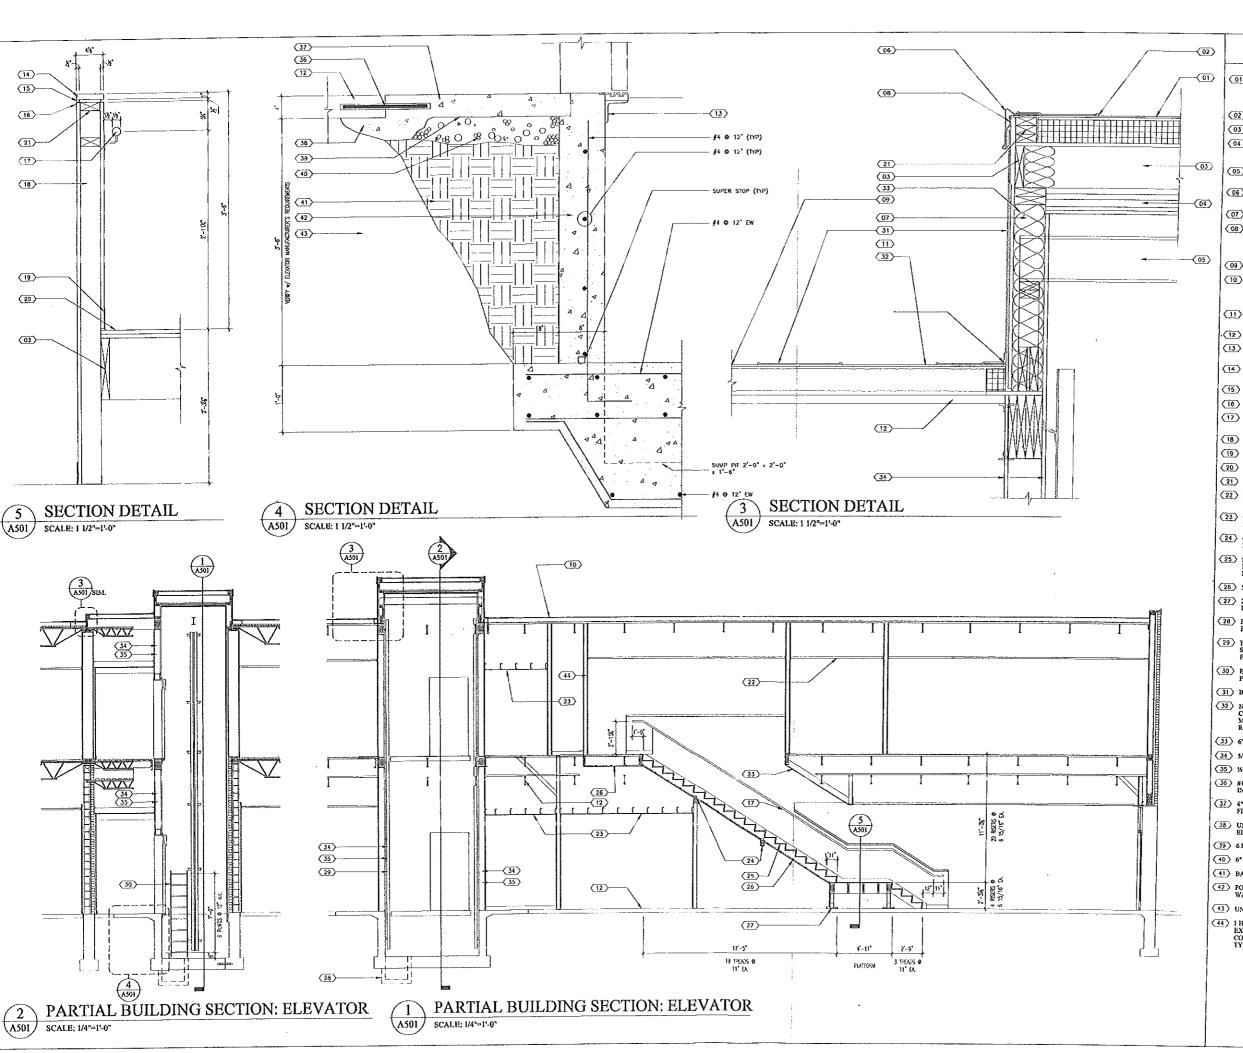

SECTION LEGEND:

- (01) ROOFING SYSTEM -SINGLE PLY PPDM MEMBRANE & '\$" ROOFING BOARD & 4" POLYISOCYANURATE INSULATION & '%" PLYWOOD ROOF DECK
- (02) LAPSEALANT
- (03) REFER TO STRUCTURAL
- 04) 1 HOUR FIRE RATED SHAFT WALL CONSTRUCTION HORIZONTALLY ATTACHED
- 05 ELEVATOR ERECTION BEAM REFER TO STRUCTURAL
- 06 PRE-FINISHED ALUMINUM COPING W/ SPRING CLIPS COLOR BY ARCHITECT
- (07) 5 1/2" WOOD STUDS @ 16" o.c.
- (09) ROOFING MEMBRANE SHALL CONTINUE UP SURFACE & OVER TOP OF WALL / PARAPET AND CONTINUE DOWN OPPOSITE SIDE I* ABOVE COPING/TRIM
- 09 EXISTING BUILT-UP ROOFING SYSTEM
- 19 LOCATE ROOF SLOPE AND PROVIDE CRICKER'S AS REQUIRED TO INSURE PROFER MOVEMENT OF WATER TO EXISTING ROOF DRAINAGE SYSTEM
- ROOFING SYSTEM STANDARD EDGE TIE-IN DETAIL ATTACH TO VERTICAL SURFACE
- (12) EXISTING CONSTRUCTION TO REMAIN
- (13) ELEVATOR DOOR SILL STEEL ANGLE BY ELEVATOR INSTALLER
- 5/4" BIRCH WOOD CAP w/ 1/8" CHAMFERS AT EA TOP SIDE CLEAR POLY FINISH
- (15) %"x %" REVEAL
- (18) I MOLDING @ TOP EDGE EACH SIDE
- HANDRAIL 1/4" DIA. STEEL TUBE PAINTED -E. SIDE
- (18) 3 1/2° WOOD STUD FRAMING @ 16° o.c.
- 19 BASE REFER TO FINISHES LEGEND
- (20) DECK-(2) LAYER 1/4" PLYWOOD
- 21 2" x WOOD BLOCKING
- 22 SUSPENDED ACOUSTICAL CEILING SYSTEM
 REFER TO REFLECTED CEILING PLANS
- (23) GWB SOFFIT 5/8" GWB of 6" MIL STUDS @
- (2) 2"x8" WOOD BRACE of (2) 2"x4" WOOD POSTS EA, SIDE
- (25) STAIR RAISERS (SLOPED) & TREADS 1/2*
 PLYWOOD REFER TO FLOOR FINISHES
 PLAN
- (26) 5/8" TYPE X 'GWB o/ %" WOOD FURRING
- 2"x12"x 3/8" STEEL CHANNEL STAIR
 LANDING FOOTING
- 28 ELEVATOR SUMP 2\2\2\1\6"
 POURED-IN-PLACE CONCRETE
- (29) ELEVATOR RAIL SYSTEM -BY ELEVATOR SUPPLIER LATERAL SUPPORT AT EACH FLOOR
- (30) ELEVATOR PIT LADDER STEEL LADDER PER CODE PAINTED
- 31) BASE FLASHING
- 32 NEW TO EXISTING ROOF SPLICE.
 CONSTRUCTION AS REQUIRED BY ROOFING
 MANUFACTURER TO COMPLY WITH
 ROOFING WARRANTY CONSTRUCTION
- (33) 6" FIBERGLASS BATT INSULATION
- 34 5/8" TYPE 'X' GWB
- (35) % PLYWOOD
- (J6) #4 BAR 12" LONG @ 16" o.c. BORE & EPOXY INTO EXISTING SLAB
- 4° POURED-IN-PLACE CONCRETE SLAB w/ FIBER MESH
- 38 UNDER POUR SLAB AS REQUIRED TO ELIMINATE POTENTIAL INDERMINING
- 39) 6 MILL VAPOR RETARDER
- (40) 6" COMPACTED GRANULAR FILL 41 BACKFILL COMPACTED TO 98 %
- (42) FOURED-IN-PLACE CONCRETE FOUNDATION WALL
- (43) Undisturbed Earth
- (4) I HOUR FIRE RATED WALL. VERIFY EXISTING CONSTRUCTION FOR COMPLIANCE OR RECONSTRUCT AS WALL TYPE WI





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AUBURN STREET RENOVATION 4

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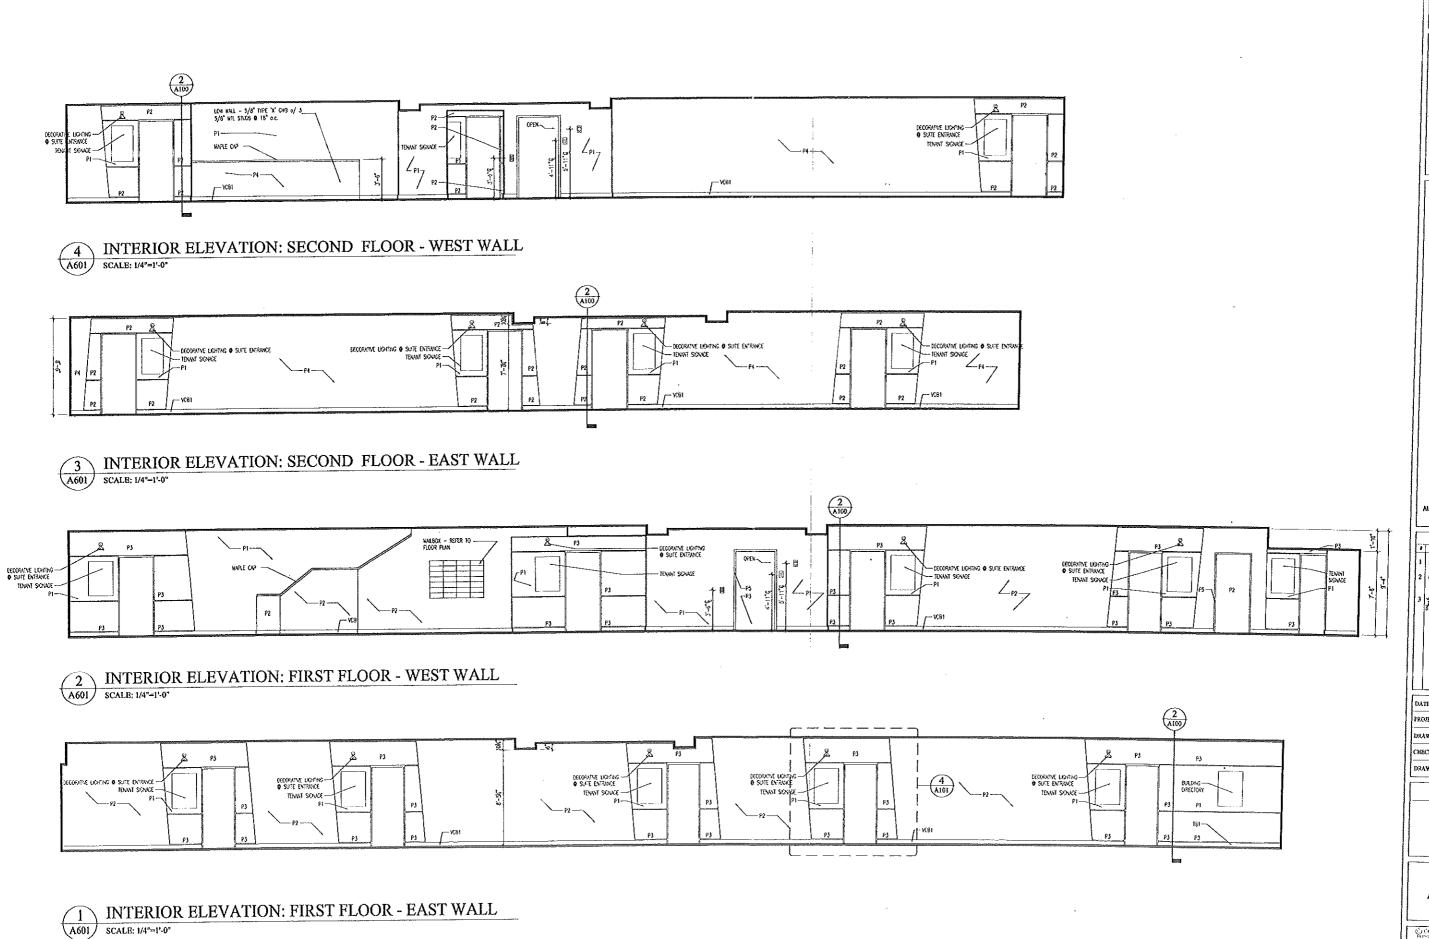
ALLIED CONSTRUCTION REVISIONS 1 5/23/03 ISSUED FOR CONSTRUCTIO CONSTRUCTIO STAIR REVISION 1 SSUED FOR Q 1/4/03 AEGIS SUITE

DATE;	A-04-03
ROJECT#	090602
ZAWN BY;	DMR
HECKED BY:	SWG
BLANDY DATABASE	AS NOTED

SHEET TITLE

SECTIONS & DETAILS

A501







94 AUBURN STREET RENOVATION

RECEIVED AUG 0 5 2003

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REVISIONS

| DATE DESCRIPTION

| SY2303 ISSUED FOR CONSTRUCTION
| SSUED FOR STAIR REVISION ISSUED FOR ISSUED F


DATE	2	80403
РКОЛ	CT#	090602
DRAW	NBY;	DMR
CHEC	KEDBY:	5%0
DRAW	LNG SCALE	AS NOTED

SHEET TITLE

INFERIOR ELEVATIONS

A601

C COPTRICHT 1935 - 200 REPORTS OF MAZE OF THE ORIGINAL PROOF PROOF MERCEN OF

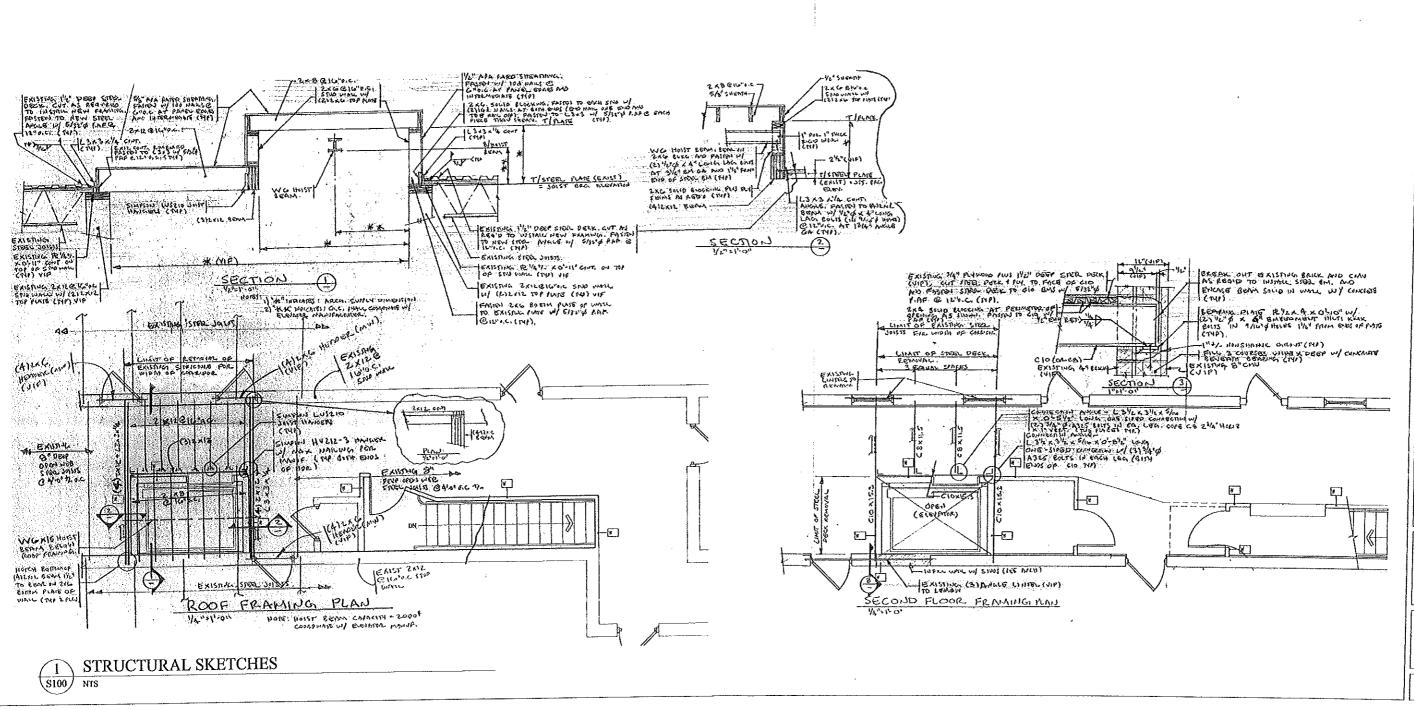





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AUBURN STREE RENOVATION 4

RECEIVED AUS 0 5 2003

ALUED CONSTRUCTION

REVISIONS # DATE DESCRIPTION 1 5/23/03 ISSUED FOR CONSTRUCTION
2 6/05/03 ISSUED FOR STAIR REVISION
3 #/23/03 ISSUED FOR SI/V 2 AEGIS SUITE

DATE 80463 PROJECT # 090602 DRAWN BY: DMR CHECKED BY: SWG DRAWING SCALE AS NOTED

SHEBT TITLE

STRUCTURE

S100