

FAN PERFORMANCE SCHEDULE													
TAG	AIRFLOW (CFM)	T.S.P (INWG)	NOISE (SONES)	RPM	DRIVE	ELECTRICAL REQUIREMENTS				BASIS OF DESIGN - GREENHECK			
						HP	BHP	WATTS	AMPS	V/PH/Hz	SERVICE	ARRANGEMENT	MODEL
EF-1	1200	-	5.5	1283	DIRECT	1/2	-	-	-	120/1/60	HAZMAT AREA EXHAUST	SIDEWALL	SEI-12-432-G
EF-2	1800	0.25	14.8	1583	DIRECT	1/2	-	-	-	120/1/60	WELDING AREA EXHAUST	DOWNBLAST	G-123-VG
EF-3	1200	0.5	19.4	2601	BELT	3/4	-	-	-	208/3/60	PAINT BENCH EXHAUST	UPBLAST	TCBRU-1-09

PACKAGED ROOFTOP UNIT PERFORMANCE SCHEDULE															BASIS OF DESIGN - DAIKIN					
TAG	NOMINAL COOLING (TONS)	TOTAL COOLING (MBH)	SENSIBLE COOLING (MBH)	EDB/EUB (°F)	TOTAL AIRFLOW (CFM)	E.S.P. (INWG)	SUPPLY FAN RPM	MINIMUM O.A. (CFM)	FUEL INPUT (MBH)	HEATING OUTPUT (MBH)	EER (BTUH/WATT)	WEIGHT (LBS)	TYPE OF REFRIGERANT	FUEL	ELECTRICAL REQUIREMENTS				BASIS OF DESIGN - DAIKIN	
															HP	MCA	MOCP	V/PH/Hz	SERVICE	MODEL
HVAC-1	1.5	86.6	68.1	16.6/6.3	3000	0.15	180	300	15.0	12.5	11.2	1400	R-410A	NAT GAS	2.0	18.5	20.0	460/3/60	SECOND FLR OFFICES	YSC092

PROVIDE ALL UNITS WITH DUAL ENTHALPY ECONOMIZER





AIR DEVICE PERFORMANCE SCHEDULE										
TAG	PANEL SIZE (IN)	NECK SIZE (IN)	AIRFLOW (CFM)	SPLOSS (INWG)	THROU (L)	Nc	BASIS OF DESIGN - METALAIR			
							DUCT CONN (IN)	PATTERN	MODEL	
A	24x24	6x6	100	0.05	-	25	SEE DWGS	SEE DWGS	5000D	
B	24x24	12x12	350	0.05	-	25	SEE DWGS	SEE DWGS	5000D	
C	24x24	10"ø	350	0.05	-	25	SEE DWGS	SEE DWGS	MSE-HC	
AA	-	8x8	100	0.05	-	25	SEE DWGS	1/2", 45°	R4D	
BB	-	12x12	400	0.05	-	25	SEE DWGS	1/2", 45°	R4D	
CC	-	22x22	1050	0.05	-	25	SEE DWGS	1/2", 45°	R4D	
DD	-	18x12	900	0.05	-	25	SEE DWGS	1/2", 45°	R4D	

.. SET MINIMUM TO 50% OF MAXIMUM, CONTROL FROM T'STAT ON WALL

GAS UNIT HEATER PERFORMANCE SCHEDULE												
TAG	INPUT (MBH)	OUTPUT (MBH)	THERMAL EFF. %	AIRFLOW (CFM)	FUEL	ELECTRICAL REQUIREMENTS				BASIS OF DESIGN - REZNR		
						HP	FLA	MOCP	V/PH/Hz	SERVICE	ARRANGEMENT	MODEL
UH-1	60.0	49.0	82.0	763	NAT GAS	1/6	3.3	15.0	115/1/60	FUTURE OFFICES	HORIZONTAL	UDAS-60

PLUMBING FIXTURE CONNECTION SCHEDULE					
TAG	DESCRIPTION	SAN	VENT	CW	HW
P-4	ADA SINGLE BOWL SS SINK	1-1/2"	1-1/2"	1/2"	1/2"
P-4A	DOUBLE BOWL SS SINK	1-1/2"	1-1/2"	1/2"	1/2"

MINIMUM SIZE OF BELOW SLAB SANITARY 4 VENT PIPING SHALL BE 2".

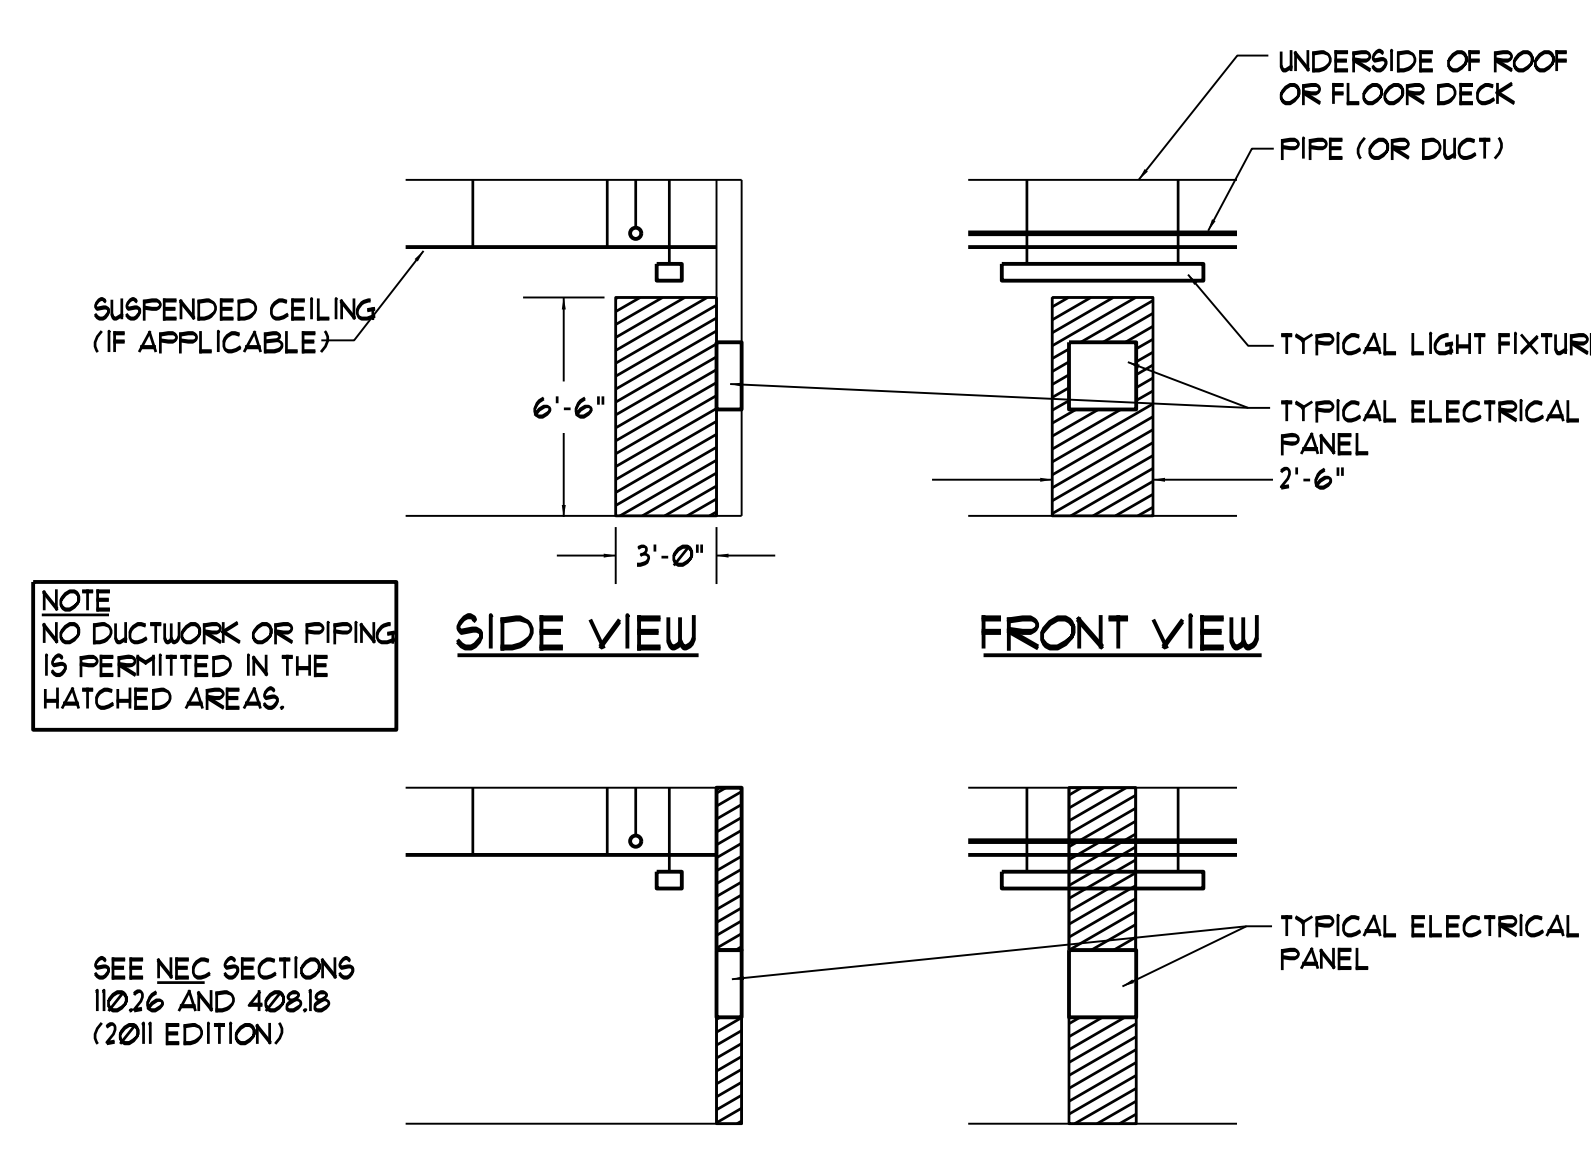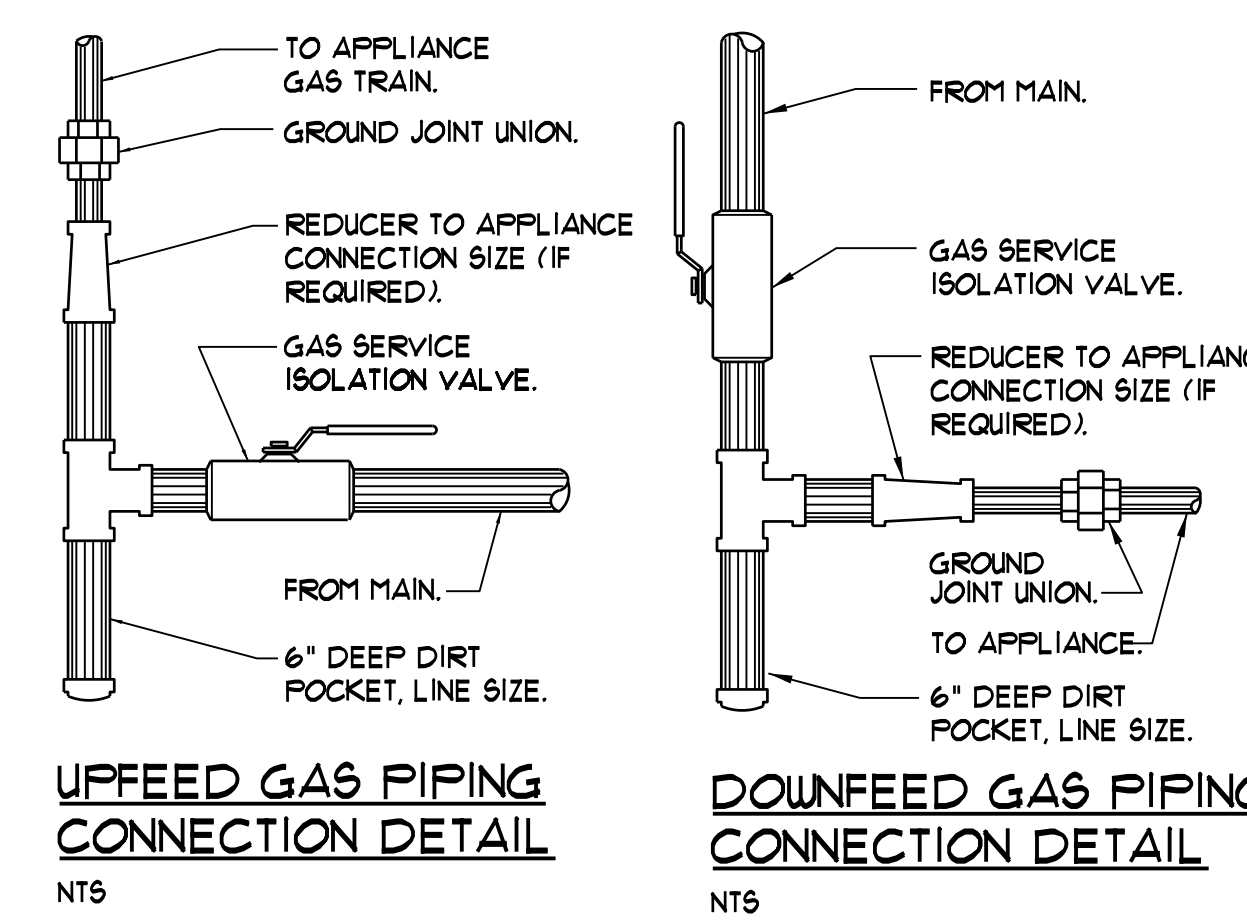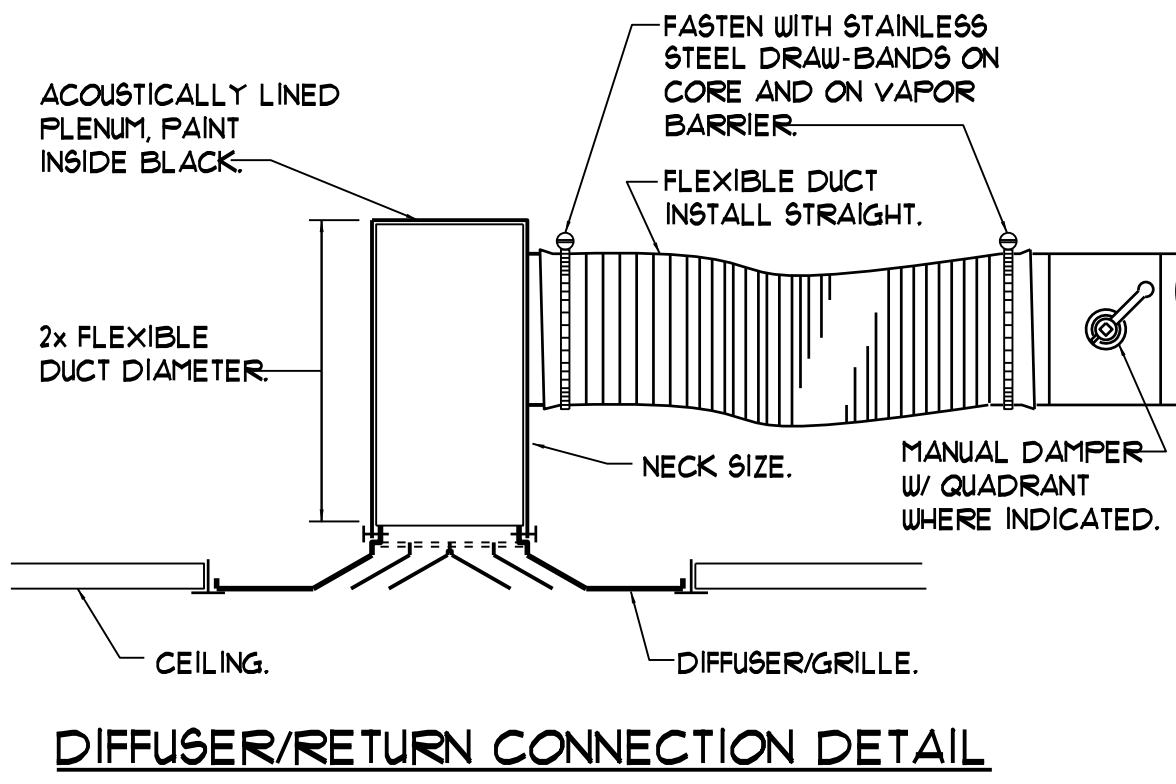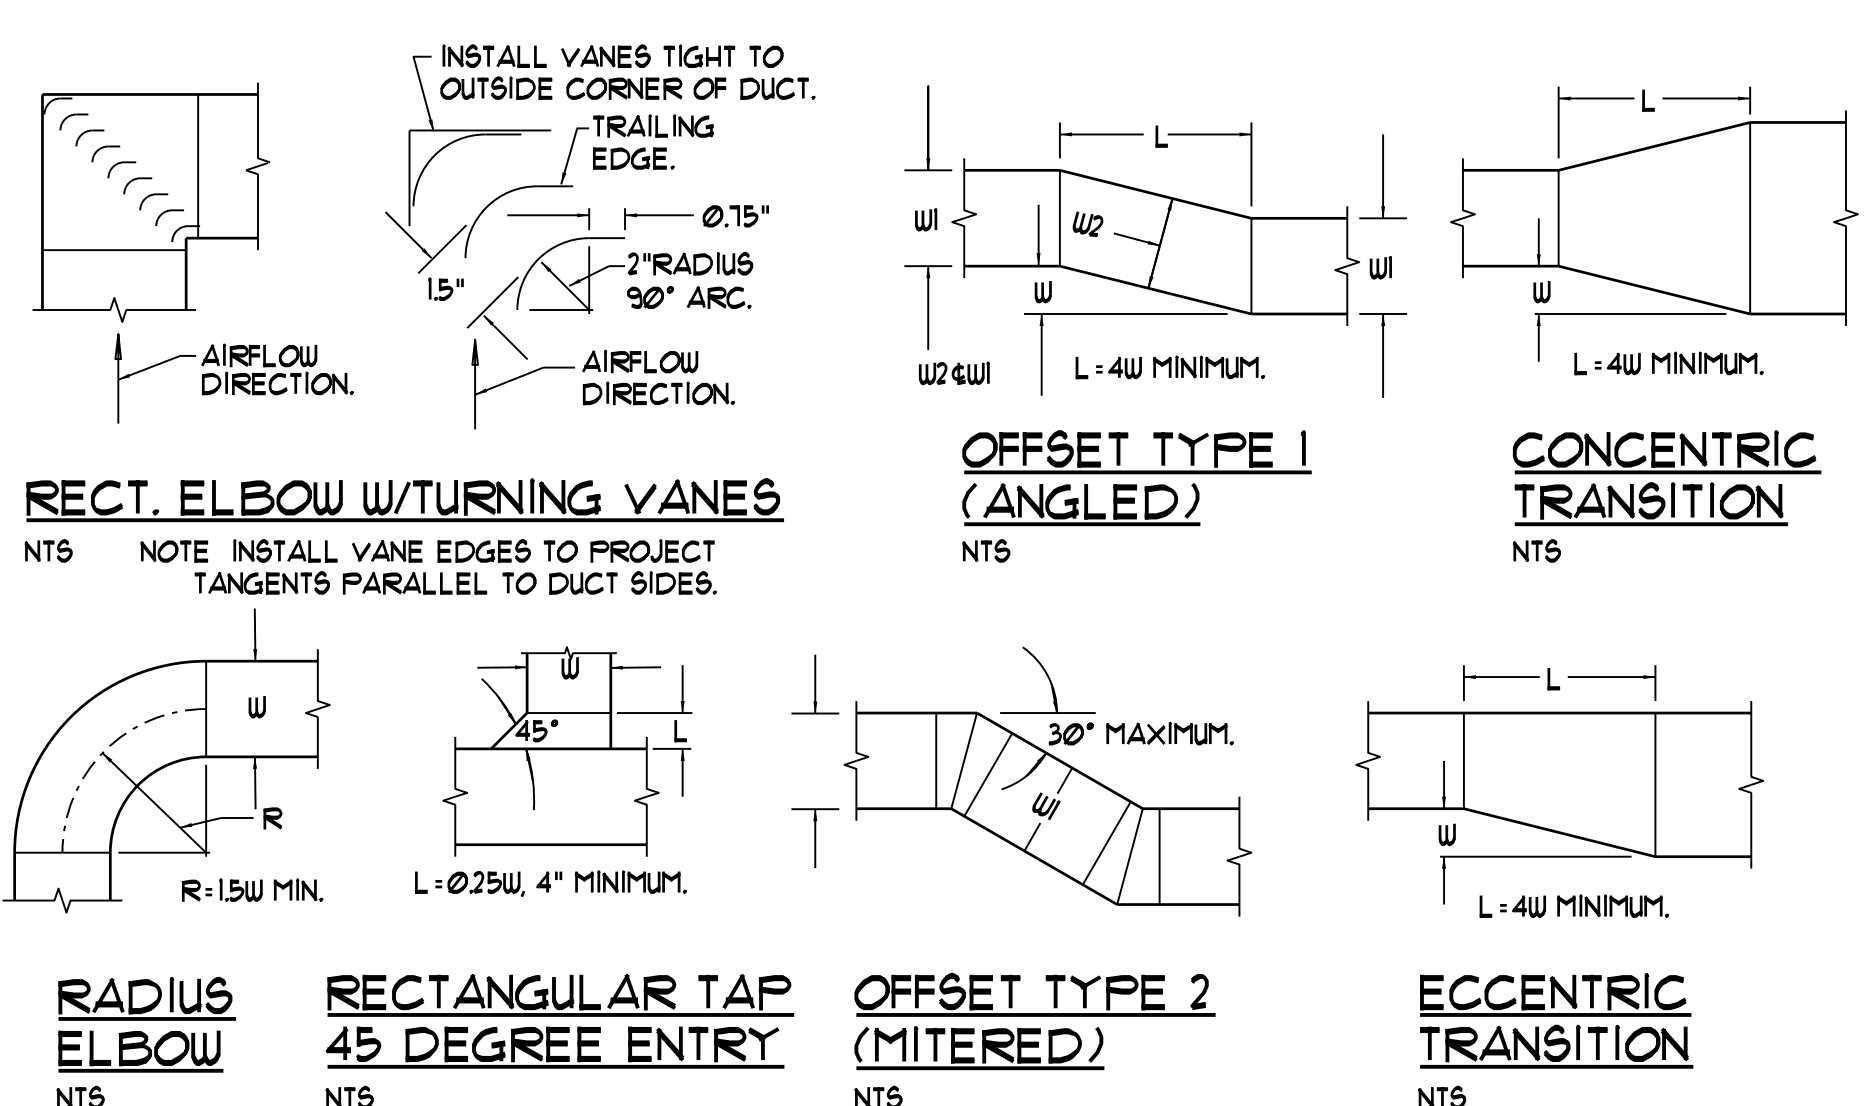

MECHANICAL AND PLUMBING SYMBOLS AND ABBREVIATIONS LEGEND

NOTE - USE SYMBOLS AND ABBREVIATIONS AS APPLICABLE FOR THIS MECHANICAL DRAWING SET. SOME SYMBOLS AND ABBREVIATIONS IN THIS LEGEND MAY NOT APPLY.

SYMBOL	DESCRIPTION	SYMBOL	DESCRIPTION	SYMBOL	DESCRIPTION	ABBREVIATION	DESCRIPTION	ABBREVIATION	DESCRIPTION	ABBREVIATION	DESCRIPTION	ABBREVIATION	DESCRIPTION
CA	COMPRESSED AIR PIPING (CA)	⊘	BACKFLOW PREVENTER (BFP)	⊘	PRESSURE GAGE WITH GAGE COCK	AAV	AUTOMATIC AIR VENT	EDB	ENTERING DRY BULB	I-B-R	INSTITUTE OF BOILER AND RADIATOR MANUFACTURERS	RLA	RUNNING LOAD AMPS
C	CONDENSATE DRAIN PIPING (C)	⊘	CHECK VALVE	⊘	THERMOMETER IN WELL	AD	ACCESS DOOR	EDC	ELECTRIC DUCT COIL TAG	IN	INCHES	RPM	REVOLUTIONS PER MINUTE
CTR	COOLING TOWER RETURN PIPING (CTR)	⊘	BALANCING VALVE (ADJUSTABLE)	⊘	WATER FLOW SWITCH	AFF	ABOVE FINISHED FLOOR	EER	ENERGY EFFICIENCY RATIO	L	LOUVER TAG	RPS	REVOLUTIONS PER SECOND
CTS	COOLING TOWER SUPPLY PIPING (CTS)	⊘	AUTOMATIC FLOW CONTROL VALVE	⊘	PRESSURE SWITCH OR SENSOR	AHU	AIR HANDLING UNIT TAG	EF	EXHAUST FAN TAG	L*	LEAVING AIR TEMPERATURE	RPZ	REDUCED PRESSURE ZONE
CWR	CHILLED WATER RETURN PIPING (CWR)	⊘	RELIEF VALVE (RV)	⊘	ENHURSION TEMPERATURE SENSOR	AMS	AIRFLOW MONITORING STATION	EFF	EFFICIENCY	LAT	LOOP WATER SUPPLY/RETURN	RTU	ROOM TEMPERATURE SENSOR
CWS	CHILLED WATER SUPPLY PIPING (CWS)	⊘	BALL VALVE	⊘	DUCT MOUNTED SMOKE DETECTOR	AMPS	AMPERES	ESP	EXTERNAL STATIC PRESSURE	LB	POUNDS	RV	RELIEF VALVE
FOR	FUEL OIL RETURN PIPING (FOR)	⊘	3/4" BALL VALVE WITH 3/4" HOSE END	⊘	ROOM TEMPERATURE SENSOR	AP	ACCESS PANEL	ET	EXPANSION TANK TAG	LWS/R	LOOP WATER SUPPLY/RETURN	RUL	RAINWATER LEADER
FOS	FUEL OIL SUPPLY PIPING (FOS)	⊘	GATE VALVE	⊘	THERMOSTAT OR SENSOR ON WALL	AFD	AIR PRESSURE DROP	EUB	ENTERING WET BULB	LRA	LOCKED ROTOR AMPS	SA	SUPPLY AIR
G	GAS PIPING (G)	⊘	PRESSURE REDUCING VALVE	⊘	TSTAT OR SENSOR W/ TAMPERPROOF GUARD	AS	AIR SEPARATOR TAG	EWH	ELECTRIC WATER HEATER TAG	LWCO	LOW WATER CUTOFF	SAN	SANITARY (DRAIN & WASTE)
HWR	HOT WATER RETURN PIPING (HWR)	⊘	RUBBLE VALVE	⊘	MANUAL AIR VENT	ATC	AUTOMATIC TEMPERATURE CONTROL	EWT	ENTERING WATER TEMPERATURE	LWT	LEAVING WATER TEMPERATURE	SD	SMOKE DAMPER
HWS	HOT WATER SUPPLY PIPING (HWS)	⊘	STRAINER W/ BLOWDOWN BALL VALVE	⊘	NOTE TAG (NUMBER)	BD	BYPASS DAMPER TAG	EXG	EXISTING	MAX	MAXIMUM	SEER	SEASONAL ENERGY EFFICIENCY RATIO
RL	REFRIGERANT LIQUID PIPING (RL)	⊘	2-WAY CONTROL VALVE	⊘	AIR DEVICE TAG (LETTER) WITH CFM	BFP	BACKFLOW PREVENTER TAG	EXH	EXHAUST	MBH	THOUSANDS OF BTU PER HOUR	SF	SUPPLY FAN
RG	REFRIGERANT GAS PIPING (RG)	⊘	SOLENOID VALVE	⊘	ROOM NUMBER	BHP	BRAKE HORSEPOWER	FC	FLEXIBLE CONNECTION	MCA	MINIMUM CIRCUIT AMPACITY	SP	STATIC PRESSURE
SBF	SANITARY PIPING BELOW FLOOR (SBF)	⊘	3-WAY CONTROL VALVE	⊘	TURNING VANES	BTUH	BRITISH THERMAL UNITS PER HOUR	FCO	FLOOR CLEANOUT	MIN	MINIMUM	SQFT	SQUARE FEET
SBAF	SANITARY PIPING ABOVE FLOOR (SBAF)	⊘	3-WAY CONTROL VALVE (TOP VIEW)	⊘	DUCT W/MANUAL DAMPER	CC	COOLING COIL TAG	FD	FIRE DAMPER	NC	NOISE CRITERION	ΔT	TEMPERATURE DIFFERENTIAL
SV	SANITARY VENT PIPING	⊘	4-WAY CONTROL VALVE (TOP VIEW)	⊘	DUCT W/FLEXIBLE CONNECTION (FC)	CFM	CUBIC FEET PER MINUTE	FD*	FLOOR DRAIN TAG	NIC	NOT IN CONTRACT	TEMP.	TEMPERATURE
RWL	RAINWATER LEADER ABOVE SLAB (RWL)	⊘	2 BUTTERFLY VALVES W/SINGLE ACTUATOR	⊘	LAGGED DUCT	CO	CLEANOUT	FLA	FULL LOAD AMPS	NTS	NOT TO SCALE	TEMP.	TEMPERATURE CONTROL PANEL
CW	COLD WATER PIPING (CW)	⊘	BUTTERFLY VALVE W/ACTUATOR	⊘	DUCT W/ACOUSTIC LINING	CF*	CIRCULATING PUMP TAG	FPB	FROST PROOF HOSE BIBB	OA	OUTSIDE AIR	TMV*	THERMOSTATIC MIXING VALVE TAG
HW	HOT WATER PIPING (HW)	⊘	TRIPLE-DUCT VALVE	⊘	DUCT W/SQUARE-TO-ROUND TRANSITION	Cv	VALVE COEFFICIENT	FFM	FEET PER MINUTE	OBD	OPPOSED BLADE DAMPER	TSP	TOTAL STATIC PRESSURE
RHW	RECIRCULATED HOT WATER PIPING (RHW)	⊘	UNION	⊘	FLEXIBLE DUCT	CW	COLD WATER	FSD	COMBINATION FIRE & SMOKE DAMPER	O.D.	OUTSIDE DIAMETER	TYP	TYPICAL
PC	PIPE CAP	⊘	PUMP WITH FLANGES	⊘	MOTOR OPERATED DAMPER	DB	DRY BULB	FT	FEET	OED	OPEN ENDED DUCT	UH*	UNIT HEATER TAG
DF	DIRECTION OF FLUID FLOW	⊘	CARTRIDGE TYPE INLINE PUMP	⊘	AIRFLOW OUT	dB RE	DECIBELS RELATIVE TO	GA	GAGE	OPD	OVERCURRENT PROTECTIVE DEVICE	VB	VACUUM BREAKER
EU	ELBOW UP	⊘	VERTICAL INLINE PUMP	⊘	AIRFLOW IN	DC	DOUBLE CHECK	GAL	GALLONS	PF*	PLUMBING FIXTURE TAG	VFD	VARIABLE FREQUENCY INVERTER DRIVE
ED	ELBOW DOWN	⊘	BASE MOUNTED PUMP	⊘	DIAMETER OR FLAT OVAL	DCA	DOUBLE CHECK ATMOSPHERIC	GPH	GALLONS PER HOUR	PENETN	PENETRATION	VTR	VENT THRU ROOF
TE	PIPE TEE UP	⊘	VERTICAL GATE VALVE	⊘	FIRE DAMPER	DEG F	DEGREES FAHRENHEIT	GPM	GALLONS PER MINUTE	FF*	FADDLE FAN TAG	V/PH/Hz	VOLTS/PHASES/HERTZ
TD	PIPE TEE DOWN	⊘	REDUCER	⊘	ROUND OR FLAT OVAL DUCT DOWN	DIA	DIAMETER	HC*	HEATING COIL TAG	PSIA	POUNDS PER SQUARE INCH ABSOLUTE	WB	WET BULB
RD	PIPE REDUCER	⊘	FLEXIBLE PIPE CONNECTION (FC)	⊘	ROUND OR FLAT OVAL DUCT UP	DIW	DOWN IN WALL	HP	HORSEPOWER	PSIG	POUNDS PER SQUARE INCH GAGE	WCO	WALL CLEANOUT
WG	PIPE WITH GUIDE	⊘	PITCH DOWN	⊘	SUPPLY DIFFUSER	DN	DOWN	HRV*	HEAT RECOVERY VENTILATOR TAG	PVC	POLYVINYL CHLORIDE (PIPE)	UG	WATER GAGE
WA	PIPE WITH ANCHOR	⊘	PETCOCK	⊘	RETURN GRILLE	EA	EXHAUST AIR	HW	HOT WATER	RA	RETURN AIR	WPD	WATER PRESSURE DROP
BV	BUTTERFLY VALVE	⊘		⊘	STEAM TRAP	EA	ENTERING AIR TEMPERATURE	HWS/R	HOT WATER SUPPLY AND RETURN	RD	ROOF DRAIN	USA	WIRE SIZING AMPS
OS	O S Y GATE VALVE	⊘		⊘	WATER HAMMER ARRESTOR	EAT				RDE	RECOMMENDED DUAL ELEMENT FUSE AMPS	WTD	WATER TEMPERATURE DROP
		⊘		⊘						RHW	RECIRCULATED HOT WATER	W	WITH

CWS ARCHITECTS

DESIGNER

OWNER

PROJECT

DRAWING

REVISIONS

DRAWING NUMBER

M3.11

SCALE: 1/8" = 1'-0"
DATE: 04/17/15

UNITIL

NORTHERN UTILITIES, INC. FIT-UP

MECHANICAL SCHEDULES AND LEGEND

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