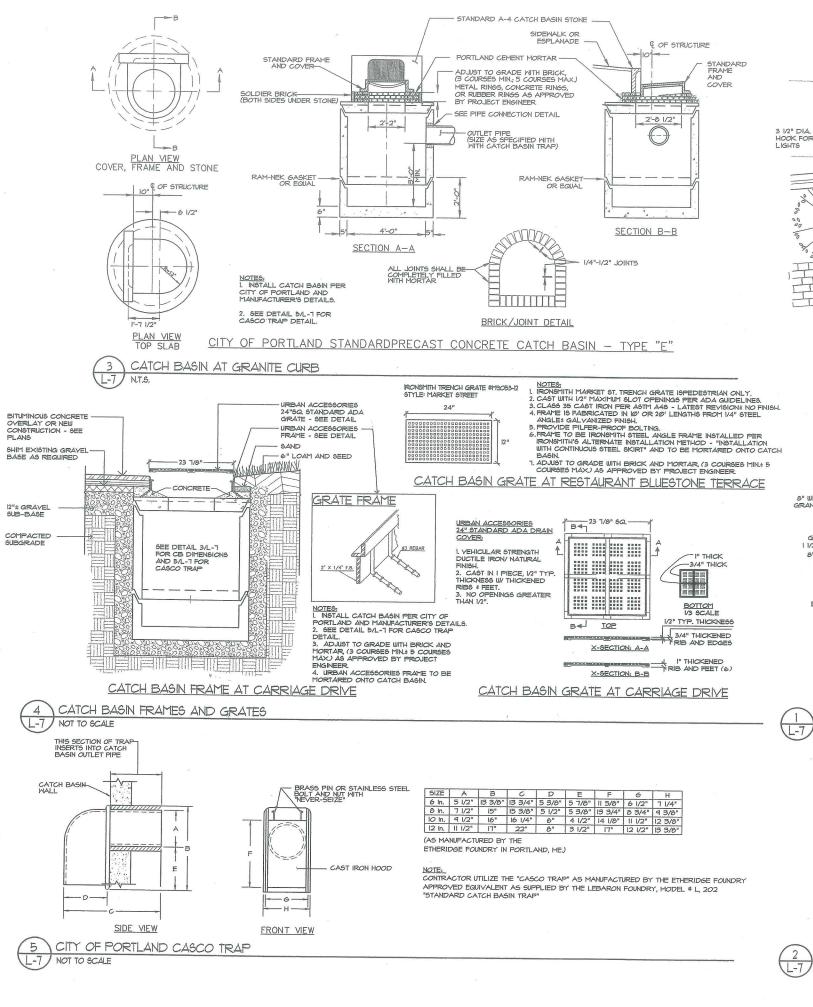
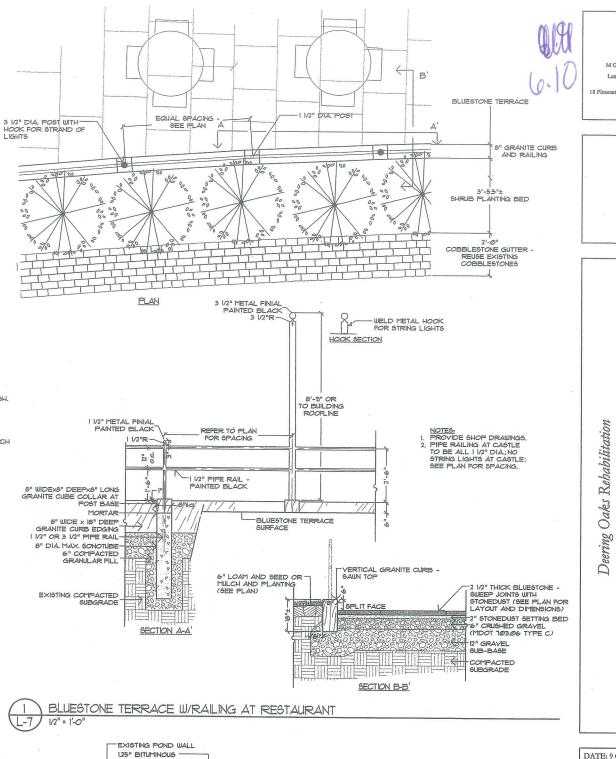
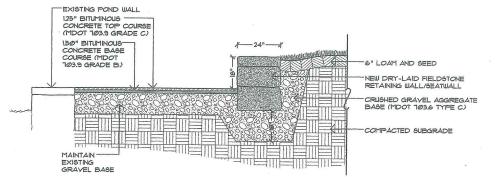
354-B.a. 1998-0136 430 Riverside Ind. Pkway Bld. Addition Unifirst

on Spreadslett







POND SEATING WALL AND PATH 1/2" = 1'-0"

DATE: 9 OCTOBER 2001 SCALE: N.T.S. DRAWN BY: TS/EG REVISIONS:

MORE SEREDII

GROUNDS

SURROUNDING

AND

ASTLE

CITY OF PORTLAND PORTLAND, MAINE

TITLE: SITE **DETAILS**

SHEET:

PROJECT PARCEL SITE PORTLAND ASSESSOR'S MAP & LOT NUMBERS

BLOCK LOT 354 В

Owner & Applicant

UNIFIRST CORPORATION PORTLAND, ME 04103

NOTES

GENERAL NOTES

- EXISTING CONDITIONS INFORMATION FOR THE PROPERTY WAS PROVIDED FROM SURVEY PERFORMED BY TITCOMB ASSOCIATES, INC. OF FALMOUTH, MAINE DATED APRIL 24, 2006.
- 2. THE CONTRACTOR IS SPECIFICALLY CAUTIONED THAT THE LOCATION THE CONTRACTOR IS SPECIFICALLY CAUTIONED THAT THE LOCATION AND/OR THE ELEVATION OF THE EXISTING UTILITIES AS SHOWN ON THESE PLANS IS BASED ON RECORDS OF THE VARIOUS UTILITY COMPANIES AND WHERE POSSIBLE MEASUREMENTS TAKEN IN THE FIELD. THIS INFORMATION IS NOT TO BE RELIED ON AS BEING EXACT OR COMPLETE. THE CONTRACTOR MUST CALL THE APPROPRIATE UTILITY COMPANY AND DIG SAFE AT LEAST 72 HOURS PRIOR TO ANY EXCAVATION OF REQUEST EXACT FIELD LOCATION OF UTILITIES. IT SHALL BE THE RESPONSIBILITY OF THE CONTRACTOR TO RELOCATE ALL EXISTING UTILITIES WHICH CONFIDENCE THE PROPOSED IMPROVEMENTS SHOWN ON THE PLANS.
- 3. MAINTENANCE OF EROSION CONTROL MEASURES IS OF PARAMOUNT
- 4. ALL MATERIAL SCHEDULES SHOWN ON THE PLANS ARE FOR GENERAL INFORMATION ONLY. THE CONTRACTOR SHALL PREPARE HIS OWN MATERIAL SCHEDULES BASED UPON HIS PLAN REVIEW. ALL SCHEDULES SHALL BE WERRIED IN THE FIELD BY THE CONTRACTOR PRIOR TO ORDERING MATERIALS OR PERFORMING WORK.
- 5. ALL MATERIALS AND CONSTRUCTION METHODS SHALL CONFORM TO THE CITY PORTLAND TECHNICAL STANDARDS AND SPECIFICATIONS, MAINE DEPARTMENT OF TRANSPORTATION SPECIFICATIONS AND THE SPECIFICATIONS ATTACHED TO THE PROJECT DOCUMENTS.
- THE CONTRACTOR SHALL PROVIDE, ERECT AND MAINTAIN ALL NECESSARY BARRICADES, LIGHTS, WARNING SIGNS AND OTHER DEVICES TO SAFEGUARD TRAFFIC PROPERLY WHILE WORK IS IN PROGRESS FOR THE DURATION OF THE PROJECT.

PERMITTING NOTES

- 1. THIS PROJECT IS SUBJECT TO THE TERMS AND CONDITIONS OF A SITE PLAN REVIEW PERMIT FROM THE CITY OF PORTLAND WHICH WILL BE MADE A PART OF THE CONTRACT BID DOCUMENTS. THE CONSTRUCTION WILL BE GOVERNED BY THE ZONING ORDINANCES WHICH ARE AVAILABLE FOR VIEWING AT THE OFFICE OF THE ENGINEER OR THE MUNICIPAL OFFICE.
- THE CONTRACTOR SHALL REVIEW THE ABOVE REFERENCED PERMITS PRIOR TO SUBMITTING A BID FOR THIS PROJECT, AND INCLUDE COSTS AS NECESSARY TO COMPLY WITH THE CONDITIONS OF THESE PERMITS.

LAYOUT NOTES

- 1. ALL DIMENSIONING, UNLESS NOTED OTHERWISE, IS TO THE FACE OF CURB OR BUILDING.
- PROPERTY LINE AND R.O.W. MONUMENTS SHALL NOT BE DISTURBED BY CONSTRUCTION. IF DISTURBED, THEY SHALL BE RESET TO THEIR ORIGINAL LOCATIONS AT THE CONTRACTOR'S EXPENSE, BY A MAINE REGISTERED LAND SURVEYOR.

SITE PLANS FOR UNIFIRST SITE EXPANSION PORTLAND, MAINE

PERMITS

STATUS

SITE PLAN REVIEW APPLICATION

EXISTING

CITY OF PORTLAND

SUBMITTED 7/21/06

C001

C100

INDEX

COVER SHEET, GENERAL NOTES & LEGEND EXISTING CONDITIONS SURVEY (BY TITCOMB ASSOCIATES, INC.) SITE LAYOUT AND UTILITY PLAN GRADING, DRAINAGE AND EROSION CONTROL PLAN

LOCATION MAP

C101 C102 PHOTOMETRIC PLAN

C400 SITE AND DRAINAGE DETAILS C401 EROSION AND SEDIMENTATION CONTROL DETAILS & NOTES LANDSCAPE PLAN (BY MITCHELL & ASSOCIATES, INC.) L101

UTILITIES

PORTLAND WATER DISTRICT 225 DOUGLASS STREET PORTLAND, MAINE 04102 (207) 761-8300

SEWER:

PORTLAND PUBLIC WORKS DEPT. 55 PORTLAND STREET PORTLAND, MAINE 04101

CENTRAL MAINE POWER 162 CANCO ROAD PORTLAND, MAINE 04103 (207) 826-2869

TELEPHONE:

VERIZON 5 DAVIS FARM ROAD PORTLAND, MAINE 04103 (207) 797-1842

CABLE:

TIME WARNER CABLE 118 JOHNSON ROAD PORTLAND, MAINE 04102 (207) 775-3431

CALL BEFORE YOU DIG 1-888-344-7233



Drawing No.

C001

GRADING AND DRAINAGE NOTES

- TOPSOIL STRIPPED IN AREAS OF CONSTRUCTION THAT IS SUITABLE FOR REUSE AS LOAM SHALL BE STOCKPILED ON SITE AT A LOCATION TO BE DESIGNATED BY THE OWNER. UNSUITABLE SOIL SHALL BE SEPARATED, REMOVED AND DISPOSED OF AT AN APPROVED DISPOSAL LOCATION OFF SITE.
- 2. THE CONTRACTOR SHALL ANTICIPATE THAT GROUNDWATER WILL BE ENCOUNTERED DURING CONSTRUCTION AND SHALL INCLUDE SUFFICIENT COSTS WITHIN THEIR BID TO PROVIDE DEWATERING AS NECESSARY. NO SEPARATE PAYMENT SHALL BE MADE TO THE CONTRACTOR FOR DEWATERING.

EROSION CONTROL NOTES

- PRIOR TO BEGINNING ANY CLEARING/LAND DISTURBING ACTIVITIES, THE CONTRACTOR SHALL INSTALL THE PERIMETER SILT FENCES AND THE CONSTRUCTION ENTRANCES.
- ALL GROUND AREAS GRADED FOR CONSTRUCTION WILL BE GRADED, LOAMED AND SEEDED AS SOON AS POSSIBLE. PERMANENT SEED MIXTURE SHALL CONFORM TO THE SEEDING PLAN CONTAINED IN THE EROSION CONTROL REPORT PREPARED FOR THIS PROJECT.
- 4. PRIOR TO PAVING, THE CONTRACTOR SHALL FLUSH SILT FROM ALL STORM DRAIN LINES. SILT SHALL NOT BE FLUSHED INTO THE MUNICIPAL INFRASTRUCTURE.
- SILT FENCES SHALL BE INSPECTED, REPAIRED AND CLEANED AS NOTED IN THE EROSION CONTROL REPORT.
- 6. THE CONTRACTOR SHALL REPAIR AND ADD STONE TO THE CONSTRUCTION ENTRANCES AS THEY BECOME SATURATED WITH MUD TO ENSURE THAT THEY WORK AS PLANNED DURING CONSTRUCTION.
- SILT REMOVED FROM AROUND INLETS AND BEHIND THE SILT FENCES SHALL BE PLACED ON A TOPSOIL STOCKPILE AND MIXED INTO IT FOR LATER USE IN LANDSCAPING OPERATIONS.
- 8. A FULL EROSION CONTROL PLAN ACCOMPANIES THIS PLAN SET AND IS CONTAINED ON DRAWING C101 OF THIS PLAN SET.
- 9. THE MAINTENANCE SCHEDULE FOR THE CATCH BASIN SEDIMENT SUMPS THE MANIEMANCE SCHEDULE FOR THE CATCH BASIN SEDIMENT SUM'S IS AS FOLLOWS SHALL BE INSPECTED IN APRIL AND OCTOBER OF THESE DEVICES SHALL BE INSPECTED IN APRIL AND OCTOBER OF THE SEDIMENT SHALL BE REMOVED FROM THE CATCH BASIN WHEN THE DEPTH OF THE SEDIMENT IS GREATER THAN ONE FOOT. THE SEDIMENT WILL BE REMOVED FROM THE SITE OF THE OWNER OR THE CATCH BASIN SELECTION OF THE CONTROL OF THE SEDIMENT OF THE APPLICATIONS.
- 10. THE CONTRACTOR IS CAUTIONED THAT FAILURE TO COMPLY WITH THE THE CONTRACTOR IS CAUTIONED THAT FAILURE TO COMPLY WITH I SEQUENCE OF CONSTRUCTION, EROSION/SEDIMENT CONTROL PLAN, AND OTHER PERMIT REQUIREMENTS MAY RESULT IN MONETARY PENALTIES. THE CONTRACTOR SHALL BE ASSESSED ALL SUCH PENALTIES AT NO COST TO THE OWNER OR PERMITTEE.
- 11. ALL NON-PAVED AREAS DISTURBED DURING CONSTRUCTION SHALL BE LOAMED AND SEEDED, UNLESS OTHERWISE DIRECTED BY THE OWNER.
- 12. SEE SHEET C401 FOR FULL EROSION AND SEDIMENTATION CONTROL

TYPE OF PERMIT

GOVERNING BODY

LEGEND DESCRIPTION PROPOSED

100

100.31

(x) (x)

○-D

CHE/T/C

UGE/T/C

PROPERTY LINE PARKING SETBACK

. WETLAND BOUNDARY ----- EDGE OF PAVEMENT GRADING CONTOUR LINE SPOT ELEVATION

TREELINE 0 * 0 TREES & HEDGES ń POLE WITH LIGHT FIXTURE(S) 0 UTILITY POLE ____ FREESTANDING SIGN

OVERHEAD ELECTRIC/TELEPHONE/CABLE UNDERGROUND ELECTRIC/TELEPHONE/CABLE WATER LINE

STORM DRAIN LINE CHIVERT HYDRANT WATER GATE VALVE MANHOLE CATCH BASIN TEST PIT

IRON ROD (SET) 0 IRON ROD (FOUND) MONUMENT


SILT FENCE STONE SEDIMENT BARRIER CENTER LINE


数数 0

- - - - FENCE RETAINING WALL

REVISED PER STAFF COMMENTS SITE PLAN REVIEW APPLICATION

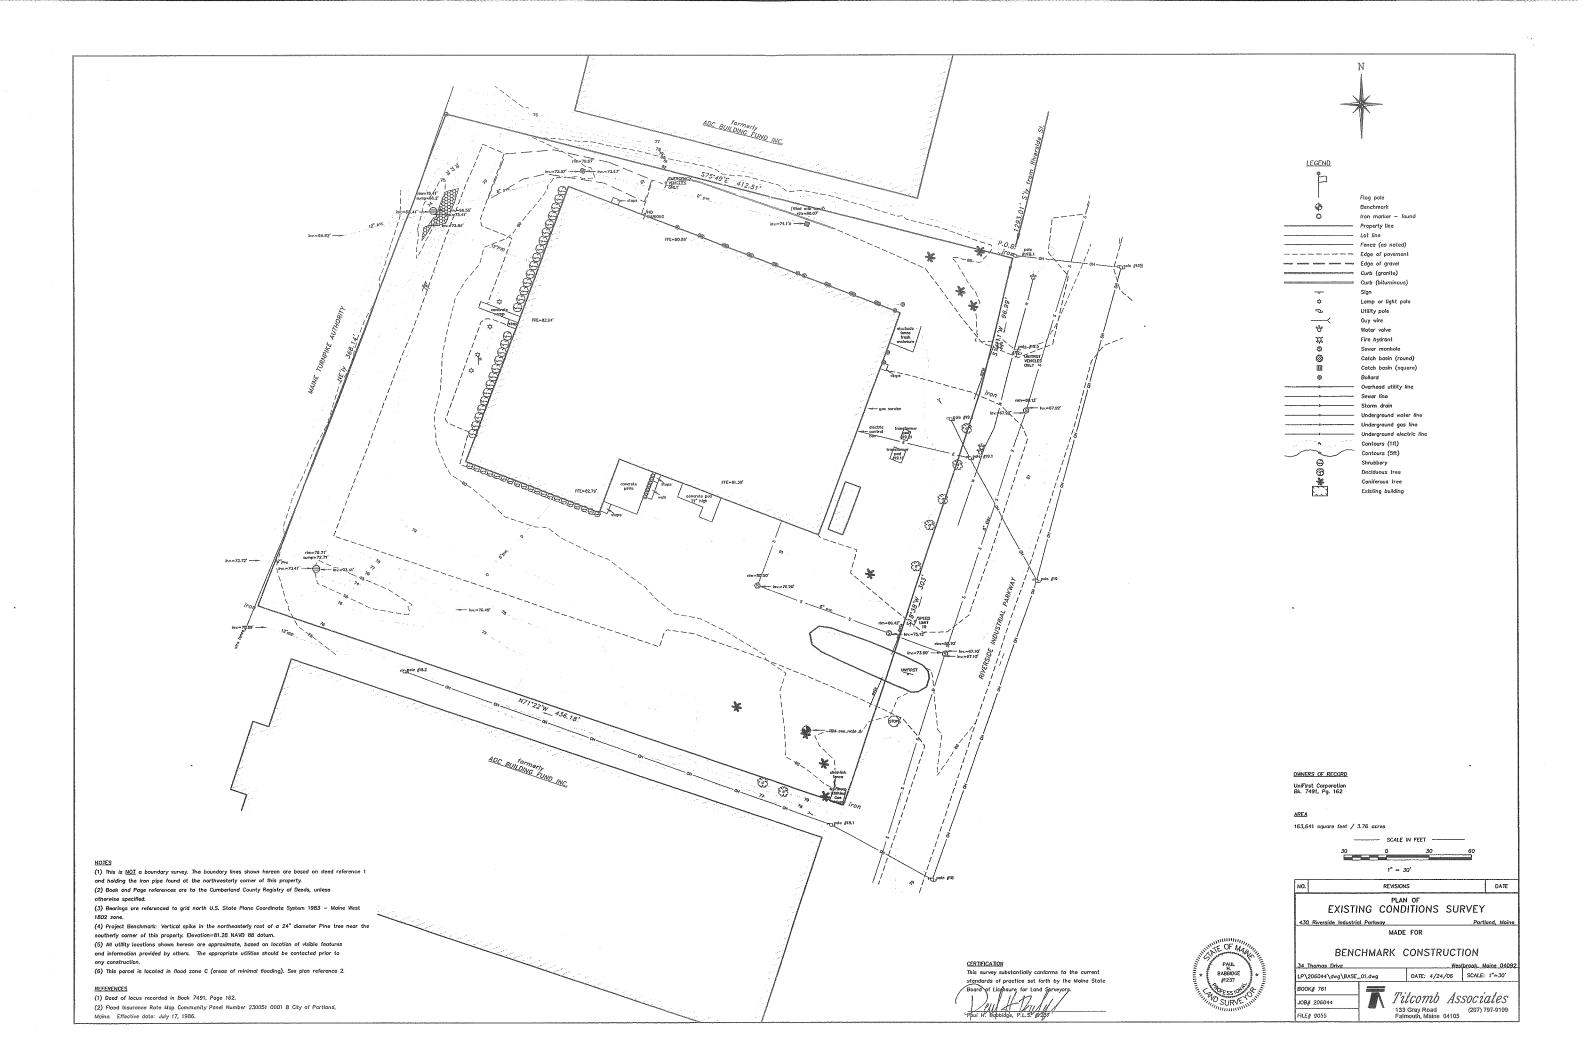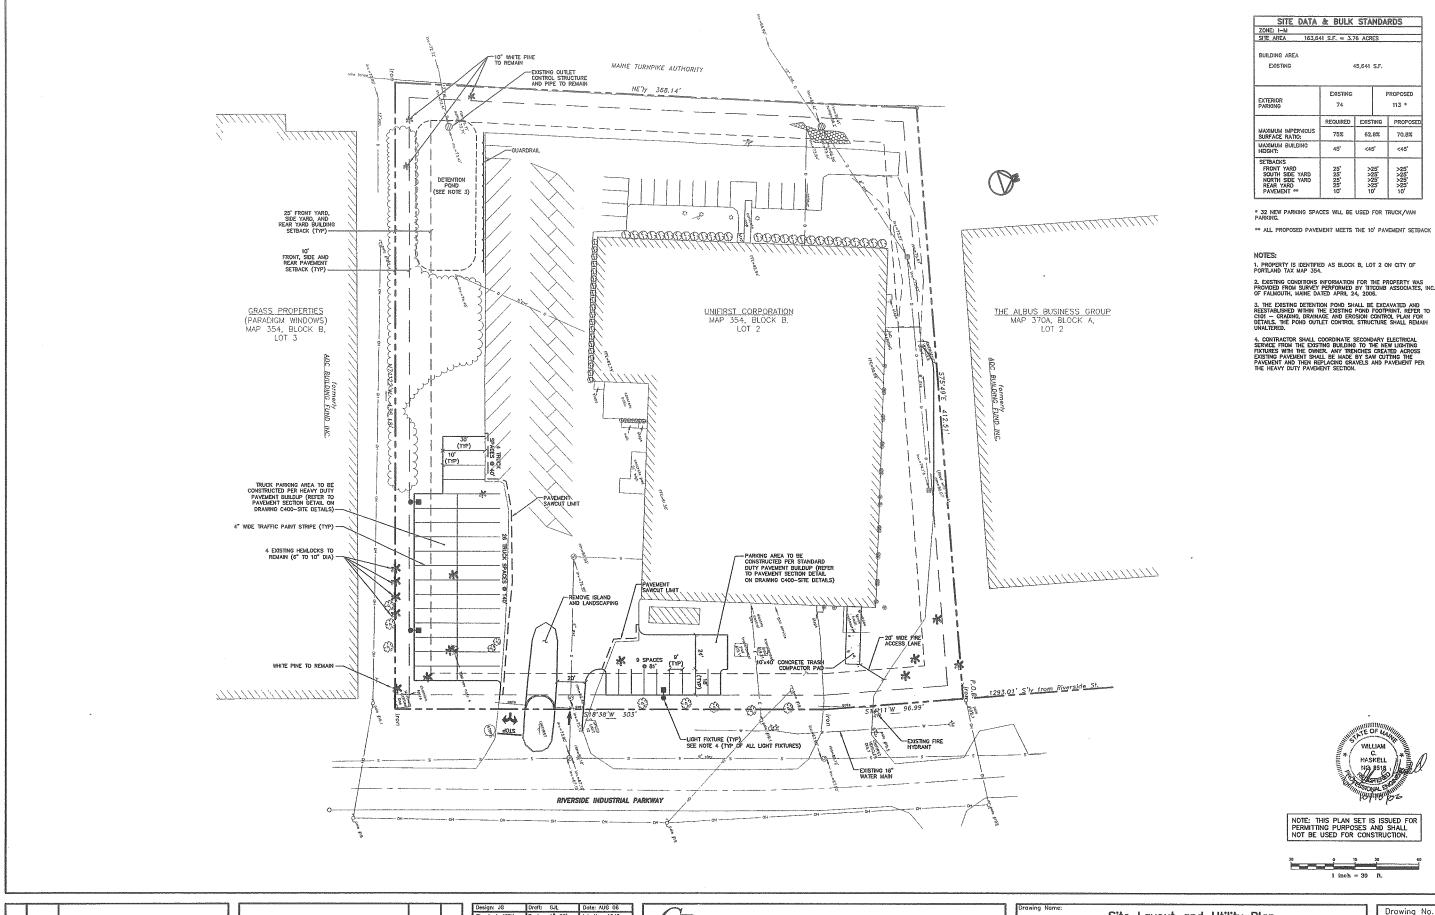NOTE: THIS PLAN SET IS ISSUED FOR PERMITTING PURPOSES AND SHALL NOT BE USED FOR CONSTRUCTION.





Rev. Date Revision

REVISED PER STAFF COMMENTS 10/10/06 WCH 8/14/06 WCH SITE PLAN REVIEW APPLICATION Date By Issued For

This plan shall not be modified without writte permission from Gorrill-Palmer Consulting Engineers, Inc.(GPCEI). Any alterations, authorized or otherwise, shall be at the user sole risk and without liability to GPCEI.

Gorrill-Palmer Consulting Engineers, Inc.

PO Box 1237 Traffic and Civil Engineering Services 207-657-6910
15 Shoker Road
Gray, ME 04039

Gray, ME 04039

Gray, ME 04039

Site Layout and Utility Plan UNIFIRST SITE EXPANSION

UNIFIRST CORPORATION
430 RIVERSIDE INDUSTRIAL PARKWAY, PORTLAND, ME 04103

Drawing No. C100

1. * DENOTES AN EXISTING GROUND ELEVATION OBTAINED FROM THE EXISTING CONDITIONS SURVEY BY TITCOMB ASSOCIATES, INC. DATED APRIL 24, 2006.

NOTE: THIS PLAN SET IS ISSUED FOR PERMITTING PURPOSES AND SHALL NOT BE USED FOR CONSTRUCTION.

REVISED PER STAFF COMMENTS	10/10/06	WCH
SITE PLAN REVIEW APPLICATION	8/14/06	WCH
Issued For	Date	Ву

Checked: WCH Scale: 1"≈30' Job No.: 1540
File Name: 1540_GRAD-EROS.dwg This plan shall not be modified without writter permission from Gorrill—Palmer Consulting Engineers, Inc.(GPCEI). Any alterations, authorized or otherwise, shall be at the user sole risk and without liability to GPCEI.

Gorrill-Palmer Consulting Engineers, Inc.

PO Box 1237 Traffic and Civil Engineering Services 207-657-6910
15 Shoker Road Gray, ME 04039

Gray, ME 04039

Gray, ME 04039


Grading, Drainage and Erosion Control Plan

UNIFIRST SITE EXPANSION

UNIFIRST CORPORATION 430 RIVERSIDE INDUSTRIAL PARKWAY, PORTLAND, ME 04103 C101

LUMINAIRE SCHEDULE									
Symbol	Label	Qty	Catalog Number	Description	Lamp	File	Lumens	LLF	Watts
Ċ	С	3	KVE2 250M R4SC	PREMIUM SQUARE AREA LIGHT WITH R4 DISTRIBUTION.	ONE 250-WATT CLEAR ED-28 METAL HALIDE, HORIZONTAL POSITION.	98100821.les	20000	1.00	297

LUMINAIRE LOCATIONS										
	***************************************		Location						Aim	
No.	Label	х	Υ	Z	MH	Orientation	Tilt	X	Υ	Z
1	C	91.0	186.3	20.0	20.0	87.4	0.0	95.0	186.5	0.0
2	С	95.0	96.6	20.0	20.0	87.8	0.0	98.0	95.8	0.0
3	С	272.6	57.5	20.0	20.0	-1,8	0,0	272.8	61,0	0.0

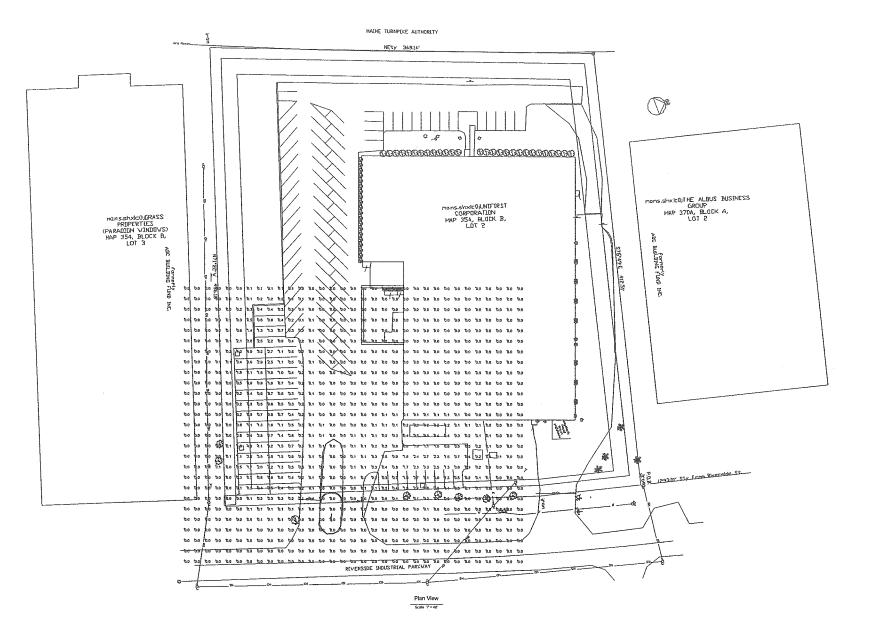



Unifirst Corporation Site Expansion

Designer WCH

Date

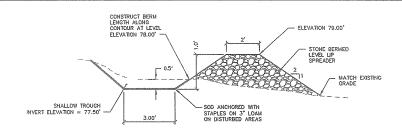
Aug 11 2006

Scale As Noted

Drawing No.

C102

s\1540\dwg\1540\light wch.DWG, Model, 10/6/2006 10:59:29 AM, 1:1.02224, GJL



BERM STO	NE SIZE
SIEVE DESIGNATION (US CUSTOMARY)	PERCENT BY WEIGHT PASSING
6 IN	100
3 IN	68-83
1 IN	42-55
NO. 4	8–12


STONE BERM LEVEL LIP SPREADER




NOTE: COMPACT SUBGRADE TO 95% MAXIMUM DRY DENSITY IN ACCORDANCE WITH ASTM D-1557 (MODIFIED PROCTOR)


	THICKNESS OF LAYERS	
STANDARD	LAYERS	HEAVY DUTY
1 1/4°	SURFACE COURSE MDOT 403.218 HOT MIX ASPHALT 3/8"	1 1/4"
1 3/4°	BINDER COURSE MOOT 403.207 HOT MIX ASPHALT 3/4"	2 3/4°
3"	BASE CRAVEL MOOT 703.06 TYPE A	3°
15"	SUBBASE GRAVEL MDDT 703.06 TYPE D	18°

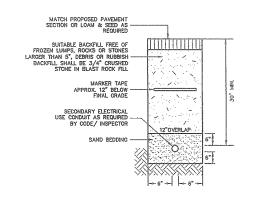
BITUMINOUS PAVEMENT SECTION




SECONDARY ELECTRICAL TRENCH

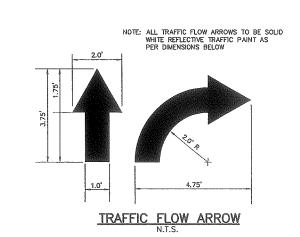

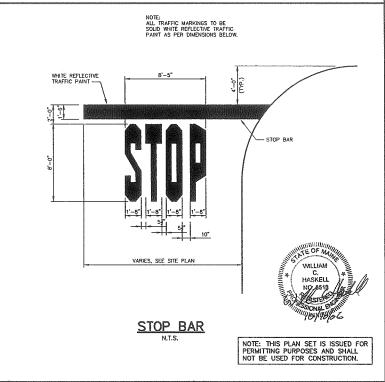

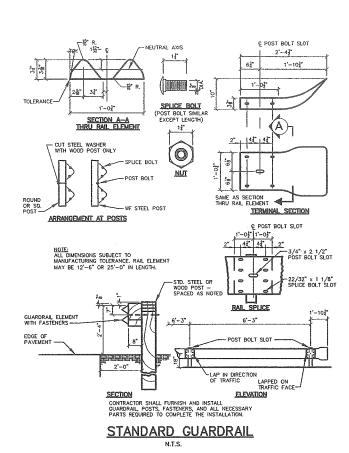

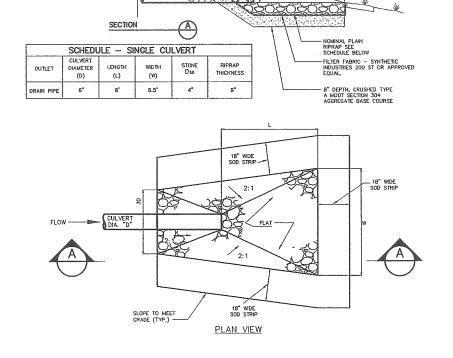

DRAIN PIPE OUTLET APRON

 	_	
Date	Revision	

REVISED PER STAFF COMMENTS	10/10/06	WCI
SITE PLAN REVIEW APPLICATION	8/14/06	WCI
Issued For	Date	By

Design: JG	Draft:	GJŁ	Date: AUG 06
Checked: WCH	Scale:	1"=30"	Job No.: 1540
File Name: 1540	_DET1.dw	9	,,,,,,,,,,,,,,,,,,,,,,,,,,,,,,,,,,,,,,,
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permission from	m Gorri	II-Palmei	r Consulting
Engineers, Inc.	(GPCEI).	. Any a	Iterations,
authorized or	otherwis	se, shall	be at the user
sole risk and	without	lightlify !	o GPCFI



	Site and Drainage Details
Project:	UNIFIRST SITE EXPANSION
Client:	UNIFIRST CORPORATION

Drawing No. C400

following temporary and permanent erosion and sediment control devices will be emented as part of the site development. These devices shall be installed as indicated

he plans or as described within this report. For further reference, see the Maine Erosion and Sediment Control Handbook for Construction: Best Management Practices.

A. Temporary Erosian Cantrol Measures

The following measures are planned as temporary erosion/sedimentation control measures during construction:

2. Siftation fence or wood waste compost berns shall be installed downstream of any disturbed areas to trap runoff borns sediments until adequate catch (90% or greater) has occurred. The shifteness and for the product of the pro

3. Straw or hay mulch including hydroseeding is intended to provide cover for denuided or seeded cross until revegetation is established. Mulch placed between April 15th and September 15th on slopes of less then 15 percent shall be onchored applying water; mulch placed on slopes of equal to or steeper than 15 percent shall be covered by a fabric natting and anchored with staples in accordance with manufacturer's recommendation. Mulch placed between September 15th and April 15th an slopes equal to or steeper than 8 percent shall be covered with a fabric

4. Temporary stockpiles of stumps, grubbings, or common excavation will be protected as follows:

- o) Temporary stackpiles shall not be located within 100 feet of any wetlands that are to be left undisturbed and any slopes exceeding 15%
- c) Stockpiles shall be surrounded by silt fence or wood-waste compost berms at the time of formation.

5. All denuded creas within 100 feet of an undisturbed wetland that have been rougraded and are not located within a roadway subbase area shall receive mulch or erosion control mesh fabric within 7 days of initial soil disturbance. All arceited within 50 feet of undisturbed wetland area shall be mulched prior to any predicter orin event regardless of the 7-day window. In other areas, the time period may be extended to 14 days. All disturbed areas located within 100 feet of a protected natural resource must be protected with a Couble row of sediment barriers.

6. For work conducted between September 15th and April 15th of any calendar year, of deruded areas will be covered with hay mulch applied at twice the normal application rote and anchored with fabric netting. The time period for applying mulch as noted in Paragraph I.A.5 shall be limited to 7 days for all areas.

Marginal Way and Preble Street Extension shall be swept to control off—tracking of mud, debris, and dust as necessary.

10. Wood waste compost/bark berms may be used in lieu of sittation fencing. Berms shall be removed and spread into a loyer not to exceed 3" thick once upstream areas ore completed and a 90% catch of vegetation is attained. Wood waste erasion tubes may also be used for perimeter sediment control or check dams, or to reduce slope lengths. These tubes may be created by filling Filtrexx mesh tubes or approved equivalent with wood waste material and staking the tube to the ground where the control is necessary.

Water shall be furnished and applied in accordance with MDOT specifications -Section 637 — Dust Control.

13. Loom and seed is intended to serve as the primary permanent revegetative for all denuded areas not provided with other erosion control measures such as riprap. Application rates are provided in Attachment A of this section. Seeding shall not occur over snow.

B. Permanent Erosion Control Measures

1. All oreos disturbed during construction but not subject to other restoration (building, powing, riprop, etc.) shall be loamed, firmed, fertilized, mulched, and seeded. Fobic netting anchored with stoples shall be ploced over the mulch in areas as noted in Poragraph I.A.3. All disturbed areas within 100 feet of an undisturbed wetland area shall be mulched prior to any practicat prior event regardless of the 7-day window. Notive topsall shall be etackpiled and reused for final restoration if deemed to be of sufficient quality.

II. Implementation Schedule

Note: For all grading activities, the contractor shall exercise extreme caution not to overexpose the site by limiting the disturbed area.

1. Install perimeter siltation fence and/or wood waste berms prior to grubbing respective

- 3. Remove existing povement within work limits.
- 5. Commence earthwork operations for proposed parking area and building foundation
- 6. Continue grading to subgrade as necessary.
- 7. Commence installation of underground utilities.

- 8. Complete remaining earthwork operations
- 9. Install subbase and base course gravels for driveways
- 11. Install surface course gravels for the driveways
- 12. Loam, lime, fertilize, seed, and mulch remaining disturbed greas.
- 13. Remove accumulated sediment from ahead of any sediment barriers as necessary.

15. Touch up loom and seed.

Note: All denuded areas not subject to final paying, riprop, or gravel shall be revegetated.

Prior to construction of the project, the contractor shall submit to the owner a schedule for the

The above construction sequence shall generally be completed in the specified order; however, several separate items may be constructed simultaneously. Work must also be scheduled or phased to prevent the extent of the above sequence is specified below. The intent of the above sequence is provide for sufficient evaluation for evaluation of the sequence such as still feace and construction entries in piece before large areas of land are demanded.

2. The work shall be conducted in sections which will:

a). Limit the amount of exposed area to those areas in which work is expected to be undertaken during the proceeding $30\,$ days.

b) Revegetate disturbed areas as rapidly as possible. All areas shall be permanently stabilized within 7 days of final grading or before a storm event, or temporarily stabilized within 7 days of initial disturbance of sall for oreas within 100 feet of an undisturbed wetland area and within 14 days for all other areas. Areas within 100 feet of an undisturbed wetland shall be mulched prior to any predicted rain event regardess of the 7-day window.

If a summer/foll construction achedule is not possible and construction is necessary between September 15th and April 15th of any colendar year, the contractor shall submit a schedule, which will satisfy the following critical

2. All disturbed areas shall be covered with mulch within 7 days of final grading. Mulch shall not be placed over snow.

a. If dormant seeding is used for the site, all disturbed areas shall receive 6° of loam and seed at an application rate of 5 lbs. per 1000 s.f. Seeding shall not occur over snow.

All areas seeded during the winter months shall be inspected in the spring for adequate catch. All areas insufficiently vegetated (less than 80% catch) shall be revegetated by replacing loam, seed, and mulch as necessary to achieve 80% catch. b. If dormant seeding is not used for the site, all disturbed areas shall be revegetated in the spring.

4. The area of denuded non-stabilized construction area shall be limited to the minimum area practicable. An area shall be considered denuded until the subbase grove is installed or the areas of future loom and seed have been loamed, seeded, and mulched at a rate twice that specified in the seeding plan (e.g. 115 lbs. per 1,000 s.f. \times 2 = 230 lbs. per 1,000 s.f.).

5. The above schedule shall be subject to the approval of the Owner.

The Contractor shall note that no areas within 100 feet of an undisturbed welland shall remain denuded for langer than 7 days before being temporarily stabilized. All other areas shall be stabilized within 14 days. For construction between September 15th and April 15th of any calendar year, all areas shall be temporarily stabilized within 7 days.

The following inspection and maintenance standards shall be required to insure the effectiveness of the erosion and sedimentation control measures are optimized during construction.

For further reference, see the Maine Department of Environmental Protection Chapter 500 Stormwater Management Rules and the Maine Construction General Permit (MCGP) requirements.

Inspect disturbed and impervious areas, erosion control measures, materials storage areas exposed to precipitation and locations where vehicles enter or exit the site. Inspection should occur at least once a week as well as before and after a storm event, and prior to completin.

Maintain all erosion and stormwater control measures until areas are permanently stabilized, maintenance, madification, and/or instabilation of additional best management practices (BMPs) are necessary, implementation must be completed within 7 calender days and prior to any storm

The following standards shall be required. For further reference, see the Maine Department of Environmental Protection Chapter 500 Starmwater Management Rules.

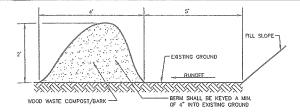
1. Spill prevention controls must be utilized to prevent pollutants from being discharged from materials ansite.

During construction, liquid petroleum products and other hazardous materials with the potential to contaminate groundwater may not be stored or handled in areas of the site draining to an infiltration area or adjacent to the starmwater actic basins and drain membales.

Action must be taken to ensure activities do not result in noticeable erosion of soils or fugitive dust emissions during or after construction.

5. Weter collected as a result of trench devotating must be spread through natural veoded be or removed to arrass that or specifically designed to collect the maximum amount of sediment possible. Ike a cofferdam sedimentation basin. Avail allowing the water to flow over disturbed areas of the site.

7. Additional requirements may be applied on a site-specific basis.



NOTES:

1. THE WOOD WASTE COMPOST/BARK MIX SHALL CONFORM TO THE FOLLOWING STANDARDS

A. MOISTURE CONTENT - 30-60%.
B. pH - 5.0 - 8.0.
C. SCREEN SIZE - 100% LESS THAN 3", MAX. 70% LESS THAN 1".
D. NO LESS THAN 40% ORGANIC MATERIAL (DRY WEIGHT) BY LOSS OF IGNITION.
E. NO STONES LARGER THAN 2" IN DIAMETER.
F. SILTS, CLAYS OR SUGAR SANDS ARE NOT ACCEPTABLE IN THE MIX.

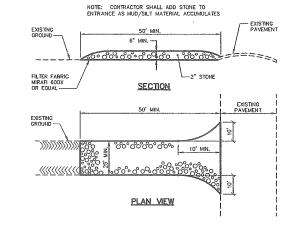
2. THE COMPOST BERM SHALL BE PLACED, UNCOMPACTED, ALONG A RELATIVELY LEVEL CONTOUR.

THE WOOD WASTE COMPOST/BARK FILTER BERM MAY BE USED IN LIEU OF SILTATION FENCE, AT THE TOE OF SHALLOW SLOPES, ON FROZEN GROUND, LEDGE OUT CROPS, VERY ROOTED FORESTED AREA OR AT THE EDGE OF GRAVEL PARKING AREAS.


4. BERMS SHALL REMAIN IN PLACE UNTIL UPSTREAM AREA IS COMPLETED OR 90% CATCH OF VEGETATION IS ATTAINED. BERMS SHALL BE REMOVED BY SPREADING SUCH THAT NATIVE EARTH CAN BE SEEN BELOW.


5. WOOD WASTE COMPOST/BARK FILTER BERM SHALL NOT BE USED IN WETLAND AREAS.

WOOD-WASTE COMPOST FILTER BERM




STABILIZED CONSTRUCTION ENTRANCE N.T.S.

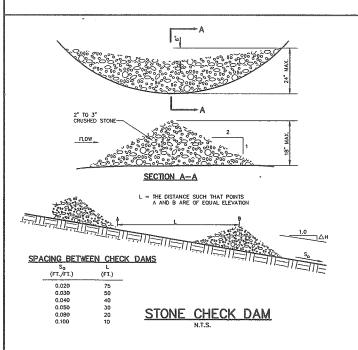


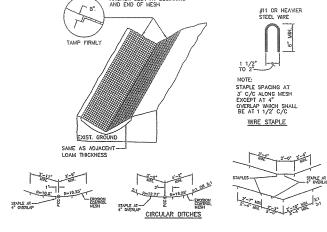

STAPLES AT EDGES, AT QUARTER POINTS, AT 4° OVERLAP

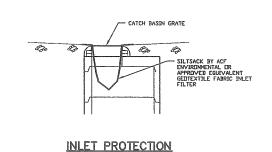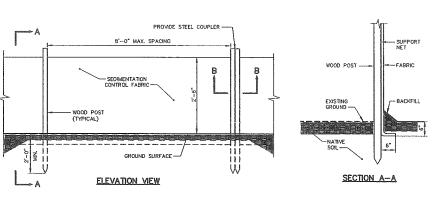EROSION CONTROL MESH





SILT FENCE MAX. SPACING REINFORCEMENT WIRE REINFORCEMENT 10' 14 GAUGE, 6" MESH

SECTION B-B

SILTATION FENCE

NOTE: THIS PLAN SET IS ISSUED FOR PERMITTING PURPOSES AND SHALL NOT BE USED FOR CONSTRUCTION.

Rev. Date Revision


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Design: JG	Draft: GJL	Date: AUG 06
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Gorrill-Palmer Consulting Engineers, Inc. PO Box 1237 Traffic and Civil Engineering Services 207-657-6910 15 Shoker Road Cray, ME 04039 E-Mail: mailbox@gorrillpalmer.com Erosion and Sedimentation Control Details & Notes UNIFIRST SITE EXPANSION

> UNIFIRST CORPORATION 430 RIVERSIDE INDUSTRIAL PARKWAY, PORTLAND, ME 04103

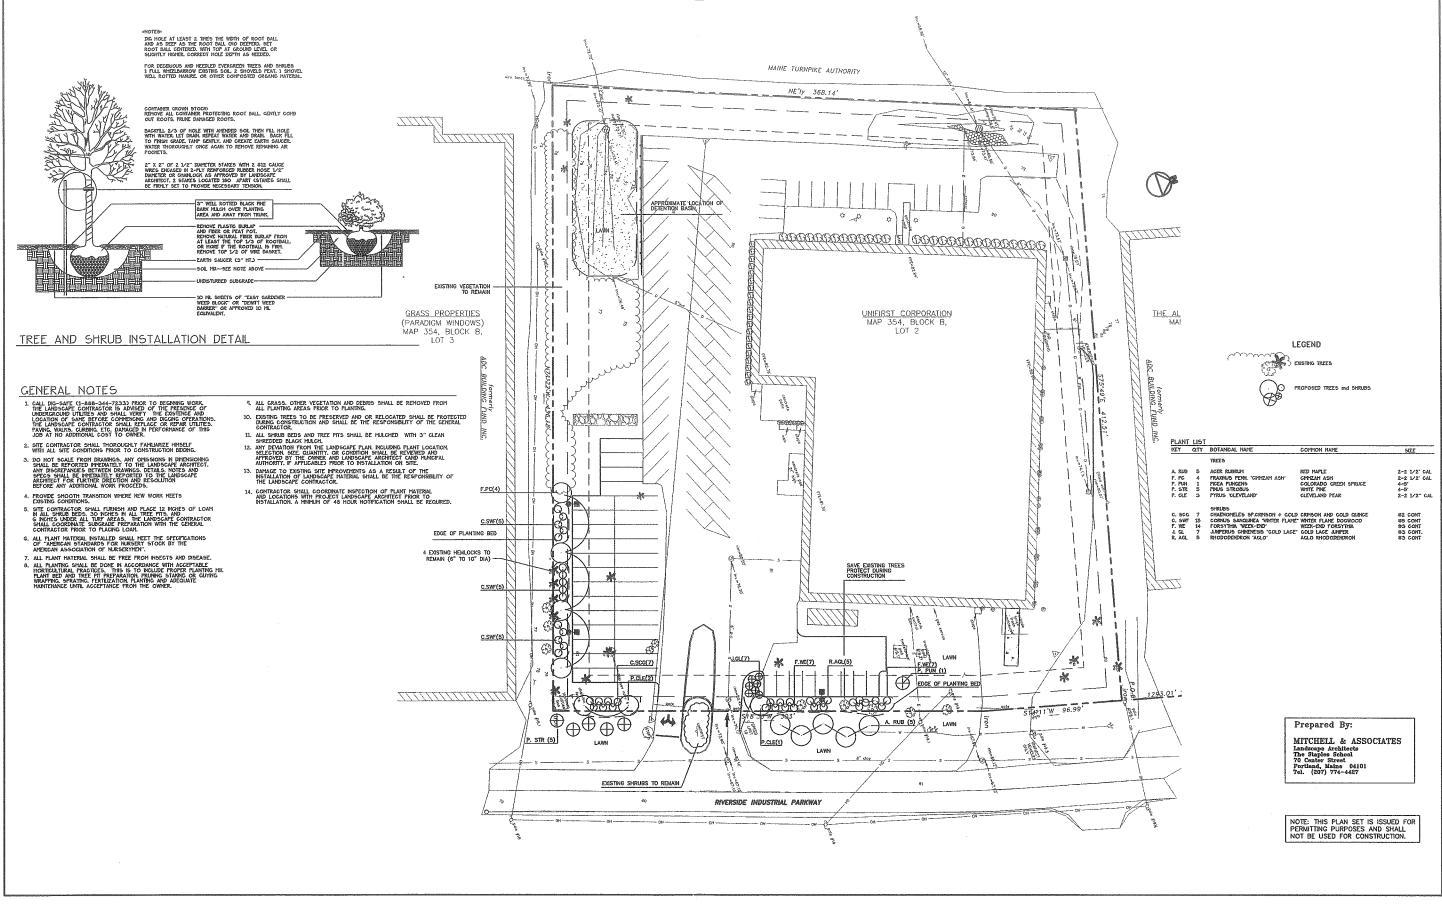Drawing No. C401



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Client:	UNIFIRST	
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