


DRAWINGS/SPECIFICATIONS BY:  
 WALGREENS'  
 LANDLORD'S CONSULTANT

ALL CONSTRUCTION WORK, UNLESS NOTED OTHERWISE, BY:  
 WALGREENS' CONTRACTOR  
 LANDLORD'S CONTRACTOR (TURNKEY CONSTRUCTION)

STORE	BUILDING
NEW . . . . . <input type="checkbox"/>	NEW . . . . . <input checked="" type="checkbox"/>
REMODELING . . . . . <input type="checkbox"/>	EXISTING . . . . . <input type="checkbox"/>
RELOCATION . . . . . <input type="checkbox"/>	NEW SHELL ONLY . . . . . <input type="checkbox"/>
OTHERS . . . . . <input type="checkbox"/>	

**TYPICAL LED SIGN POWER SUPPLY RACK ELEVATION**  
 NOT TO SCALE

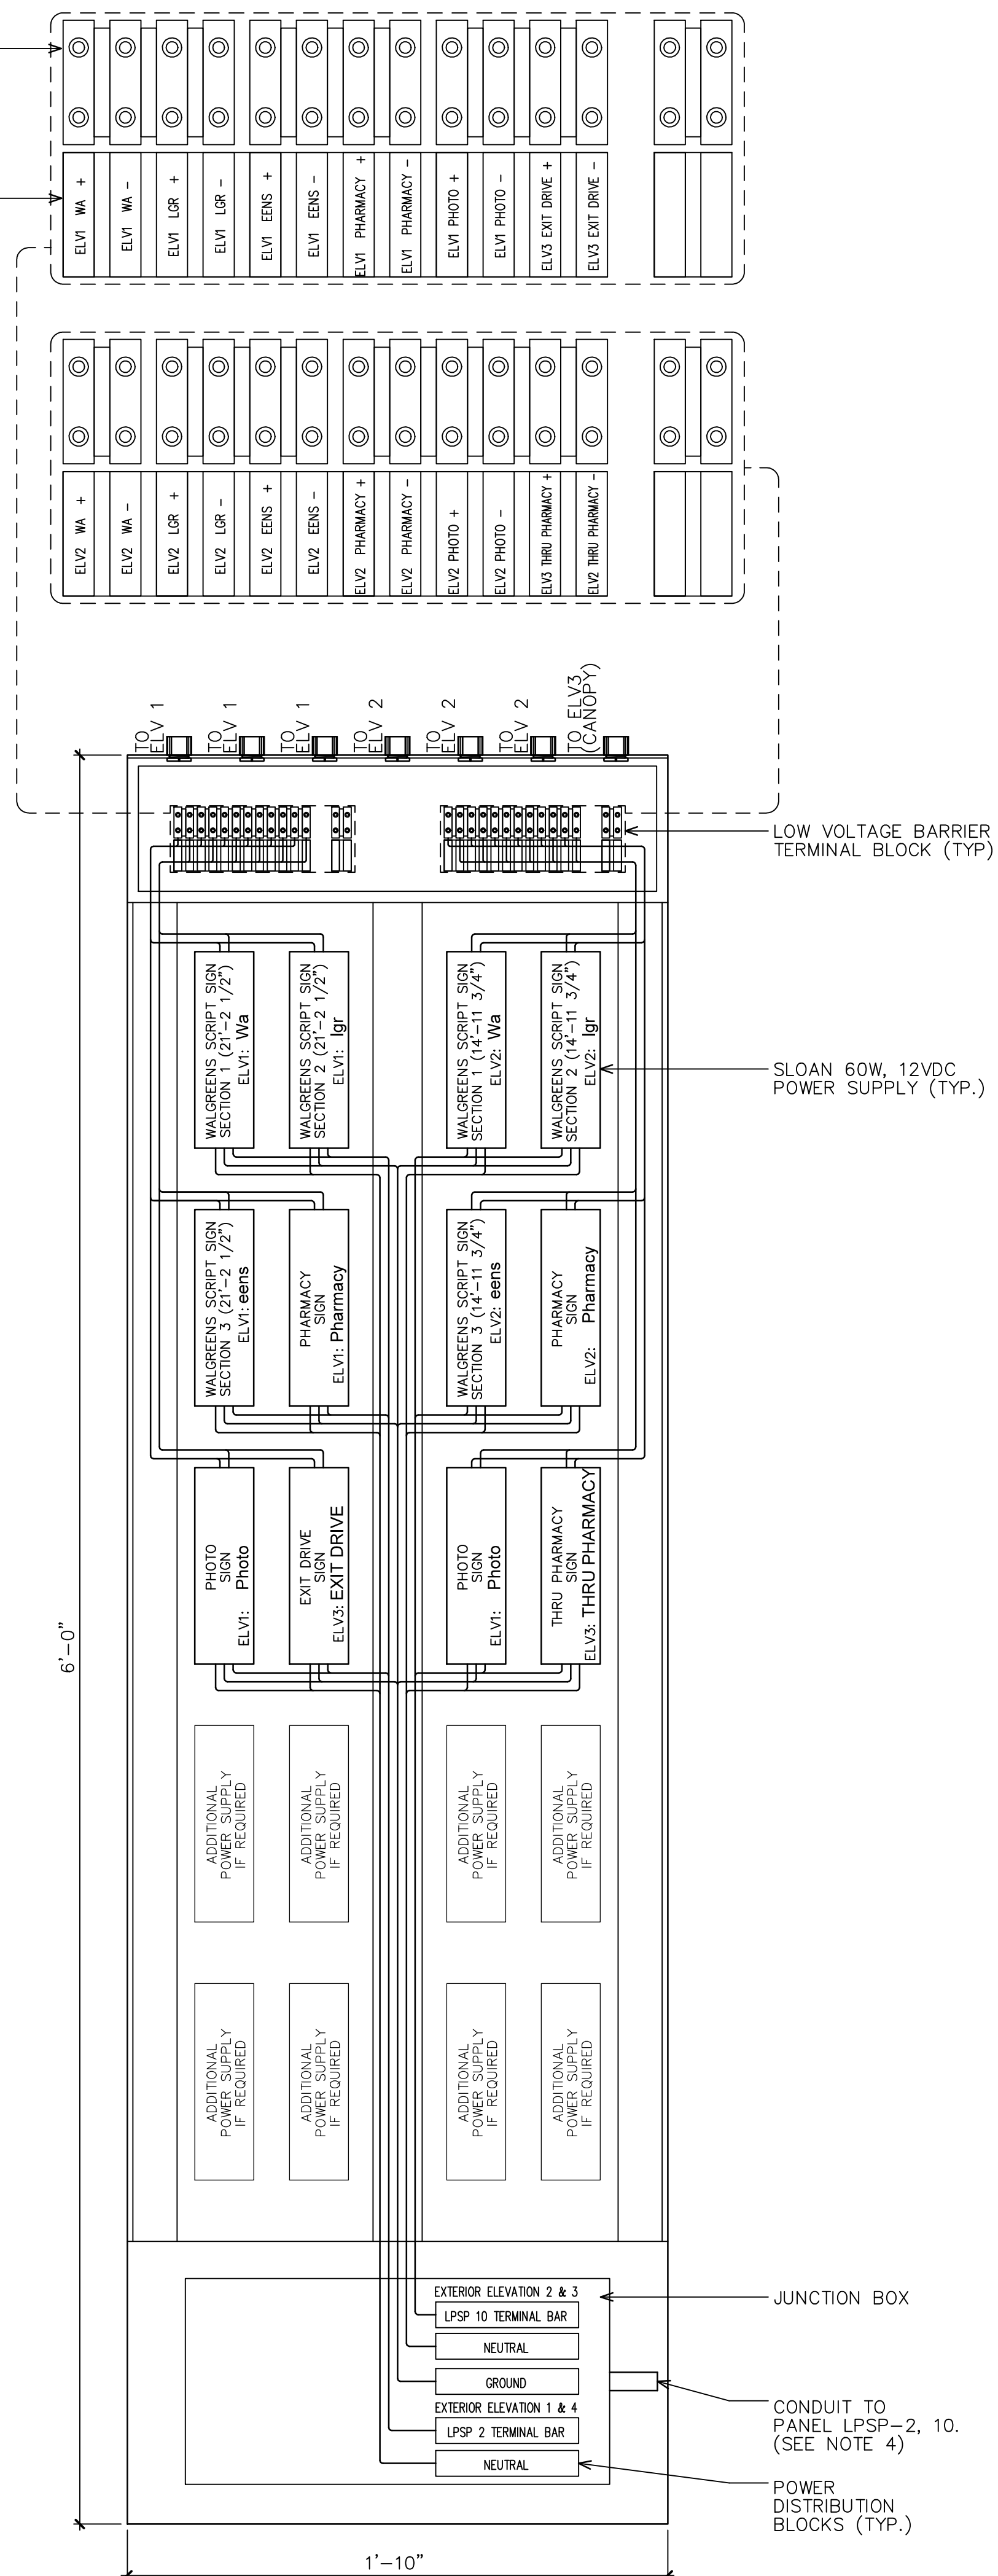

WARNING:  
 LETTERS WILL NOT LIGHT IF WIRING  
 POLARITY IS REVERSED.  
 RED: POSITIVE (+)  
 BLACK: NEGATIVE (-)


LOW VOLTAGE BARRIER  
 TERMINAL BLOCK (TYP.)

VINYL COPY INDICATING POLARITY,  
 LETTERS OF SIGN AND THE  
 LOCATION OF THE SIGN (TYP.)

SLOAN LED SIGN ELECTRICAL DATA (0.9PF)						
SIGN MOST COMMON SIZES (NOTE 7)	WATTS	QUANTITY OF POWER SUPPLY	QUANTITY OF LOW VOLTAGE CABLE	SIGN MOST COMMON SIZES (NOTE 7)	WATTS	QUANTITY OF POWER SUPPLY
WALGREENS SCRIPT: 23'-8 1/2"	136.8	3	6	DRIVE THRU: 10"	40.8	1
PHARMACY: 14"	53.4	1	2	DRIVE THRU PHARMACY: 6"	71.4	2
PHOTO: 14"	33	1	2	24 HR: 18"	22.2	1
CLINIC: 18"	26.4	1	2	EXIT: 10"	16.2	***

\* - POWER SUPPLY RATED 60 WATTS.  
 \*\*\* - POWER SUPPLY SHARED WITH DRIVE THRU PHARMACY SIGN

TYPICAL TAGS FOR LOW VOLTAGE CONDUCTORS BETWEEN TERMINAL BLOCKS AND SIGNS (NOTE 3)		
WALGREENS SCRIPT		
ELV1 WA +	ELV1A WA +	ELV2 WA +
ELV1 WA -	ELV1A WA -	ELV2 WA -
ELV1 LGR +	ELV1A LGR +	ELV2 LGR +
ELV1 LGR -	ELV1A LGR -	ELV2 LGR -
ELV1 EE +	ELV1A EE +	ELV2 EE +
ELV1 EE -	ELV1A EE -	ELV2 EE -
ELV1 NS +	ELV1A NS +	ELV2 NS +
ELV1 NS -	ELV1A NS -	ELV2 NS -
PHARMACY		
ELV1 PHARMACY +	ELV2 PHARMACY +	
ELV1 PHARMACY -	ELV2 PHARMACY -	
PHOTO		
ELV1 PHOTO +		
ELV1 PHOTO -		

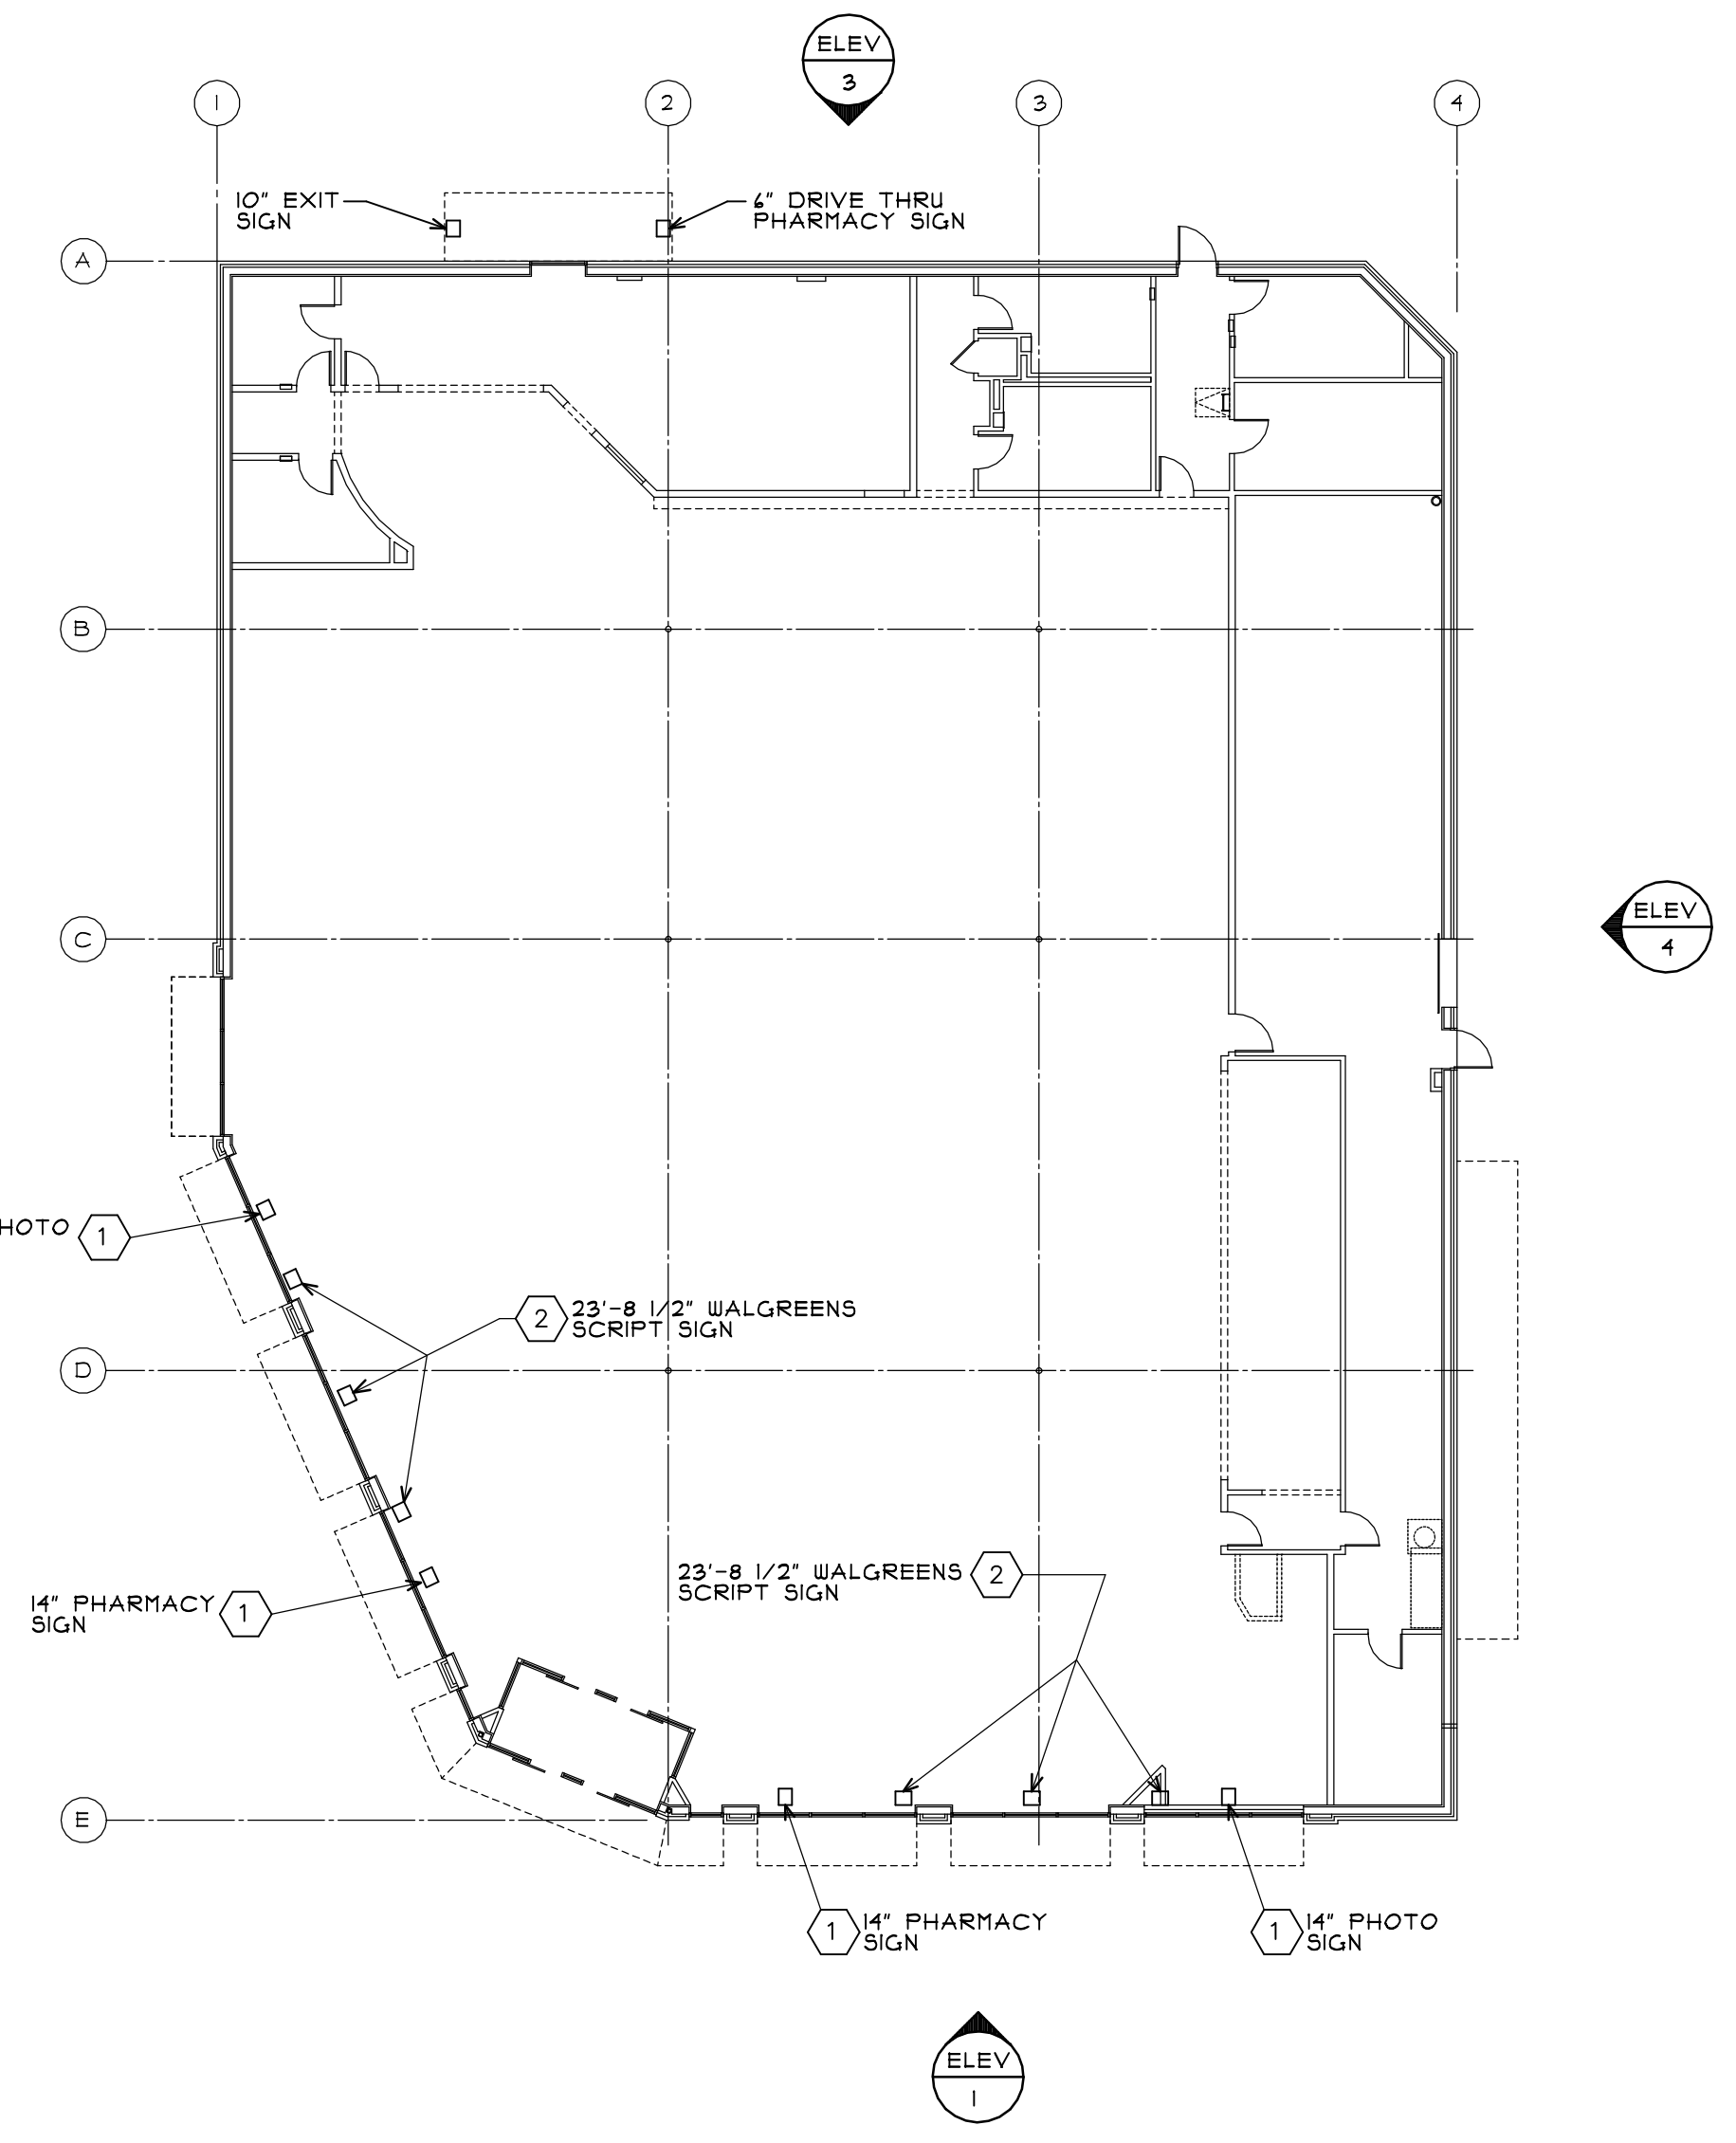


**FLOOR PLAN - CHANNEL LETTER LED SYSTEM**  
 SCALE: 1/16" = 1'-0"

**CHANNEL LETTER LED SYSTEM KEYED NOTES**

1 JUNCTION BOX FOR EXTERIOR INDIVIDUAL LETTER SIGN.  
 2 4 JUNCTION BOXES FOR EXTERIOR SCRIPT SIGN.

**CHANNEL LETTER LED SYSTEM NOTES**

- ALL WORK SHOWN SHALL COMPLY WITH ALL NATIONAL, STATE AND LOCAL CODES, ORDINANCES, ETC.
- SEE ARCHITECTURAL EXTERIOR ELEVATIONS FOR EXACT SIGN POSITIONS.
- ELECTRICAL CONTRACTOR SHALL FURNISH WIRING BETWEEN LOW VOLTAGE 12-CIRCUIT BARRIER TERMINAL BLOCKS AND J-BOXES NEAR SIGNS (#10AWG). TAGS (SEE DESCRIPTION SHOWN ON TABLE) MUST BE FURNISHED BY ELECTRICAL CONTRACTOR AND ATTACHED ON BOTH ENDS OF EACH LOW VOLTAGE CONDUCTOR. WIRING BETWEEN J-BOXES AND THE SIGNS SHALL BE FURNISHED BY SIGN CONTRACTOR.
- WIRING BETWEEN PANEL "LP-SP" CIRCUITS 2 AND 10 AND POWER DISTRIBUTION J-BOX SHALL BE FURNISHED BY ELECTRICAL CONTRACTOR.
- ELECTRICAL CONTRACTOR SHALL FURNISH AND INSTALL PLYWOOD BOARD FOR POWER SUPPLY RACK. PLYWOOD BOARD SHALL BE INSTALLED NEXT TO TELEPHONE TERMINAL BOARD.
- LED POWER SUPPLY RACK (FURNISHED BY THE SIGN CONTRACTOR) SHALL BE INSTALLED ON PLYWOOD BOARD. ELECTRICAL CONTRACTOR RACK SHALL BE FINISHED AND COMPLETE WITH POWER SUPPLIES, POWER DISTRIBUTION J-BOX AND LOW VOLTAGE 12-CIRCUIT BARRIER TERMINAL BLOCKS. POWER SUPPLIES SHALL BE PRE-WIRED TO POWER DISTRIBUTION J-BOX AND LOW VOLTAGE 12-CIRCUITS BARRIER TERMINAL BLOCKS. EACH POWER SUPPLY SHALL BE FACTORY IDENTIFIED WITH VINYL COPY INDICATING LETTERS OF SIGN AND LOCATION OF SIGN. EACH TERMINAL AT 12-CIRCUIT BARRIER TERMINAL BLOCK SHALL BE FACTORY IDENTIFIED WITH VINYL COPY INDICATING POLARITY, LETTERS OF SIGN AND LOCATION OF SIGN.
- CONSULTANT SHALL VERIFY QUANTITY AND SIZE OF LED SIGNS.

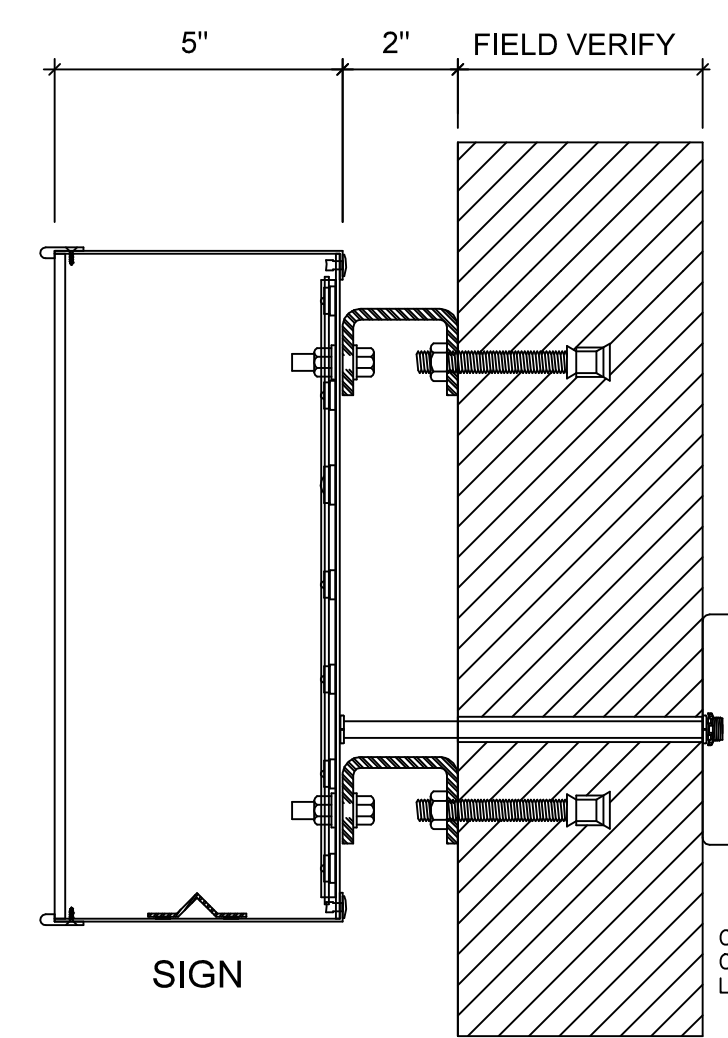


**WARNING:  
 CHANGE IN WIRING  
 POLARITY WILL CAUSE  
 FAILURE IN DC  
 CONTROLLERS AND  
 POWER SUPPLY.**

**WHITE WITH RED TRACER:  
 POSITIVE (+)**

**SOLID WHITE: NEGATIVE (-)**

**WARNING:  
 CHANGE IN WIRING  
 POLARITY WILL CAUSE  
 FAILURE IN DC  
 CONTROLLERS AND  
 POWER SUPPLY.**

**RED WIRE HAS:  
 POSITIVE (+) DC VOLTAGE  
 BLACK WIRE HAS:  
 NEGATIVE (-) DC VOLTAGE**

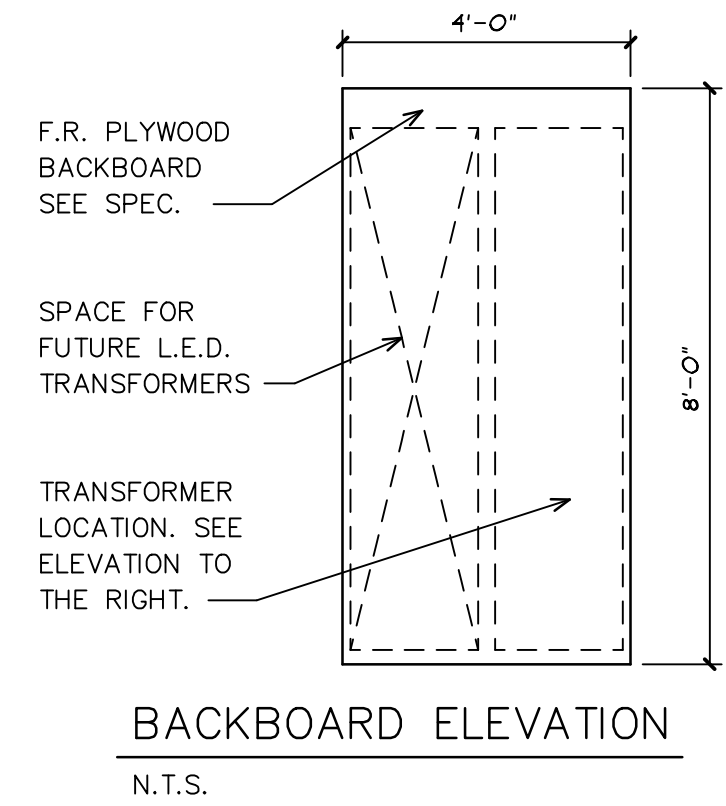

NO.	DATE	BY	DESCRIPTION	CONST
REVISIONS				

**CERTIFICATION AND SEAL**

I HEREBY CERTIFY THAT THIS PLAN AND SPECIFICATION WAS PREPARED BY ME OR UNDER MY DIRECT SUPERVISION AND THAT I AM A DULY REGISTERED ARCHITECT OR ENGINEER UNDER THE LAWS OF THE STATE OF MAINE AS SIGNIFIED BY MY HAND AND SEAL.

**FISCAL 2007 CRITERIA - STORE #12326**

WALGREENS  
 (NWC) WASHINGTON & ALLEN AVES.  
 PORTLAND, MAINE

**DRAWING TITLE**  
**CHANNEL LETTER LED SYSTEM**

CADD PLOT: \_\_\_\_\_  
 VOID PLOT: \_\_\_\_\_  
 RELEASED TO CONSTRUCTION: \_\_\_\_\_

SCALE: AS NOTED  
 DRAWN BY: TD  
 DATE: 3-28-09  
 REVIEWED BY: SAM

DRAWING NO. **E1.7**