

344-E-6 300 Allen Ave. Bld. Addition Northgate Plaza


2003-0124



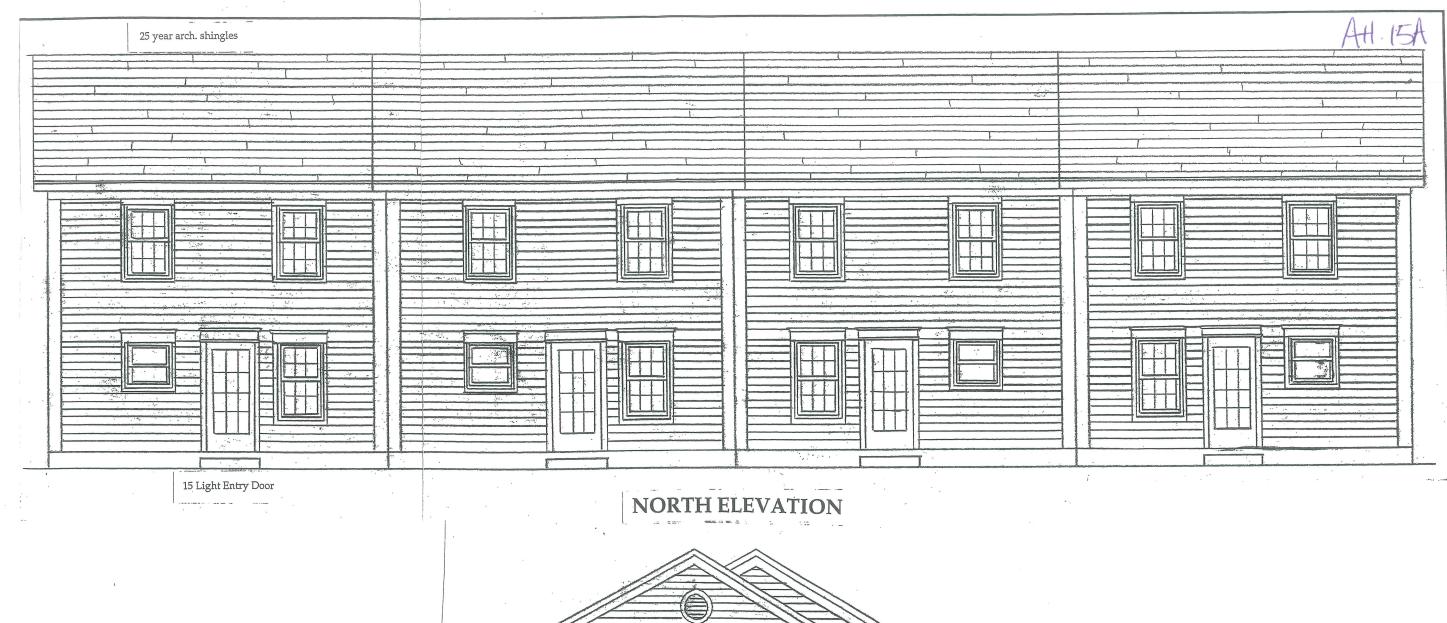


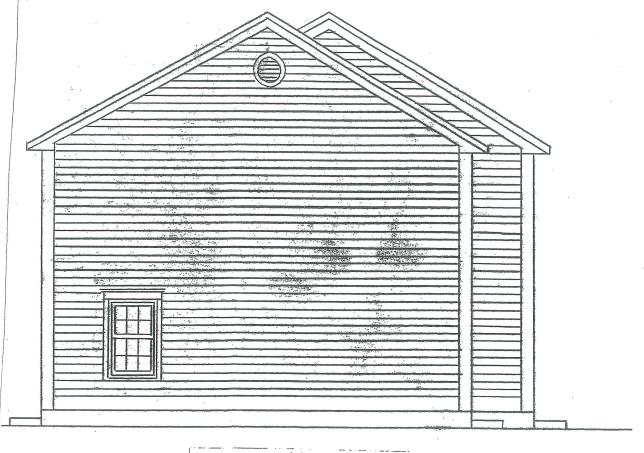


WEST ELEVATION

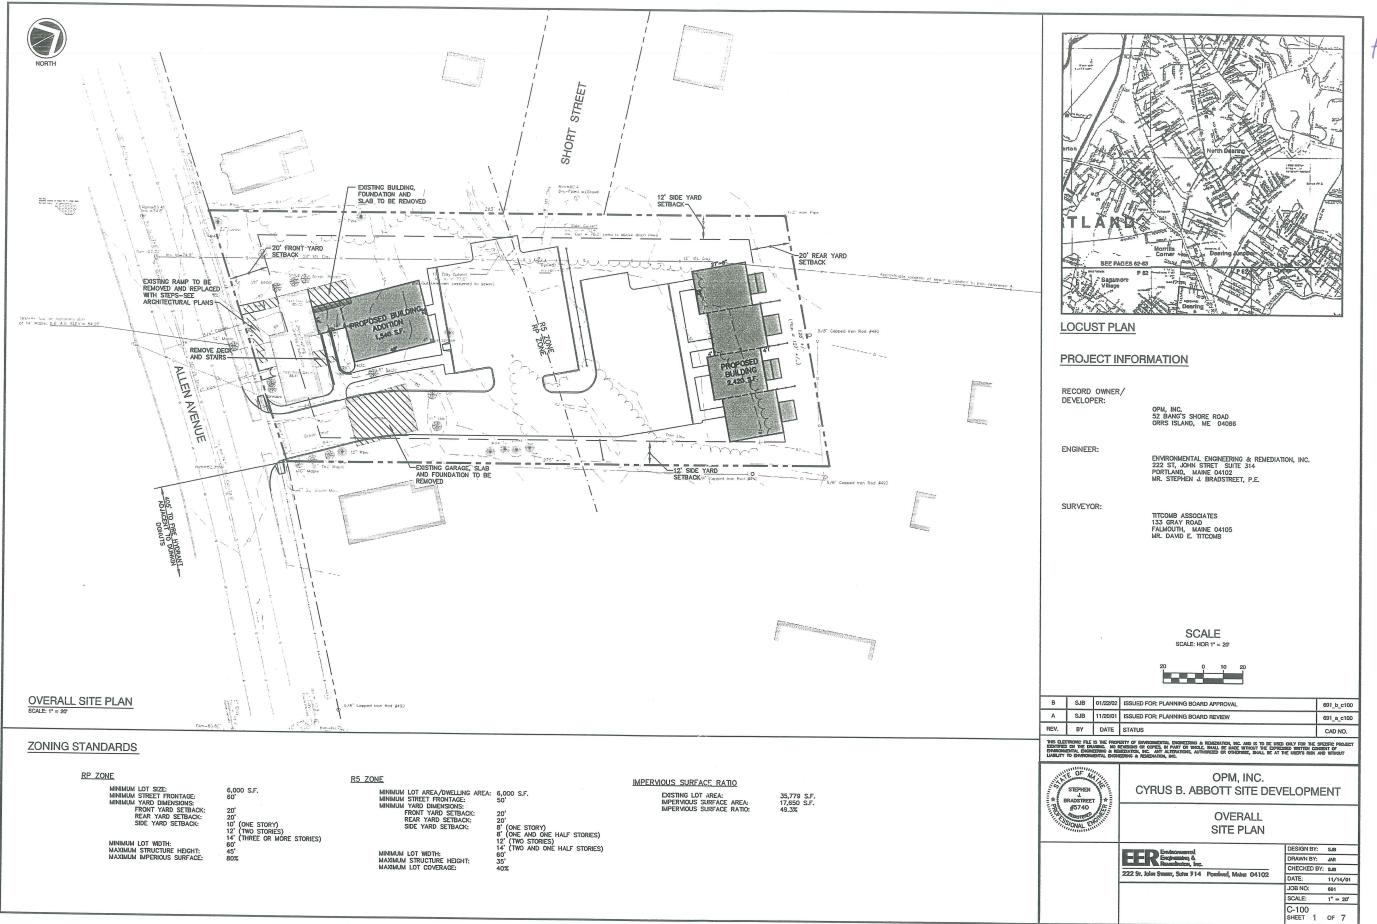


AH. 16

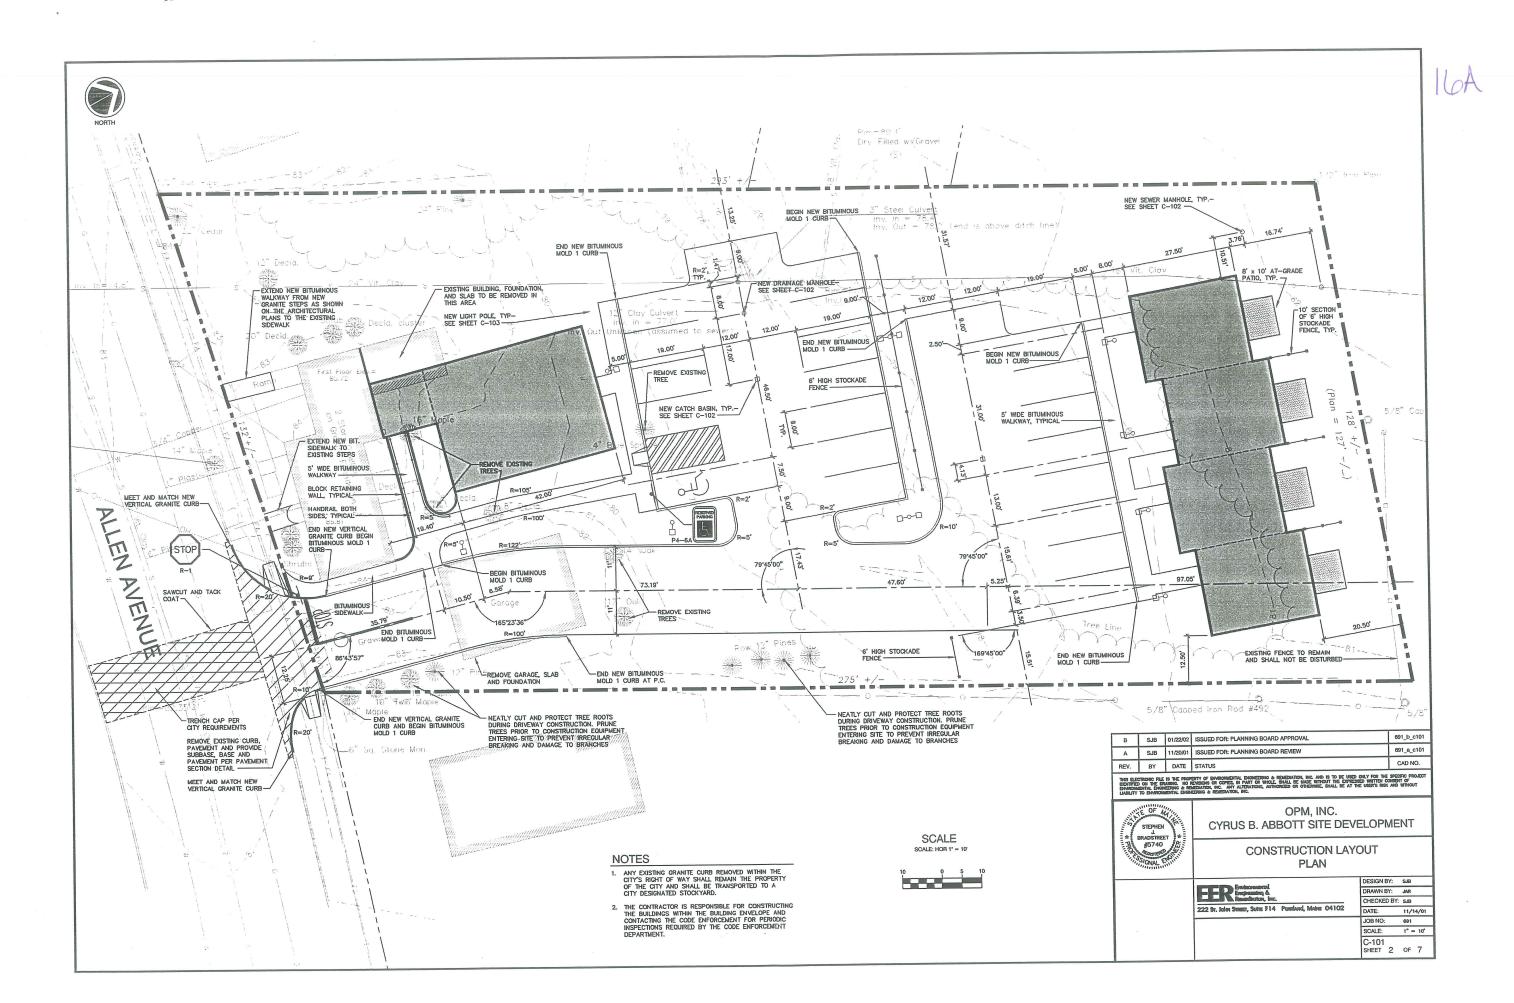

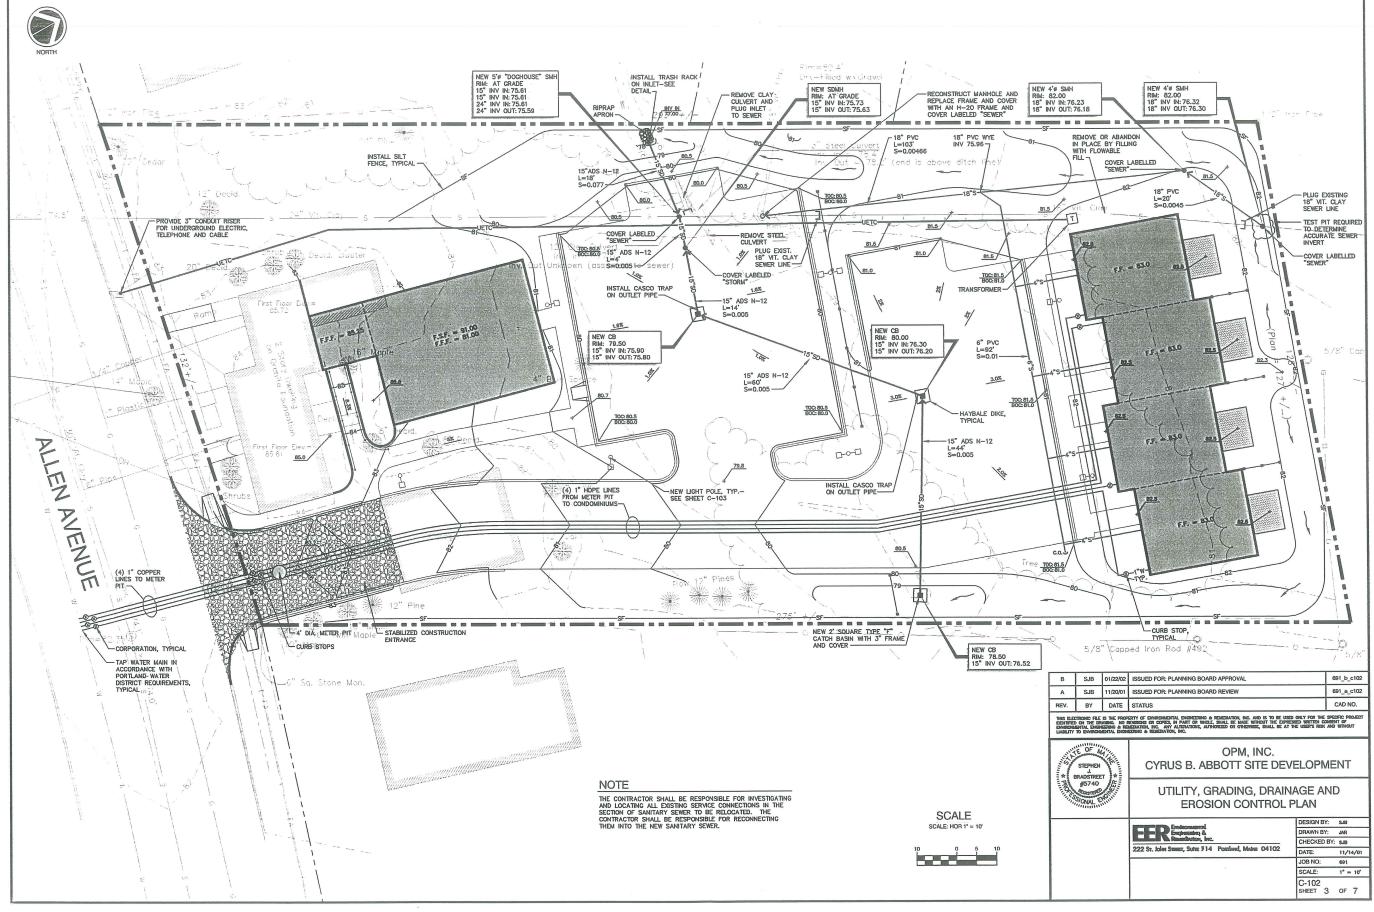



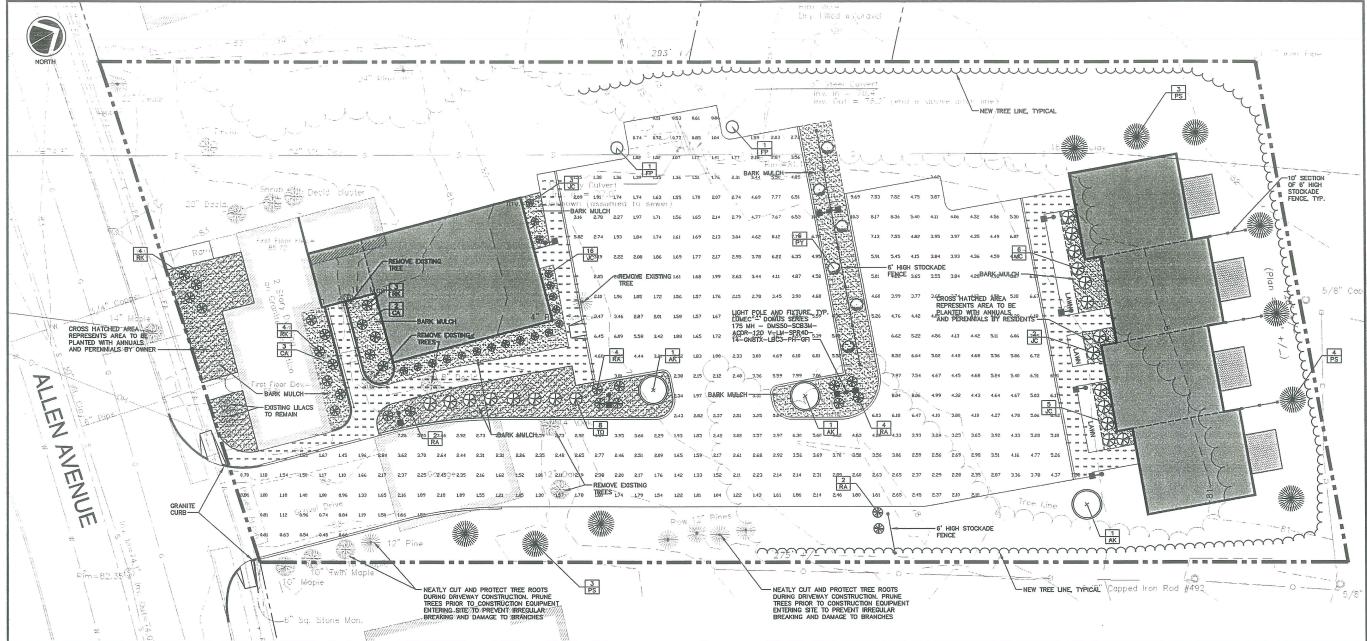

PLANTING NOTES

- THE LANDSCAPE CONTRACTOR IS ADVISED OF THE POSSIBILITY OF UNDERGROUND UTILITIES. THE LANDSCAPE CONTRACTOR SHALL VERIFY UTILITIES PRIOR TO COMMENCING CONSTRUCTION.
- THE LANDSCAPE CONTRACTOR SHALL BE RESPONSIBLE FOR REPAIRING ANY UTILITIES, WALKS, PAVING, CURBING, ETC.. DAMAGED IN THE PERFORMANCE OF THIS JOB AT NO COST TO THE OWNER.
- 3. PLANTING OF TREES AND SHRUBS SHALL NOT OCCUR UNTIL ALL GRADING AND PAVING IS COMPLETED.
- ALL PLANTS SHALL HAVE A NORMAL HABIT OF GROWTH FOR THE SPECIES AND SHALL BE SOUND, HEALTHY AND FREE OF DISEASE AND INSECTS. THEY SHALL CONFORM TO THE MEASUREMENTS ON THE PLANT UST AND SHALL CONFORM TO ANSI Z60.1 — NURSERY STOCK, LATEST REVISION.
- 5. ALL PLANTS SHALL HAVE ALL NONBIODEGRADABLE MATERIALS (STRING, WIRE, POTS, ETC.) REMOVED AT THE TIME OF PLANTING. CIRCLING ROOTS OR ROOTS THAT WOULD LATER GROUE THE PLANT SHALL BE STRAIGHTHENED, CUT OR THE ROOT BALL SHALL BE CUT UTILIZING THE "BUTTERFLY METHOD." TOP 1/3 OF WIRE BASKETS AND BURLAP ON TREES SHALL BE CUT AND REMOVED.
- 6. BACKFILL MIX SHALL BE COMPOSED OF A 80/20, LOAM/PEAT MOSS MIX. PLANTING PITS SHALL BE EXCAVATED TO THREE TIMES THE DIAMETER AND TO THE SAME DEPTH OF THE PLANT ROOT BALL BACKFILL 1/2 OF THE PIT AT A TIME AND COMPACT. SEE NOTE 7 AND INSTALL SLOW RELEASE FERTILIZER AFTER FIRST BACKFILL LIFT. SETTING THE TREE/ SHRUB: EACH TREE/SHRUB SHALL BE PLANTED SUCH THAT THE TRUNK FLARE JUNCTION IS LEVEL WITH OR 1-2" ABOVE EXSTING GRADE. TREES/SHRUBS WHERE THE PLANTING DEPTH IS INCORRECT SHALL BE REJECTED. ALL PLANTING ISLANDS SHALL HAVE 18" OF TOPSOIL INSTALLED, WITH A PINISHED GRADE AT THE TOP OF CURB, PRIOR TO THE INSTALLATION OF PLANT MATERIAL.
- 7. ALL PLANTINGS SHALL HAVE SLOW RELEASE FERTILIZER TABLETS INSTALLED.

 TABLETS SHALL BE AGRIFORM 21 GRAM 20-10-5 PLANTING TABLETS OR AN APPROVED EQUAL. APPLICATION RATE: PERENNIALS-1 TABLET/PLANT, WOODY SHRUBS TO 3-0"-2 TABLETS/PLANT, SHRUBS AND TREES 5"-0" TO 6"-0"-3 TABLETS/PLANT AND TREES 6"-0" AND ABOVE-4 TABLETS/PLANT. AFTER PLANTS ARE INSTALLED, LIQUID FEED ALL PLANTS WITH ROOTS OR AN APPROVED EQUAL. MIX MIX ACCORDING TO MANUFACTURER'S INSTRUCTIONS. APPLICATION RATE: PERENNIALS-2 QTS/PLANT, WOODY SHRUBS TO 4"0"-1.5 GAL/PLANT, TREES AND SHRUBS 4"-0" TO 10"-0"-3.0 GAL/PLANT AND TREES 10" AND ABOVE-4.0 GAL/PLANT.
- 8. TREES WILL NOT BE STAKED UNLESS IN THE OPINION OF THE LANDSCAPE CONTRACTOR THAT IT IS REQUIRED. IN THOSE CASES THE PARTICULAR TREES SHOULD BE REPORTED TO THE OWNER FOR THEIR APPROVAL. IN NO CASES SHALL A TREE BE STAKED BECAUSE THE ROOT BALL CRUMPLED. IN THOSE CASES THE TREE SHALL BE REMOVED AND REPLACED WITH A TREE OF THE SAME SPECIES AND SIZE WITH A SOLID AND INTACT ROOT BALL. IF STAKES ARE USED, THEY SHALL BE REMOVED BY THE CONTRACTOR AFTER ONE YEAR.
- 9. MULCH TO BE INSTALLED TO A DEPTH OF 3" AFTER NORMAL SETTLING. MULCH SHALL BE MEDIUM SHREDDED HEMLOCK BARK. DO NOT PLACE MULCH IN CONTACT WITH THE TREE OR SHRUB TRUNK. ALL SHRUB BEDS AND ISLANDS SHALL BE MULCHED. IN SHRUB BEDS THE EXTENT OF MULCH WILL BE 3" FROM THE CENTER OF THE PLANT TO THE EDGE OF THE BED.
- 10. ALL PLANTS SHALL BE ORIENTED FOR BEST APPEARANCE. PLANT SPECIES SUBSTITUTIONS WILL NOT BE ALLOWED UNLESS APPROVED BY THE OWNER.
- 11. ALL PLANTS SHALL BE GUARANTEED FOR ONE GROWING SEASON (ONE YEAR FROM DATE OF ACCEPTANCE). ANY PLANTS THAT DIE DURING THE GUARANTEE, SHALL BE REPLACED BY THE LANDSCAPE CONTRACTOR AT NO COST TO THE OWNER.

- 12. ALL AREAS NOT IDENTIFIED WITH OTHER SURFACE TREATMENTS SHALL BE LAWN. THE LAWN ARE SHALL BE SEEDED WITH (LOFTS TRI-PLEY GENERAL OR APPROVED EQUAL) AND STRAW MULCHED. THE CONTRACTOR SHALL BE RESPONSIBLE FOR LAWN MAINTENANCE. MAINTENANCE SHALL COMMENCE AT THE TIME OF PLANTING AND LAST UNTIL A COOD FULL CATCH OR GRASS IS ESTABLISHED.
- 13. IF QUANTITIES OF PLANTS LISTED IN THE PLANT SPECIES LIST DO NOT CORRELATE WITH THE PLANTINGS INDICATED ON THE PLAN, THE QUANTITIES ON THE PLAN SHALL GOVERN.

-PI A	MTIM	G SCHEDULE			
	QTY.	BOTANICAL NAME ACER RUBRUM "KARPICK"	COMMON NAME KARPICK RED MAPLE	SIZE 2.5°-3° CAL	REMARKS Bass
CA	5	CLETHRA ALNIFOLIA "HUMMINGBIRD"	HUMMINGBIRD SUMMERSWEET	18°-24°	4' O.C.
JC	32	J. CHINL VAR. SARGENTI GLAUCA	BLUE SARGENT	2'-2.5' HT.	B&B, 4' O.C.
RA	12	R. "AGLO"	AGLO RHODODENDRON	15"-18" HT.	4' O.C.
RIK	11	R. KURUME HYBRID "HERSEY'S RED"	HERSEY'S RED AZALEA	15°-18° HT.	4° O.C.
то	8	T. OCC. "SMARGARD"	EMERALD GREEN	3'-4' HT.	B&B, 4' O.C.
PY	6	PYRUS CALLERYANA "ARISTOCRAT"	ARISTOCRAT ORNAMENTAL PEAR	2.5°-3° CAL	Bad
PS	10	PINUS STROBUS	WHITE PINE	5'-6' HT.	BAG
FP	2	FRAMINUS PENNSYLVANICA "SUMMIT"	SUMMIT ASH	25°-3° CAL	BAB

SCALE GALE: HOR 1" = 10"

В	SJB	01/22/02	ISSUED FOR: PLANNING BOARD APPROVAL	691_b_c103
Α	SJB	11/20/01	ISSUED FOR: PLANNING BOARD REVIEW	691_a_c103
REV.	BY	DATE	STATUS	CAD NO.


THIS ELECTRONIC PLE IS THE PROPERTY OF ENGOMEDITAL BIOMEDITAL DISCRIPTION OF RELEASTION, MC. AND IS TO BE USED ONLY FOR THE SPECIFIC PROJECT DESTITIED ON THE ONLINES. ON EXPENSION OF COPERS, IN PART ON WOLDE SHALL BRILLE BUILDED WITHOUT THE OPPRESSED WITHIN CHESTED OF ENGOMEDITAL ENGNEETING & REJECTATION, INC. ANY ALTERATIONS, AUTHORIZED OR OTHERWISE, SHALL BE AT THE USER'S RISK AND WITHOUT LABOURTY TO ENVIRONMENTAL ENGREDWISE OF REMEMBRISH, INC.





OPM, INC. CYRUS B. ABBOTT SITE DEVELOPMENT

SITE LANDSCAPING AND LIGHTING PLAN

Fredromers I	DESIGN BY:	SJB
Eroprossalvog &	DRAWN BY:	JAR
Residence, Inc.	CHECKED BY:	SJB
2 Sr. John Smarr, Suite F14 Pomland, Mahu 04102	DATE:	11/14/0
	JOB NO:	691
	SCALE:	1° = 10
	C-103 SHEET 4	of 7

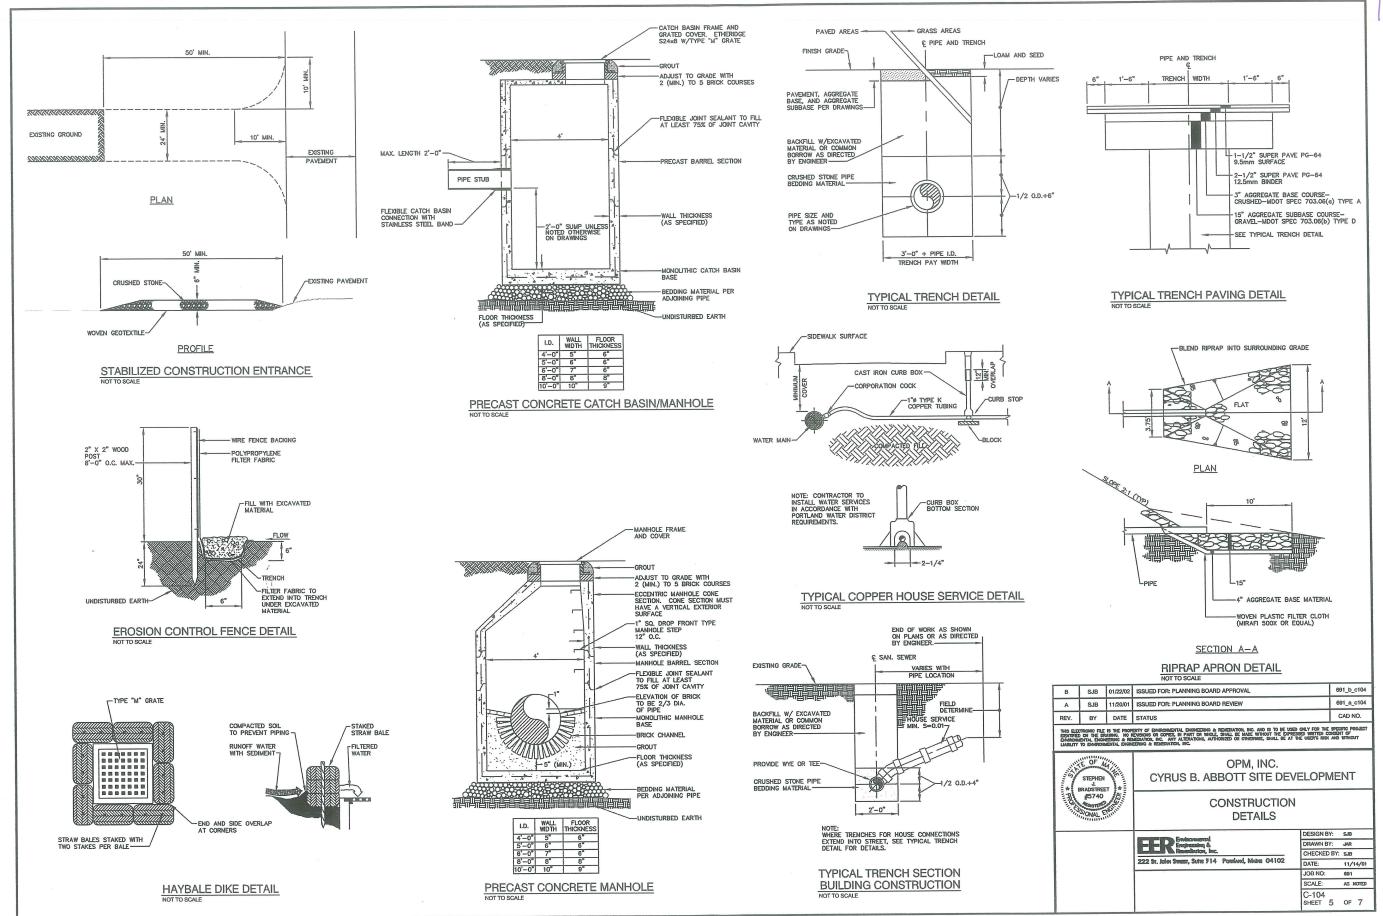

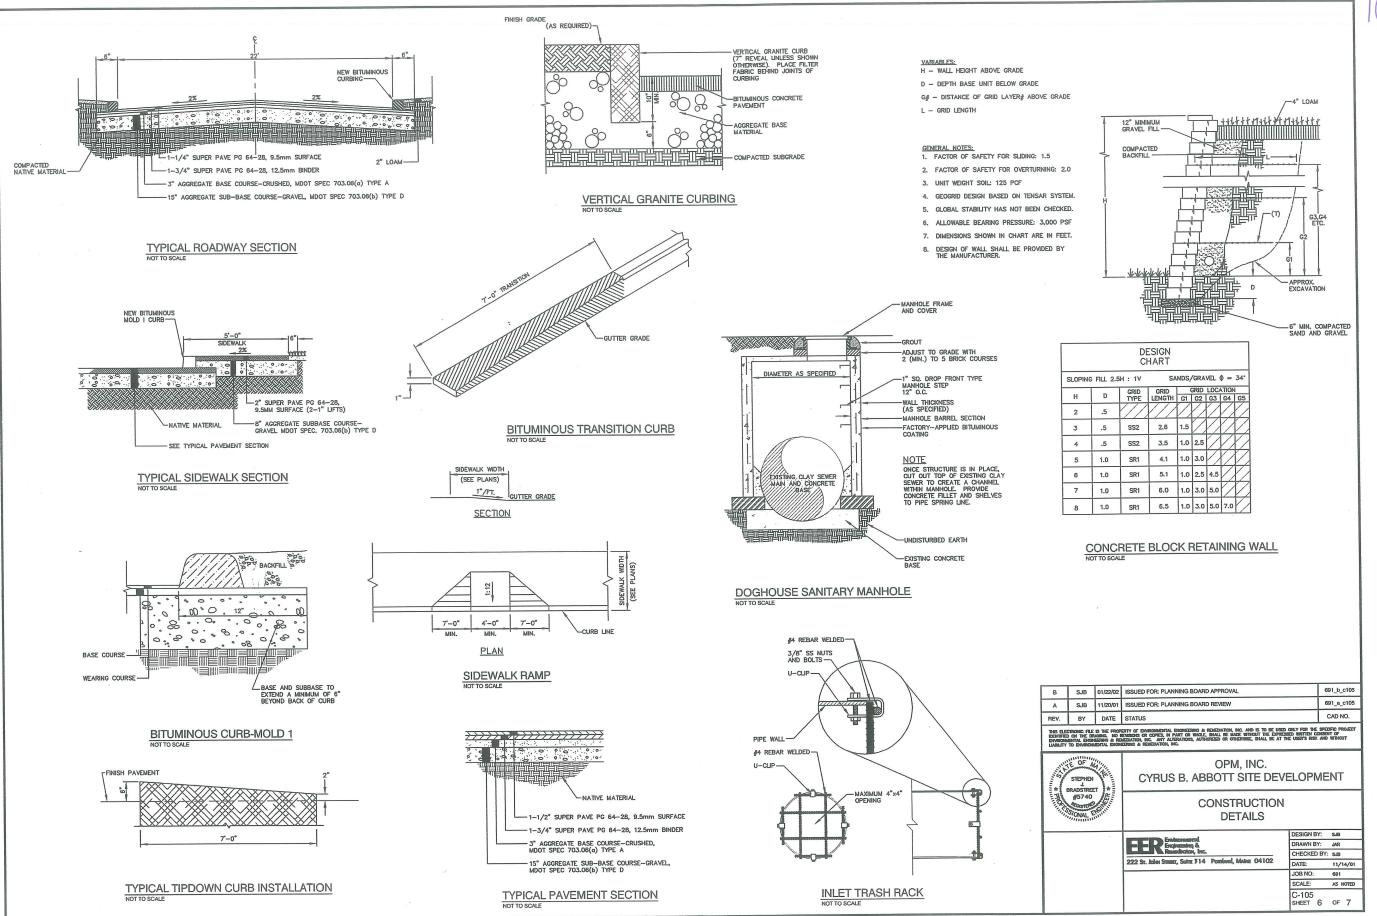

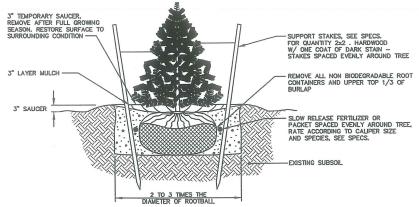

- NEVER CUT OUT CENTRAL LEADER, PRUNE OUT BROKEN, DEAD, OR CONFLICTING BRANCHES
- TREE GUYS SHALL BE GUYING CHAIN OR WEB STRAPPING.
- 5. WATER AT TIME OF PLANTING-SEE NOTES AND SPECS.

NOTES:
1. ON TREES LESS THAN 4" CA. USE WOOD STAKES. 4. NEVER CUT OUT CENTRAL LEADER, PRUNE OUT BROKEN, DEAD, OR CONFLICTING BRANCHES 2. ON TREES 3" CA. OR GREATER USE GUYING CABLES (3) EVENLY SPACED.

TURNBUCKLE AS SPEC.

3" HIGH EARTH

CUT AND REMOVE BURLAP FROM TOP 1/3 OF BALL IF NON-BIODEGRADEABLE MATERIAL REMOVE ENTIRELY

PLANT MIX AS SPECIFIED-

3. FOR PRUNING, SEE SPECIFICATIONS.

- 5. SEE SPECS, FOR ADDITIONAL REQUIREMENTS
 - 6. WATER AT TIME OF PLANTING-SEE NOTES AND SPECS.


-INSTALL TREE SO TRUNK FLARE JUNCTION IS LEVEL WITH OR 1"-2" ABOVE EXISTING GRADE

-3° MULCH AS SPECIFIED

FINISHED GRADE


TYPICAL TREE PLANTING DETAIL



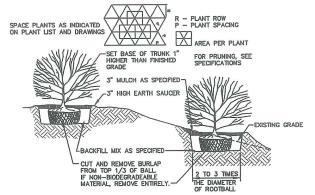


- 1. SEE SPECS, FOR ADDITIONAL REQUIREMENTS
- 2. INSTALL SHRUB SO TRUNK ROOT JUNCTION IS LEVEL WITH OR 1"-2" ABOVE EXISTING GRADE.


TYPICAL SHRUB PLANTING DETAIL

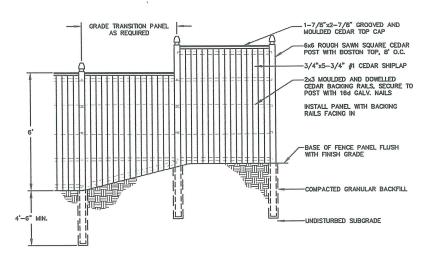

STOCKADE FENCE DETAIL

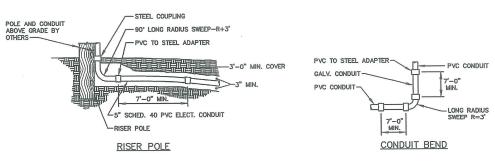

CONDUIT BEND AND RISER POLE DETAIL

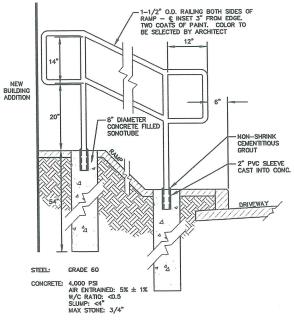

RAILING DETAIL

EROSION CONTROL NOTES

- APPLICATION OF TEMPORARY AND PERMANENT EROSION CONTROL MEASURES FOR THE PROJECT SHALL BE IN ACCORDANCE WITH PROCEDURES AND SPECIFICATIONS OF THE "MAINE EROSION AND SEDIMENT CONTROL HANDBOOK FOR CONSTRUCTION: BEST MANAGEMENT PRACTICES," MARCH 1991 (BMP HANDBOOK).
- SILTATION FENCE SHALL BE INSTALLED BEFORE GRUBBING OR EARTH MOVING OPERATIONS.
- PERMANENT SEEDING SHALL BE APPLIED WITHIN 15 DAYS OF FINAL GRADING FROM APRIL 15 TO SEPTEMBER 1.
- 4. PERMANENT SEEDING SHALL BE: BIRDSFOOT TREFOIL

LBS/1,000 S.F. CROWNVETCH CREEPING RED FESCUE OR TALL FESCUE

TEMPORARY SEEDING SHALL BE APPLIED WITHIN 30 DAYS OF INITIAL DISTURBANCE OF THE SOIL IF PERMANENT SEEDING IS NOT APPLIED. TEMPORARY SEEDING SHALL BE:

SEED	LB/1,000 SQ. FT.	SEEDING DEPTH	RECOMMENDED SEEDING DATES
WINTER RYE	2.6	1-1.5°	8/15-10/1
OATS	1.8	1-1.5°	4/1-7/1 8/15-9/15
ANNUAL RYEGRASS	0.9	.25"	4/1-7/1
SUDANGRASS	0.9	.5-1"	5/15-8/15
PERENNIAL	0.9	.25"	8/15-9/15

- FERTILIZER SHALL BE 10-20-20 GRANULAR GAREN FERTILIZER AND APPLIED AT 18.4 LBS/1,000 S.F.
- LIMESTONE SHALL BE GROUND WITH 50% CALCIUM PLUS MAGNESIUM OXIDE AND APPLIED AT 138 LBS/1,000 S.F.
- 8. MULCH SHALL BE HAY OR STRAW APPLIED AT 70-90 LBS/1,000 S.F.
- 9. WINTER MULCH SHALL BE APPLIED BETWEEN OCTOBER 1 AND APRIL 1 AND SHALL BE HAY OR STRAW APPLIED AT 300 LBS/1,000 S.F.
- ALL EROSION CONTROL MEASURES, SEEDING AND MULCHING SHALL BE INSPECTED WEEKLY,
 AFTER RAINSTORMS AND DURING RUNOFF EVENTS. ALL MEASURES SHALL BE REPAIRED
 OR REPLACED WHEN NO LONGER SERVICEABLE DUE TO SEDIMENT ACCUMULATION OR
- 11. SEEDED AND MULCHED AREAS SHALL BE MAINTAINED UNTIL FINAL ACCEPTANCE OF THE WORK. SED CATCH SHALL BE ACCEPTABLE WHEN 75 PERCENT CATCH IS ESTABLISHED. MAINTENANCE SHALL CONSIST OF PROVIDING PROTECTION AGAINST TRAFFIC AND REPAIRING ANY AREAS TO RE-ESTABLISHED THE CONDITION AND GRADE OF THE SOIL PRIOR TO SEEDING AND SHALL THEN BE REFERTILIZED, RESEDED AND REMULCHED.
- TEMPORARY EROSION CONTROL MEASURES SHALL BE REMOVED UPON COMPLETION OF GRADING OPERATIONS AND ESTABLISHMENT OF A 75 PERCENT CATCH OF GRASS.
- THE CONTRACTOR SHALL BE RESPONSIBLE FOR MAINTAINING EROSION CONTROL MEASURES DURING CONSTRUCTION.
- 14. EROSION CONTROL INSPECTION SHALL BE PERFORMED BY:
 ENVIRONMENTAL ENGINEERING AND REMEDIATION, INC.
 STEPHEN J. BRADSTREET, P.E.
 222 ST. JOHN STREET SUITE 314
 (207) 828-1272
- 15. EROSION CONTROL AND CONSTRUCTION SEQUENCE:

 q) INSTALL ALL TEMPORARY EROSION CONTROL AS SHOWN ON THE PLAN SHEET IN ACCORDANCE WITH THE DETAILS AND BIMP'S.
 b) CONSTRUCT THE DRIVE AND PARKING LOTS. IMMEDIATELY UPON INSTALLATION OF STORNIDRAINS CONSTRUCT RIPRAP INLET PROTECTION.
 c) REMOVE TEMPORARY EROSION CONTROL MEASURES ONCE IMPROVEMENTS ARE COMPLETE AND THERE IS 75 PERCENT CATCH OF GRASS.

 - d) INSTALL PERMANENT EROSION CONTROL MEASURES.

16. CONSTRUCTION SCHEDULE
REMOVE EXISTING GARAGE
EXISTING HOME RENOVATIONS
PROPOSED BUILDING ADDITION
SITE CONSTRUCTION SITE CONSTRUCTION
RESIDENTIAL APARTMENT CONSTRUCTION

В	SJB	01/22/02	ISSUED FOR: PLANNING BOARD APPROVAL	691_b_c106
Α	SJB	11/20/01	ISSUED FOR: PLANNING BOARD REVIEW	691_a_c106
REV.	BY	DATE	STATUS	CAD NO.

THIS ELECTRONICE FILE IS THE PROPERTY OF SAMEGINEETHAL DEGREESHING & RESIDIATION, INC. AND IS TO BE USED THE UNIT OF THE PROPERTY OF THE PROPE



OPM, INC. CYRUS B. ABBOTT SITE DEVELOPMENT

> CONSTRUCTION **DETAILS**

	DESIGN BY: SJB
E E D Engineering &	DRAWN BY: JAR
Randotor, Inc.	CHECKED BY: SJB
222 Sr. Joles Smarr, Sutra F14 Possilved, Meira 04102	DATE: 11/14/01
	JOB NO: 691
	SCALE: AS NOTED
	C-106

