

343-C-014 Allen Ave Apts (60) Allen Ave A.L.C Development Co 19980147

WASHINGTON CROSSING

REGIDENTIAL UNIT DEVELOPMENT

ALLEN AVENUE PORTLAND, MAINE

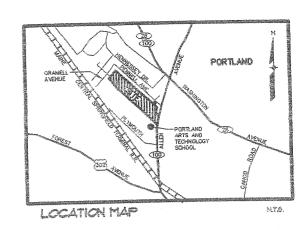

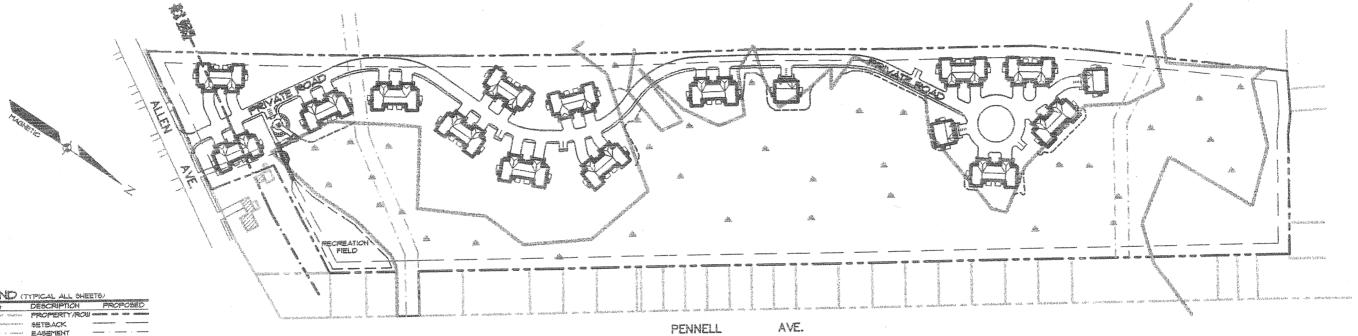

GRAPHIC SCALE

In the Company of T	TPICAL ALL SHE	
EXISTING	DESCRIPTION	PROPOSED
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深水中心有效性白色的	STREAM	
	ROCK OUTCROP	•
	EDGE PAVETEN	Ганинанализация
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CONFEROUS TREE

SILT FENCE MATCH LINE

SHEET INDEX


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- MASTER PLAN
- SITE PLAN I
- SITE PLAN 2
- PLAN & PROFILE !
- PLAN & PROFILE 2
- LANDSCAPE & LIGHTING PLAN I
- LANDSCAPE & LIGHTING PLAN 2
- DETAILS I
- DETAILS 2
- DETAILS 3

OWNER/APPLICANT: A.L.C. DEVELOPMENT CORP.
258 BLACK POINT ROAD
SCARBOROUGH, MAINE 84814

ENGINEER/SURVEYOR: SEBAGO TECHNICS, INC.



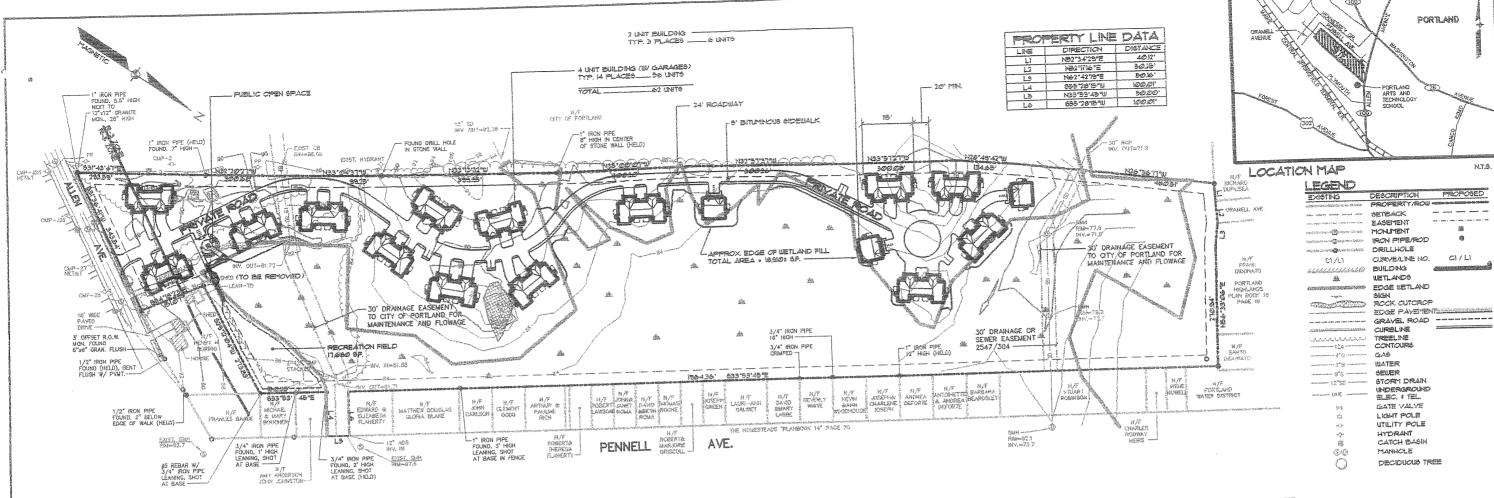

GENERAL NOTES

- RECORD COMER OF THE PROPERTY IS ALC DEVELOPMENT CORPORATION IN ACCORDANCE WITH A DEED RECORDED IN THE CUMBERLAND COUNTY REGISTRY OF DEEDS, PORTLAND, MAINE IN BOOK 14192, PAGE 320.
- 2. THE PROPERTY IS LOCATED ON THE CITY OF PORTLAND ASSESSOR'S PLAN NO. 345, BLOCK C, SHORIN AS LOTS 14 AND 25, AND ASSESSOR'S PLAN NO. 344, BLOCK D, LOT 5.
- 3. TOTAL AREA 136,656 SQUARE FEET, OR 26,69 ACRES.
- A PLAN REFERENCES:
 - A FLAN OF PROPERTY IN PORTLAND, MANE MADE FOR CITY OF PORTLAND, PORTLAND REGIONAL VOCATIONAL SCHOOL BY H LAND E. C. JORDAN, SURVEYORS, DATED 1973, REVISED INFOUSA JAKUST 12, 1976 CHILLE AT THE CITY OF PORTLAND ENGINEER'S OFFICE IN FILE NO. 1206/9.
 - PLAN OF LAW OF HENET NORING, ALLEN AVENUE D. PLAN OF LANG OF HENRY NORMS, ALLEN AVENUE, PORTLAND, MANE FOR BRAD GAITE ASSOCIATED MAY II, 1931 BY CIVIL COMBLIANTS BYSHEERS AND PLANNING, SOUTH SERUICK, MANE. PLAN IS UNRECORDED AND ON PILE AT CIVIL CONSULTANTS IN JOB FILE 26-218.
 - C. CITY OF PORTLAND, MANE, DEPARTMENT OF PUBLIC BUSING, RIGHT-CP-BLAY PLAY FOR PORTLAND FESIONAL VOCATIONAL TECHNICAL SCHOOL STORT SEUER BY THE CITY OF PORTLAND ENGINEERING DEPARTMENT DATED AUGUST 6, 1975, AN UNRECORDED PLAY ON PILE AT THE CITY OF PORTLAND ENGINEERING DEPARTMENT IN PLAY FILE NO. 668-9.
 - D. PORTLAND HIGHLANDS, PORTLAND, CAPBERLAND CONNTY, MANE CHIEFD BY HR LOUD LAND COMPANY, INC., FORMERLY CHIED BY GEORGE F. REED DATED JLLY 22, 1824 BY ERWEST WE BRANCH, CAVIL BY SMEER CHINCY, MASSACHUSETTS, CELLONDED IN THE CAPBERLAND COUNTY REGISTRY OF DEEDS IN PLAN BOOK 16, PAGE 19.
 - E. THE HOMESTEADS, PORTLAND, MANE CHIED BY THE CITY AND SUBURBAN LAND TRUST, PROVIDENCE, RHODE ISLAND, SURVEYED BY E. C. JORDAN & COMPANY, CIVIL ENGINEERS, PORTLAND, MANE DATED SEPTIFIER RQ, RECORDED IN SAID REGISTRY IN PLAN BOOK 14, PAGE 10.

3. SUBJECT TO:

- A. AN EASEMENT GRANTED BY HENRY N. AND BLANCHE B. NORMS TO C. H. LANGON & CO., N.C. AS DESCRIBED IN AN NORMS TO C. H. LANGON & CO., N.C. AS DESCRIBED IN AN NORMS TO C. H. LANGON AND RECORDED BY SAME THAT DEED A DESCRIPTION OF THE PARCEL THE SERVE AS PROVIDED STRIP OF LAND AS SHOUN HEREON CRUSSING THE NORTHEASTERLY BND OF THE PARCEL. THE PURPOSE OF SAID EASEMENT IS FOR THE CONSTRUCTION OF CURFACE WATER DRANG OR SEWERS, TOGETHER WITH THE RIGHT TO ENTER UPON SAID STRIP AT ANY AND ALL THES IN ORDER TO CONSTRUCT, MAINTAIN, REPAIR, REBUILD, OR RECONSTRUCT THE SAME.
- D. A STORM CENER EASEMENT TO FEET IN WIDTH AS SHOWN MEREON CROSSING THE SOUTHERLY BND OF THE PARCEL, SAID 20 FOOT WIDE STORM SHUER EASEMENT SHOWN ON THE PLAN REFERENCED IN NOTE AC. NO RECORD EASEMENT DEED FOR THIS EASEMENT WAS POUND IN SAID REGISTRY.

- THE PLAN AND SURVEY WERE PERFORMED IN CORPORTANCE WITH THE MAKE STATE BOARD OF LICENSURE FOR PROFESSIONAL LAND SURVEYORS, STANDARDS OF PRACTICE, CATEGORY I, CONDITION 2 WITH EXCEPTIONS:
 - BURYETOR'S REPORT BEING LIMITED TO THE NOTES AS
 - B. NO DETAILS DRAWN ON MONIMENTATION NOT HELD.
 - C. NO HEU DEED DESCRIPTION OR MONORMATION HAVING BEEN SET TO DATE.
- BEARINGS SHOWN HEREON ARE MAGNETIC NORTH OF 1886, REFERENCED
- ELEVATIONS SHOUN HEREON ARE BASED ON NATIONAL GEODETIC VERTICAL DARM OF HOS ESTABLISHED BY USING ASHTEC Z-D-GPS DUAL PREQUENCY RECEIVERS.
- 9. THIS PLAN MAY BE SUBJECT TO REVISION UPON RECEIPT OF A TITLE OPINION.
- 10. THE PROPERTY IS LOCATED IN THE R-3 AND R-5 ZONES.
- וו פיישכים איני פער אבימוויפיים ווי

R-3 ZONE:

	ಶಿವಲಲ	Qr.
MINIMUM LOT SIZE	50-FT.	
MINIM STREET FRONTAGE	35-FT.	
THE REAL PROPERTY VICTOR		
THE PARTY OF ADVISOR OF THE PARTY OF THE PAR	25-FT.	
THE RELEASE I PROPERTY.	8-F1.	
MINIMUM SIDE YARD (I STORY)	2-F7.	
(I/2 STORY)	14-F7.	
(2 510)(1 /		
(25 STORY)	俗千 7.	
	25%	
MAXIMIM LOT COVERAGE	TA-FT.	
	35-FT.	
1 111 3 1 105 1 10 4 1 1 1 1 1 1 1 1 1 1 1 1 1 1 1 1	22-11.	

HAXINIM STRUCTURE HEIGHT————————————————————————————————————	
R-5 ZONE: MINITUR LOT SIZE MINITUR STREET PRONTASE MINITUR STREET PRONTASE MINITUR SCAR Y ARD MINITUR SCAR Y ARD MINITUR SCAR Y ARD (1) STORY) (2 STORY) (2 STORY) (2) STORY) MINITUR DISTANCE SETILEER BUILDING MAXIMUM LOT WIDTH VILLIPLEXO (OTHER WESS) MAXIMUM STRUCTURE MEIGHT MAXIMUM STRUCTURE MEIGHT MAXIMUM STRUCTURE MEIGHT MAXIMUM STRUCTURE MEIGHT	6000 SF. 50-FT. 20-FT. 30-FT. 8-FT. 8-FT. 14-FT. 14-FT. 40% 20-FT. 50-FT. 140-FT. W MTERNAL GARAGES

- NET RESIDENTIAL CALCULATIONS. NET RESIDENTIAL CALCULATION

 TOTAL LOT AREA

 STORMLATER DETENTION AREA

 OUTSIDE OF WEILANDS

 ENSTRES WATERCOURSES

 NACCESSISIE AREAS

 WEILANDS

 AREAS BENCHMEIRED BY EXISTING

 EAST-BENCHMEIRED BY EXISTENCE

 EXISTENCE 26 Ø3 Ac 0B 40 - SLOPES OF 15% OR GREATER -0 Ac. BETOTAL 256 Ac.
 102 of BUSTOTAL LAND AREA 1028 AC.
 HET RESIDENTIAL LAND AREA 1028 AC.
 HAWMUM NO. OF WHITS ALLOWED AT VISBOD SP. 98 WHITS
 MUTBER OF WHITS PROPOSED 52 WHITS 236 Ac. 1028 Ac. (446,054 8F.)
- 3. OPEN SPACE REGISTEPENTS: 300 SEANT 300x61 = 8500 SF, OF WHICH A MENTAL OF 6,000 SF, (50×100) MINT BE A MILTI-FURPOSE MOUED FIELD.
- 14. OPEN SPACE PROVIDED:
 PUBLIC OPEN SPACE = 6.484 SF.
 PECREATION HELD = 11.680 SF.
 TOTAL = 24/64 SF.
- B. THE PRIVATE ROAD WILL BE BUILT TO CITY OF PORTLAND STANDARDS FOR MATERIALS AND CROSS-SECTIONAL DEPTHS. IT SHALL BE THE RESPONSIBILITY OF THE WASHINGTON CROSSING CHERG ASSOCIATION FOR PLANTANCE, REPAIR OF THE ROADWAY AND CONTRIBUTATION CONTRIBUTION. OWNERS ASSOCIATION FOR PAINTESAN AND SIDEUALK, AND SHOW REMOVAL
- 16. THE ENTIRE SITE SHALL BE DEVELOPED AND/OR MAINTANED AS DEPICIED ON THE SITE/PHASNIS PLAN. APPROVAL OF THE PLANNIS AUTHORITY OR PLANNIS BOARD SHALL BE REQUIRED FOR ANY ALTERATIONS TO OR DEVIATIONS FROM THE APPROVED SITE PLAN, INCLUDING SITHOUT LIMITATION, TOPOCHAPHY, DRAHAGE, ACCESS, SIZE, LANDSCAPINS, RETENTION OF BOODED OR LAWA REAS, AND LOCATION AND SIZE OF BUILDINGS.
- 11. AS PART OF THIS APPLICATION A SEPARATE LANDSCAPING PLAN HAS BEEN SEPTITED FOR REVIEW IN LIEU OF THE REQUIREMENT OF TWO INCES MINIMIT FER LOTANIT. ALL LANDSCAPING SHALL MEET THE CITY'S ARBOROLLINEAL SPECIFICATIONS AND STANDARDS OF PRACTICE AND LANDSCAPE DESIGN GUIDELINES. THE DEVELOPER MAY CONTRACT FOR THE PLACETHAY OF LANDSCAPING, BUT SHALL RETIAN LABLE TO THE CITY OF PORTLAND FOR FRANCIAL OBLIGATION FOR COTT-LANDS WITH CITY OR DIMANCES AND AFFROYALD. SUCH PRANCIAL OBLIGATION SHALL BE NEITHER TRANSFERABLE NOR WAIVERABLE BY THE DEVELOPER.
- IS, THE ACTIVE RECREATION AREA SHALL BE FOR THE USE OF ALL THE HOMEOUNERS ASSOCIATIONS BOUNDED BY AGREEMENT, OR DOOLNENTS, TO WASHINGTON CROSSING CONDOMINATIONS.
- NO. ALL ELECTRIC, TELEPHONE AND CARLE T.Y. GERY/CES SHALL SE INDERCASONS AND IN CORPORMANCE WITH CENTRAL MAN'E POWER CO. BELL ATLANTIC TELEPHONE CO. AND THE WARRER CASLE T.Y. CO. STANDARDS.


- 20, ALL WATER MANS, SERVICES AND ASSOCIATED APPRIENTACES SHALL SE IN CORPORTANCE WITH PORTLAND WATER DISTRICT STANDARDS.
- 21. ALL EROBION AND SEDIMENT CONTROL MEASURED SHALL SE INSTALLED IN ACCORDANCE WITH THANK EROSION AND SEDIMENTATION CONTROL HANDSOOK FOR CONSTRUCTIONS DESTINATION OF PRECINCES PRELIGHED BY THE GARBER AND COUNTY SOIL, AND WATER DESTINATION OF PROPERTIES THANKED HES OR LATEST EDITION. IT SHALL BE RESERVISEDLITY OF THE CONTRACTOR TO POSSES A COPY OF THE EROSION CONTROL PLAN AT ALL, THESE
- 4. PRIOR TO ANY BLASTING, THE APPLICANT AND/OR CONTRACTOR SHALL NECESSARY BLASTING PERSITTS PROM THE CITY OF PORTLAND FIRE DEPARTMENT.

 AND CODE ENFORCEMENT DEPARTMENT.

AFFROVAL-

CITY OF PORTLAND

PLANNING BOARD

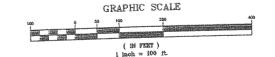

G SMF 4-8-99 REVISE PER PLAN REVIEW COMMENTS
F SMF 2-25-99 REVISE SITE PLAN SUBMISSION TO CITY
E SMF 2-5-99 SITE PLAN SUBMISSION TO CITY
D JRP 1-28-99 LAYOUT REVISIONS
G JRP 9-25-98 RESUBMITTED FOR PLANING BOARD REVIEW
D 1-21-08 LAYOUT BEVERICING


THIS PLAN SHALL NOT BE MODIFIED WITHOUT WRITTEN PERMISSION FROM SEBAGO TECHNICS, INC. ANY ALTERATIONS, AND WITHOUT DO SEBAGO TECHNICS, WITHOUT LABOUTY TO SEBAGO TECHNICS, WITHOUT DO SEBAGO TECHNICS,


Waster Flah WASHINGTON CROSSING CONDOMINUMS ALLEN AVENUE PORTLAND, MAINE


ALC DEVELOPMENT CORP. 258 BLACK POINT ROAD SCARBOROUGH, MAINE 04074





DESIGN BY: A.W/SMF DRAWN BY: TFH DRAWN BY: TEH CHECKED BY: SMF 10-10-9 1"=100" FIELD BK: 599 PROJ. NO: 97380 ng & Planning for the Puturs 12 WESTBROOK COMMON SHEET 2 OF 1

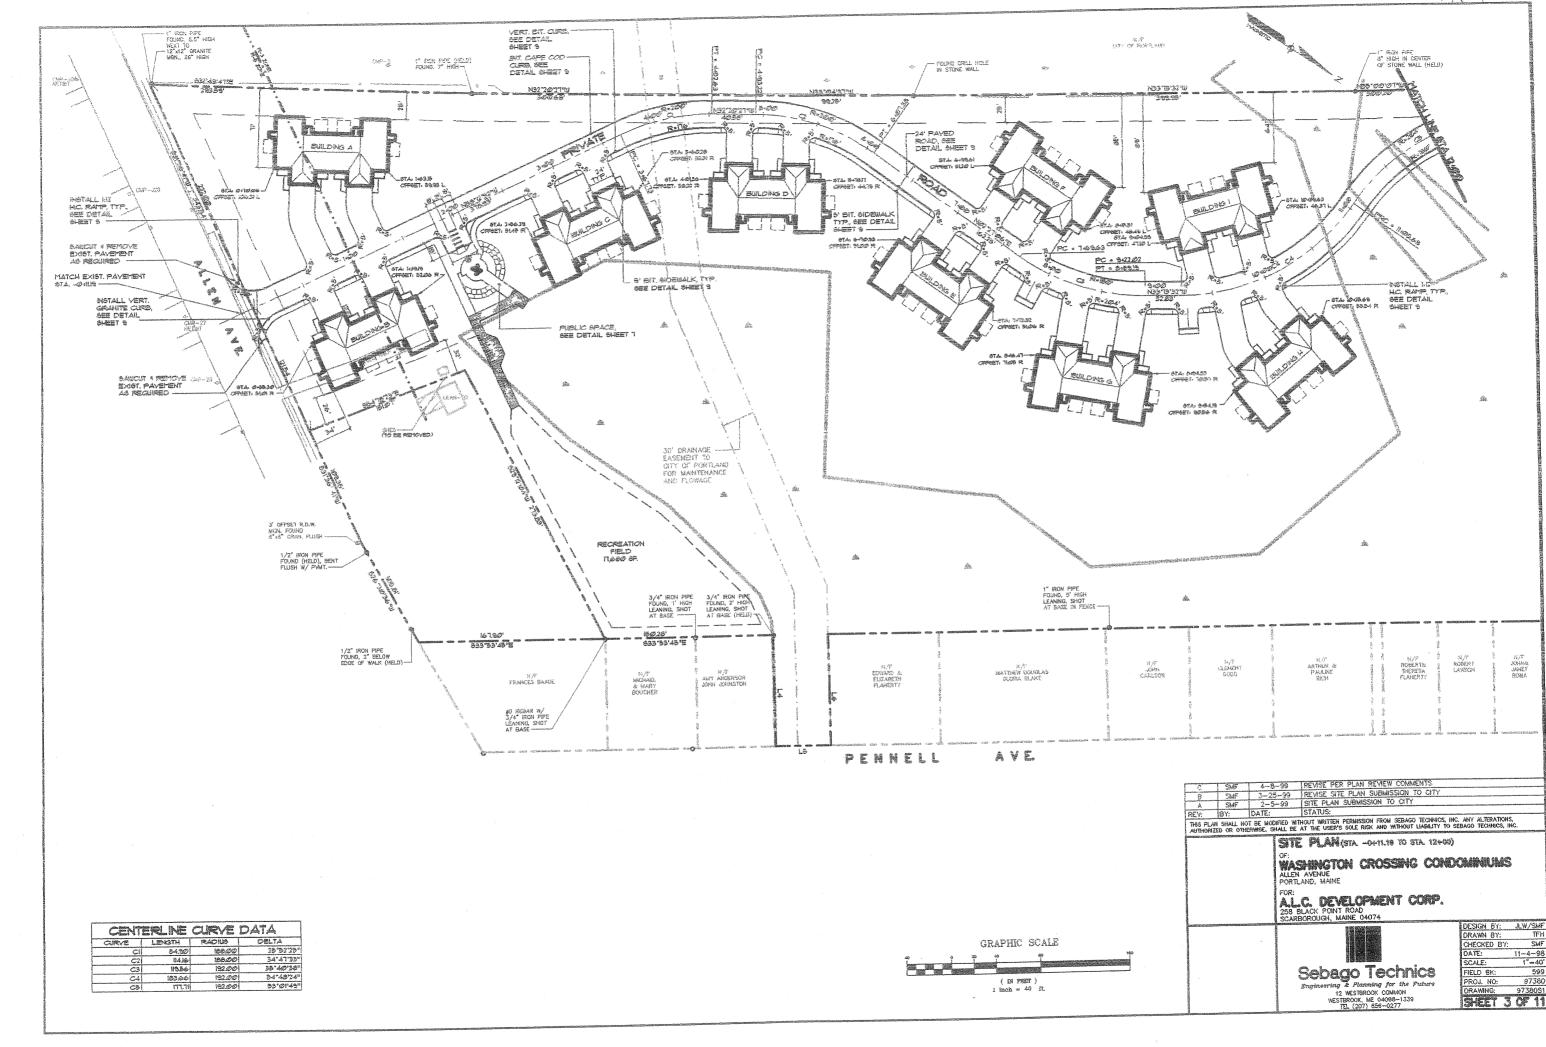


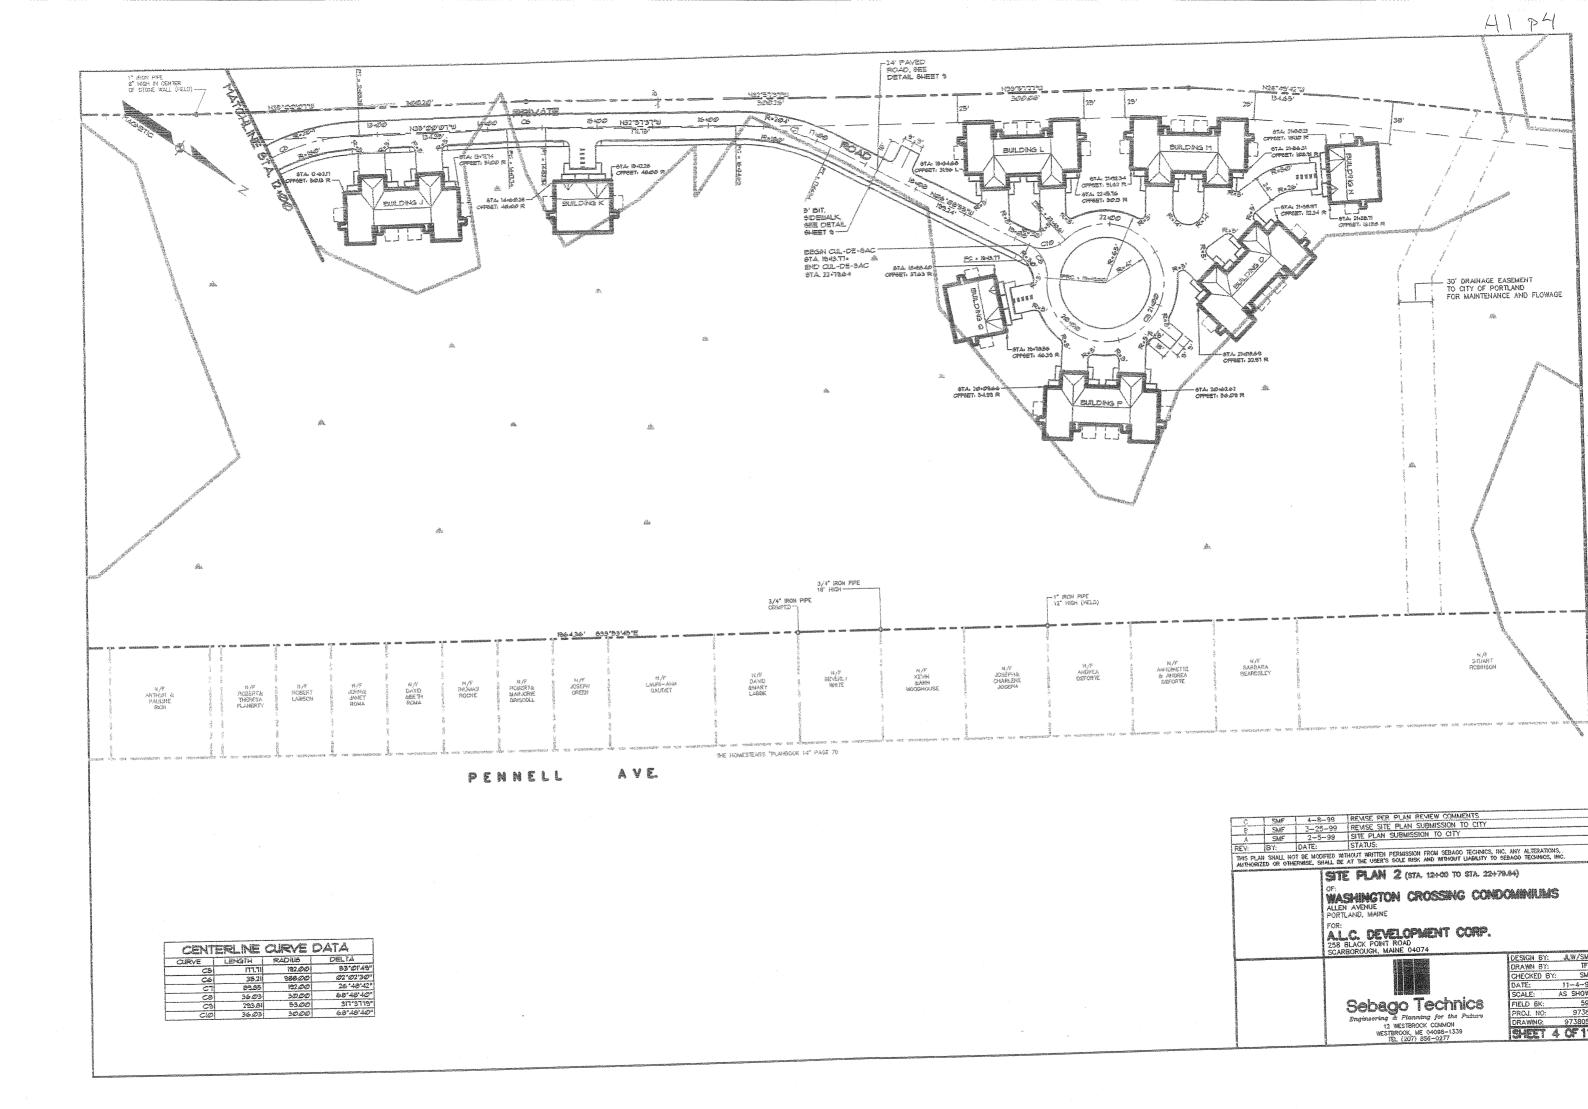


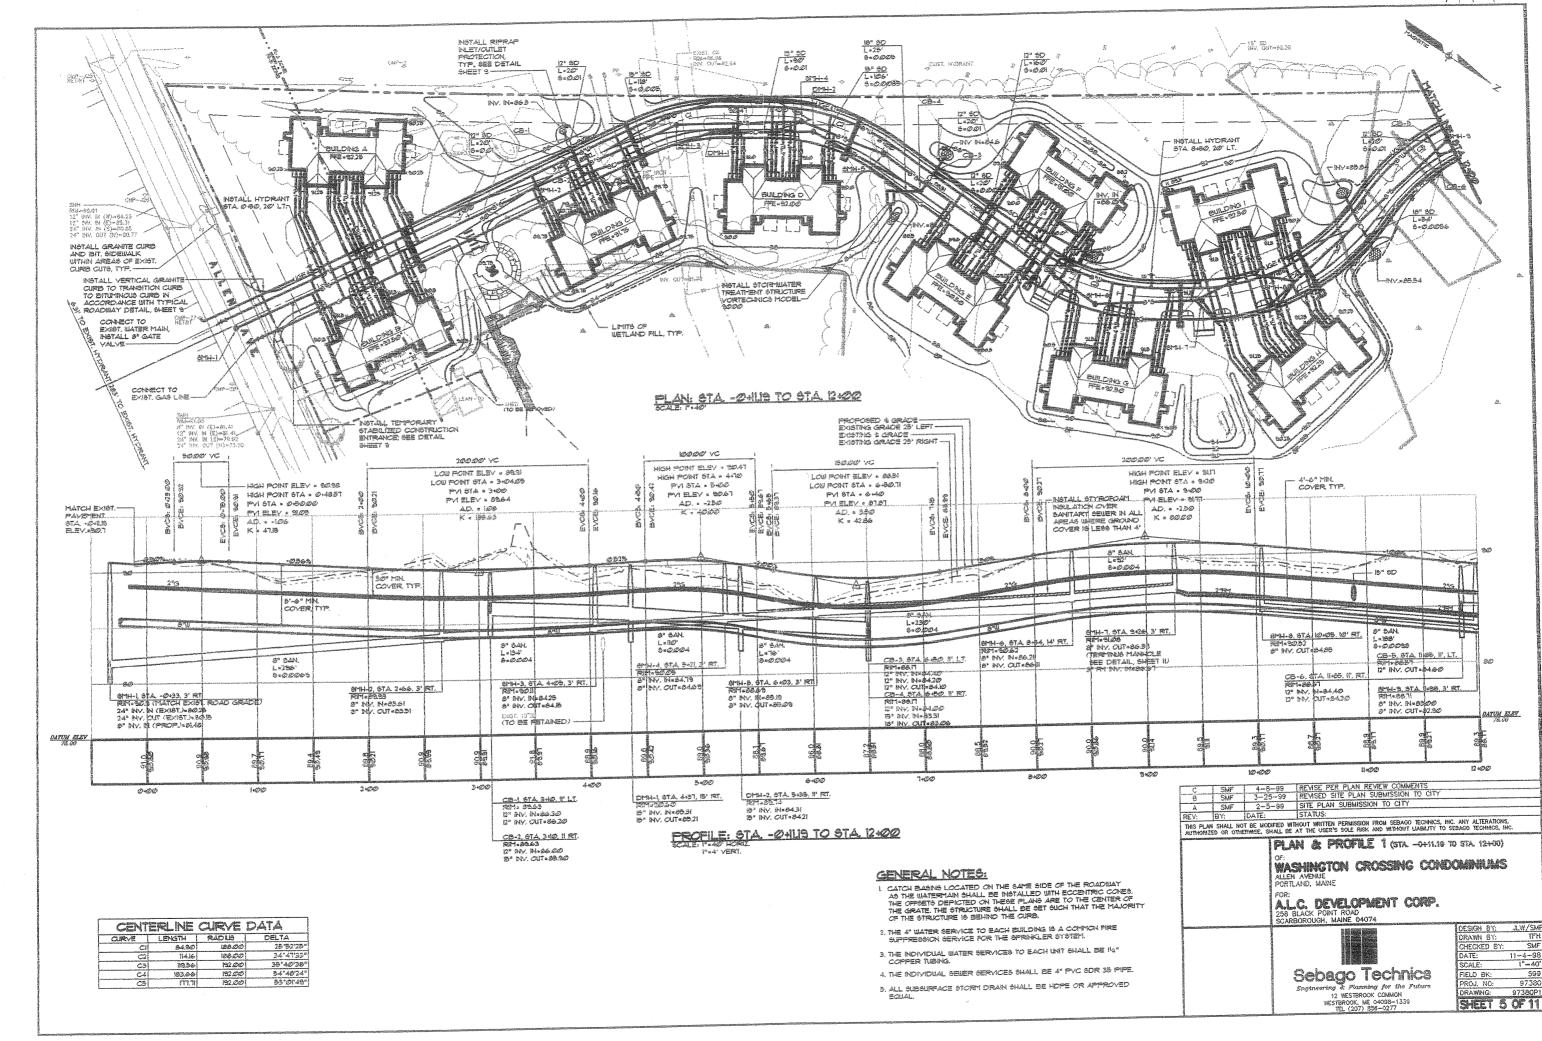

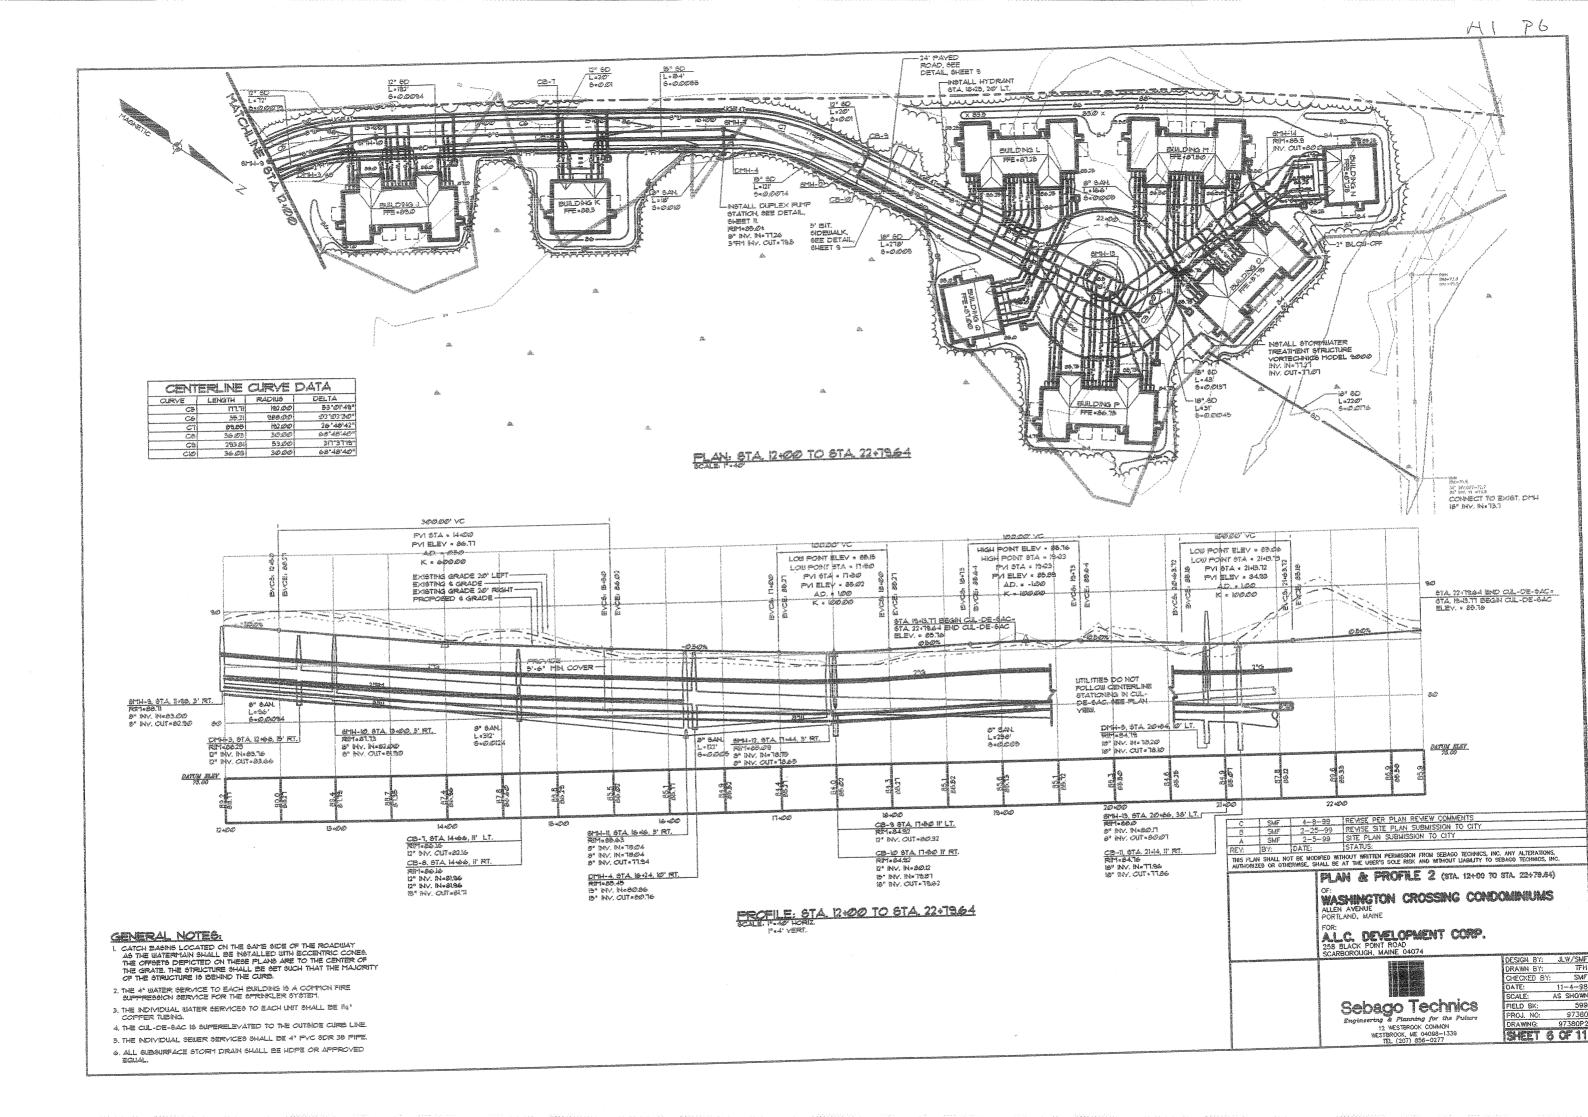

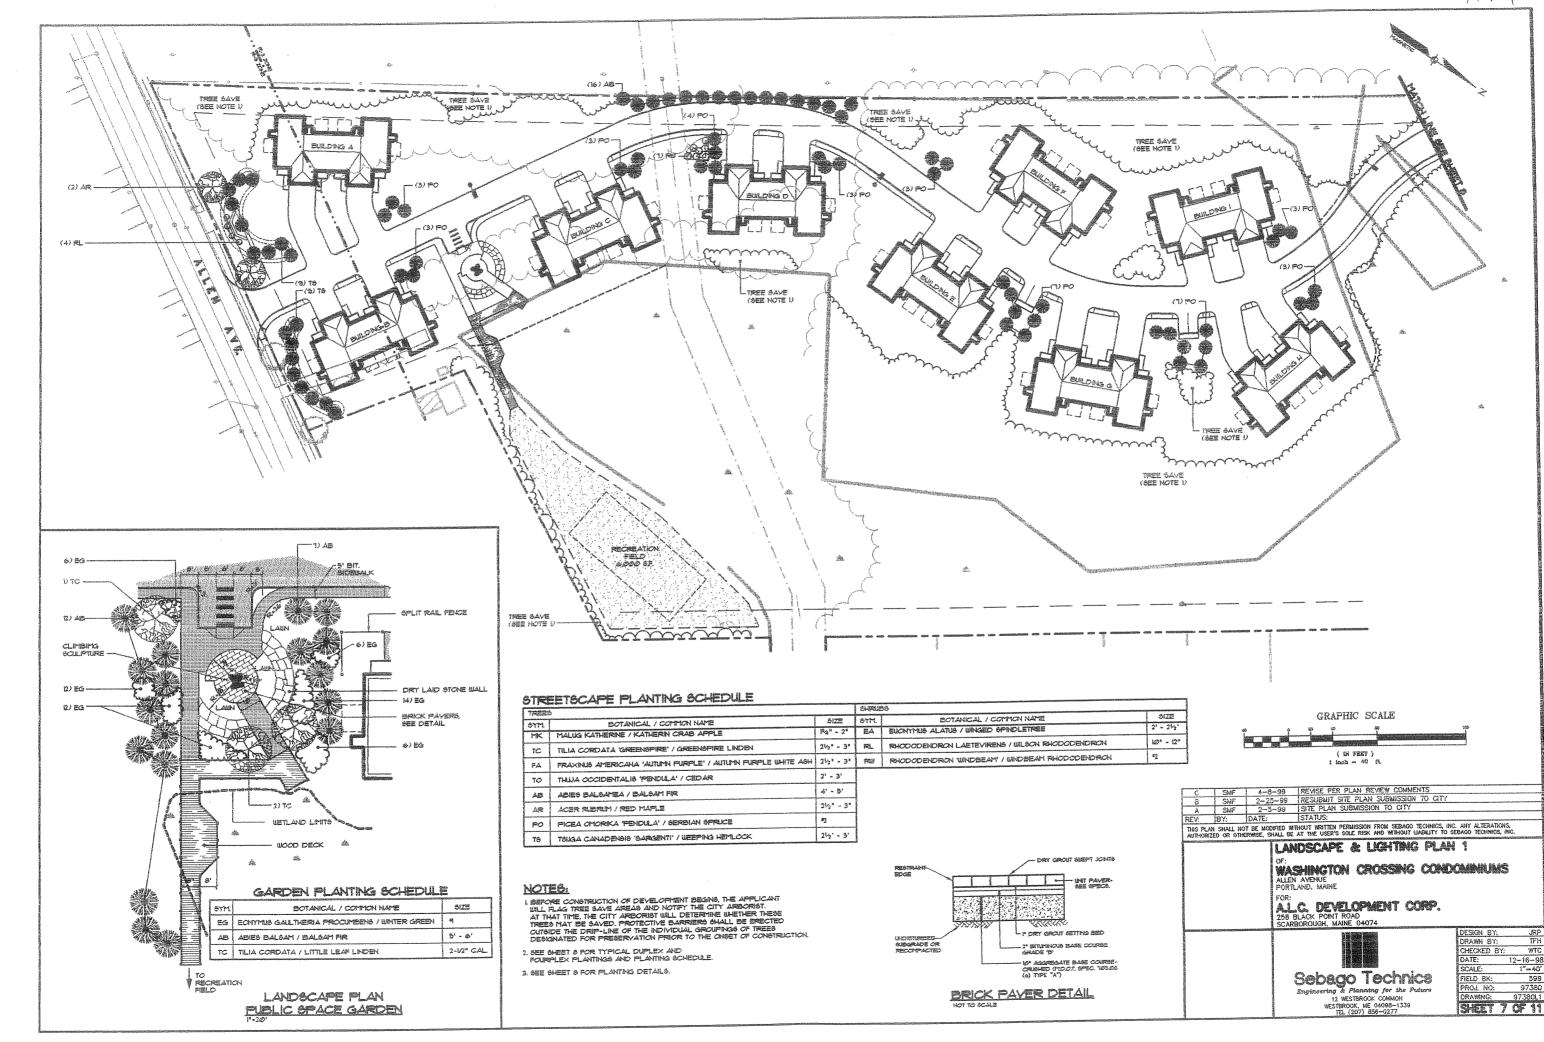

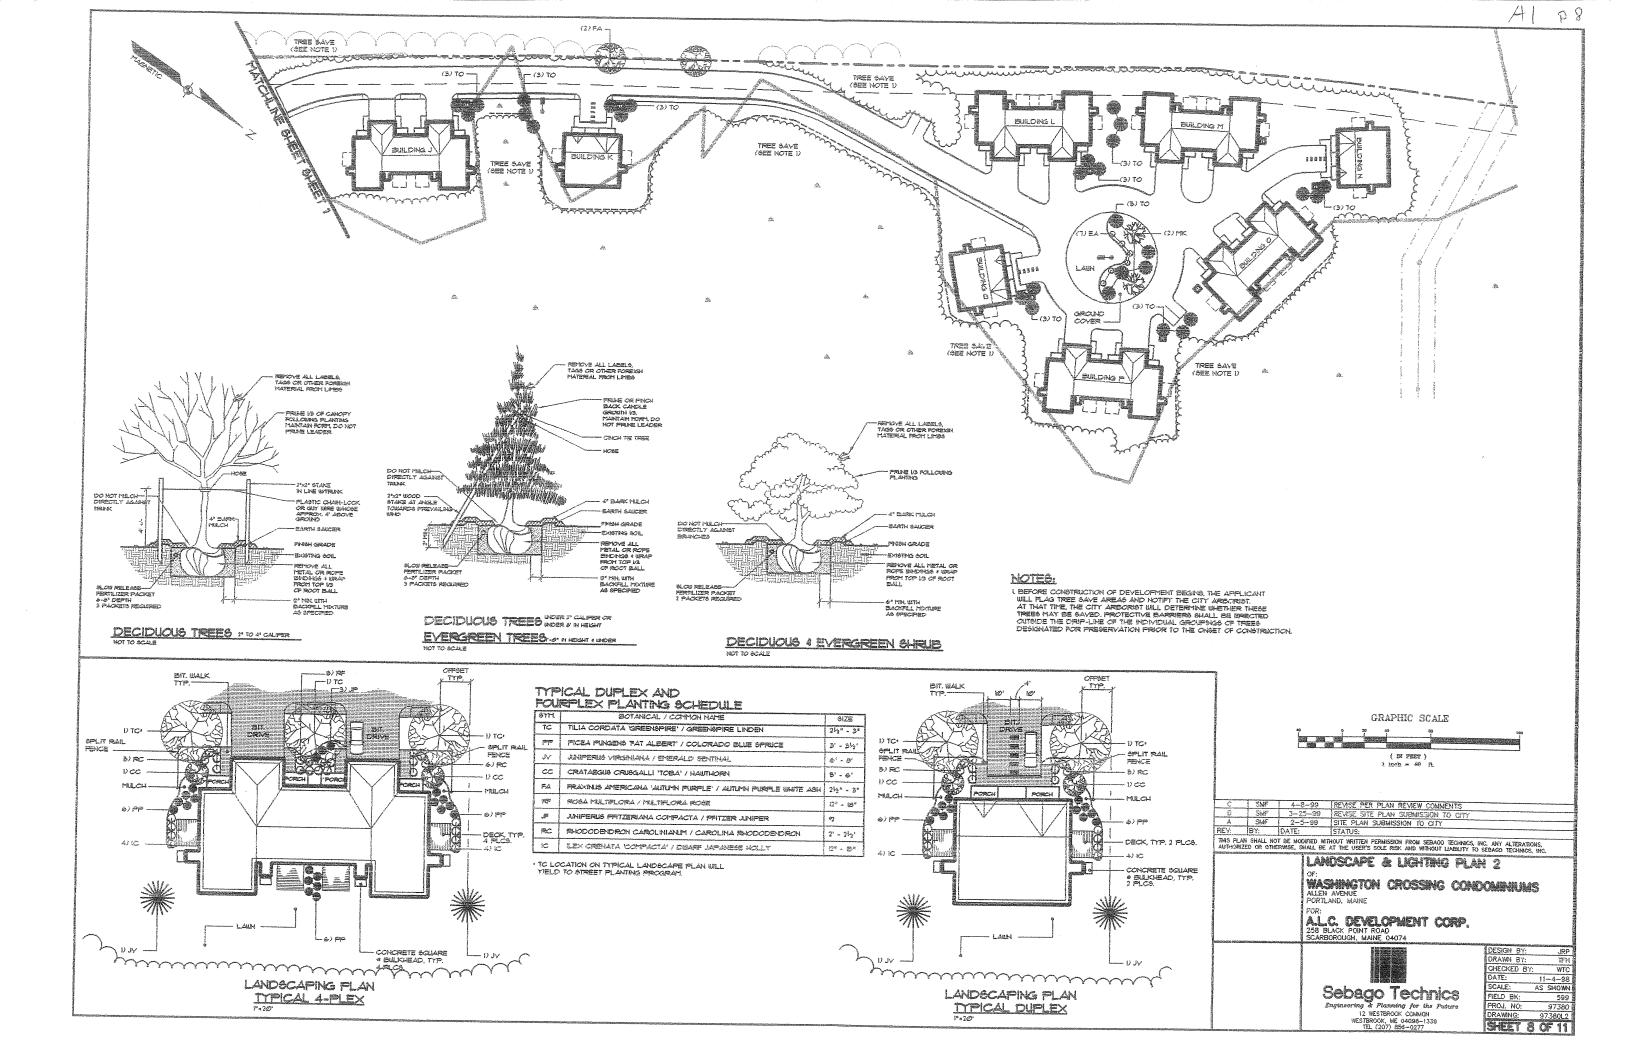

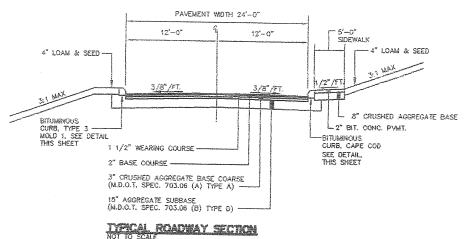

1/4"/FT.

- 1 1/2" WEARING COURSE

3" CRUSHED AGGREGATE BASE COARSE (M.D.O.T. SPEC. 703.06 (A) TYPE A)

TRANSITION


DRIVEWAY


SIDEWALK

2" BASE COURSE

2" HOT BITUMINOUS 1" LIFTS, TYPE C 10" AGGREGATE SUBBASE M.D.O.T. SPEC. 703.06

BILLMINGIS STEWALK NOT TO SCALE

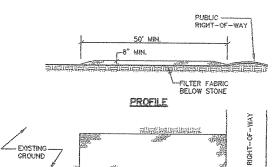

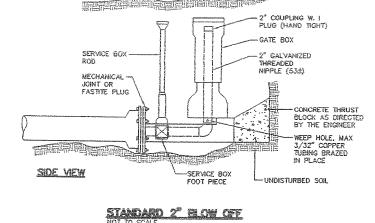

GALVANIZED 2"-90" ELL W/ RISER -

GALVANIZED 2" NIPPLE

TOP VIEW

NOTE: OFFSETS MAY BE USED ONLY IF ACCEPTABLE TO THE ENGINEER

NOTE: IF ANY HYDRANT

EXTENSION IS REQUIRED SPACERS SHALL BE INSTALLED FROM THE BOTTOM OF THE HYDRANT

WALL OF TRENCH (UNDISTURBED) ---

2-18"X12"X4"X3" CONCRETE WEDGES OR AS DIRECTED BY THE ENGINEER -

-IRON PIPE W/ TOP SECTION CUT AWAY

TAKE CARE IN PLACEMENT OF HYDRANT WITHIN R.O.W. AND

- 10 FACE OF CURB (3' FOR EDGE OF PAVEMENT)


COORDINATE WORK WITH KENNEBUNK WATER DISTRICT

2" FLANCE TO


FINISH GRADE

ON A PROPERTY

©

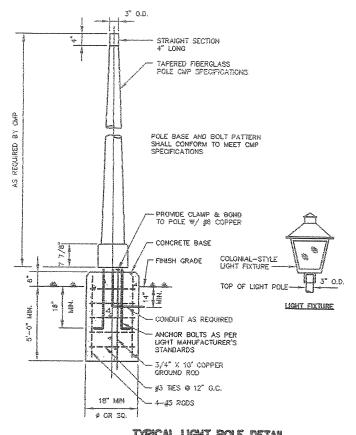

15" AGGREGATE SUBBASE (M.D.O.T. SPEC. 703.06 (B) TYPE D) BITIMINOUS CURR SECTION (TYPE 3, MOLD 1) NOT TO SCALE

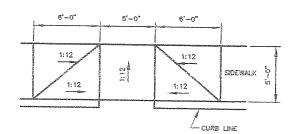

HANDICAP RAMP NOT TO SCALE

TRANSITION

APRON DIMENSIONS TO BE DETERMINED INFIELD BY OWNER AND TOWN ENGINEER PRIOR TO CONSTRUCTION

1. STONE SIZE- AASHTO DESIGNATION M43, SIZE NO. 2 (2 1/2" TO 1 1/2"). USE CRUSHED STONE.

PLAN


2 LENGTH- AS SHOWN ON PLANS, MIN. 50 FEET.

PROVIDE APPROPRIATE TRANSITION BETWEEN CONSTRUCTION ENTRANCE

AND PUBLIC R.O.W.

- 3. THICKNESS- NOT LESS THAN EIGHT (8) INCHES.
- WOTH- NOT LESS THAN FULL WIDTH OF ALL POINT OF INGRESS OR EGRESS.
- 5. MAINTENANCE— THE ENTRANCE SHALL BE MAINTAINED IN A CONDITION WHICH WILL PREVENT TRACKING OR FLOWING OF SEDWENT CHTO PUBLIC RIGHT—OF—WAY. THIS MAY REQUIRE PERIODIC TOP DRESSING WITH ADDITIONAL STONE AS CONDITIONS DEMAND AND REPAIR AND/OR CLEANOUT OF ANY MEASURES USED TO TRAP SEDIMENT. ALL SEDIMENT SPILLED, DROPPED, WASHED OR TRACKED ONTO PUBLIC RIGHT—OF—WAY MUST BE REMOVED IMMEDIATELY.

STABLIZED CONSTRUCTION ENTRANCE NOT TO SCALE

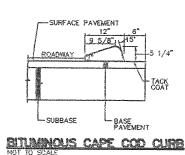

TYPICAL HYDRANT BLOCKING & REPLACEMENT


24"X18"X6" CONCRETE BLOCK

RIKKURUKUK


TYPICAL LIGHT POLE DETAIL 4"X8-1/2" FILTER FABRIC JOINT 1/4" ± 1/8" CRANITE CURS 4" LOAM & SEED/SOE " REVEAL PAVEMENT EXCAVATION INCIDENTA TO COST OF CURB - AGGREGATE BASE-CRUSHED, TYPE "A" 6" BASE SHALL BE COMPACTED TO A FIRM EVEN SURFACE PRIOR TO SETTING OF CURB -AGGREGATE SUBBASE SECTION

TYPICAL DRIVE APRON DETAIL WITH SIDEWALK NOT TO SCALE


PROVIDE 1" LIP AT STREET LINE

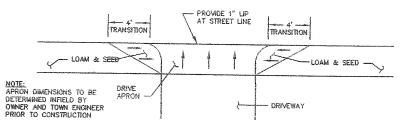

TYPICAL DRIVE APRON DETAIL WITHOUT STEWALK NOT TO SCALE

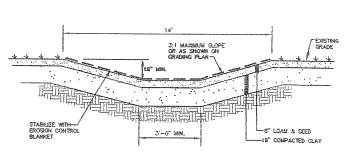

GRASSED SWALE

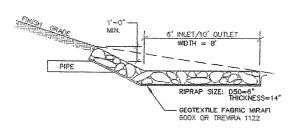


RPRAP CULVERT IN ET/CUTLET NOT TO SCALE

GRANITE CURB DETAIL

C	SMF	4-8-99	REVISE PER PLAN REVIEW COMMENTS
8	SMF	3-25-99	REVISED SITE PLAN SUBMISSION TO CITY
A	SMF	2-5-99	SITE PLAN SUBMISSION TO CITY
EV:		DATE:	STATUS:
HIS PLAN UTHORIZE	SHALL MOT D OR OTHE	de mochfied Rwise, shall e	MITHOUT WRITTEN PERMISSION FROM SEBAGO TECHNICS, INC. ANY ALTERATIONS. E AT THE USER'S SOLE RISK AND WITHOUT LIABILITY TO SEBAGO TECHNICS, INC.
		OF: ALLE POR POR 258	TALLS 1 SHINGTON CROSSING CONDOMINIUMS IN AVENUE PLAND, MAINE L.C. DEVELOPMENT CORP. BLACK POINT ROAD REGROUGH, MAINE 04074
			DESIGN 8Y: JLW/SMF


Sebago Technics

Engineering & Planning for the Puture
12 WESTBROOK COMMON
WESTBROOK, ME 04088-1339
TEL (207) 8858-0277 FIELD BK: PROL NO: DRAWING: SHEET 9 OF 11

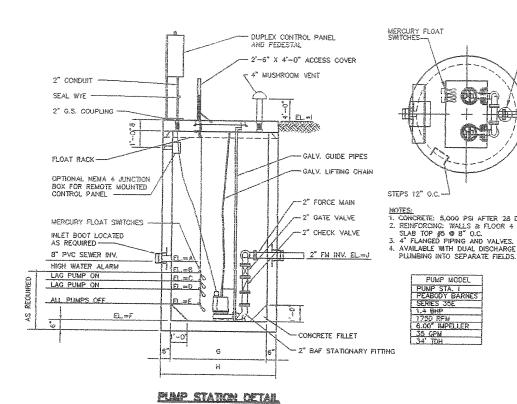

MEASUREMENT (fL) 75.76 75.26 74.26 73.26 6 77.26 76.28


PUMP STATION SCHEDULE

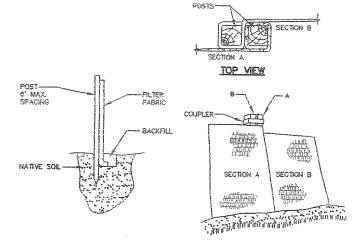

INSTALLATION:


- 1. EXCAVATE A 6"x 6" TRENCH ALONG THE LINE OF PLACEMENT FOR THE FILTER BARRIER.
- UNROLL A SECTION AT A TIME AND POSITION THE POSTS AGAINST THE BACK (DOMNSTREAM) WALL OF THE TRENCH.
- DRIVE POSTS INTO THE GROUND UNTIL APPROXIMATELY 2" OF FABRIC IS LYING ON THE TRENCH BOTTOM.
- 4. LAY THE TOE—IN FLAP OF FABRIC ONTO THE UNDISTURBED BOTTOM OF THE TRENCH, BACKFILL THE TRENCH AND TAMP THE SOIL. TOE—IN CAN ALSO BE ACCOMPLISHED BY LAYING THE FABRIC FLAP ON UNDISTURBED GROUND AND PILING AND TAMPING FILL AT THE BASE, BUT MUST BE ACCOMPANIED BY AN INTERCEPTION DITCH.
- 5. JOIN SECTION AS SHOWN ABOVE.
- 6. BARRIER SHALL BE MIRAFI SILT FENCE OR EQUAL

SILT FENCE NOT TO SCALE

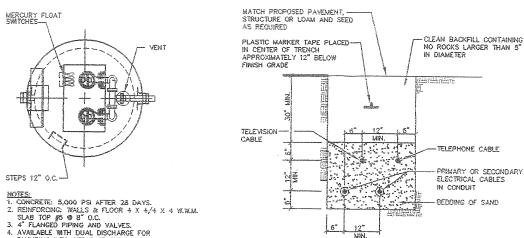

CABLES TO BE ENCASED IN SCHEDULE 40 PVC CONDUIT WHEN BUN BENEATH PAVED AREAS.

TYPICAL UNDERGROUND CARLE INSTALLATION

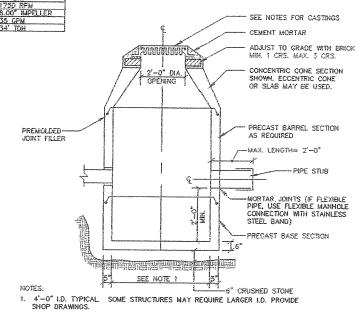


- 2. DRAINAGE STRUCTURES TO BE DESIGNED FOR H-20 LOADING
- J. PIPE SIZES AND INVERTS AS NOTED ON PLANS


PUMP MODEL

- CATCH BASIN FRAME AND GRATE TO BE ETHERIDGE FOUNDRY M248G OR APPROVED EQUAL.
- 5. DRAINAGE MANHOLE FRAME AND COVER TO BE ETHERIDGE FOUNDRY M248S OR APPROVED EQUAL. COVER SHALL BE MARKED "DRAIN".

TYPICAL CATCH BASIN

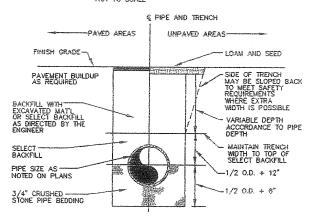


TYPICAL TRENCH SECTION

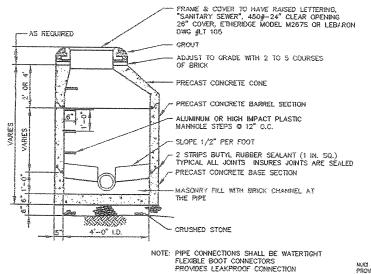

PRECAST MANHOLE




EMBEDDING DETAIL

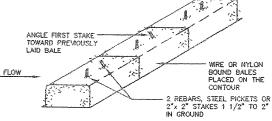

ANCHORING DETAIL

- BALES SHALL BE PLACED IN A ROW WITH ENDS TIGHTLY ABUTTING THE ADJACENT BALES.
- 2. EACH BALE SHALL BE EMBEDDED IN THE SOIL A MINIMUM OF 4"
- 3. BALES SHALL BE SECURELY ANCHORED IN PLACE BY STAKES OR REBARS DRIVEN THROUGH THE BALES. THE FIRST STAKE IN EACH BALE SHALL BE ANGLED TOWARD PREVIOUSLY LAID BALE TO FORCE BALES TOGETHER.
- 4. INSPECTION SHALL BE FREQUENT AND REPAIR OR REPLACEMENT SHALL BE MADE PROMPTLY AS NEEDED.
- BALES SHALL BE REMOVED WHEN THEY HAVE SERVED THEIR USEFULNESS SO AS NOT TO BLOCK OR IMPEDE STORM FLOW OR DRAIMAGE.

HAY BALE BARRIER

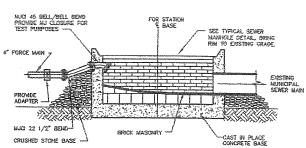


FORCE MAIN TERMINUS MANHOLE


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В	SMF	3-25-99	REVISE SITE PLAN SUBMISSION TO	
A	SMF	2-5-99	SITE PLAN SUBMISSION TO CITY	
REV:	BY:	DATE:	STATUS:	
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			C. CEVELOPMENT CO ACK POINT ROAD OROUGH, MAINE 04074	
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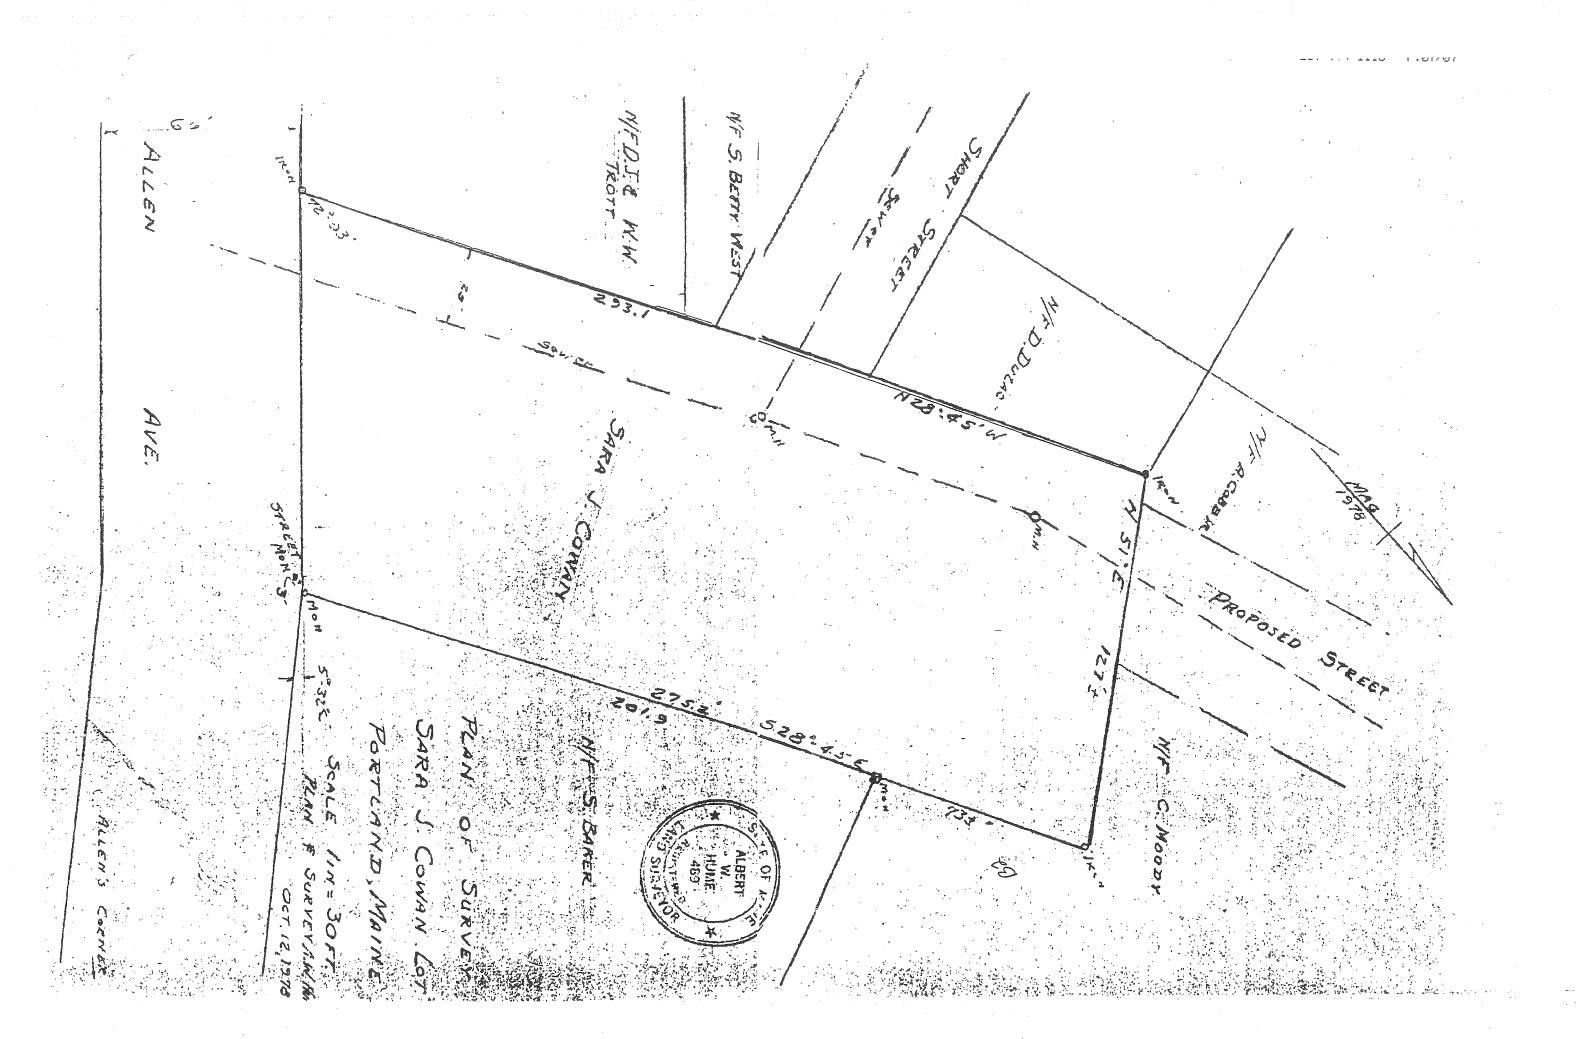
DESIGN BY: DRAWN BY: AS SHOW PROJ. NO: 97380 SHEET 10 OF 11




AH. 16

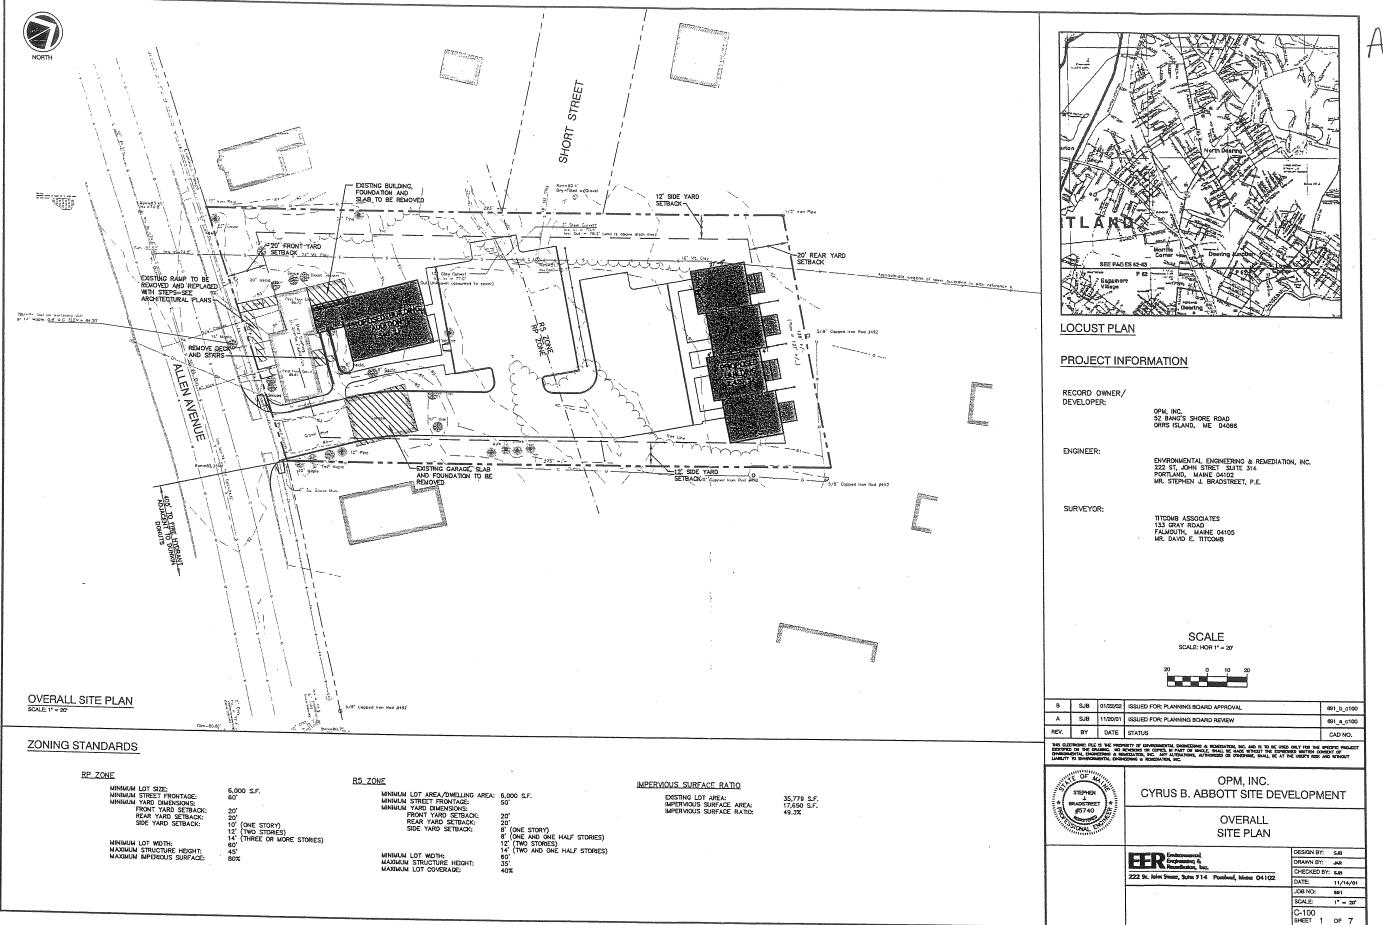

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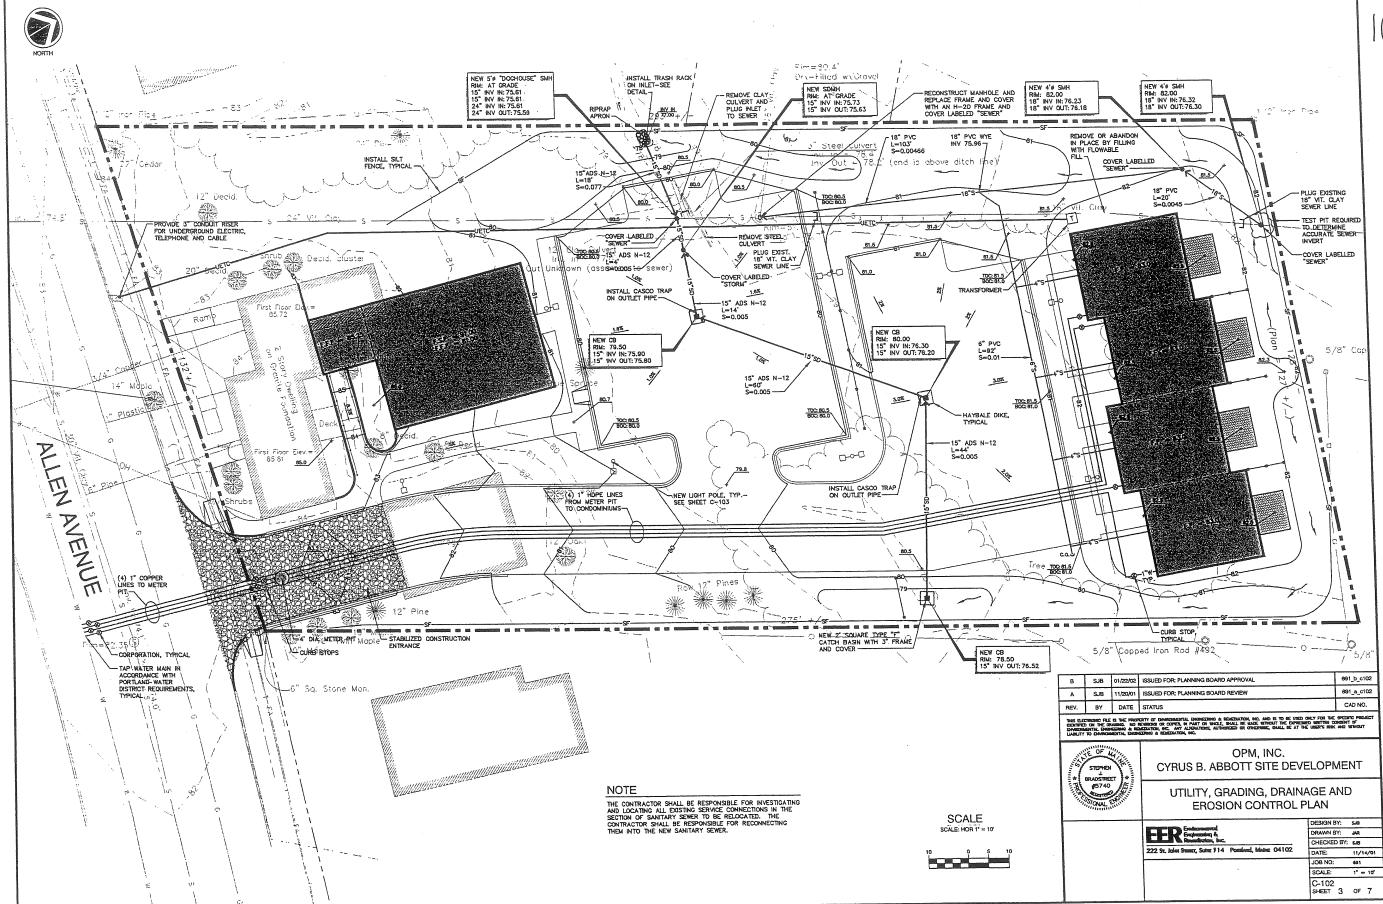


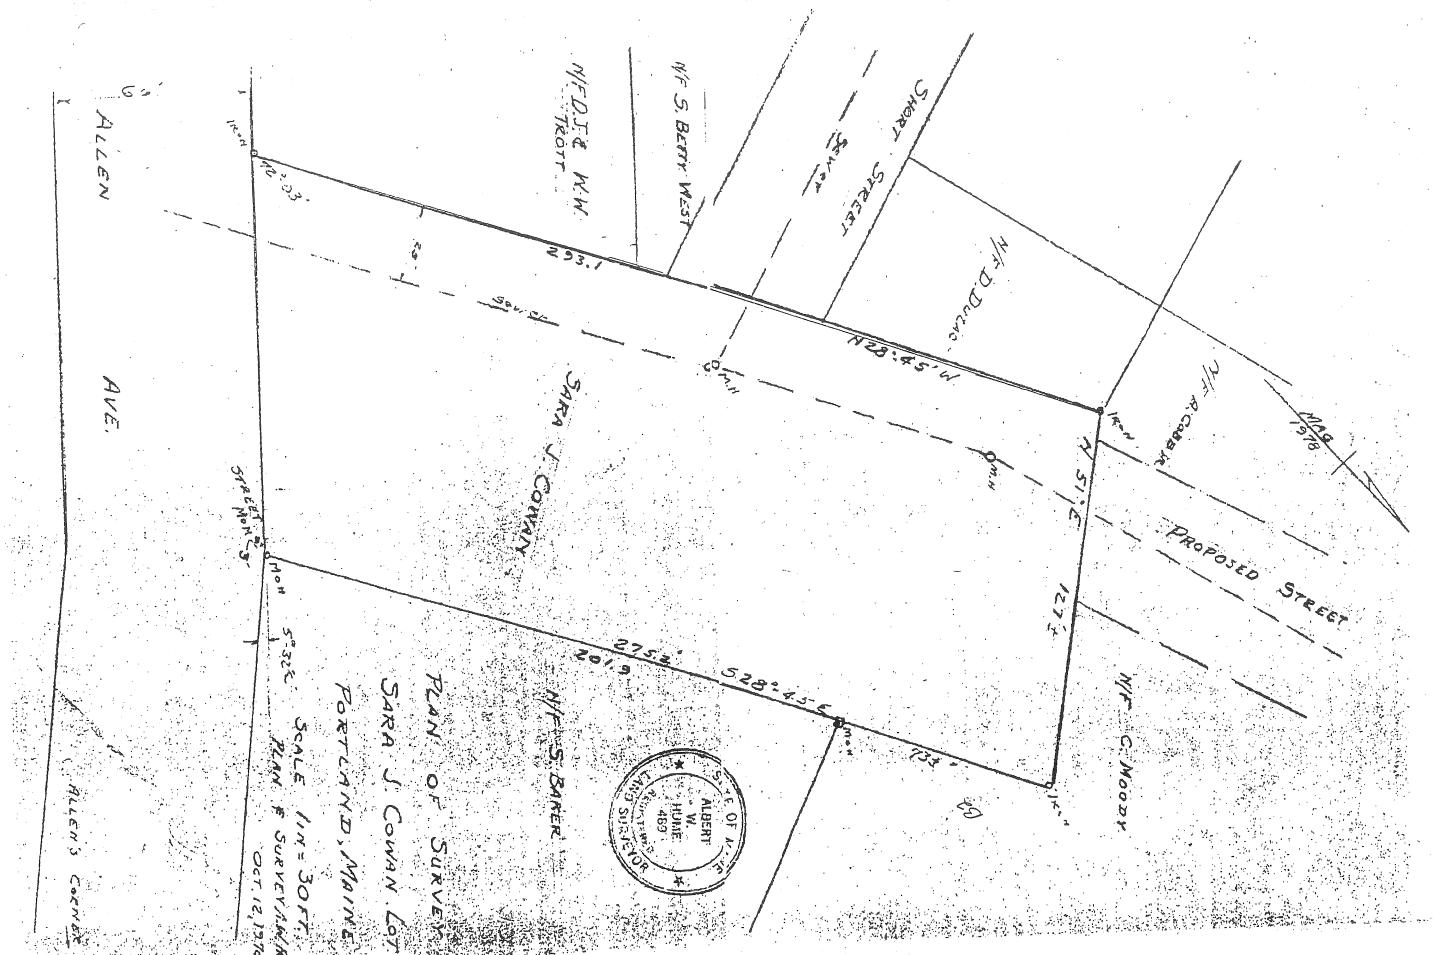


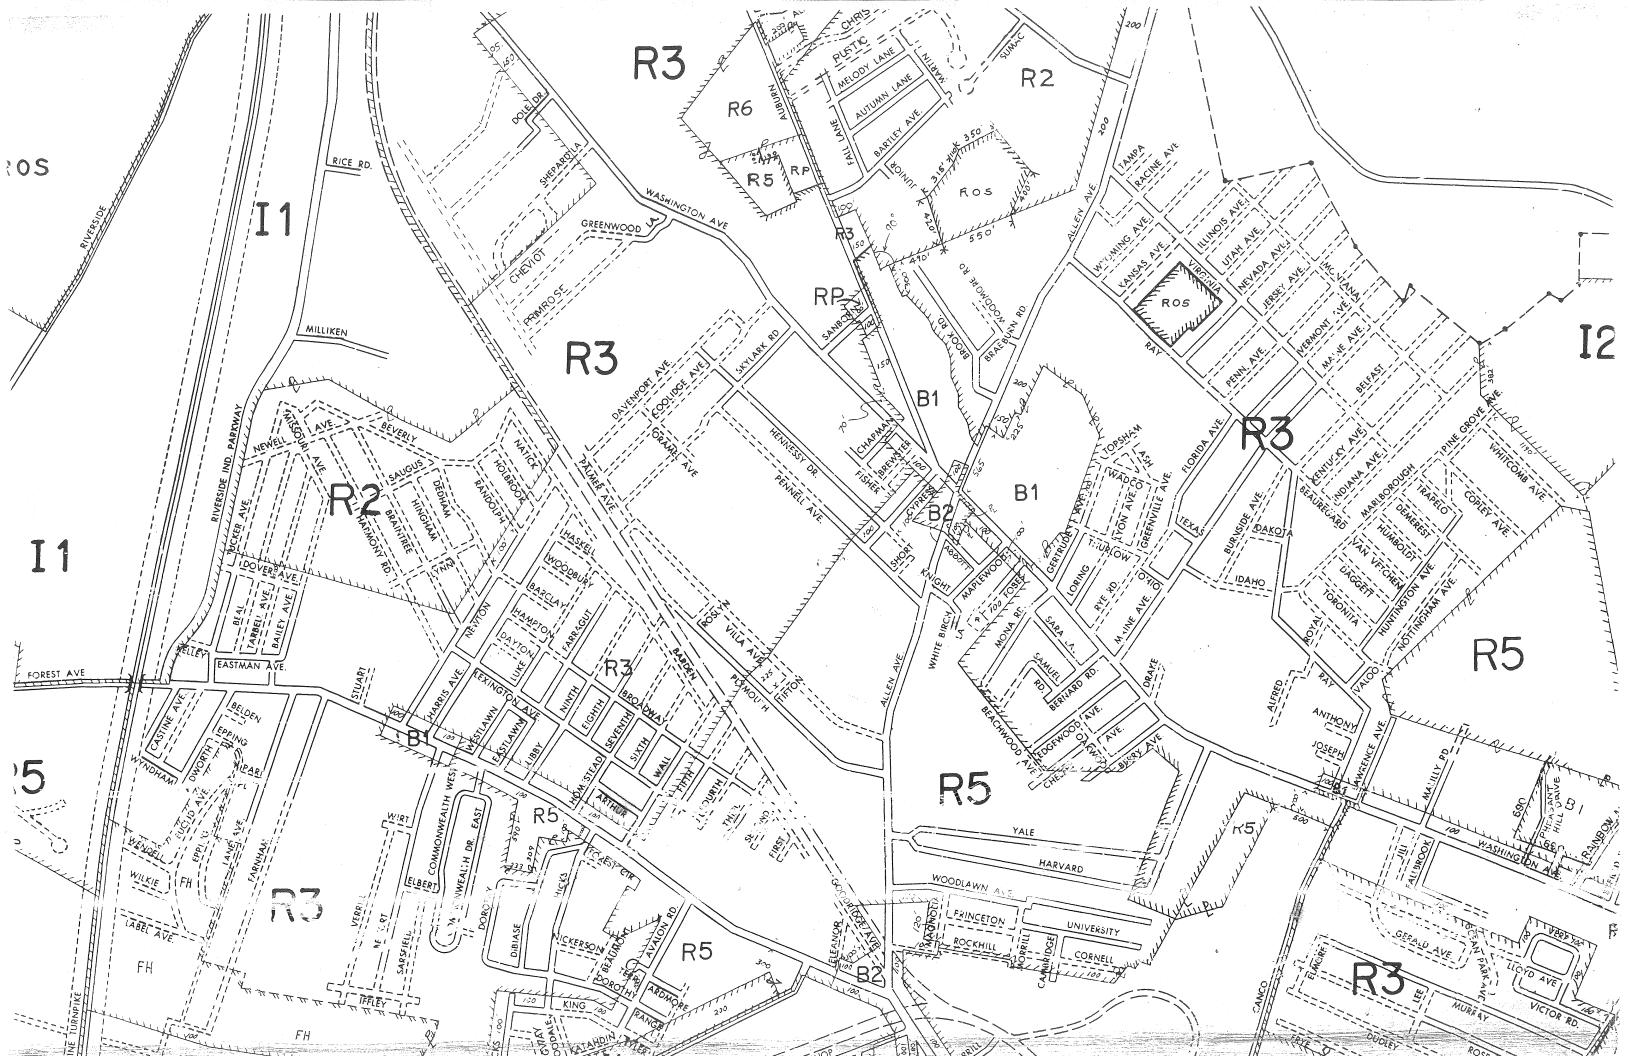



WEST ELEVATION



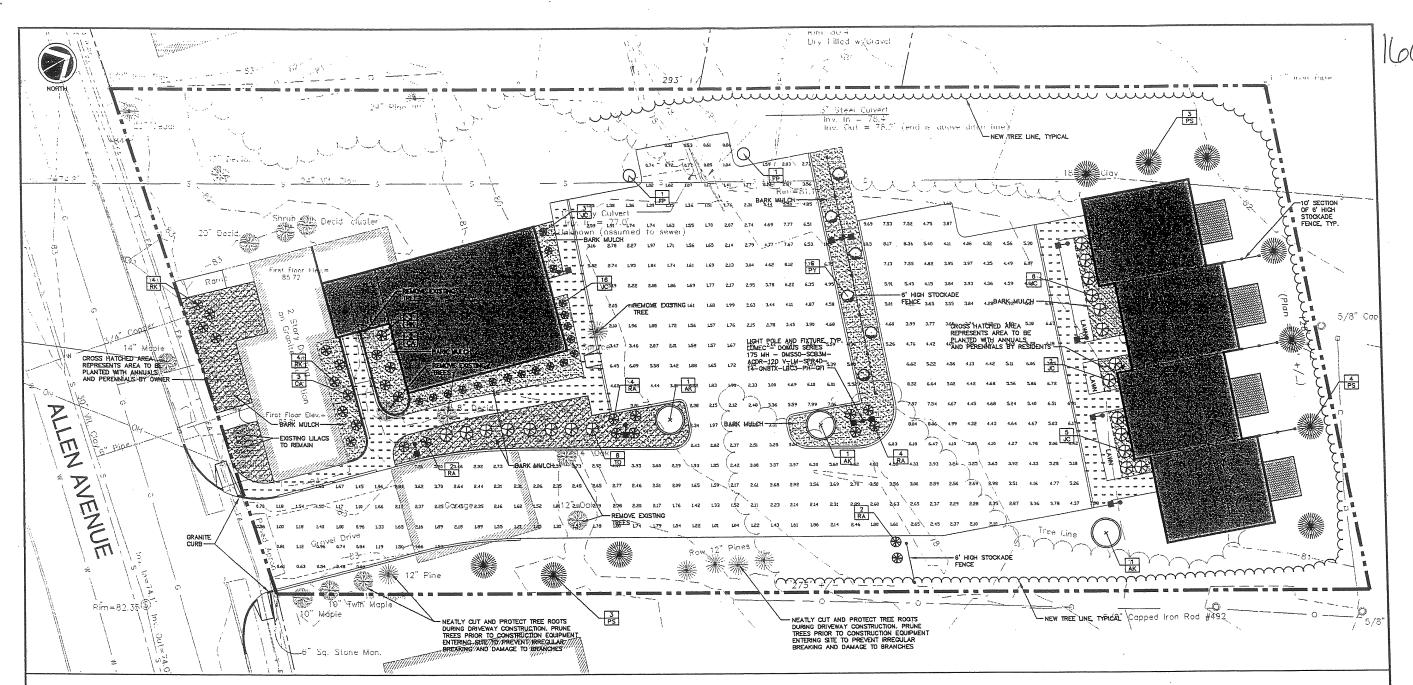

PLANTING NOTES

- 1. THE LANDSCAPE CONTRACTOR IS ADMISED OF THE POSSIBILITY OF UNDERGROUND UTILITIES. THE LANDSCAPE CONTRACTOR SHALL VERIFY UTILITIES PRIOR TO COMMENCING CONSTRUCTION.
- THE LANDSCAPE CONTRACTOR SHALL BE RESPONSIBLE FOR REPAIRING ANY UTILITIES, WALKS, PAYING, CURBING, ETC., DAMAGED IN THE PERFORMANCE OF THIS JOB AT NO COST TO THE OWNER.
- 3. PLANTING OF TREES AND SHRUBS SHALL NOT OCCUR UNTIL ALL GRADING AND PAYING IS COMPLETED.
- 4. ALL PLANTS SHALL HAVE A NORMAL HABIT OF GROWTH FOR THE SPECIES AND SHALL BE SOUND, HEALTHY AND FREE OF DISEASE AND INSECTS. THEY SHALL CONFORN TO THE MEASUREMENTS ON THE PLANT LIST AND SHALL CONFORM TO ANSI Z60.1 — NURSERY STOCK, LATEST REMSION.
- 5, ALL PLANTS SHALL HAVE ALL NONBIODEGRADABLE MATERIALS (STRING, WIRE, POTS, ETC.) REMOVED AT THE TIME OF PLANTING. CIRCLING ROOTS OR ROOTS THAT WOULD LATER GROLE THE PLANT SHALL BE STRIAGHENED, CUT OR THE ROOT BALL SHALL BE CUT UTULIZING THE "BUTTERFLY METHOD." TOP 1/3 OF WIRE BASKETS AND BURLAP ON TREES SHALL BE CUT AND REMOVED.
- 6. BACKFILL MIX SHALL BE COMPOSED OF A 80/20, LOAM/PEAT MOSS MIX. PLANTING PITS SHALL BE EXCAVALTED TO THREE TIMES THE DIAMETER AND TO THE SAME DEPTH OF THE PLANT ROOT BALL. BACKFILL 1/2 OF THE PIT AT A TIME AND COMPACT. SEE NOTE 7 AND INSTALL SLOW RELEASE FERTILIZER AFTER FIRST BACKFILL LIFT. SETTING THE TREE/ SHRUB: EACH TREE/SHRUB SHALL BE PLANTED SUCH THAT THE TRUNK FLARE JUNCTION IS LEVEL WITH OR 1-27 ABOVE DESTING CRADE. TREES/SHRUBS MHERE THE PLANTING DEPTH IS INCORRECT SHALL BE REJECTED. ALL PLANTING ISLANDS SHALL HAVE 18" OF TOPSOIL INSTALLED, WITH A PINISHED GRADE AT THE TOP OF CURB, PRIOR TO THE INSTALLATION OF PLANT MATERIAL.
- 7. ALL PLANTINGS SHALL HAVE SLOW RELEASE FERTILIZER TABLETS INSTALLED.
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 APPROVED EQUIL. APPLICATION RATE: PERENNIALS-1 TABLET/PLANT, WOODY
 SHRUBS 10 3"-0"-2 TABLETS/PLANT, SHRUBS AND REES 3"-0" 10 6"-0"-3
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 ARE INSTALLED, LIQUID FEED ALL PLANTS WITH ROOTS OR AN APPROVED EQUAL.
 MIX ACCORDING TO MANUFACTURER'S INSTRUCTIONS. APPLICATION RATE
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 PLANT.
- 8. TREES WILL NOT BE STAKED UNLESS IN THE OPINION OF THE LANDSCAPE CONTRACTOR THAT IT IS REQUIRED. IN THOSE CASES THE PARTICULAR TREES SHOULD BE REPORTED TO THE OWNER FOR THEIR APPROVAL. IN NO CASES SHALL A TREE BE STAKED BECAUSE THE ROOT BALL CRUMPLED. IN THOSE CASES THE TREE SHALL BE REMOVED AND REPLACED WITH A TREE OF THE SAME SPECIES AND SIZE WITH A SOULD AND INTACT ROOT BALL. IF STAKES ARE USED, THEY SHALL BE REMOVED BY THE CONTRACTOR AFTER ONE YEAR.
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- 10. ALL PLANTS SHALL BE ORIENTED FOR BEST APPEARANCE. PLANT SPECIES SUBSTITUTIONS WILL NOT BE ALLOWED UNLESS APPROVED BY THE OWNER.
- 11. ALL PLANTS SHALL BE GUARANTEED FOR ONE GROWING SEASON (ONE YEAR FROM DATE OF ACCEPTANCE). ANY PLANTS THAT DIE DURING THE GUARANTEE, SHALL BE REPLACED BY THE LANDSCAPE CONTRACTOR AT NO COST TO THE OWNER.

- 12. ALL AREAS NOT IDENTIFIED WITH OTHER SURFACE TREATMENTS SHALL BE LAWN. THE LAWN ARE SHALL BE SEDED WITH (LOFTS THE-PLK GENERAL OR APPROVED EQUAL) AND STRAW MULCHED. THE CONTRACTOR SHALL BE RESPONSIBLE FOR LAWN MAINTENANCE. MAINTENANCE SHALL COMMENCE AT THE TIME OF PLANTING AND LAST UNTIL A GOOD FULL CATCH OR GRASS IS ESTABLISHED.
- 13. IF QUANTITIES OF PLANTS LISTED IN THE PLANT SPECIES LIST DO NOT CORRELATE WITH THE PLANTINGS INDICATED ON THE PLAN, THE QUANTITIES ON THE PLAN SHALL COVERN.

EPLA	NTIN	G SCHEDULE			
	i. QTY.	BOTANICAL NAME	COMMON NAME	SIZE	REMARKS
AK	3	ACER RUBRUM "KARPICK"	KARPICK RED MAPLE	2.5°-3° CAL	BAS
CA.	5	CLEHERA ALNEFOLIA "HUMANGBERD"	HUMAINGBIRD SUMMERSWEET	15"-24"	4' O.C.
J.c.	32	A CHINE VAR. SARGENTI GLAUCA	BILUE SARGENT	Z'-2.5' HT.	B&B. 4' O.C.
RA	12	R. "AGLO"	AGLO RHODODENDRON	15"16" HT.	4° Q.C.
RIK	11	R. KURUME HYBRID "HERSEY'S RED"	HERSEY'S RED AZALEA	15"-16" HT.	4' Q.C.
10	8	T. OCC. "SHARGARD"	EMERALD GREEN	3'-4' HT.	B&B, 4' O.C.
PY	6	PYRUS CALLERYANA "ARISTOCRAT"	ARISTOCRAT ORNALIENTAL PEAR	2.5"-3" CAL	545
PS	10	PINUS STROBUS	WHITE PINE	5"-6" HT.	643
FP	2	FRAMUS PENNSYLVANICA SUMMIT	SUMMET ASH	2.5"-5" CAL	849



В	SJB	01/22/02	ISSUED FOR: PLANNING BOARD APPROVAL	691_b_c103
A	SJB	11/20/01	ISSUED FOR: PLANNING BOARD REVIEW	691_a_c103
REV.	BY	DATE	STATUS	CAD NO.


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OPM, INC. CYRUS B. ABBOTT SITE DEVELOPMENT

> SITE LANDSCAPING AND LIGHTING PLAN

ESSENCE STORY Fredericans	DESIGN BY:	8.2
Graphensing &	DRAWN BY:	JAR
Reservation, Inc.	CHECKED BY:	S.JB
222 St. John Steems, Suite 914 Possilved, Make 04102	DATE:	11/14/01
	JOB NO:	601
	SCALE:	1" = 10"
	C-103 SHEET 4	of 7



- NEVER CUT OUT CENTRAL LEADER, PRUNE OUT BROKEN, DEAD, OR CONFLICTING BRANCHES
- 4. INSTALL TREE SO TRUNK FLARE JUNCTION IS LEVEL WITH OR 1°-2° ABOVE EXISTING GRADE.
- 2. SEE SPECS. FOR ADDITIONAL REQUIREMENTS
- 5. WATER AT TIME OF PLANTING-SEE NOTES AND SPECS
- 3. TREE GUYS SHALL BE GUYING CHAIN OR WEB STRAPPING.

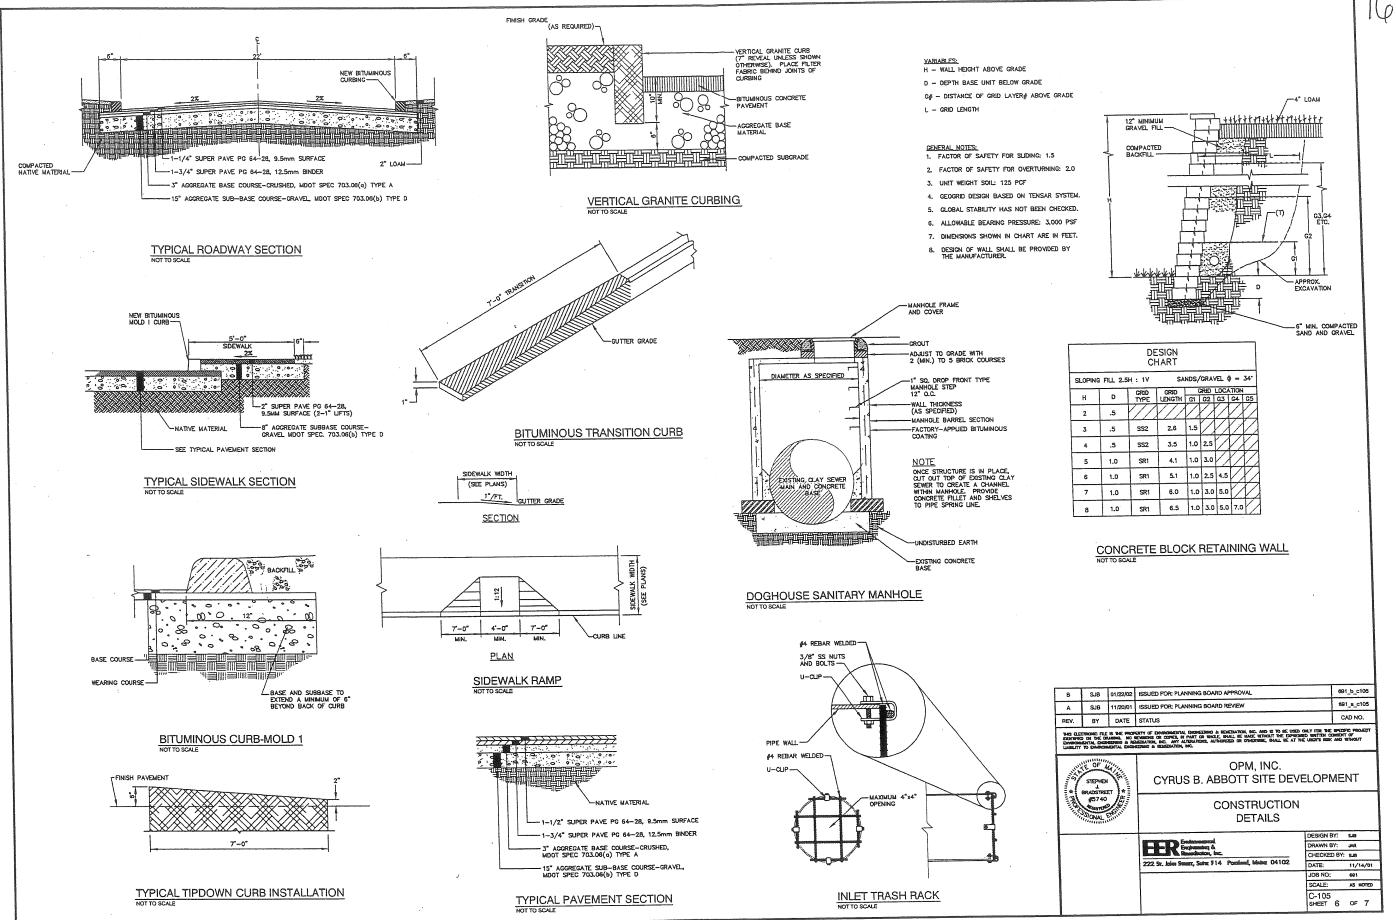- NOTES:
 1. ON TREES LESS THAN 4" CA. USE WOOD STAKES.
- ON TREES 3° CA. OR GREATER USE GUYING CABLES (3) EVENLY SPACED.

WHITE CLOTH STRIPS 2 PER CABLE

3" HIGH EARTH SAUCER

CUT AND REMOVE BURLAP FROM TOP 1/3 OF BALL IF NON-BIODEGRADEABLE MATERIAL, REMOVE ENTIRELY-

PLANT MIX AS SPECIFIED-

4. NEVER CUT OUT CENTRAL LEADER, PRUNE OUT BROKEN, DEAD, OR CONFLICTING BRANCHES


TREE ANCHOR AS SPECIFIED

-INSTALL TREE SO TRUNK FLARE JUNCTION IS LEVEL WITH OR 1"-2" ABOVE EXISTING GRADE

-3° MULCH AS SPECIFIED

- 5. SEE SPECS. FOR ADDITIONAL REQUIREMENTS
- 6. WATER AT TIME OF PLANTING-SEE NOTES AND SPECS.

TYPICAL TREE PLANTING DETAIL

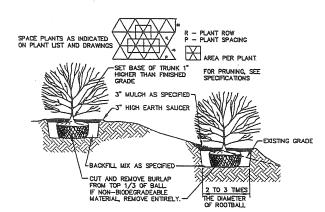


EVERGREEN TREE PLANTING & STAKING DETAIL NOT TO SCALE

NOTES:


1. SEE SPECS. FOR ADDITIONAL REQUIREMENTS

INSTALL SHRUB SO TRUNK ROOT JUNCTION IS LEVEL WITH OR 1"-2" ABOVE EXISTING GRADE.


TYPICAL SHRUB PLANTING DETAIL

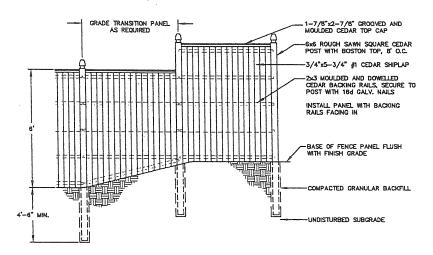

STOCKADE FENCE DETAIL NOT TO SCALE

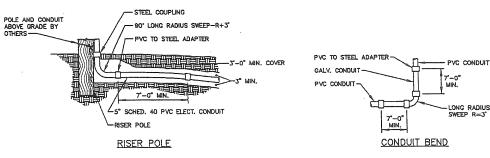

CONDUIT BEND AND RISER POLE DETAIL

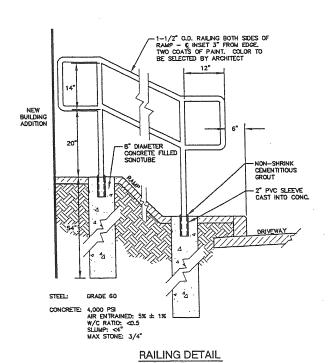

EROSION CONTROL NOTES

- APPLICATION OF TEMPORARY AND PERMANENT EROSION CONTROL MEASURES FOR THE PROJECT SHALL BE IN ACCORDANCE WITH PROCEDURES AND SPECIFICATIONS OF THE MAINE EROSION AND SEDMENT CONTROL HANDBOOK FOR CONSTRUCTION: BEST MANAGEMENT PRACTICES," MARCH 1991 (BMP HANDBOOK).
- SILTATION FENCE SHALL BE INSTALLED BEFORE GRUBBING OR EARTH MOVING OPERATIONS.
- PERMANENT SEEDING SHALL BE APPLIED WITHIN 15 DAYS OF FRIAL GRADING FROM APRIL 15 TO SEPTEMBER 1.
- 4. PERMANENT SEEDING SHALL BE:

BIRDSFOOT TREFOIL

CROWNVETCH CREEPING RED FESCUE OR TALL FESCUE

TEMPORARY SEEDING SHALL BE APPLIED WITHIN 30 DAYS OF INITIAL DISTURBANCE OF THE SOIL IF PERMANENT SEEDING IS NOT APPLIED. TEMPORARY SEEDING SHALL BE:

SEED	LB/1,000 SQ. FT.	SEEDING DEPTH	RECOMMENDED SEEDING DATES
WINTER RYE	26	1-1.5°	8/15-10/1
OATS	1.8	1-1.5°	4/1-7/1 8/15-9/15
ANNUAL RYEGRASS	0.9	.25"	4/1-7/1
SUDANGRASS	0.9	.5-1"	5/15-8/15
PERENNIAL	0.9	.25°	8/15-9/15

- FERTILIZER SHALL BE 10-20-20 GRANULAR GAREN FERTILIZER AND APPLIED AT 18.4 LBS/1,000 S.F.
- LIMESTONE SHALL BE GROUND WITH 50% CALCIUM PLUS MAGNESIUM OXIDE AND APPLIED AT 138 LBS/1,000 S.F.
- 8. MULCH SHALL BE HAY OR STRAW APPLIED AT 70-90 LBS/1,000 S.F.
- WINTER MULCH SHALL BE APPLIED BETWEEN OCTOBER 1 AND APRIL 1 AND SHALL BE HAY OR STRAW APPLIED AT 300 LBS/1,000 S.F.
- ALL EROSION CONTROL MEASURES, SEEDING AND MULCHING SHALL BE INSPECTED WEBLLY, AFTER RAINSTORMS AND DURING RUNGEF EVENTS. ALL MEASURES SHALL BE REPAIRED OR REPLACED WHEN NO LONGER SERVICEABLE DUE TO SEDIMENT ACCUMULATION OR DAMAGE.
- 11. SEEDED AND MULCHED AREAS SHALL BE MAINTAINED UNTIL FINAL ACCEPTANCE OF THE WORK. SEED CATCH SHALL BE ACCEPTABLE WHEN 75 PERCENT CATCH IS ESTABLISHED. MAINTENANCE SHALL CONSIST OF PROVIDING PROTECTION AGAINST TRAFFIC AND REPARRIG ANY AREAS TO RE-ESTABLISHED THE COUNTION AND GRADE OF THE SOIL PRIOR TO SEEDING AND SHALL THEN BE REPERTILIZED, RESEDED AND REMULCHED.
- 12. TEMPORARY EROSION CONTROL MEASURES SHALL BE REMOVED UPON COMPLETION OF GRADING OPERATIONS AND ESTABLISHMENT OF A 75 PERCENT CATCH OF GRASS.
- 13. THE CONTRACTOR SHALL BE RESPONSIBLE FOR MAINTAINING EROSION CONTROL MEASURES DURING CONSTRUCTION.
- 14. EROSION CONTROL INSPECTION SHALL BE PERFORMED BY:
 ENVIRONMENTAL ENGINEERING AND REMEDIATION, INC.
 STEPHEN J. BRADSTREET, P.E.
 222 ST. JOHN STREET SUITE 314
 (207) 828–1272

- 15. EROSION CONTROL AND CONSTRUCTION SEQUENCE:

 a) INSTALL ALL TEMPORARY EROSION CONTROL AS SHOWN ON THE PLAN SHEET IN ACCORDANCE WITH THE DETAILS AND BHE?

 b) CONSTRUCT THE DRIVE AND PARKING LOTS. IMMEDIATELY UPON INSTALLATION OF STORMDRAINS CONSTRUCT RIPRAP INLET PROTECTION.
 c) REMOVE TEMPORARY EROSION CONTROL MEASURES ONCE IMPROVEMENTS ARE COMPLETE AND THERE IS 75 PERCENT CATCH OF GRASS.

 - d) INSTALL PERMANENT EROSION CONTROL MEASURES.

16. CONSTRUCTION SCHEDULE
REMOVE EXISTING GARAGE
EXISTING HOME REMOVATIONS
PROPOSED BUILDING ADDITION

FEBRUARY 2002 FEBRUARY TO JUNE 2002 MARCH TO JUNE 2002 MARCH TO AUGUST 2002 MARCH TO AUGUST 2002

В	\$JB	01/22/02	ISSUED FOR: PLANNING BOARD APPROVAL	691_b_c106
A	SJB	11/20/01	ISSUED FOR: PLANNING BOARD REVIEW	691_a_c106
REV.	BY	DATE	STATUS	CAD NO.

THE SECTIONS FILE IS THE PROPERTY OF DIMENSIONAL DESIGNATION OF SECTION OF USE OF USE




OPM, INC. CYRUS B. ABBOTT SITE DEVELOPMENT


> CONSTRUCTION **DETAILS**

FER Enforcement &		JAR
Manufactor, bc.	CHECKED BY:	8.8
222 Sr. Inles Susser, Suiter F14 Possilved, Milles 04102	DATE:	11/14/01
	JOB NO:	691
	SCALE:	AS HOTED
	C-106 SHEET 7	OF 7

LBS/1.000 S.F.

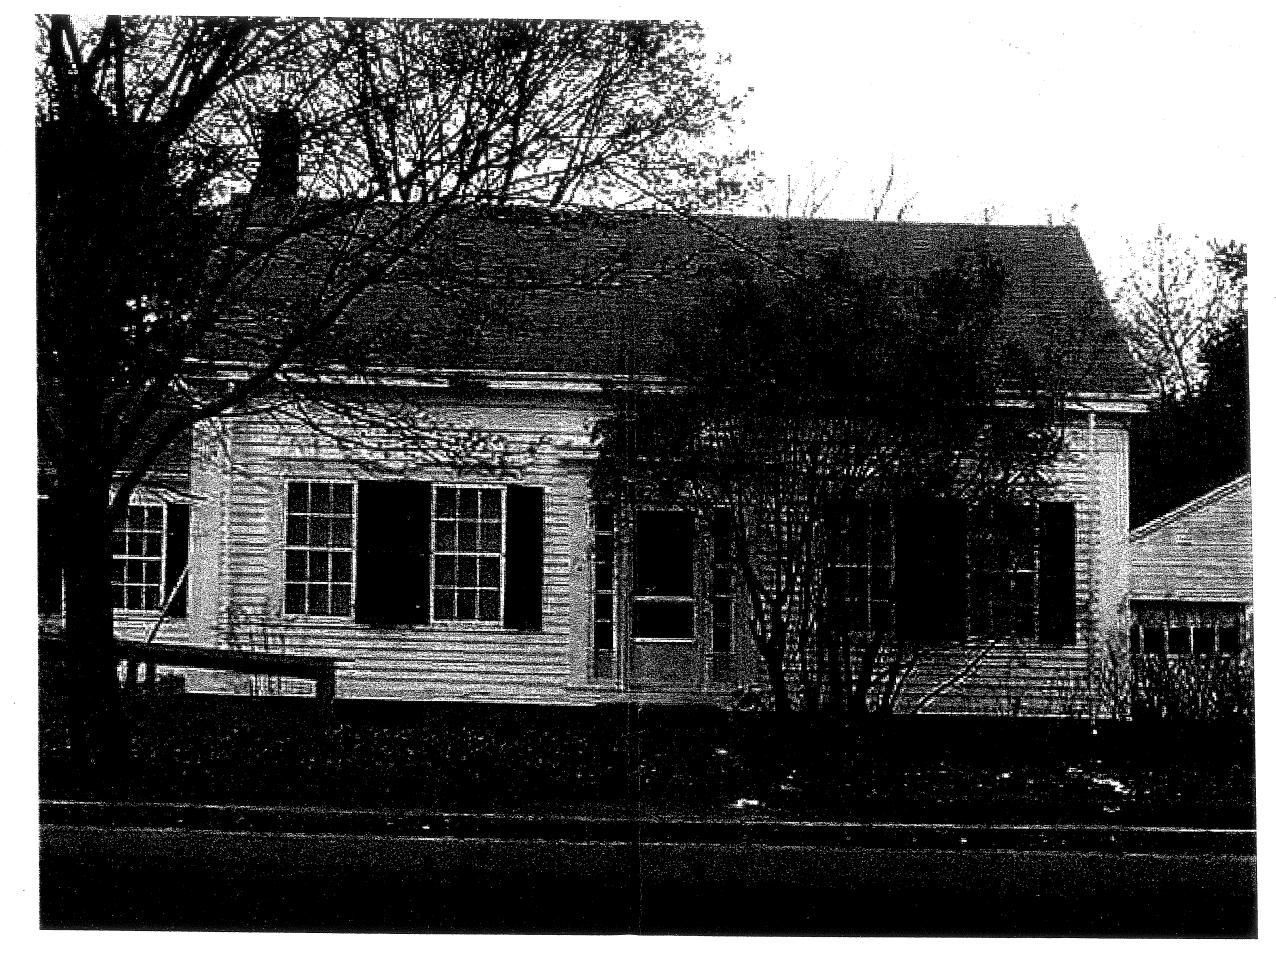




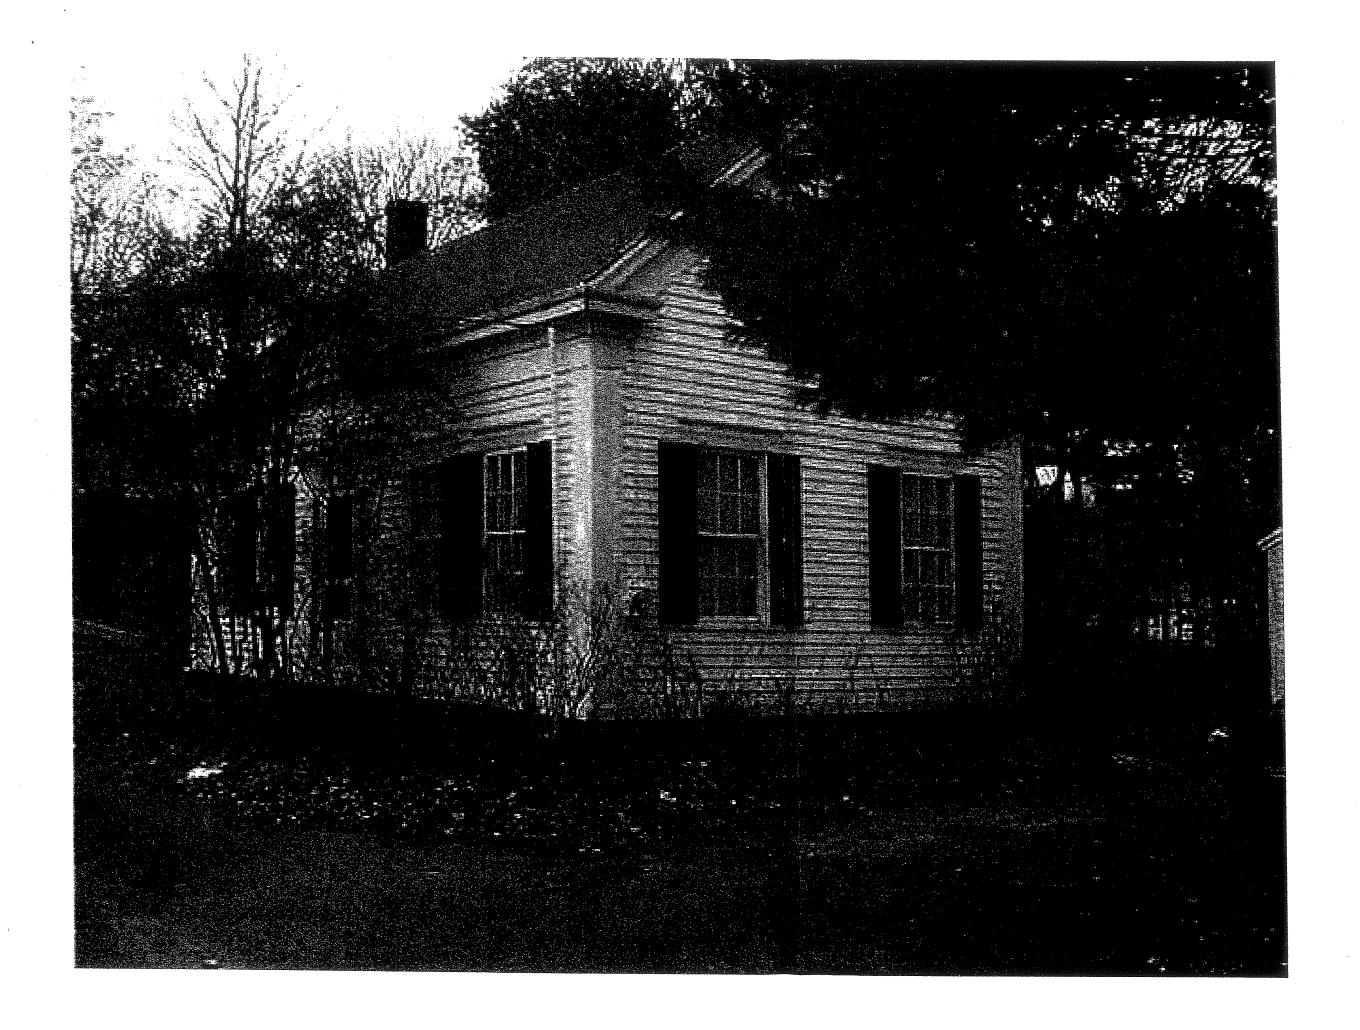









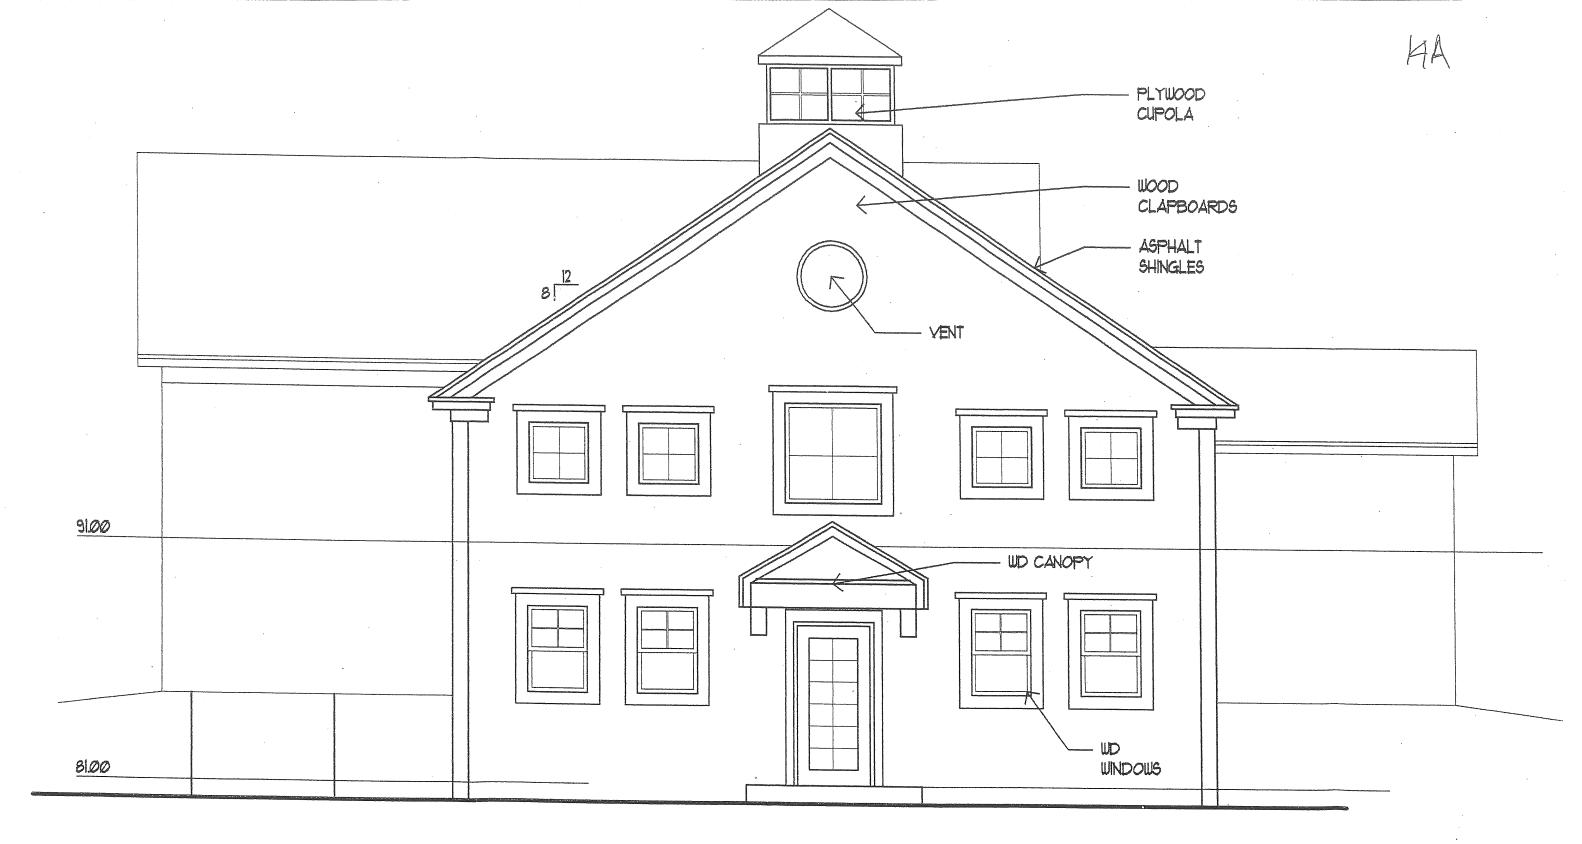





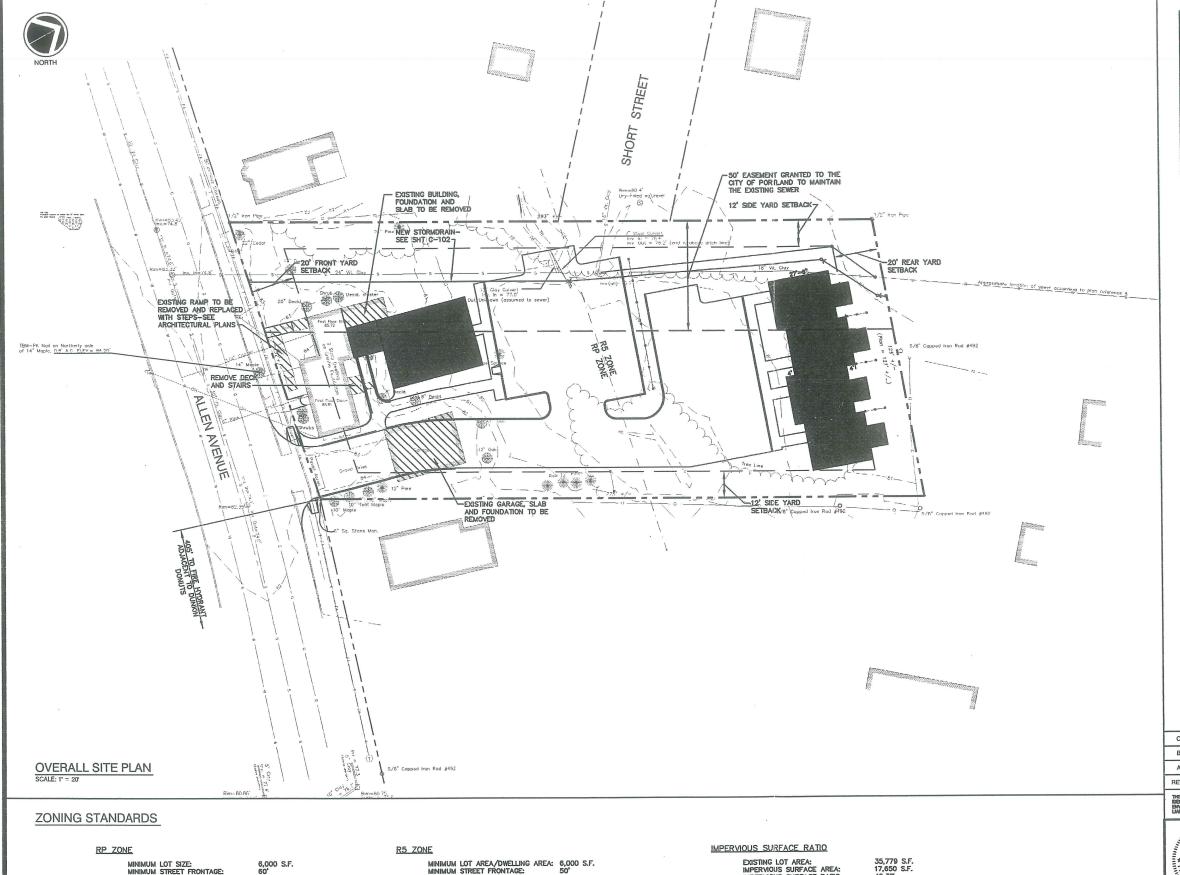

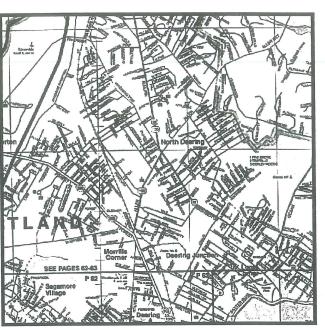

LOCUST PLAN

PROJECT INFORMATION

RECORD OWNER/ DEVELOPER:

OPM, INC. 52 BANG'S SHORE ROAD ORRS ISLAND, ME 04066

ENGINEER:

ENVIRONMENTAL ENGINEERING & REMEDIATION, INC. 222 ST, JOHN STREET SUITE 314 PORTLAND, MAINE 04102 MR. STEPHEN J. BRADSTREET, P.E.

SURVEYOR:

TITCOMB ASSOCIATES 133 GRAY ROAD FALMOUTH, MAINE 04105 MR. DAVID E. TITCOMB

SCALE: HOR 1" = 20"



С	SJB	02/26/02	ISSUED FOR: RESPONSE TO PLANNING STAFF COMMENTS	691_c_c100
В	SJB	01/22/02	ISSUED FOR: PLANNING BOARD APPROVAL	691_b_c100
Α	SJB	11/20/01	ISSUED FOR: PLANNING BOARD REVIEW	691_a_c100
REV.	BY	DATE	STATUS	CAD NO.

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OPM, INC. CYRUS B. ABBOTT SITE DEVELOPMENT

> **OVERALL** SITE PLAN

3.1.2.		
Fatamani .	DESIGN BY:	SJB
Engineering &	DRAWN BY:	JAR
Residence, Inc.	CHECKED BY:	SJB
222 St. John Smitt, Subs. 514 Pomberd, Matrix 04102	DATE:	11/14/01
	JOB NO:	001
	SCALE:	1° = 20'
	C-100 SHEET 1	of 7

MINIMUM LOT SIZE:
MINIMUM STREET FRONTAGE:
MINIMUM YARD DIMENSIONS:
FRONT YARD SETBACK:
REAR YARD SETBACK:
SIDE YARD SETBACK:


20'
20'
10' (ONE STORY)
12' (TWO STORIES)
14' (THREE OR MORE STORIES)


MINIMUM LOT WDTH:
MAXIMUM STRUCTURE HEIGHT:
MAXIMUM IMPERIOUS SURFACE:


MINIMUM LOT AREA/DWELLING AREA: 6,000 S.F.
MINIMUM STREET FRONTAGE: 50'
MINIMUM YARD DIMENSIONS:
FRONT YARD SETBACK: 20'
REAR YARD SETBACK: 20'
SIDE YARD SETBACK: 8' (ONE STI

20'
20'
8' (ONE STORY)
8' (ONE AND ONE HALF STORIES)
12' (TWO STORIES)
14' (TWO AND ONE HALF STORIES)
60'
35'
40% MINIMUM LOT WIDTH: MAXIMUM STRUCTURE HEIGHT: MAXIMUM LOT COVERAGE:

EXISTING LOT AREA: IMPERVIOUS SURFACE AREA: IMPERVIOUS SURFACE RATIO:

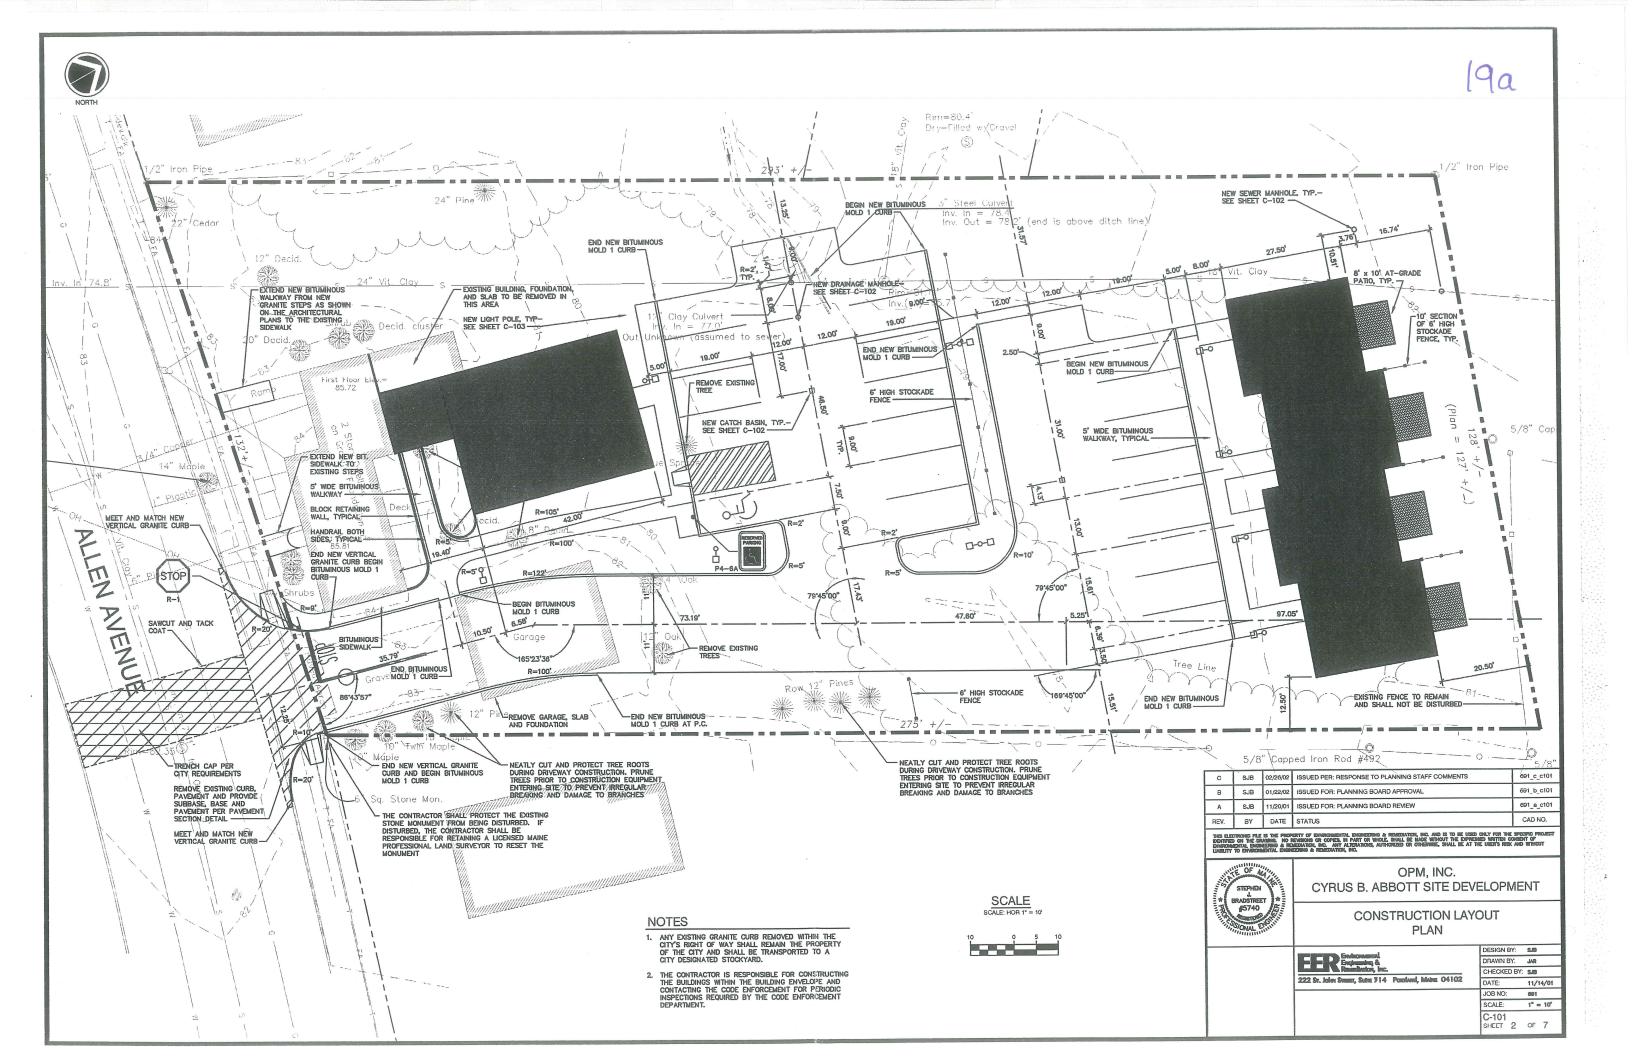

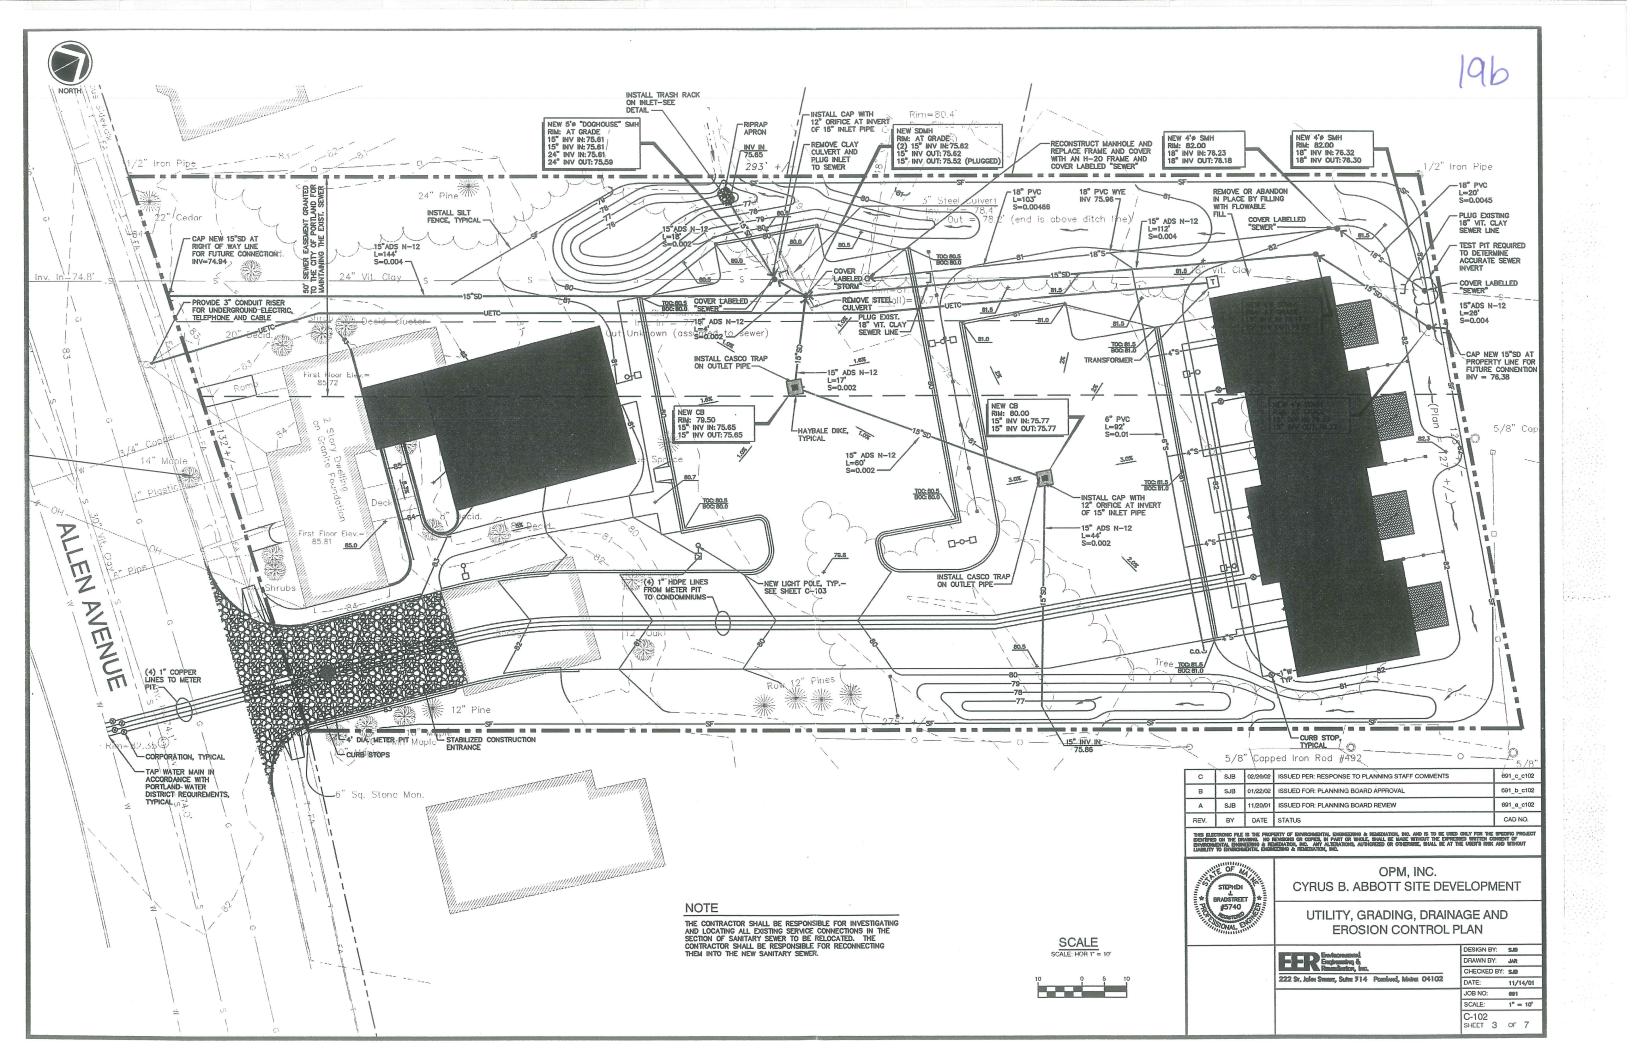

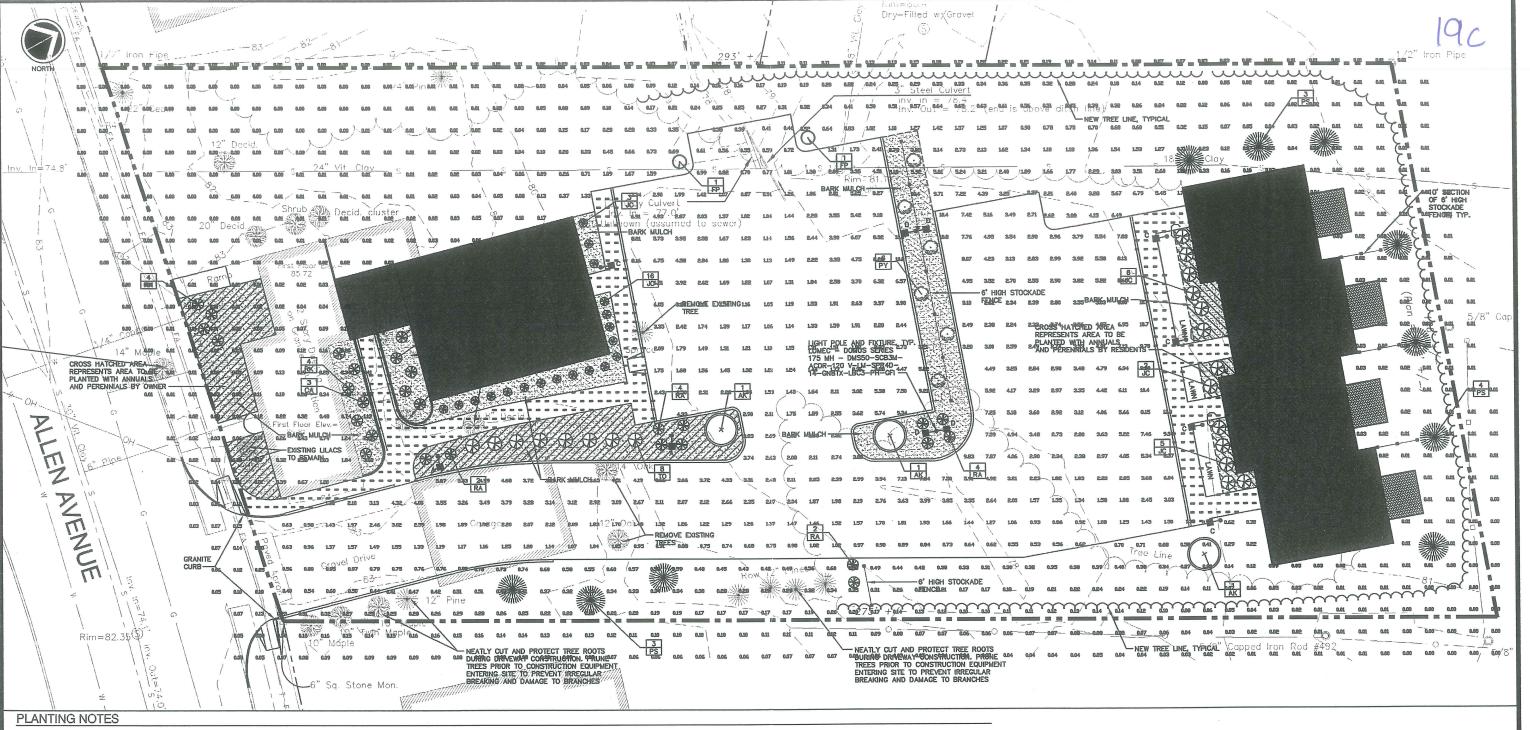

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 PERENNIALS-2 QTS/PLANT, WOODY SHRUBS TO 4'0"-1.5 GAL/PLANT, TREES AND
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SHALL GOVERN.											
F	EPLANTING SCHEDULE										
		QTY.	BOTANICAL NAME	COMMON NAME KARPICK RED MAPLE	SIZE 2.5°-3° CAL	REMARKS BAB					
1	CA	5	CLETHRA ALNIFOLIA "HUMMINGBIRD"	HUMMINGBIRD SUMMERSWEET	18°-24°	4° O.C.					
	JC	32	J. CHIN. VAR. SARGENTI GLAUCA	BLUE SARGENT	2°-2.5° HT.	B&B, 4' O.C.					
ı	RA	12	R. "AGLO"	AGLO RHODODENDRON	16°-18° HT.	4' O.C.					
1	RK	11	R. KURUME HYBRID "HERSEY'S RED"	HERSEY'S RED AZALEA	15°-16° HT.	4° O.C.					
ı	то	8	T. OCC. "SMARGARD"	EMERALD GREEN	3'-4' HT.	B&B, 4' O.C.					
	PY	6	PYRUS CALLERYANA 'ARISTOCRAT'	ARISTOCRAT ORNAMENTAL PEAR	2.5°-3° CAL	BAB					
	PS	10	PINUS STROBUS	WHITE PINE	5'-6' HT.	BAB					
ı	FP	2	FRAXINUS PENNSYLVANICA "SUMMET"	SUMMIT ASH	2.5°-3° CAL	BAB					

_		
		SCHEDULE
		DESCRIPTION
	A	LIGHT POLE AND FIXTURE LUMEC DOMUS SERIES 175 MH-DMS-SG3 ACOR-120 V-LM-SPR4D 14 GN8TX-LBC3-PH-GFI
	C	LIGHT POLE AND FIXTURE LUMEC DOMUS SERIES 175 MH-DMS-SGFM ACOR-120 V-LM-SPR4D 14 CN8TX-LBC3-PH-GFI
	D	HIGHT POLE AND EXCHIPE LIMES DOMES SERIES 2X 175 MH-DMS-SQFM ACOR-120 V-LM-SPR4D 14 QN8TX-LBC3-PH-QFI



С	SJB	02/26/02	ISSUED PER: RESPONSE TO PLANNING STAFF COMMENTS	691_c_c103
В	SJB	01/22/02	ISSUED FOR: PLANNING BOARD APPROVAL	691_b_c103
Α	SJB	11/20/01	ISSUED FOR: PLANNING BOARD REVIEW	691_a_c103
REV.	BY	DATE	STATUS	CAD NO.


E BLESTIGNOS PILE ES THE PROPERTY OF DEVINCAMENTAL DISSISSIONES À REMEDIATION, NO. AND IS TO BE USED CULT FOR THE SPECIAL SYMMETER ON THE DEAD AND AN EXPERIMENT OF THE PROPERTY OF THE PROPER




OPM, INC.
CYRUS B. ABBOTT SITE DEVELOPMENT


SITE LANDSCAPING AND LIGHTING PLAN

	AND LIGHTING PLAN					
٦	Fuhanani	DESIGN BY:	SJB			
	E-E-Referencing &	DRAWN BY:				
	Rainduloi, Inc.	CHECKED BY: SJB				
1	222 St. Joles Smart, Suite 314 Postland, Maint 04102	DATE:	11/14/01			
		JOB NO:	691			
	i i	SCALE:	1° = 10°			
		C-103 SHEET 4	of 7			

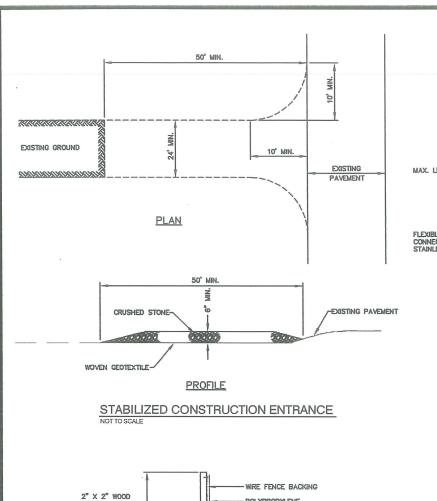


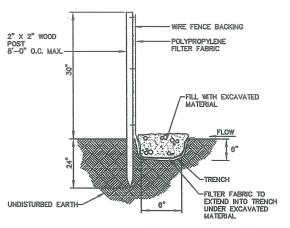


EROSION CONTROL FENCE DETAIL

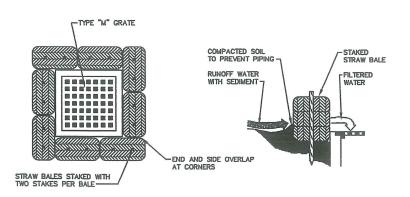


HAYBALE DIKE DETAIL

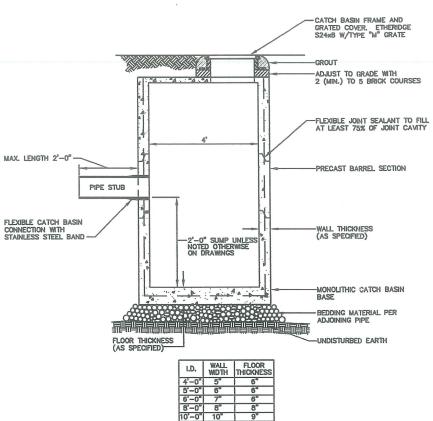




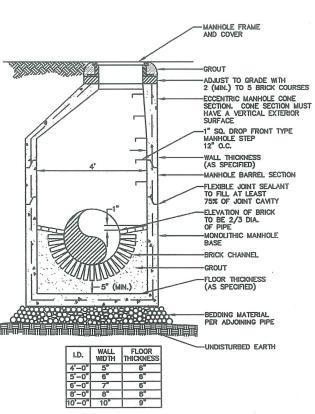


PRECAST CONCRETE MANHOLE

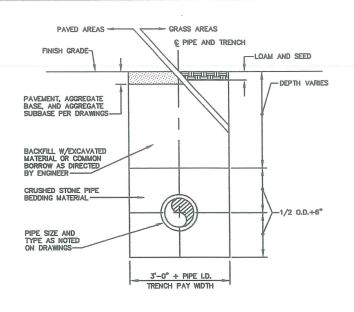


TYPICAL TRENCH DETAIL

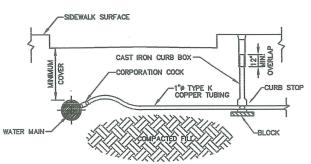

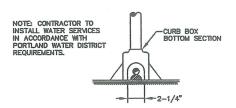


TYPICAL COPPER HOUSE SERVICE DETAIL

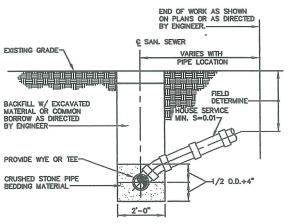



NOTE: WHERE TRENCHES FOR HOUSE CONNECTIONS EXTEND INTO STREET, SEE TYPICAL TRENCH DETAIL FOR DETAILS.

TYPICAL TRENCH SECTION BUILDING CONSTRUCTION
NOT TO SCALE

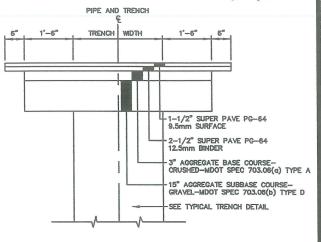

TYPICAL TRENCH PAVING DETAIL

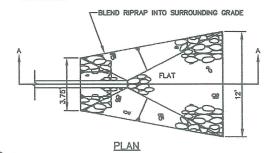

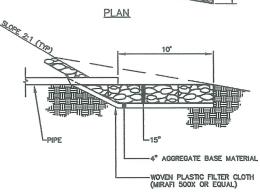

SECTION A-A RIPRAP APRON DETAIL

С	SJB	02/26/02	ISSUED PER: RESPONSE TO PLANNING STAFF COMMENTS	691_c_c104
В	SJB	01/22/02	ISSUED FOR: PLANNING BOARD APPROVAL	691_b_c104
Α	SJB	11/20/01	ISSUED FOR: PLANNING BOARD REVIEW	691_a_c104
REV.	BY	DATE	STATUS	CAD NO.


THE RECTIONS FALS IN THE PROPERTY OF ENVIRONMENTAL EMONETHING IN REMEMATION, INC. AND IS TO RE UNED ONLY FOR THE SPECIFIC PROJECT ON THE DIABABLE HOUSE SHAPE OF CHARLES AND REPORT OF THE SPECIFIC PROJECT OF THE SPECIFIC PR



OPM, INC.
CYRUS B. ABBOTT SITE DEVELOPMENT

CONSTRUCTION DETAILS

		DESIGN BY:	SJØ
	FFR Suprement	DRAWN BY:	JAR
	Raindleton, Inc.	CHECKED BY:	SJB
	222 Sr. John Smain, Suite 714 Pambred, Mehra 04102	DATE:	11/14/01
		JOB NO:	001
		SCALE:	AS NOTED
		C-104 SHEET 5	of 7

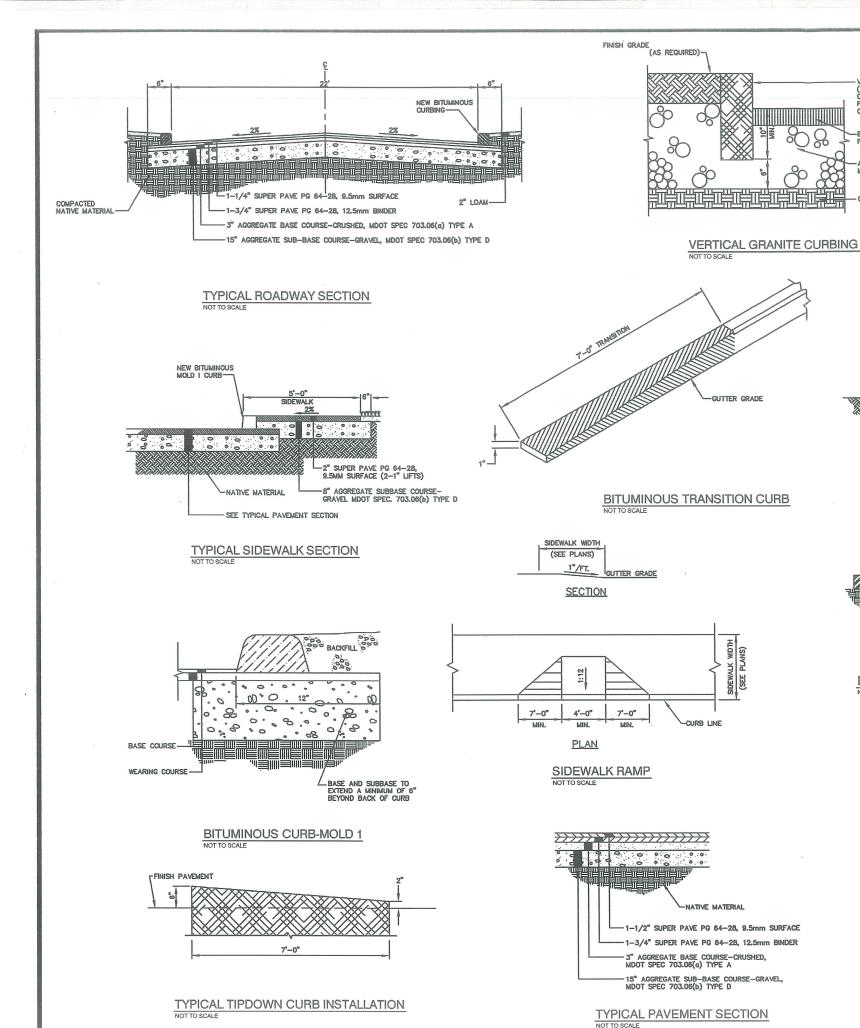

VARIABLES:

- H WALL HEIGHT ABOVE GRADE
- D DEPTH BASE UNIT BELOW GRADE
- G# DISTANCE OF GRID LAYER# ABOVE GRADE

-ADJUST TO GRADE WITH 2 (MIN.) TO 5 BRICK COURSES

-FACTORY-APPLIED BITUMINOUS COATING

ONCE STRUCTURE IS IN PLACE, CUT OUT TOP OF EXISTING CLAY SEVER TO CREATE A CHANNEL WITHIN MANHOLE. PROVIDE CONCRETE FILLET AND SHELVES TO PIPE SPRING LINE.

-EXISTING CONCRETE BASE


-1" SQ. DROP FRONT TYPE MANHOLE STEP 12" O.C.

-WALL THICKNESS (AS SPECIFIED) -MANHOLE BARREL SECTION

NOTE

- GENERAL NOTES:

 1. FACTOR OF SAFETY FOR SLIDING: 1.5
- 2. FACTOR OF SAFETY FOR OVERTURNING: 2.0
- 3. UNIT WEIGHT SOIL: 125 PCF
- 5. GLOBAL STABILITY HAS NOT BEEN CHECKED.
- 6. ALLOWABLE BEARING PRESSURE: 3,000 PSF
- 7. DIMENSIONS SHOWN IN CHART ARE IN FEET.
- 8. DESIGN OF WALL SHALL BE PROVIDED BY THE MANUFACTURER.

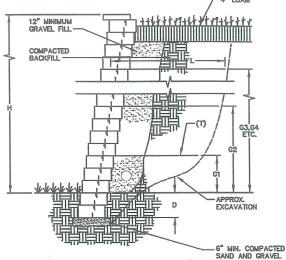

١								
DESIGN CHART								
SLOPING FILL 2.5H : 1V SANDS/GRAVEL $\phi = 34^\circ$								
Н	D	GRID TYPE	GRID LENGTH	GI	GRID G2		G4	
2	.5					\mathbb{Z}		
3	.5	SS2	2.6	1.5				
4	.5	SS2	3.5	1.0	2.5			
5	1.0	SR1	4.1	1.0	3.0			
6	1.0	SR1	5.1	1.0	2.5	4.5		
7	1.0	SR1	6.0	1.0	3.0	5.0		\mathbb{Z}
8	1.0	SR1	6.5	1.0	3.0	5.0	7.0	

CONCRETE BLOCK RETAINING WALL

DOGHOUSE SANITARY MANHOLE


DIAMETER AS SPECIFIED

VERTICAL GRANITE CURB (7° REVEAL UNLESS SHOWN OTHERWISE). PLACE FILTER FABRIC BEHIND JOINTS OF

-BITUMINOUS CONCRETE PAVEMENT

COMPACTED SUBGRADE

AGGREGATE BASE MATERIAL

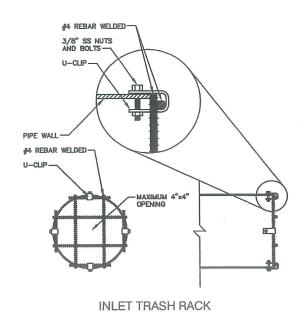


С	SJB	02/26/02	ISSUED PER: RESPONSE TO PLANNING STAFF COMMENTS	691_c_c105
В	SJB	01/22/02	ISSUED FOR: PLANNING BOARD APPROVAL	691_b_c105
А	SJB	11/20/01	ISSUED FOR: PLANNING BOARD REVIEW	691_a_c105
REV.	BY	DATE	STATUS	CAD NO.
HEV.	ВТ	DATE	STATUS	UND NO.



OPM, INC. CYRUS B. ABBOTT SITE DEVELOPMENT

CONSTRUCTION

DETAILS		
Entrement	DESIGN BY:	SJB
Englegening &	DRAWN BY:	JAR
Madded W. Raedutor, Inc.	CHECKED BY:	SJB
222 Sr. John Smar, Suite 714 Possland, Mahra 04102	DATE:	11/14/01
	JOB NO:	601
	SCALE:	AS NOTED
	C-105 SHEET 6	of 7

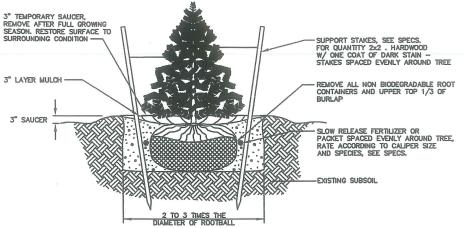

- 1. NEVER CUT OUT CENTRAL LEADER, PRUNE OUT BROKEN, DEAD, OR CONFLICTING BRANCHES
- 2. SEE SPECS. FOR ADDITIONAL REQUIREMENTS
- TREE GUYS SHALL BE GUYING CHAIN OR WEB STRAPPING.
- 4. INSTALL TREE SO TRUNK FLARE JUNCTION IS LEVEL WITH OR 1°-2° ABOVE EXISTING GRADE.
- 5. WATER AT TIME OF PLANTING-SEE NOTES AND SPECS.
- - 3. FOR PRUNING, SEE SPECIFICATIONS.

TURNBUCKLE AS SPEC.

WHITE CLOTH STRIPS 2 PER CABLE

CUT AND REMOVE BURLAP FROM TOP 1/3 OF BALL IF

MATERIAL, REMOVE ENTIRELY PLANT MIX AS SPECIFIED-

- $\frac{\text{NOTES:}}{1.}$ On trees less than 4° ca. Use wood stakes. 4. NEVER CUT OUT CENTRAL LEADER, PRUNE OUT BROKEN, DEAD, OR CONFLICTING BRANCHES ON TREES 3" CA. OR GREATER USE GUYING CABLES (3) EVENLY SPACED.
 - 5. SEE SPECS. FOR ADDITIONAL REQUIREMENTS

TREE ANCHOR


-install tree so trunk Flare Junction is level With or 1"-2" above Edisting grade

-3° MULCH AS SPECIFIED

6. WATER AT TIME OF PLANTING-SEE NOTES AND SPECS.

TYPICAL TREE PLANTING DETAIL


EVERGREEN TREE PLANTING & STAKING DETAIL

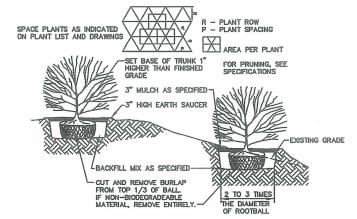


NOTES:

- 1. SEE SPECS. FOR ADDITIONAL REQUIREMENTS
- INSTALL SHRUB SO TRUNK ROOT JUNCTION IS LEVEL WITH OR 1"-2" ABOVE EXISTING GRADE.


TYPICAL SHRUB PLANTING DETAIL NOT TO SCALE

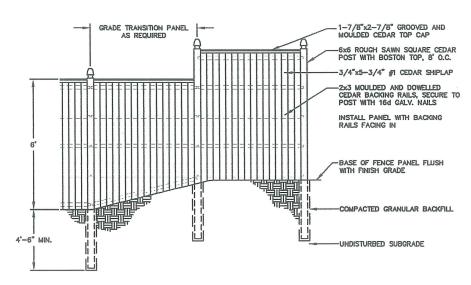

STOCKADE FENCE DETAIL

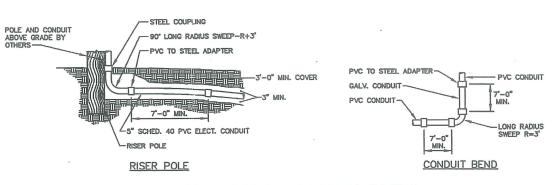

CONDUIT BEND AND RISER POLE DETAIL

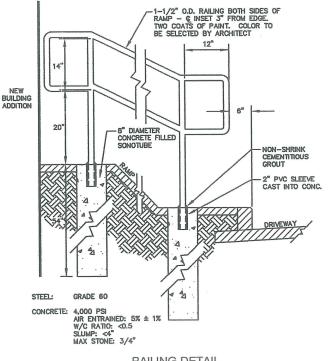

RAILING DETAIL

EROSION CONTROL NOTES

- APPLICATION OF TEMPORARY AND PERMANENT EROSION CONTROL MEASURES FOR THE PROJECT SHALL BE IN ACCORDANCE WITH PROCEDURES AND SPECIFICATIONS OF THE "MAINE EROSION AND SEDIMENT CONTROL HANDBOOK FOR CONSTRUCTION: BEST MANAGEMENT PRACTICES," MARCH 1991 (BMP HANDBOOK).
- 2. SILTATION FENCE SHALL BE INSTALLED BEFORE GRUBBING OR EARTH MOVING OPERATIONS.
- PERMANENT SEEDING SHALL BE APPLIED WITHIN 15 DAYS OF FINAL GRADING FROM APRIL 15 TO SEPTEMBER 1.
- 4. PERMANENT SEEDING SHALL BE:

LBS/1.000 S.F. BIRDSFOOT TREFOIL CROWNVETCH CREEPING RED FESCUE OR TALL FESCUE

5. TEMPORARY SEEDING SHALL BE APPLIED WITHIN 30 DAYS OF INITIAL DISTURBANCE OF THE SOIL IF PERMANENT SEEDING IS NOT APPLIED. TEMPORARY SEEDING SHALL BE:

SEED	LB/1,000 SQ. FT.	SEEDING DEPTH	RECOMMENDED SEEDING DATES
WINTER RYE	2.6	1-1.5"	8/15-10/1
OATS	1.8	1-1.5°	4/1-7/1 8/15-9/15
ANNUAL RYEGRASS	0.9	.25°	4/1-7/1
SUDANGRASS	0.9	.5-1"	5/15-8/15
PERENNIAL	0.9	.25°	8/15-9/15

- 6. FERTILIZER SHALL BE 10-20-20 GRANULAR GAREN FERTILIZER AND APPLIED AT 18.4
- LIMESTONE SHALL BE GROUND WITH 50% CALCIUM PLUS MAGNESIUM OXIDE AND APPLIED AT 138 LBS/1,000 S.F.
- 8. MULCH SHALL BE HAY OR STRAW APPLIED AT 70-90 LBS/1,000 S.F.
- WINTER MULCH SHALL BE APPLIED BETWEEN OCTOBER 1 AND APRIL 1 AND SHALL BE HAY OR STRAW APPLIED AT 300 LBS/1,000 S.F.
- ALL EROSION CONTROL MEASURES, SEEDING AND MULCHING SHALL BE INSPECTED WEEKLY, AFTER RAINSTORMS AND DURING RUNOFF EVENTS. ALL MEASURES SHALL BE REPAIRED OR REPLACED WHEN NO LONGER SERVICEABLE DUE TO SEDIMENT ACCUMULATION OR DAMAGE.
- 11. SEEDED AND MULCHED AREAS SHALL BE MAINTAINED UNTIL FINAL ACCEPTANCE OF THE WORK. SEED CATCH SHALL BE ACCEPTABLE WHEN 75 PERCENT CATCH IS ESTABLISHED. MAINTENANCE SHALL CONSIST OF PROVIDING POTECTION AGAINST TRAFFIC AND REPAIRING ANY AREAS TO RE-ESTABLISHED THE CONDITION AND GRADE OF THE SOIL PRIOR TO SEEDING AND SHALL THEN BE REFERTILIZED, RESEEDED AND REMULCHED.
- TEMPORARY EROSION CONTROL MEASURES SHALL BE REMOVED UPON COMPLETION OF GRADING OPERATIONS AND ESTABLISHMENT OF A 75 PERCENT CATCH OF GRASS.
- THE CONTRACTOR SHALL BE RESPONSIBLE FOR MAINTAINING EROSION CONTROL MEASURES DURING CONSTRUCTION.
- 14. EROSION CONTROL INSPECTION SHALL BE PERFORMED BY:
 ENVIRONMENTAL ENGINEERING AND REMEDIATION, INC.
 STEPHEN J. BRADSTREET, P.E.
 222 ST. JOHN STREET SUITE 314
 (207) 828-1272
- 15. EROSION CONTROL AND CONSTRUCTION SEQUENCE:
 - a) INSTALL ALL TEMPORARY EROSION CONTROL AS SHOWN ON THE PLAN SHEET

 - d) INSTALL ALL TEMPORARY EROSION CONTROL AS SHOWN ON THE PLAN SHEET IN ACCORDANCE WITH THE DETAILS AND BMPS.
 b) CONSTRUCT THE DRIVE AND PARKING LOTS. IMMEDIATELY UPON INSTALLATION OF STORMDRAINS CONSTRUCT RIPRAP INLET PROTECTION.
 c) REMOVE TEMPORARY EROSION CONTROL MEASURES ONCE IMPROVEMENTS ARE COMPLETE AND THERE IS 75 PERCENT CATCH OF GRASS.

 - d) INSTALL PERMANENT EROSION CONTROL MEASURES.

16. CONSTRUCTION SCHEDULE
REMOVE EXISTING GARAGE
EXISTING HOME RENOVATIONS
PROPOSED BUILDING ADDITION

SITE CONSTRUCTION RESIDENTIAL APARTMENT CONSTRUCTION FERRUARY 2002 FEBRUARY 2002
FEBRUARY TO JUNE 2002
MARCH TO JUNE 2002
MARCH TO AUGUST 2002

C	SJB	no me mo	ISSUED PER: RESPONSE TO PLANNING STAFF COMMENTS	691 c c106
C	SUB	02/20/02	ISSUED FER. RESPONSE TO FERINAING STAFF COMMENTS	031_0_0100
В	SJB	01/22/02	ISSUED FOR: PLANNING BOARD APPROVAL	691_b_c106
А	SJB	11/20/01	ISSUED FOR: PLANNING BOARD REVIEW	691_a_c106
REV.	BY	DATE	STATUS	CAD NO.

THIS ELECTRORIC PLE IS THE PROPERTY OF ENGINEERINAL ENGINEERING & RELEDATION, NO. AND IS TO BE USED ONLY FOR THE SPECIFIC PROJECT OF ENGINEERING OF REVISIONS OF COPPER, BY PART OR WINDLE, SHALL BE MADE WITHOUT THE ENFECTMENT OWNERS OF REPRESEND WRITTEN CONSIST OF ENMINORMENTAL ENGINEERING & REGISTRATION, NO. ANY ALTERNITORS, AUTHORIZED OR ORIENTING, SHALL BE AT THE USER'S RISK AND WITHOUT LIBERTY TO ENVIRONMENTAL ENGINEERING & REMINISTRATIONS.



OPM, INC. CYRUS B. ABBOTT SITE DEVELOPMENT

CONSTRUCTION **DETAILS**

Enterment	DESIGN BY:	SJB
Englispening &	DRAWN BY:	JAR
Maddell W. Rosedictor, Inc.	CHECKED BY:	SJB
222 Sr. John Sman, Suite F14 Pomford, Make 04102	DATE:	11/14/01
	JOB NO:	691
	SCALE:	AS NOTED
	C-106 SHEET 7	of 7















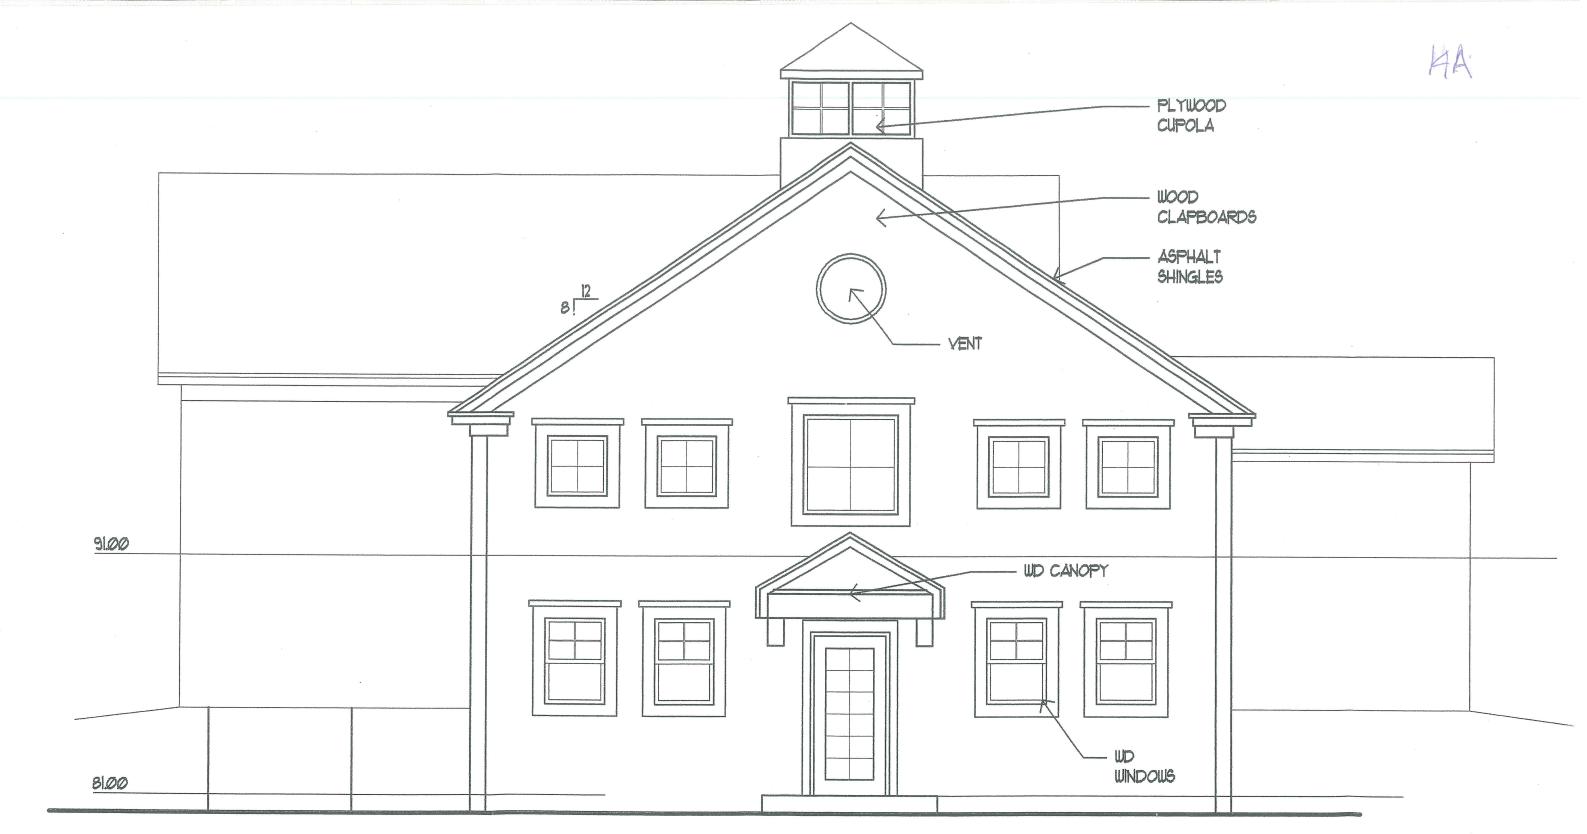






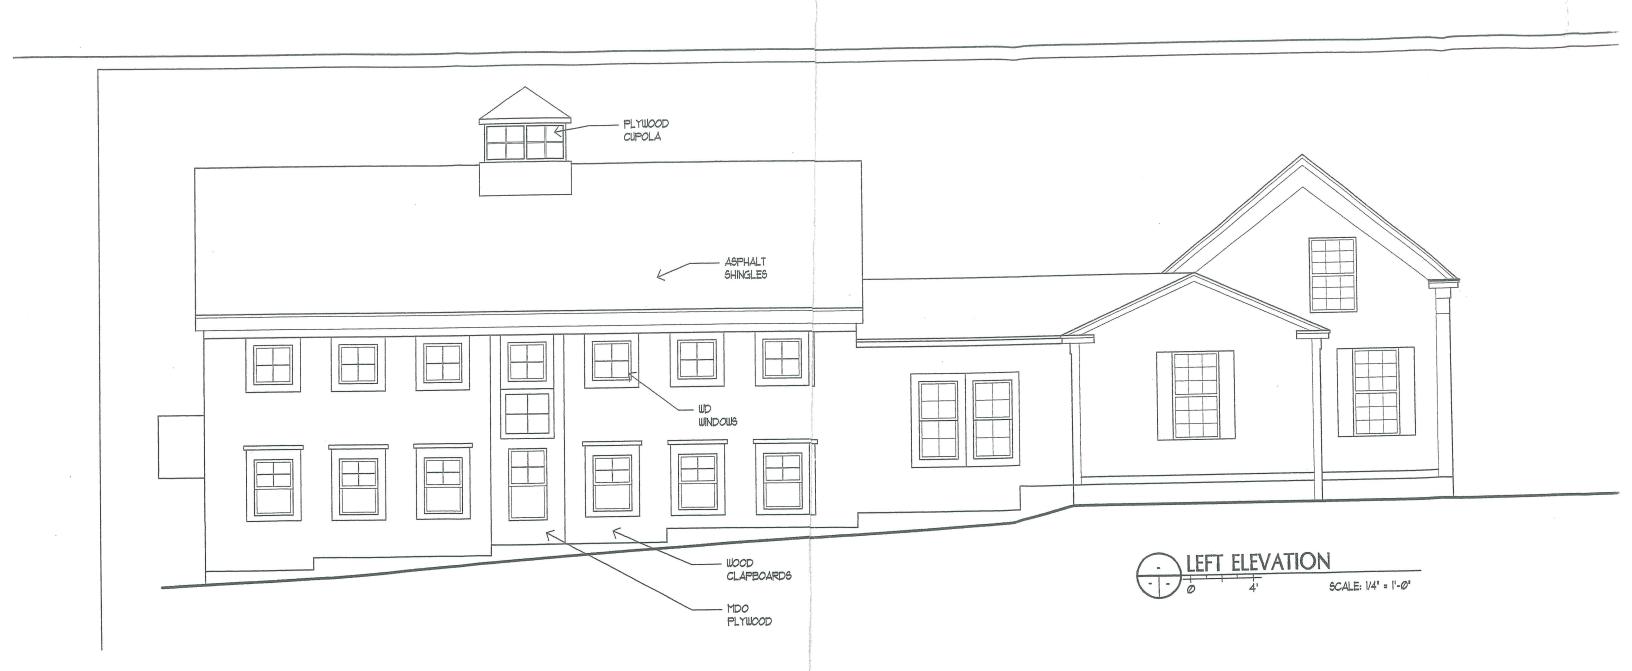



SOUTH ELEVATION

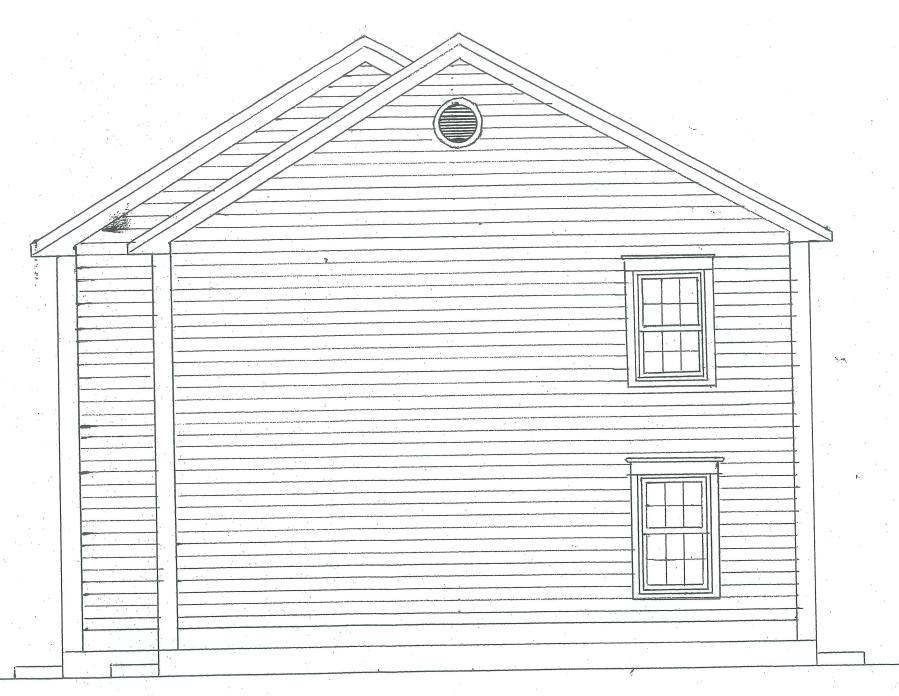

PROPOSED MATERIAL LIST:

- * 8" Fluted Vinyl Cornerboard
- Vinyl Frieze board
- * 6/6 Doublehung vinylclad
- seamless vinyl clapboard
- * vinylclad molding
- 10" vinyl freezeboard
- * Concrete foundation wall
- $4' \times 4'' \times 8''$ granite or precast slab

EAST ELEVATION

" Cyrus B. Abbott" Multifamily Housing Project

SCALE: 1/4" = 1'-0"

DATE: January 21, 2001

APPROVED BY:


OPM, INC.

DRAWN BY D.Kingsley
REVISED

Proposed Front and Side Elevations


FOR PLANNING BOARD APPROVAL

DRAWING NUMBER
A - 01

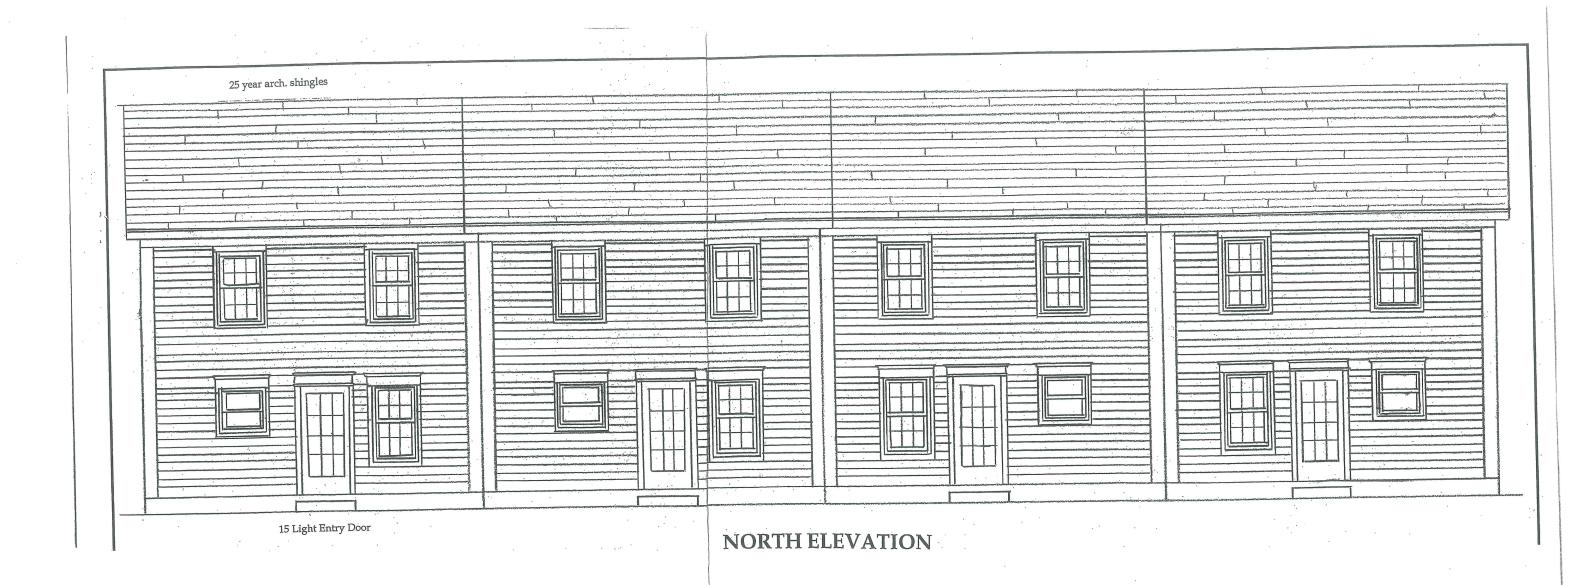

PROPOSED MATERIAL LIST:

- 8" Fluted Vinyl Cornerboard
- Vinyl Frieze board
- 6/6 Doublehung vinylclad
- seamless vinyl clapboard
- vinylclad molding
- 10" vinyl freezeboard
- Concrete foundation wall
- 4' x 4" x 8" granite or precast slab *

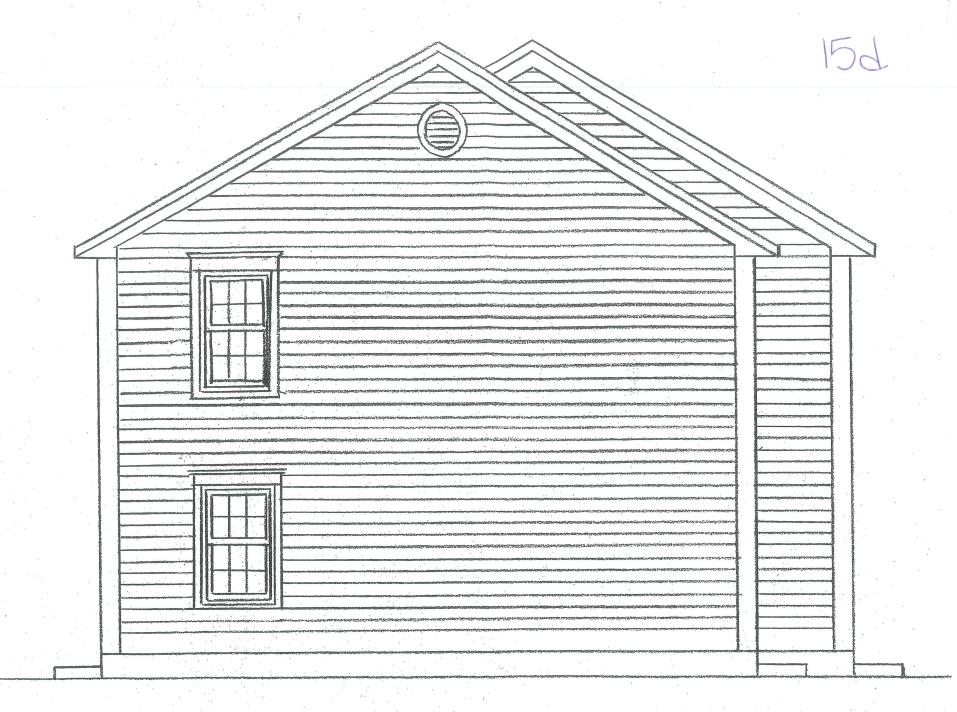

WEST ELEVATION