## PROJECT DIRECTORY

## OWNER:

TIM BELLANCENU

# DESIGN PROFESSIONAL:

MACLEOD STRUCTURAL ENGINEERS, PA 90 BRIDGE STREET WESTBROOK, MAINE 04092 TEL. 207-839-0980

# GENERAL CONTRACTOR:

CHRISTIAN DARLING, BUILDER PORTLAND, MAINE TEL. 207-409-7048

## PROJECT DESCRIPTION:

THIS PROJECT CONSISTS OF -1. ADDING A SECOND FLOOR IN-LAW APARTMENT OVER THE EXISTING GARAGE AND KITCHEN/ LIVING ROOM OF THE HOUSE. 2. THE FOOTPRINT OF THE BUILDING IS 3. EXISTING COMPONENTS TO REMAIN EXCEPT AS NOTED HEREIN

### SYMBOLS

ROOM NUMBER/NAME

DOOR NUMBER

WINDOW NUMBER

REVISION NUMBER

## DETAIL LEADER — LEFT TAG TAIL LEADER - RIGHT TAG DETAIL SECTION LABEL TAG DETAIL LABEL TAG Scale: ?" = 1'-0"Scale: ?" = 1'-0"TITLE LABEL TAG SECOND FLOOR FRAMING PLAN Scale: ?" = 1'-0"GRID BUBBLE LEVATION LEADER $\frac{\text{T.O.Grade}}{\text{Elev.} = xx'-x"}$ ( X.X )

# MATERIALS


EARTH

CONCRETE

BATT INSULATION

RIGID INSULATION

# 21 STUART STREET Portland, Maine

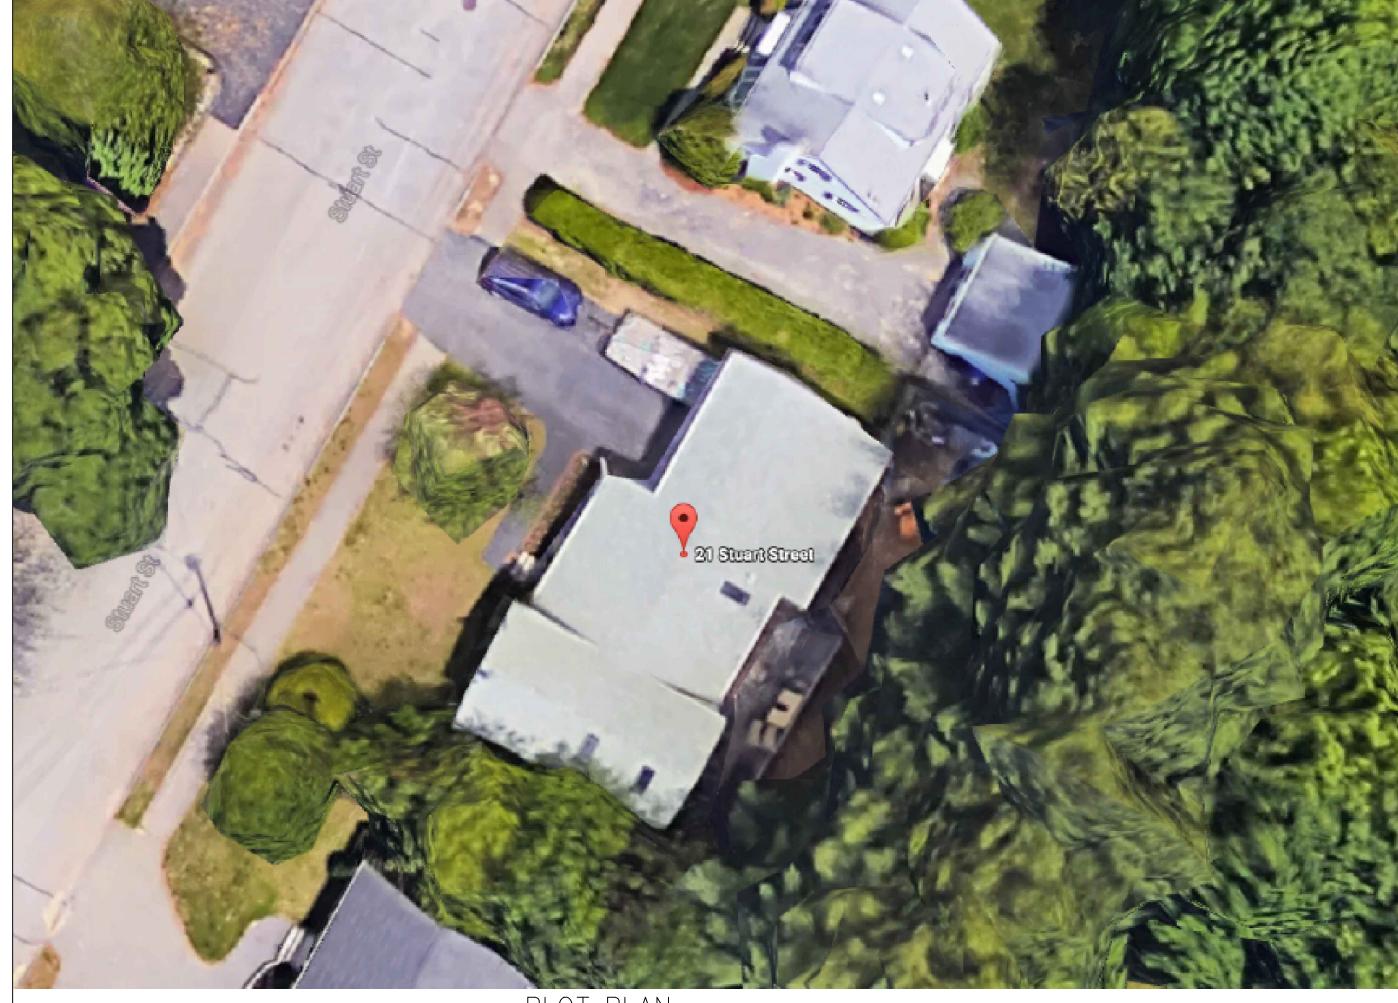

# PLOT PLAN

### **GENERAL NOTES:**

- 1. THIS PLAN IS DESIGNED TO COMPLY WITH MAINE BUILDING AND
- ENERGY CODE, 2009 IRC, AND 2009 IECC 2. ALL OTHER CODES SHALL BE THE RESPONSIBILITY OF THE
- OWNER/CONTRACTOR
- 3. ALL MECHANICAL/PLUMBING/ELEVATRICAL DESIGN BY OTHERS 4. CONTRACTOR SHALL VERIFY ALL DIMENSIONS PRIOR TO BEGINNING

### ENERGY CODE STANDARDS: ZONE 6

- 1. FENESTRATIONS -Windows u-0.35, shq-0.38
- -Doors u-0.25 -R49 (R30 at Sloping Ceiling Areas) ROOF
- 3. EXTERIOR WALLS -R19 (at New Construction)
- 4. BASEMENT CONC. WALLS (Exist to Remain)

### ENERGY CODE NOTES:

- 1. ALL JOINTS AND PENETRATIONS SHALL BE CAULKED, GASKETED, OR COVERED WITH MOISTURE VAPOR-PERMEABLE WRAPPING MATERIAL
- 2. COMPONENT R-VALUES & U-FACTORS SHALL BE LABELED AS
- CERTIFIED. 3. INSULATION SHALL BE INSTALLED ACCORDING TO MFRS.
- INSTRUCTIONS, AND IN A MANNER THAT ACHIEVES THE REQ'D
- 4. STAIR, ELEVATOR SHAFT VENTS, AND OTHER OUTDOOR INTAKE AND
- EXHAUST OPENINGS SHALL BE EQUIPPED WITH MOTORIZED DAMPERS. 5. RECESSED LIGHTING FIXTURES INSTALLED IN THE BUILDING ENVELOPE SHALL BE TRYPE IC RATED AS MEETING ASTM E283, AND SEALED OR

CODE REVIEW NFPA 101 Chapter 24 One and Two Family Dwellings 24.2 Means of Egress — One primary means of egress and one secondary means of escape is required from every sleeping room and every living area. This design meets this requirement 24.2.5 Stairs — min. width =36in. 24.2.6 Hallways — min. width 36in 24.2.7 Bulkheads — shall provide direct access to the basement, are

exempt from requirements of 24.2.5.1 24.3.4.1 Smoke alarms shall be provided in each sleeping room, outside each separate sleeping area in the immediate vicinity, and on each additional level including attic and basement, and shall be interconnect

per this code 24.3.5.2 Sprinkler system is required per NFPA 13D Single Family Residence Code Review 21 STUART STREET PORTLAND, MAINE

### CODE REVIEW: IRC2009

SECT 301 DESIGN CRITERIA Design Wind speed = 100mph, therefore design per IRC Design Snow, Pg= 60psf, therefore design per IRC

For additional structural design criteria, refer to Structural notes.

SECT 302 FIRE RESISTANT CONSTRUCTION

R302.1 Exterior Walls shall comply with Table R302.1

Not within 5ft of property line.

R302.7 Under stair protection is required for accessible spaces below stairs R302.9 Wall and ceiling finishes shall meet flame spread <200 and smoke index <450.

R302.10 Insulation materials including vapor barriers shall meet flame spread <25 and smoke index <450 except as otherwise

R302.11 Fireblocking is required at floors and ceilings, top and bottom of stair runs, and openings at vents, pipes, ducts, cables

and wires with materials approved in this code R302.12 Draftstoping at floor/ceilings is not required for this project

R302.13 Recessed lights, fans, etc shall be installed per this section R303 LIGHT VENTILAITION AND HEATING

R303.1 Habitable rooms shall have glazing >8 % of floor area, with 4% openable R303.3 Bathrooms, min. glazing area of 3 sq. ft. with half openable

R303.6 Stairways shall have artificial illumination per this section

R303.8 Heating shall be provided per the requirements of this code R304 MINIMUM R00M AREA requirements have been met in these plans

R305 CEILING HEIGHT min. of 7ft has been met R306 SANITATION requirements have been met

R307 TOILET, BATH AND SHOWER SPACES comply with this section R308 GLAZING shall comply with the requirements of this section

R310 EMERGENCY ESCAPE is required from the basement and sleeping rooms — Complies.

R311 MEANS OF EGRESS each unit in these plans has one egress in compliance with this section

R311.6 Hallways are > 36 in. wide

R311.7 Stairways, handrails, rise and run, nosings, headroom, etc are in compliance with this code refer to stairway sections and details within (these are existing)

R313 AUTOMATIC SPRINKLER SYSTEMS R313.2, new two family dwellings shall have an automatic sprinkler system complying with NFPA13D

R314 SMOKE ALARMS shall be provided in each sleeping room, outside each separate sleeping area in the immediate vicinity, and

on each additional level including attic and basement, and shall be interconnect per this code R315 CARBON MONOXIDE ALARMS shall be provided in the immediate vicinity outside sleeping areas

CHAPTER 6 WALL CONSTRUCTION 602.10.1 Braced Wall Panels Mixed wall types are used First Floor Walls are Existing

CHAPTER 11 ENERGY EFFICIENCY Table N1101.2 Climate zone 6A

Windows, U = 0.35, SHGC = NRDoors, U = 0.35

Glazed Fenestrations, U = 0.35, SHGC = NR Attic, R= 49 (R30 if uncompressed over exterior walls and at Sloped Ceilings)

Exterior walls, R=20 Basement, R= 30 at ceiling **RESIDENTIAL SPECIFICATIONS:** 

FLOOR SYSTEM: 14" ENGINEERED JOIST @ 16"o.c. 2x8 SPF #1/2 JOIST @ 12"o.c. SHEATHING AS INDICTED (3/4")

EXTERIOR WALLS: 2x6 Studs as Indicated (16"oc) Sheathing as Indicated  $(\frac{7}{16})$ Air Infiltration Wrap Siding/Finish as Indicated

INTERIOR WALLS: 2x4 Studs @ 16"oc <sup>1</sup>/<sub>2</sub>" Gypboard as Indicated

ROOF SYSTEM: Rafters/Trusses as Indicated Sheathing as Indicated (5") 15# Underlayment Ice & Water Shield at Eaves/Valleys 235# Asphalt Shingles as Indicated

INSULATION: Exterior Walls R-19 Attic Cap R-49 Sills -Existing

**VENTILATION:** Soffit - 2"Contin. Strip Ridges — Contin. Shingle Circulation Vents Between Rafters/Trusses

BEAMS/HEADERS: (3)2x6 Max. 40" Span (3)2x10s Max 76" Span Min. 4" Bearing all Beams

INTERIOR FINISHES: <sup>1</sup>/<sub>2</sub>" Gypboard or As Indicated At Walls/Ceilings Flooring As Indicated Paint/Stain As Indicated

Note: Items not Indicated Shall be Per Contract

### DRAWING LIST:

COVER SHEET A-1FLOOR PLANS ELEVATIONS A-2A-3FRAMING PLANS SECTIONS & NOTES

> ISSUED FOR PERMIT ONLY NOT FOR CONSTRUCTION 4/26/17

These drawings are the property of MacLeod Structural Engineers, PA and are for the exclusive use of:

Use of these drawings by others without written consent is prohibited.

MACLEOD STRUCTURAL ENGINEERS, PA 90 Bridge Street Suite 252 Westbrook, Maine 04092 207.839.0980 SECOND FLOOR ADDITION

21 STUART STREET

PORTLAND, MAINE

BRUCE W.

MACLEOD

No. 5422

COVER SHEET

DATE: 04.25.17 DRAWN BY: JJL DRAWNG NUMBER: SCALE: as noted PROJ NO: 2017-037 A -0.0