

335-C-D74001
68-68 Beverly St., Portland ME
1A-403 Street Ext. (Beverly street)
Siversified properties Inc
P.O. BOX 10127, Portland, ME 0 4104

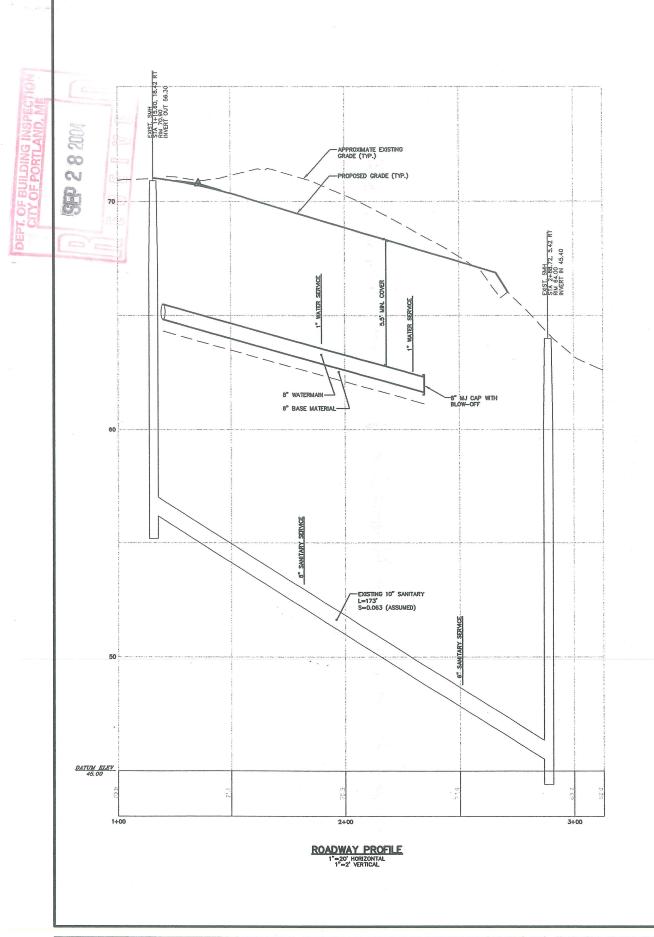

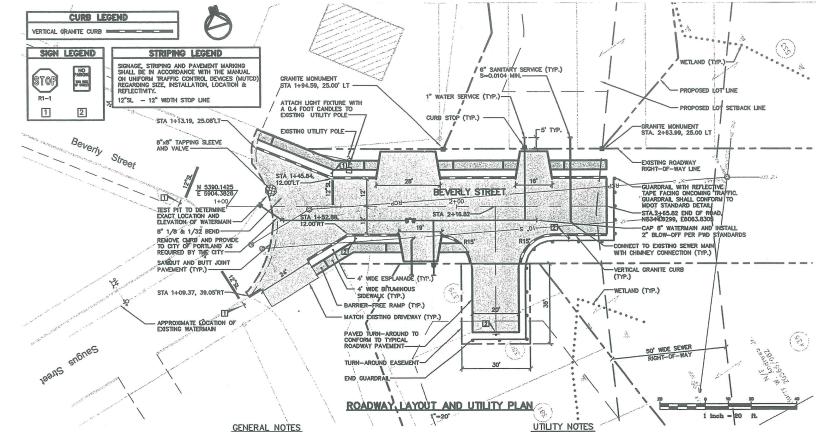

GENERAL NOTES

- 1. TOPOGRAPHIC DATA AND EXISTING CONDITIONS ARE BASED UPON A GROUND SURVEY CONDUCTED BY TITCOMB ASSOCIATES IN 2004.
- 2. WETLANDS SHOWN ON PLANS WERE DELINEATED BY SWEET ASSOCIATES OF FALMOUTH, MAINE AND FIELD LOCATED BY TITCOMB ASSOCIATES.
- 3. THE CONTRACTOR SHALL PROVIDE, ERECT AND MAINTAIN ALL NECESSARY BARRICADES, LIGHTS, WARNING SIGNS AND OTHER DEVICES TO SAFEGUARD TRAFFIC PROPERLY WHILE WORK IS IN PROGRESS.
- . THE CONTRACTOR IS SPECIFICALLY CAUTIONED THAT THE LOCATION 4. THE CONTRACTOR IS SPECIFICALLY CAUTIONED THAT THE LOCATION AND/OR THE ELEVATION OF THE EASTING UTILITIES AS SHOWN ON THESE PLANS IS BASED ON RECORDS OF THE VARIOUS UTILITY COMPANIES AND WHERE POSSIBLE MEASUREMENTS TAKEN IN THE FIELD. THIS INFORMATION IS NOT TO BE RELIED ON AS BEING EXACT OR COMPLETE. THE CONTRACTOR MUST CALL THE APPROPRIATE UTILITY COMPANY AND DIG SAFE AT LEAST 72 HOURS PRIOR TO ANY EXCAVATION TO REQUEST EXACT FIELD LOCATION OF UTILITIES. IT SHALL BE THE RESPONSIBILITY OF THE CONTRACTOR TO RELOCATE ALL EXISTING UTILITIES WHICH CONFLICT WITH THE PROPOSED IMPROVEMENTS SHOWN ON THE PLANS.
- 5. MAINTENANCE OF EROSION CONTROL MEASURES IS OF PARAMOUNT IMPORTANCE TO THE OWNER AND THE CONTRACTOR IS RESPONSIBLE FOR IMPORTANCE TO THE OWNER AND THE CONTROL MEASURES SHOWN ON THE PLANS.

 ADDITIONAL EROSION CONTROL MEASURES SHOWN ON THE PLANS.

 ADDITIONAL EROSION CONTROL MEASURES SHALL BE INSTALLED IF DEEMED NECESSARY BY ON—STE INSPECTIONS OF THE OWNER OR THEIR REPRESENTATIVES AT NO ADDITIONAL COST TO THE OWNER.
- 6. ALL MATERIAL SCHEDULES SHOWN ON THE PLANS ARE FOR GENERAL INFORMATION ONLY. THE CONTRACTOR SHALL PREPARE HIS OWN MATERIAL SCHEDULES BASED UPON HIS PLAN REVIEW. ALL SCHEDULES SHALL BE VERIFIED IN THE FIELD BY THE CONTRACTOR PRIOR TO ORDERING MATERIALS OR PERFORMING WORK.
- 8. NO PUBLIC SERVICES (I.E. SNOW PLOWING, TRASH REMOVAL, LIGHTING) WILL BE PROVIDED UNLESS AND UNTIL THIS SECTION OF BEVERLY STREET IS ACCEPTED BY THE CITY COUNCIL.

LAYOUT NOTES

- 1. ALL DIMENSIONING, UNLESS NOTED OTHERWISE, IS TO THE FACE OF CURB.
- 2. OFFSETS TO CATCH BASINS AND MANHOLES ARE TO THE CENTER OF THE FRAME.
- 3. PIPE LENGTH ECUALS THE CENTER TO CENTER DISTANCES BETWEEN CATCH BASINS AND/OR MANHOLES MINUS ONE—HALF OF THE DIAMETER OF EACH CATCH BASIN OR MANHOLE.
- 4. PROPERTY LINE AND R.O.W. MONUMENTS SHALL NOT BE DISTURBED BY CONSTRUCTION. IF DISTURBED, THEY SHALL BE RESET TO THEIR ORIGINAL LOCATIONS AT THE CONTRACTOR'S EXPENSE, BY A MAINE REGISTERED LAND SURVEYOR.
- 5. PROPOSED RIGHT OF WAY MONUMENTS AND PROPERTY LINE PINS SHALL BE INSTALLED UNDER THE DIRECTION OF A MAINE REGISTERED LAND SURVEYOR.

- 1. ALL WATER UTILITY MATERIALS AND INSTALLATION METHODS SHALL CONFORM TO PORTLAND WATER DISTRICT STANDARDS. ALL WATER DISTRIBUTION PIPING SHALL BE CLASS 52 DUCTILE IRON PIPE, DOUBLE CEMENT LINED AND BITUMINOUS COATED CONFORMING TO AWWA/ANS C104/A21.4. DISTRIBUTION OF WATER LINES SHALL CONFORM TO AWWA STANDARD C651, LATEST REVISION.
- 2. THE LOCATION OF THE PROPOSED UNDERGROUND ELECTRICAL SERVICE SHALL BE COORDINATED WITH CENTRAL MAINE POWER COMPANY.
- 3. THRUST BLOCKS OR LOCKING RETAINER GLANDS SHALL BE PLACED ON THE WATER DISTRIBUTION LINES AT ALL BENDS, TEES, FIRE HYDRANTS, VALVES, CHANGES IN DIRECTION, ETC. THE THRUST BLOCKS OR LOCKING RETAINER GLANDS SHALL MEET THE REQUIREMENTS OF THE PORTLAND WATER DISTRICT STANDARDS.

GRADING AND DRAINAGE NOTES

1. UNLESS OTHERWISE NOTED, ALL STORM DRAIN PIPE SHALL BE IN ACCORDANCE WITH MDDT SPECIFICATIONS SECTION 803—— PIPE CULVERTS AND STORM DRAINS, LATEST REVISION WITH THE EXCEPTION THAT THE ONLY ACCEPTABLE TYPES OF PIPE ARE AS FOLLOWS:

REINFORCED CONCRETE PIPE, CLASS III POLYVINYL-CHLORIDE (PVC) PIPE

- TOPSOIL STRIPPED IN AREAS OF CONSTRUCTION THAT IS SUITABLE FOR REUSE AS LOAM SHALL BE STOCKPILED ON SITE AT A LOCATION TO BE DESIGNATED BY THE OWNER. UNSUITABLE SOIL SHALL BE SEPARATED, REMOVED AND DISPOSED OF AT AN APPROVED DISPOSAL LOCATION OFF SITE.
- 3. THE CONTRACTOR SHALL ANTICIPATE THAT GROUNDWATER WILL BE ENCOUNTERED DURING CONSTRUCTION AND SHALL INCLUDE SUFFICIENT COSTS WITHIN THEIR BID TO PROVIDE DEWATERING AS NECESSARY. NO SEPARATE PAYMENT SHALL BE MADE TO THE CONTRACTOR FOR DEWATERING.

EROSION CONTROL NOTES

- LAND DISTURBING ACTIVITIES SHALL BE ACCOMPLISHED IN A MANNER AND SEQUENCE THAT CAUSES THE LEAST PRACTICAL DISTURBANCE OF THE SITE.
- 2. ALL GROUND AREAS DISTURBED FOR CONSTRUCTION WILL BE GRADED, LOAMED AND SEEDED AS SOON AS POSSIBLE.
- 3. ALL NON-PAVED AREAS DISTURBED DURING CONSTRUCTION SHALL BE LOAMED AND SEEDED, UNLESS OTHERWISE DIRECTED BY THE OWNER.
- 4. ALL DISTURBED AREAS ARE TO RECEIVE A MINIMUM OF $4^{\rm o}$ OF TOPSOIL PRIOR TO PERMANENT SEEDING.

-	-	_	CITY STAFF REVIEW	9/27/04	DER
Rev.	Date	Revision	Issued For	Date	Ву

cked: DER Scale: AS NOTED Job No.: 1081 This plan shall not be modified without writ Engineers, Inc.(GPCEI). Any alterations,

authorized or otherwise, shall be at the user sole risk and without liability to GPCEI.

_4'-02-4'-02

RANITE CURB (T

1" HOT BITUMINOUS PAVEMENT GRACING "C".
2" HOT BITUMINOUS PAVEMENT GRADING "B".
10" AGGREGATE BASE — CRUSHED TYPE "A"

TYPICAL DRIVEWAY APRON SECTION

LDAM AND SEED (TYP)
HOT BITUMINOUS PAVEMENT GRADING "C" (TYP)
AGGREGATE BASE — TYPE A" (TYP)

Gorrill-Palmer Consulting Engineers, Inc.

1/2" HOT BITUMINOUS PAVEMENT GRADING "B"

"HOT BITUMINOUS PAVEMENT GRADING "B"

"AGGREGATE BASE COURSE — TYPE "A"


"AGGREGATE SUBBASE — TYPE "A"

TYPICAL ROADWAY SECTION
N.T.S.

PO Box 1237 PO Box 1237 Traffic and Civil Engineering Services 207-657-6910 15 Shaker Road FAX: 207-657-6912 Roadway Layout & Utility Plan

BEVERLY STREET, PORTLAND, MAINE

Diversified Properties P.O. Box 10127, 449 Forest Avenue, Portland ME 04104 Drawing No.

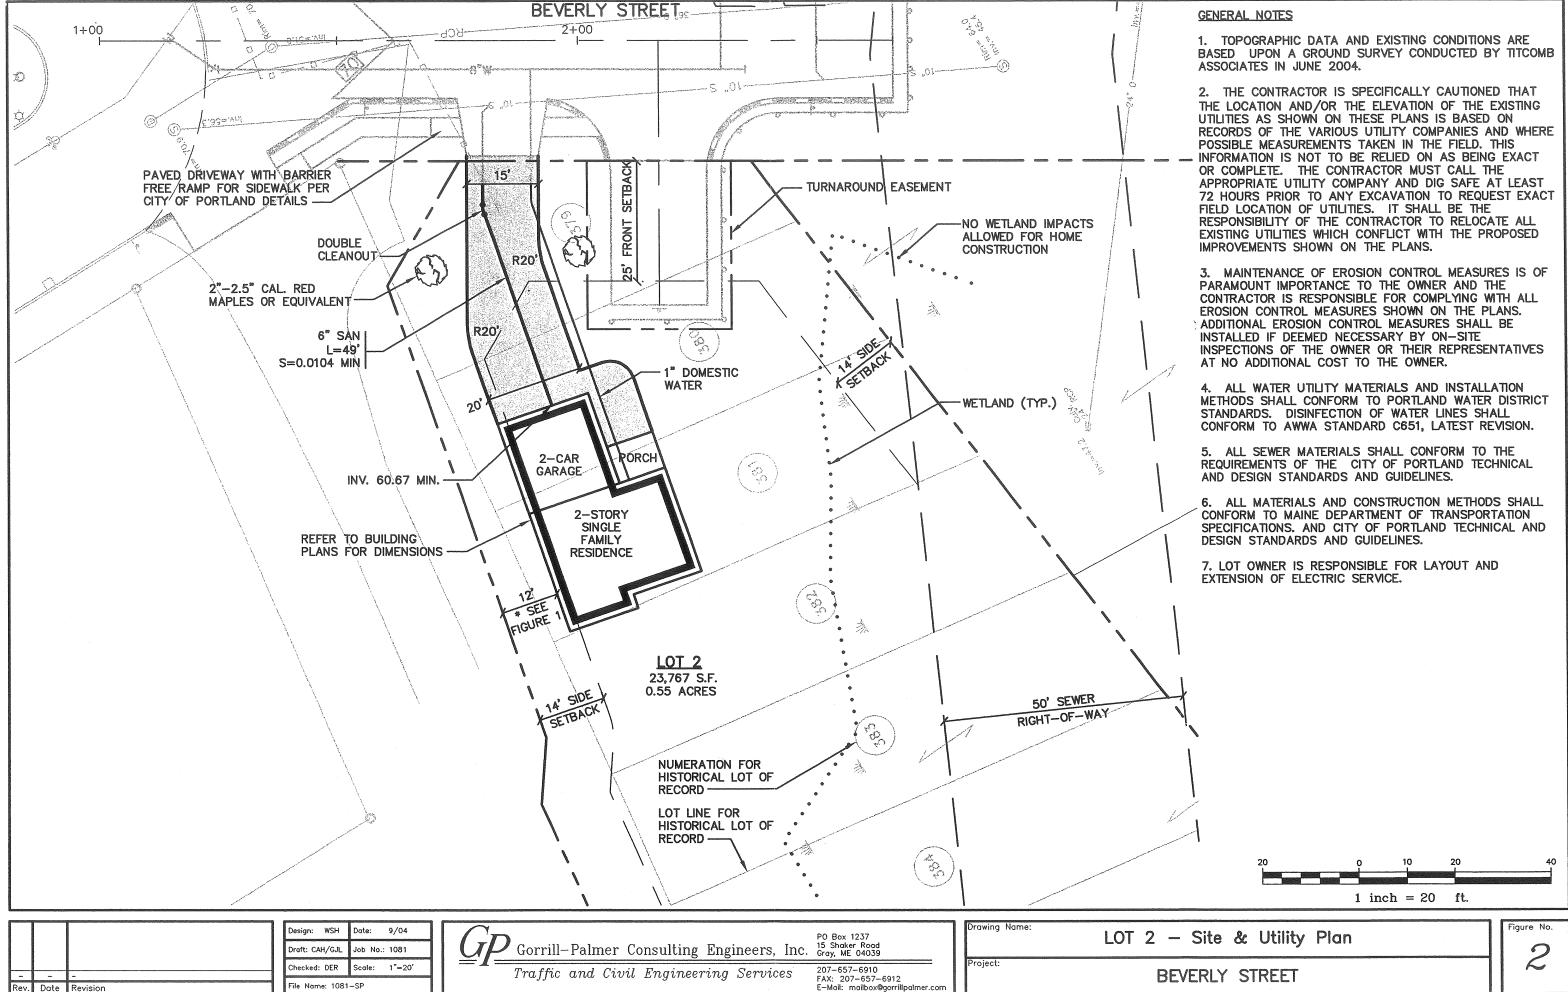

File Name: 1081-SP

Rev. Date Revision



SPACE AND BULK REQUIREMENTS - R-2 ZONE

MINIMUM LOT SIZE:

10,000 S.F.

MINIMUM FRONTAGE:

50 FT.

MINIMUM SETBACKS:

FRONT YARD 25 FT.
REAR YARD 25 FT
SIDE YARD*

YARD*
1 STORY 12 FT.
1 1/2 STORY 12 FT.
2 STORY 14 FT.
2 1/2 STORY 16 FT.

MINIMUM LOT WIDTH:

80 FT.

* THE WIDTH OF ONE (1) SIDE YARD MAY BE REDUCED ONE (1) FOOT FOR EVERY FOOT THAT THE OTHER SIDE YARD IS CORRESPONDINGLY INCREASED, BUT NO SIDE YARD SHALL BE LESS THAN TWELVE (12) FEET IN WIDTH.

THE SIDE YARDS SHOWN ON THE FOLLOWING FIGURES ARE BASED UPON A 2 STORY STRUCTURE AND MAY BE INCREASED OR DECREASED DEPENDING UPON THE NUMBER OF STORIES.

Design: DER	Date: SEPT 04							
Draft: CAH	Job No.: 1081							
Checked: AMP	Scale: NTS							
File Name: 1081-SP.DWG								

GE) Traffic	and	Civil	Engin	eering	Services
	PO Box Gray, MI 207-65	E 04	039	Shaker	Road	


Space & Bulk Requirements

Project:

BEVERLY STREET, PORTLAND

Figure No.

1

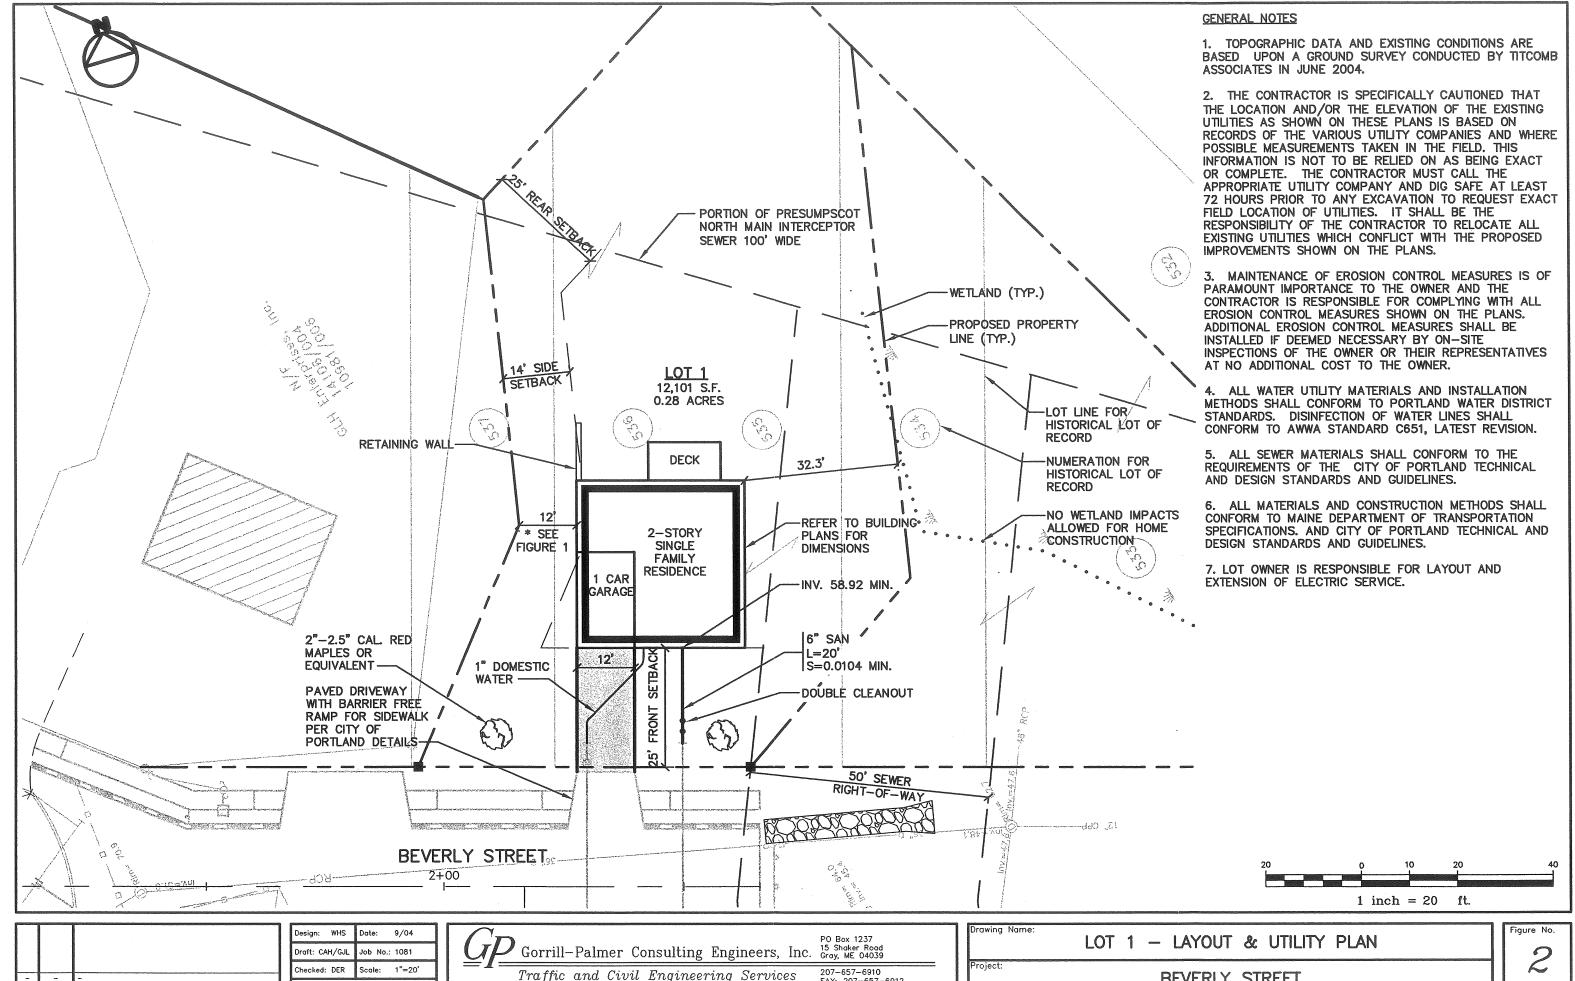


FAX: 207-657-6912 E-Mail: mailbox@gorrillpalmer.com

File Name: 1081-SP

Rev. Date Revision

BEVERLY STREET

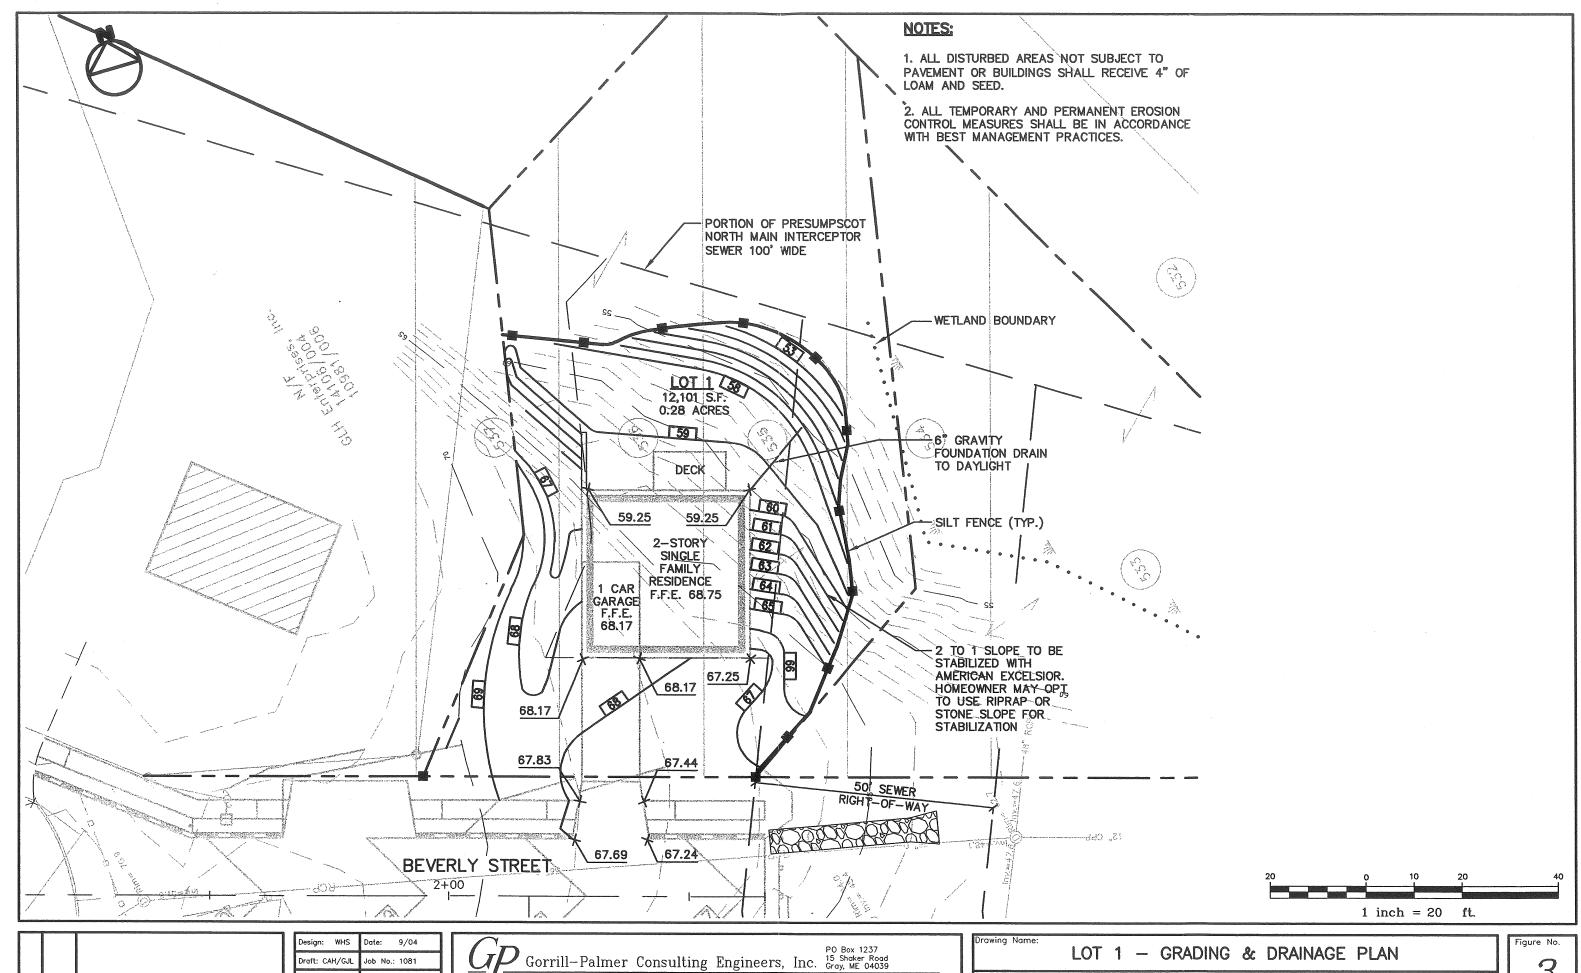

Rev. Date Revision

Checked: DER Scale: 1"=20' File Name: 1081-SP

207-657-6910 FAX: 207-657-6912 E-Mail: mailbox@gorrillpalmer.com Traffic and Civil Engineering Services

BEVERLY STREET