

- ICE & WATER SHIELD @ ROOF EDGE, ALL ROOF JOINTS AND TRANSITIONS, ALL ROOF PENETRATIONS PER MANUF. RECOMMENDATIONS.
- 3. §" CDX PLYWD
- 4. WOOD RAFTERS (SEE FRAMING PLANS)
- 5. CONT. DRIP EDGE FLASHING
- 6. 1x3 WOOD STRAPPING
- 7. GYPSUM WALL BOARD (SEE WALL TYPES)
- 8. 1x4 WOOD TRIM
- 9. 1x8 WOOD TRIM
- IØ. CONT. SOFFIT VENT
- II. FINISH FLOOR BY OWNER
- 12. FLOOR SYSTEM F2
- 13. CEILING SYSTEM FI
- 14. EXTERIOR WALL, 2×6 STUDS @ 16" O.C. WITH $\frac{1}{2}$ " CDX PLYWOOD, OR EQUAL, HOUSE WRAP ON $\frac{1}{2}$ " FIBERBOARD, EXTERIOR SIDING PER OWNER ON 1×3 FURRING. INSULATION MIN. 3" SPRAY-FOAM, R-21
- 15. 8" CONC. CAST IN PLACE WALL.

 DAMPPROOFING PER IRC 406.1, WITH


 INTERIOR 2×4 STUDS @ 16" O.C. \$ 3" MIN.

 RIGID INSULATION \$ \frac{1}{2}" GWB FINISHED PER
- 16. 4" FOUNDATION DRAIN. PROVIDE FILTER FABRIC OVER TOP OF DRAIN AND MIN 2" CRUSHED ROCK UNDER DRAIN.
- 17. 4" SLAB ON GRADE WITH VAPOR BARRIER AND MIN. 2" RIGID INSULATION ON MIN. 6" OF COMPACTED STRUCTURAL GRAVEL.


 PROVIDE MIN. THERMAL BREAK @ CONC. FOUNDATION WALL.
- 18. SILL PLATES SHALL BE ANCHORED TO THE FOUNDATION WITH ANCHOR BOLTS SPACED A MAX. OF 6' O.C., BOLTS SHALL BE AT LEAST ½" IN DIAMETER AND SHALL EXTEND A MINIMUM OF 1" INCHES INTO CONCRETE SILL PLATE SHALL BE P.T 2x6 WITH SILL SEAL OR CONT. SILL GASKET.
- 19. DRAINAGE GRAVEL
- 20. NEW MIN 20"XIO" SPREAD FOOTING
- 21. 6" MIN COMPACTED STRUCTURAL GRAVEL
- 22. SIDING BY OWNER

23. 2x6 TOP PLATE(S)

- 24. 2x6 BOTTOM PLATE(S)
- 25. RIM JOIST
- 26. WOOD JOISTS (SEE FRAMING PLAN)
- 27. 2" XPS RIGID INSULATION
- 28. PROVIDE CAULKING @ WINDOW FRAME, HEAD, JAMBS & SILL.
- 29. SEAL VAPOR BARRIERS @ WALL & ROOF/CEILING W/CONT. BEAD ACOUSTICAL SEALANT.
- 30. WRAP FLOOR FRAMING W/VAPOR BARRIER & SEAL TO WALL VAPOR BARRIER W/CONT. BEAD ACOUSTICAL SEALANT.

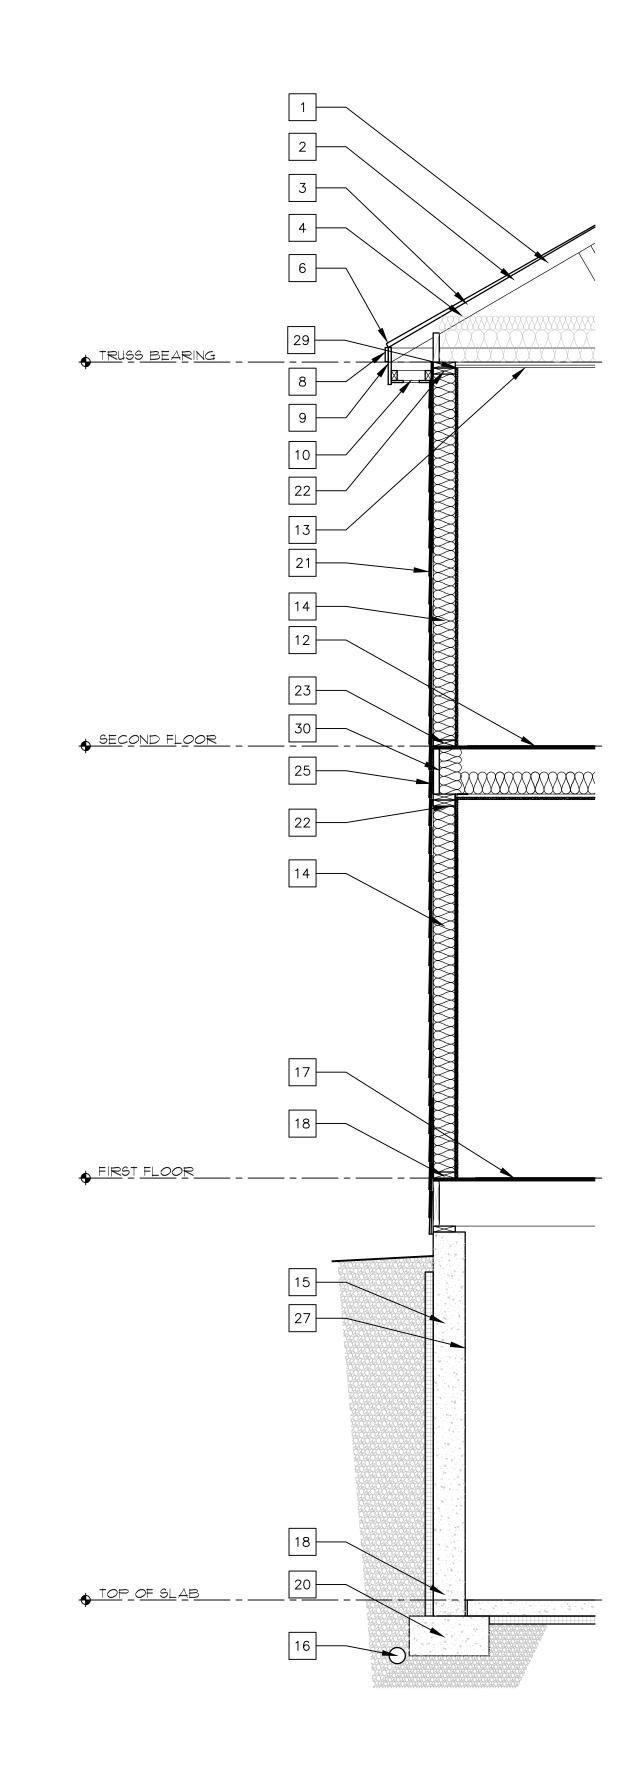



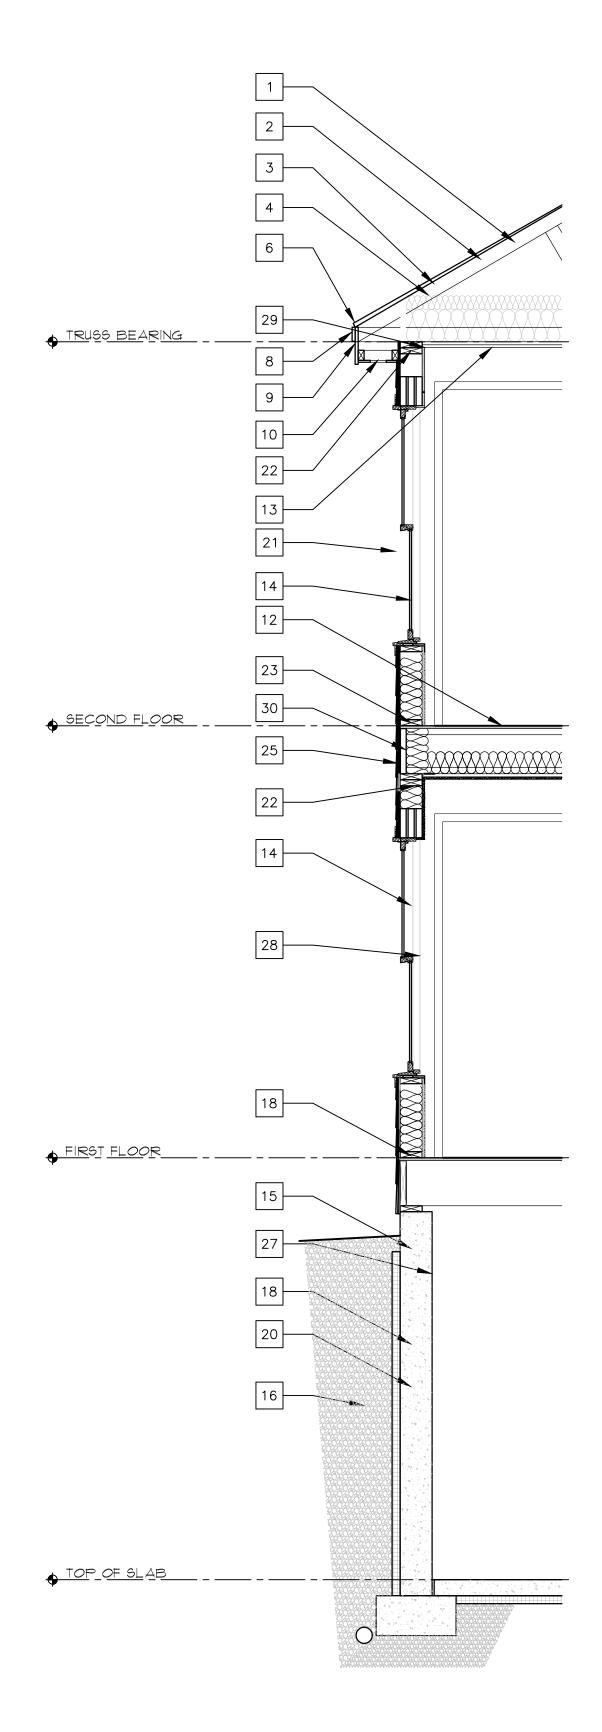

anaug

for

IRC 2009

Portland

As Noted

TOWN:

DRAWN:

WALL

SHEET:

SECTIONS

A2-02

TITLE:

DATE: 06-24-2012

TYPICAL WALL SECTION @ WINDOWS

SCALE: 1/2"=1'-0"

<u>NOTE</u>:

THE CONTRACTOR/OWNER ASSUMES ALL RESPONSIBILITY
FOR LOCAL CODE COMPLIANCE.
ALL DRAWINGS, PLANS, SKETCHES ETC. ARE PROVIDED TO OUR
CLIENTS BASED UPON INFORMATION PROVIDED BY THE CLIENT
AND DRAWN IN ACCORDANCE WITH COMMON BUILDING PRACTICES
AND LOCAL CODES, NONE OF THE EMPLOYEES OF CDT
ARE REGISTERED ARCHITECTS, ENGINEERS OR LAND
SURVEYORS, ALL DIMENSIONS AND SPECIFICATIONS SHOULD BE VERIFIED
BY CLIENT AND/OR CONTRACTOR BEFORE ACTUAL CONSTRUCTION
BEGINS. IF DIMENSIONS AND SPECIFICATIONS ARE NOT VERIFIED
BY CLIENT AND/OR CONTRACTOR BEFORE ACTUAL CONSTRUCTION
BEGINS CDT WILL BE HELD HARMLESS
CDT ASSUMES NO LIABILITY FOR CHANGES
AND/OR REVISIONS MADE TO PLANS BY CLIENT AND/OR CONTRACTOR.

1. Contractor/owner responsible for securing all necessary permits.

2. Contractor/owner will Comply with all applicable codes and ordinances.

3. Contractor/owner to verify all site grades and dimensions.