



CIDE ELEVATION

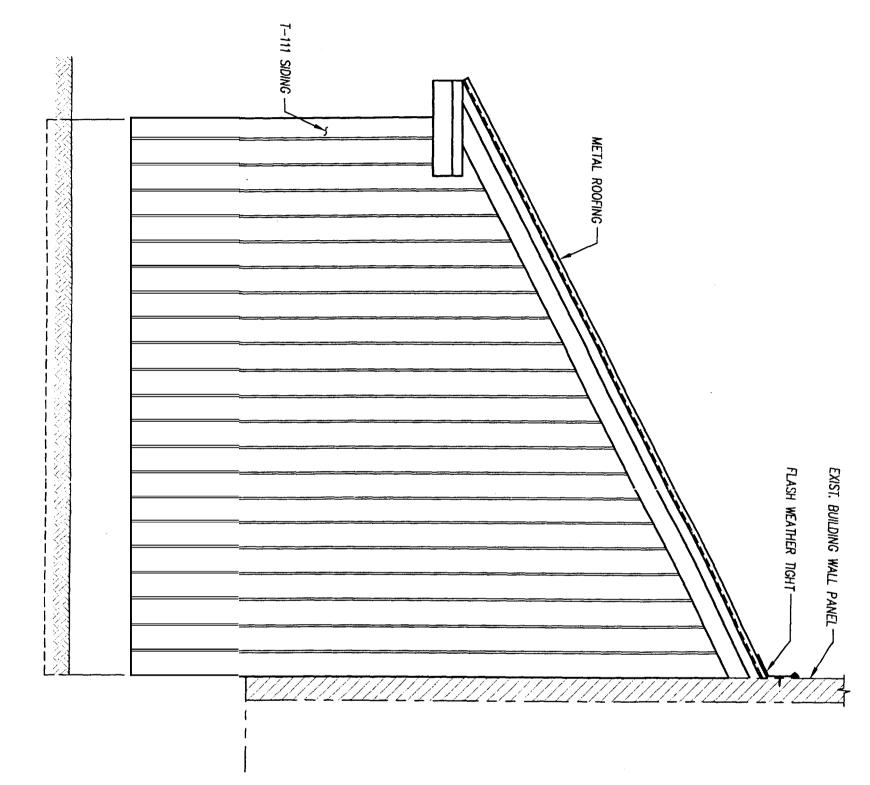


REAR ELEVATION

SCALE: ½" = 1'-0"

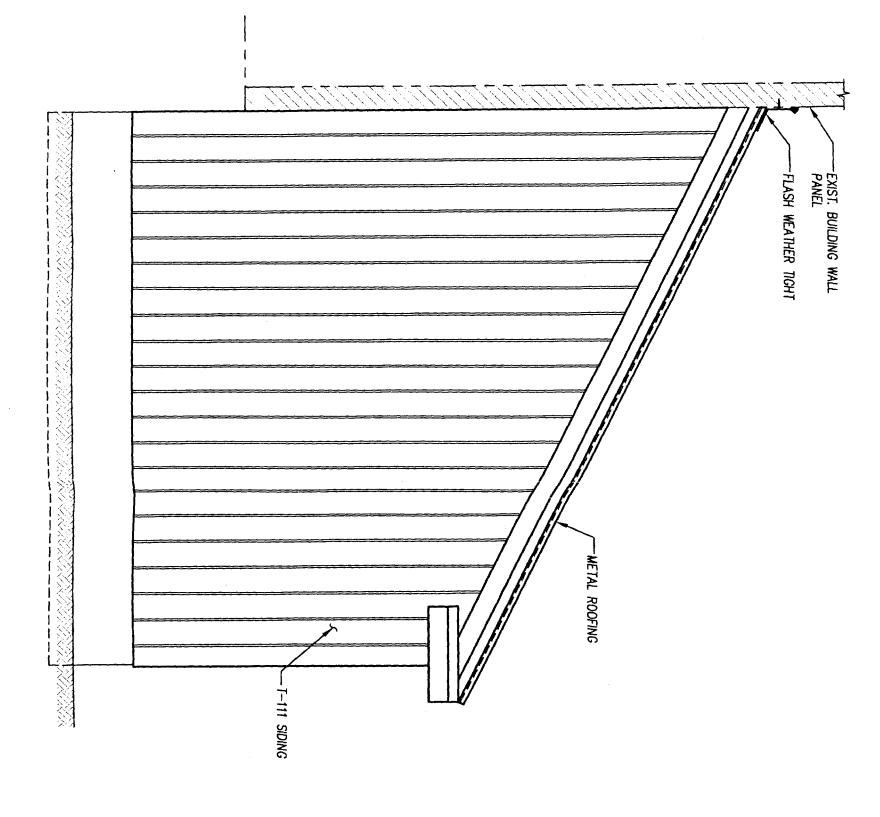

FRONT ELEVATION

SCALE: 1/2" = 1'-0"

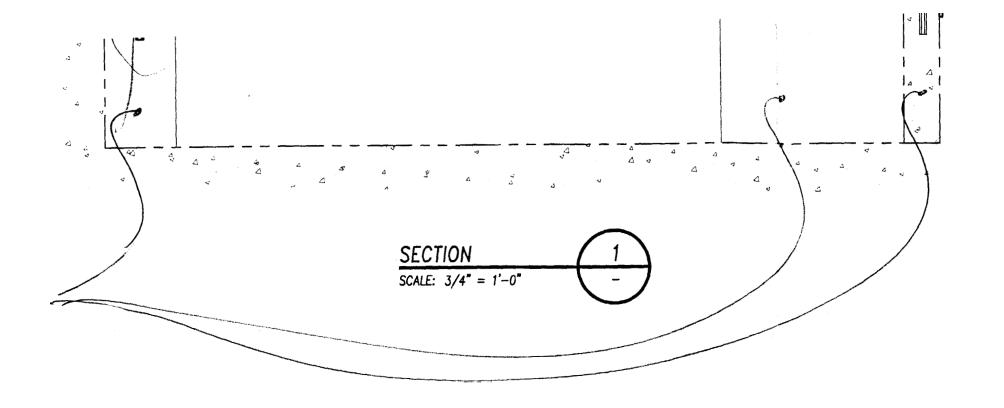

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ETTE

TIMBER FRAMING NOTES

11/07/05

- 1. ALL TIMBER MATERIALS AND WORKMANSHIP SHALL CONFORM TO THE LATEST EDITIONS OF THE AMERICAN INSTITUTE OF TIMBER CONSTRUCTION 'TIMBER CONSTRUCTION MANUAL' AND THE AMERICAN FOREST AND PAPER ASSOCIATION 'MANUAL OF ENGINEERED WOOD CONSTRUCTION'
- 2. ALL DIMENSIONAL LUMBER FOR FRAMING SHALL BE No.1/No.2 SPRIJCE-PIN-FIR UNLESS NOTED AT PRESSURE TREATED (PT). PRESSURE TREATED LUMBER SHALL BE No.1 SOUTHERN YELLOW PINE.
- 3. FOR CONNECTIONS NOT DETAILED ON THE DRAWINGS, FOLLOW THE FASTNEING SCHEDULE IN CHAPTER 23 OF THE IBC 2003 BUILDING CODE.
- 4. WALL AND ROOF SHEATHING SHAU BE BLOCKED AT ALL EDGES. FASTEN TO FRAMING WITH 10d NAILS AT 6 O.C. AT PANEL EDGES AND 12" ON CENTER FIELD.

ISSUED FOR CONSTRUCTION

5. VERSA-LAM GIRDER SHALL BE VERSA-LAM 2.0 2800 OR VERSA-LAM 2.0 3100 AS MANUFACTURED BY BOISE CASCADE OR APPROVED EQUAL.

ROBERT

MOHLIN

No. 3546


GLS SNP

MOHLIN COMPANY CONSULTING ENGINEERS 146 MAIN STREET, SUITE 300 SACO, MAINE 04072 (207) 283-9151 / FAX (207) 283-9136 (&C DRAMING NO. 2005-2901-S-100 CLIENT BARBER FOODS SOUTH PORTLAND, MAINE TITLE WASTE TREATMENT TANK BUILDING ENCLOSURE STRUCTURAL PLAN, SECTION AND NOTES

CLIENT DRAWING NUMBER

IQ I

SCALE

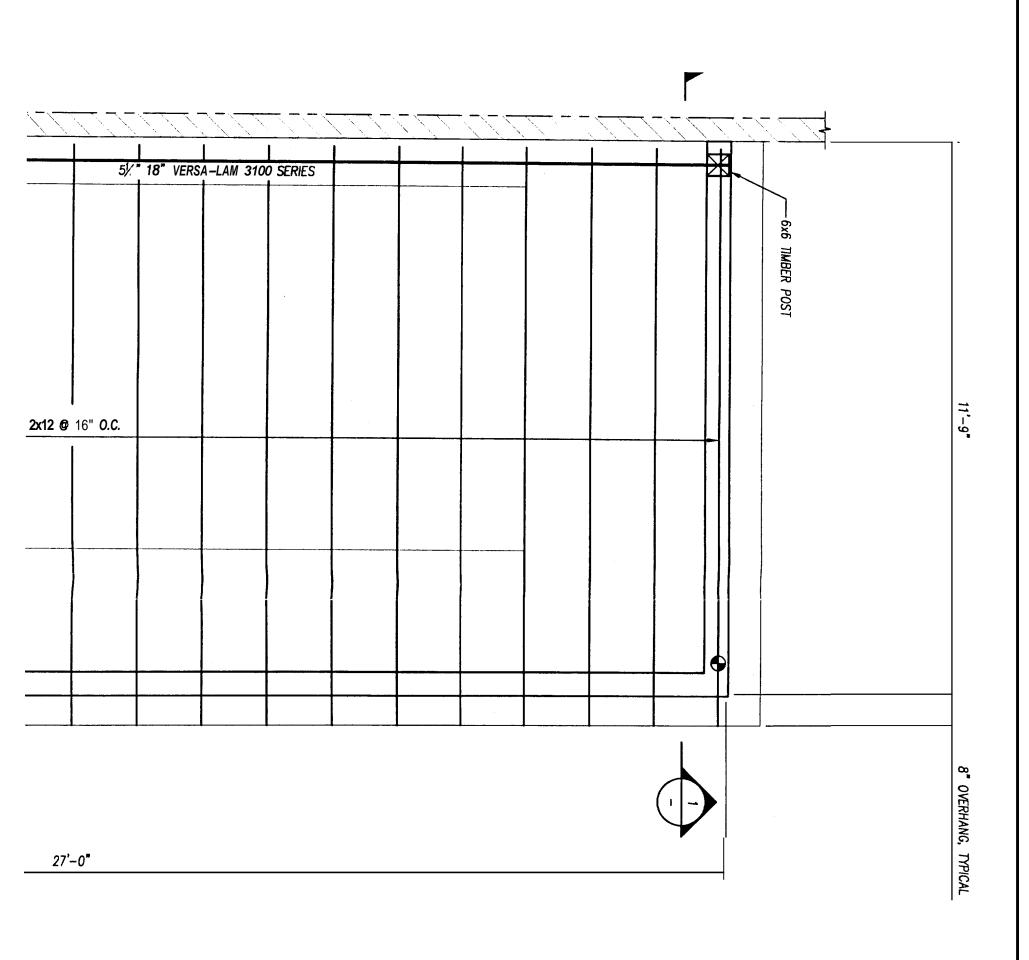

DIVER POST

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