


- PUBLIC ADDRESS SYSTEM NOTES**
- SEE DWG. E-000-C FOR DRAWING LIST, SYMBOLS, ABBREVIATIONS AND GENERAL NOTES.
 - RISER IS DIAGRAMMATIC. NOT ALL SPEAKERS ARE SHOWN. FOR EXACT QUANTITIES AND LOCATION OF DEVICES REFER TO DWGS. E-301-C, E-302-C.
 - PUBLIC ADDRESS SYSTEM RECESSED CEILING AND WALL MOUNTED SPEAKERS SHALL BE 8" AS MANUFACTURED BY ELECTRO-VOICE. AMPLIFIERS SHALL BE MODEL MA-1212 AS MANUFACTURED BY ELECTRO-VOICE, INC.
 - UNLESS OTHER WISE NOTED ALL CABLING SHALL BE INSTALLED IN CABLE TRAY AND AS FOLLOWS:
A. WALLS OR PARTITIONS - IN CONDUIT.
B. ABOVE SUSPENDED CEILING AND IN UNFINISHED AREAS - SUPPORTED BY J-HOOKS MOUNTED AS HIGH AS POSSIBLE TO BUILDING STEEL ON MAXIMUM 3' INTERVALS.
 - COORDINATE AMPLIFIER LOCATION INSIDE ROOM #216 WITH OWNER AND PROVIDE ALL RACKS, MOUNTING HARDWARE AND OTHER ACCESSORIES REQUIRED FOR A COMPLETE INSTALLATION. PROVIDE ADDITIONAL AMPLIFIER/CIRCUIT IF LOADING EXCEEDS MAXIMUM AMPLIFIER CAPACITY.
 - 2#14 STANDARD NON-SHIELDED, PLENUM RATED, GENERAL CABLE #C3128 OR APPROVED EQUAL.


1 PUBLIC ADDRESS SYSTEM RISER DIAGRAM
E-805-C N.T.S.

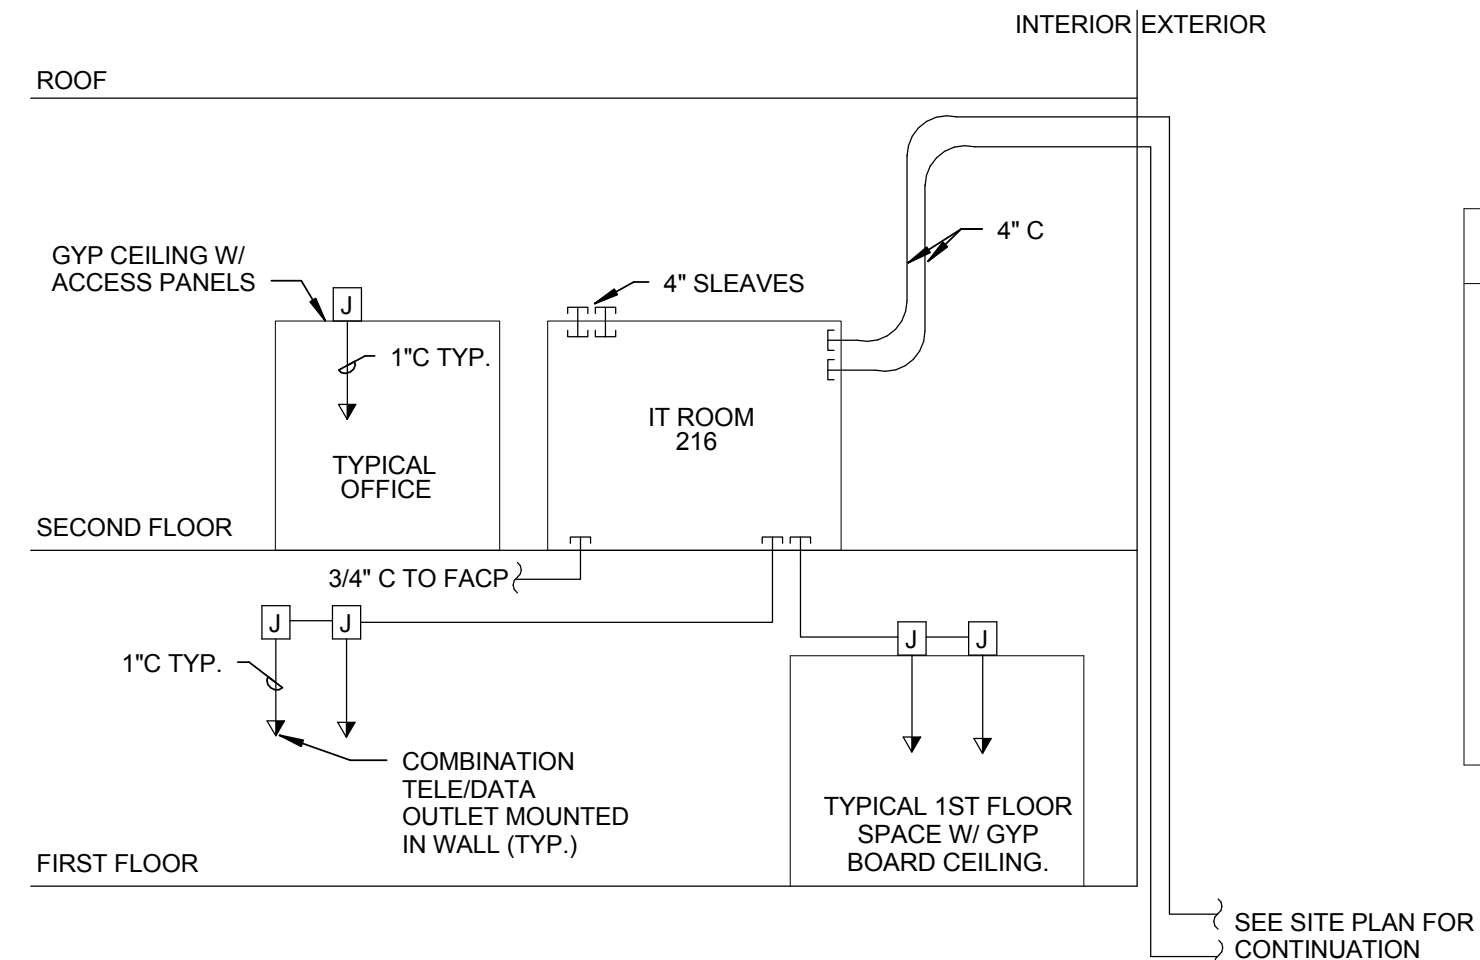

- TELEPHONE / DATA SYSTEM NOTES**
- DEVICES SHOWN ARE TYPICAL ONLY. FOR EXACT LOCATIONS AND QUANTITIES REFER TO FLOOR PLANS.
 - ELECTRICAL CONTRACTOR SHALL PROVIDE A 4" BOX WITH A REDUCING RING TO SINGLE DUPLEX AND A 1" STUB ABOVE THE FINISHED CEILING FOR ALL TEL/DATA OUTLETS. REFER TO TEL/DATA DRAWINGS FOR EXACT LOCATIONS AND QUANTITIES.
 - PROVIDE JUNCTION BOX AT CEILING ADJACENT TO POWER JUNCTION BOX FOR EACH TEL/DATA DROP IN AREAS WITH NO SUSPENDED CEILING.
 - FOR ALL FIRST FLOOR AREAS, PROVIDE CONDUIT WITH PULL STRING ALL THE WAY BACK TO THE DATA ROOM. HOME RUNS SHALL BE SIZED BASED ON 40% MAXIMUM FILL, WITH 4 CABLES 0.22" DIAMETER EACH, AT EACH STATION.
 - IT ROOM TELE/DATA EQUIPMENT SHALL BE PROVIDED BY OWNER.

2 TELEPHONE / DATA RISER DIAGRAM
E-805-C N.T.S.

Revision	By	App'd	DD.MM.YYYY
0			08/19/2016
INTERIOR FIT-OUT - ISSUED FOR CONSTRUCTION			
PACKAGE C - INTERIOR FIT-OUT			
PACKAGE B - SUPERSTRUCTURE & SHELL			
PACKAGE A - FOUNDATIONS & BELOW SLAB			
Issued			

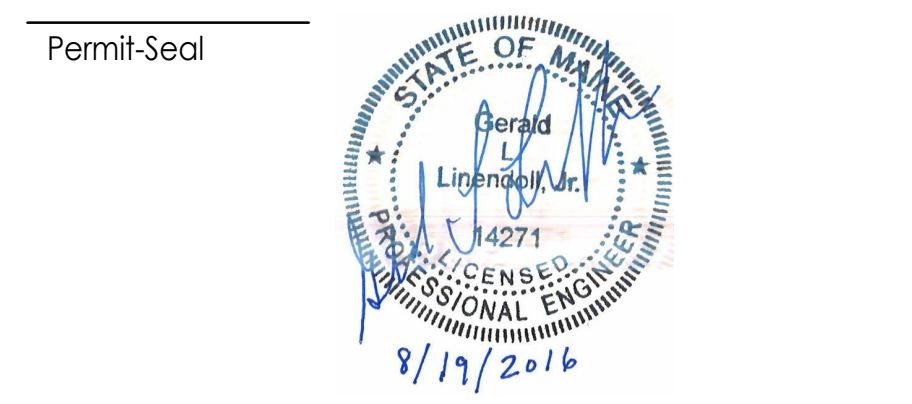

Client/Project
IMMUCELL

Lot 11 - Second Tee Business Park
1039 Riverside Street
Portland, Maine 04103

Title
COMMUNICATION RISER DIAGRAMS

Project No. 191504176	Scale N.T.S.
Revision 0	Drawing No. E-805-C