## DOOR SCHEDULE

TAG	DOOR SLAB	SIZE	THICKNESS	SWING	FIRE LABEL	FRAME	WALL THICKNESS	REMARKS	
1	ALUM.	3070	1 3/4	RH		ALUM.	4 1/8	FULL GLASS WITH SIDELIGHT	HRDWR SET #I
2	HM ·	3010	1 3/4	LH		НМ	4 7/8	24 X 30 INS. GLASS	HRDWR SET #I
3	НМ	3010	1 3/4	RH		НМ	4 1/8	·	HRDWR SET #I
					HARDWA	ARE SCH	HEDULE		
		SET #I	HING	ES, CLC	SER, LE	EVER LO	OCKSET,	WEATHERSTRIP, THRESHOLD	
			NOTE:	ALL LO	CK5 TO	BE MA	STER K	EYED	

## GENERAL NOTES

BUILDING CODES: MUBEC, IBC 2009, NFPA I (2009), NFPA IO, NFPA I3, NFPA IOI (2006), IECC 2009

PERMIT IS FOR THE CONSTRUCTION OF THE SHELL ONLY, SEPARATE PERMITS ARE REQUIRED FOR ANY FUTURE INTERIOR FIT-UP

THIS BUILDING DOES NOT HAVE A SPRINKLER SYSTEM. IF THE FUTURE OCCUPANCY REQUIRES A SPRINKLER SYSTEM, ONE WILL NEED TO BE INSTALLED.

THE BUILDING IS A PRE-ENGINEERED METAL BUILDING BY PACKAGE STEEL SYSTEMS, INC. OF SUTTON, MA .. BUILDING MANUFACTURER TO PROVIDE STRUCTURAL DESIGN, BUILDING ENVELOPE DETAILS, AND LETTER OF CERTIFICATION.

FOUNDATION DESIGN TO BE BY ASSOCIATED DESIGN PROFESSIONALS


ALL DOORS SHALL BE 3'-0" WIDE AND HAVE HANDICAPPED LEVER TYPE HARDWARE

5 LB ABC FIRE EXTINGUISHERS SHALL BE MOUNTED AT EVERY EXIT

HANDICAPPED SIGNAGE SHALL BE MOUNTED AT 5'-O" A.F.F. AT ALL FUTURE BATHROOMS AND EXITS BATHROOM AND UNDERGROUND PLUMBING WILL BE INSTALLED PER THE CITY ORDINANCES ONCE THE OCCUPANCY HAS BEEN DETERMINED, AND SHALL REQUIRE SEPARATE PERMITS.

THE FUTURE HEATING SYSTEM SHALL MEET CITY ORDINANCES AND SHALL REQUIRE SEPARATE PERMITS


SEPARATE PERMITS ARE REQUIRED FOR THE ELECTRICAL, PLUMBING, AND HVAC WORK

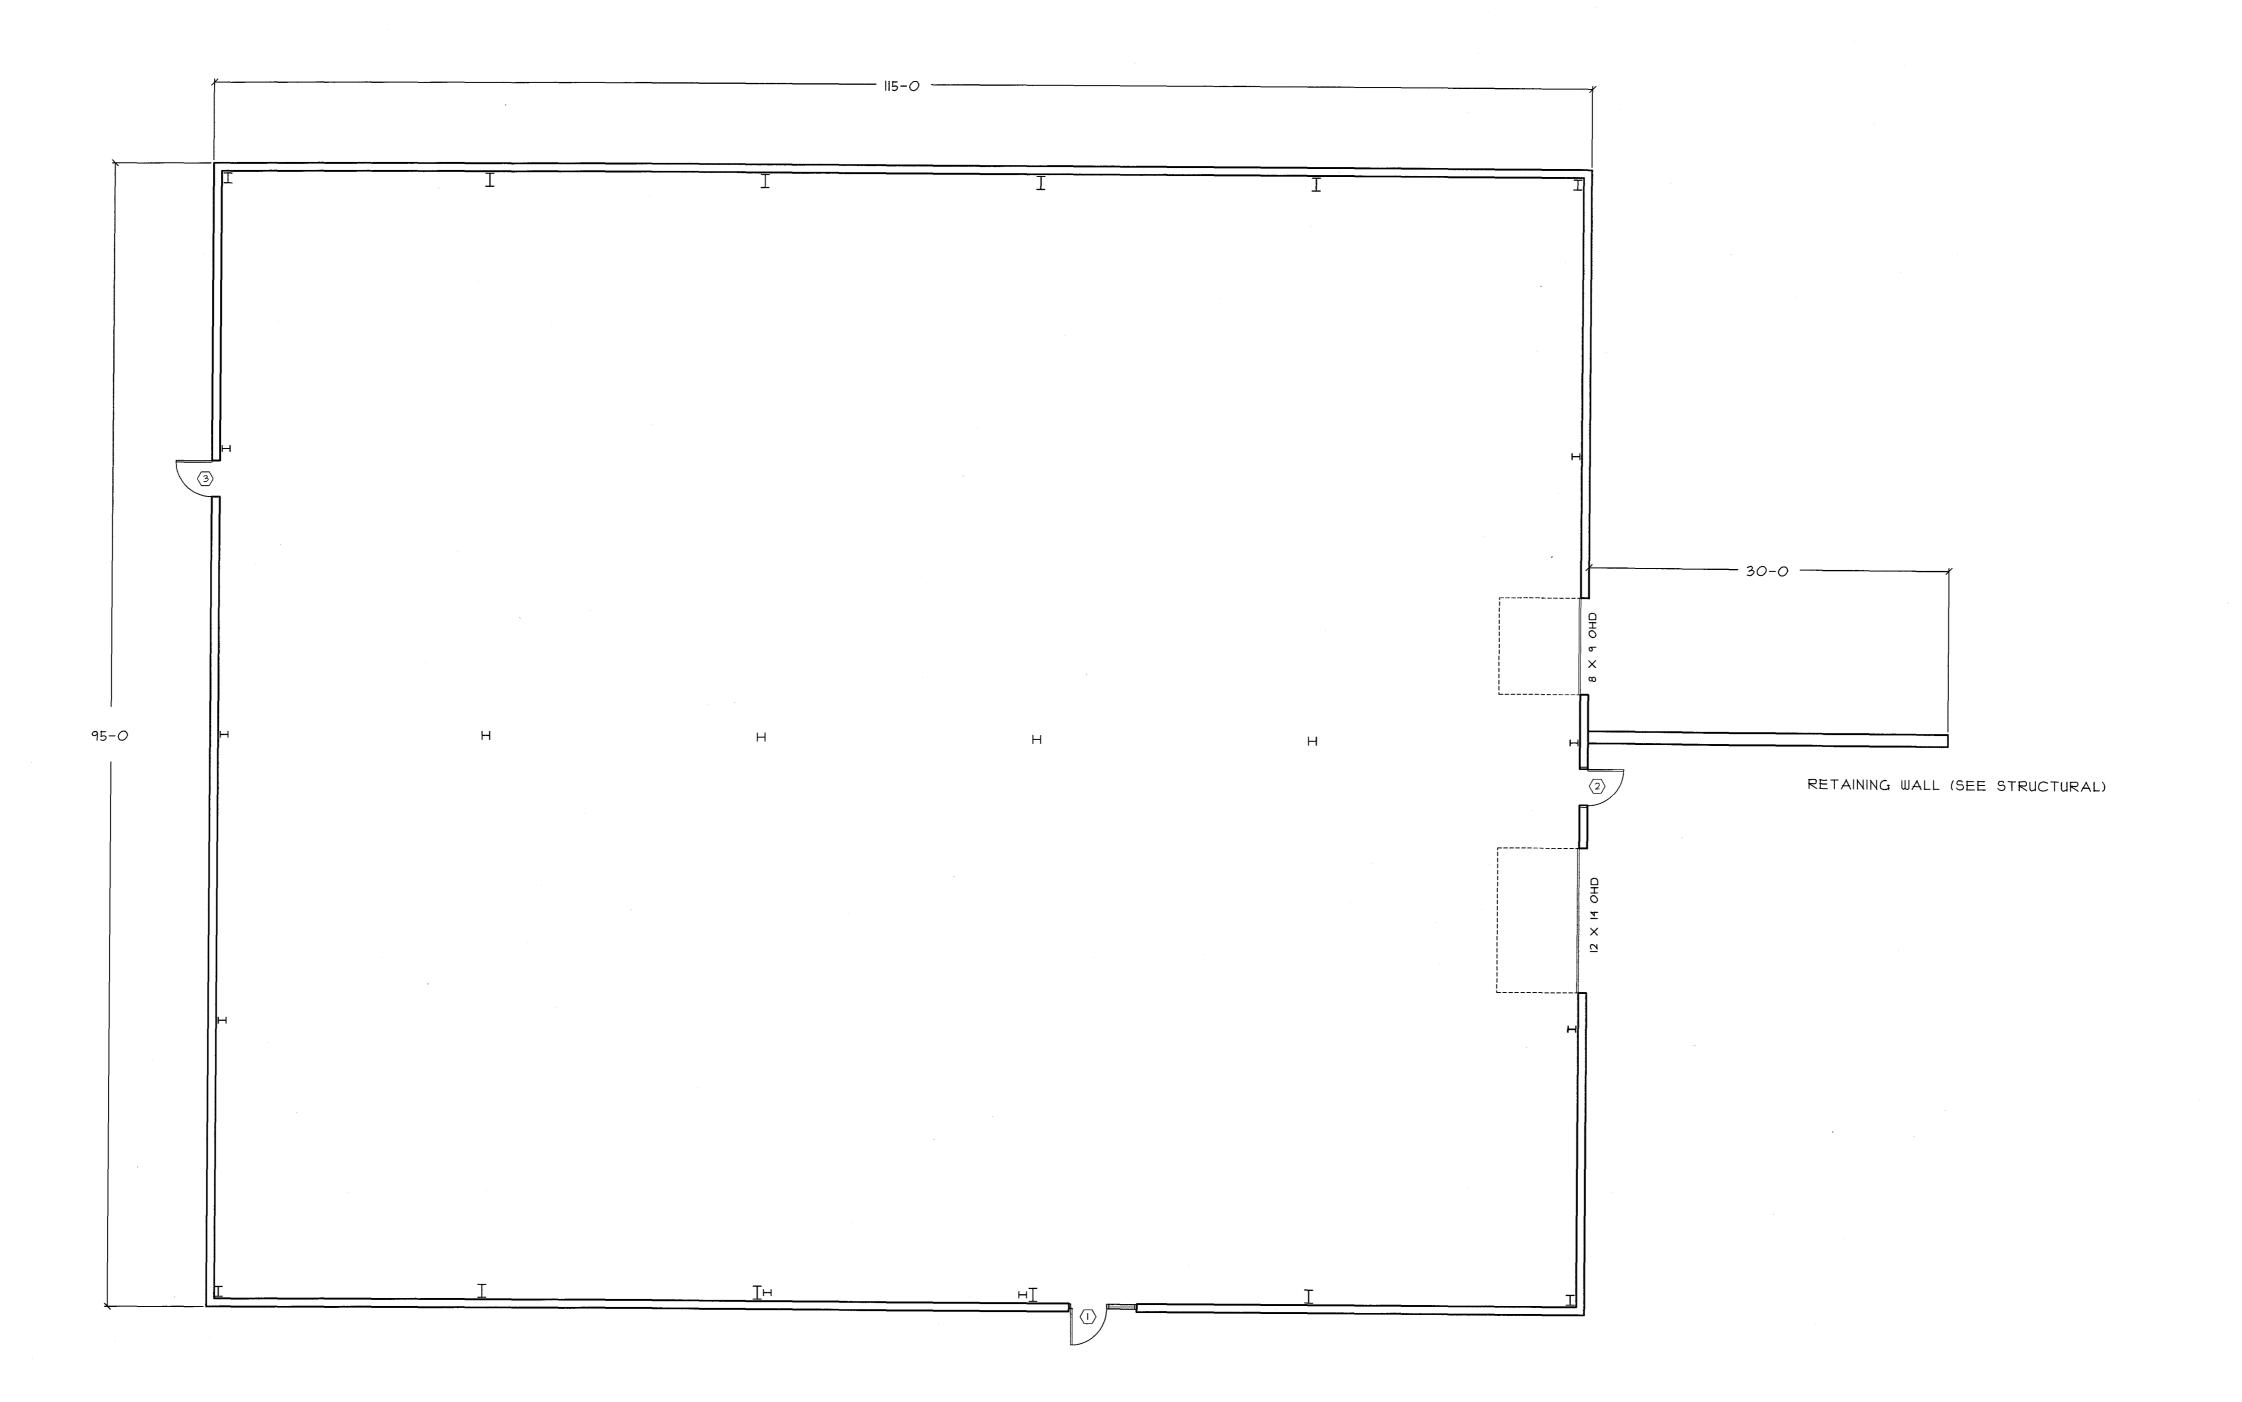


BISKUP CONSTRUCTION, INC. 6 DANIELLE DRIVE WINDHAM, MAINE 04062 TEL. (201) 892-9800

WWW.BISKUPCONSTRUCTION.COM

FAX. (207) 892-9895

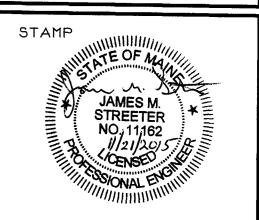

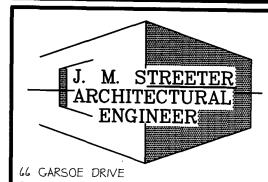

PORTLAND. MAINE 04103 (207) 797-3093

R	REVISIONS
DATE	DESCRIPTION
	10.74
	NO

DATE: II/I2/2I05 SCALE: 1/8" = 1'-0" DESIGNER: JB CHECKED BY: JB

BISKUP CONSTRUCTION, INC.

© COPYRIGHT

SHEET TITLE

FLOOR PLAN

SHEET NUMBER

SHEET I OF 4