



(A) STABILIZED CONSTRUCTION ENTRANCE
N.T.S.

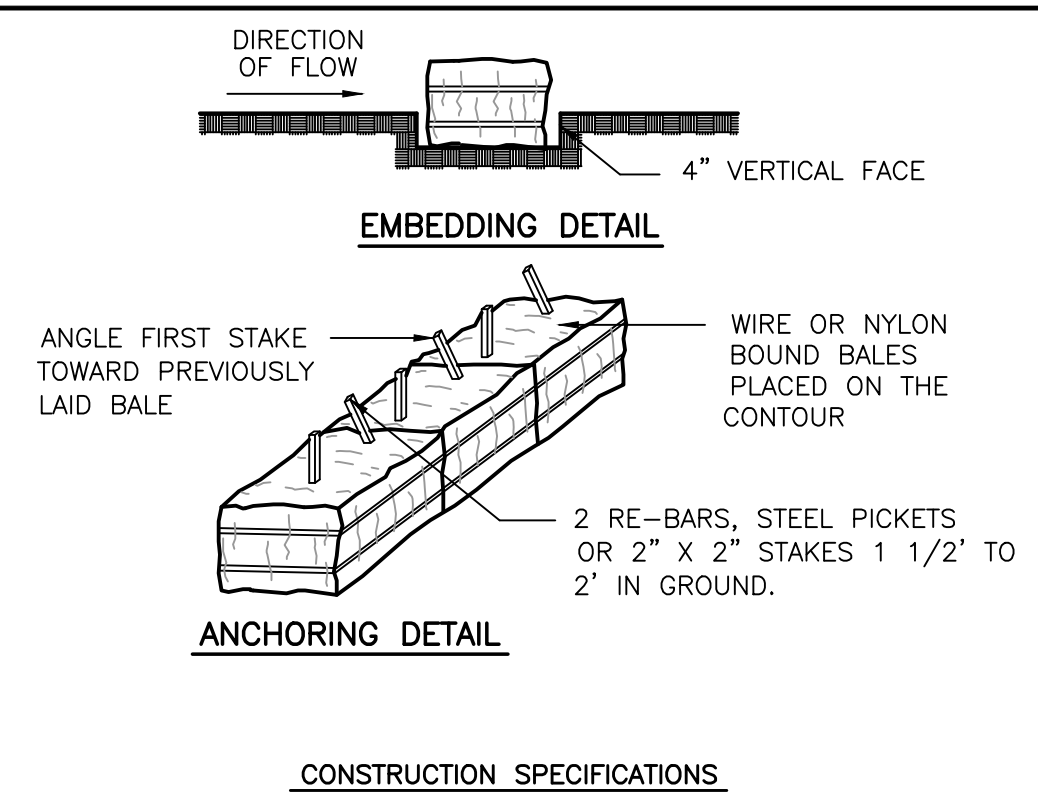


- CONSTRUCTION SPECIFICATIONS**
- Bales shall be placed in a row with ends tightly abutting the adjacent bales.
 - Each bale shall be embedded in the soil a minimum of 4".
 - Bales shall be securely anchored in place by stakes or re-bars driven through the bales. The first stake in each bale was angled toward previously laid bale to force bales together.
 - Inspection will be frequent and repair or replacement shall be made promptly as needed.
 - Bales shall be removed when they have served their usefulness so as not to block or impede storm flow or drainage.


(D) STRAW OR HAY BALE BARRIERS
N.T.S.

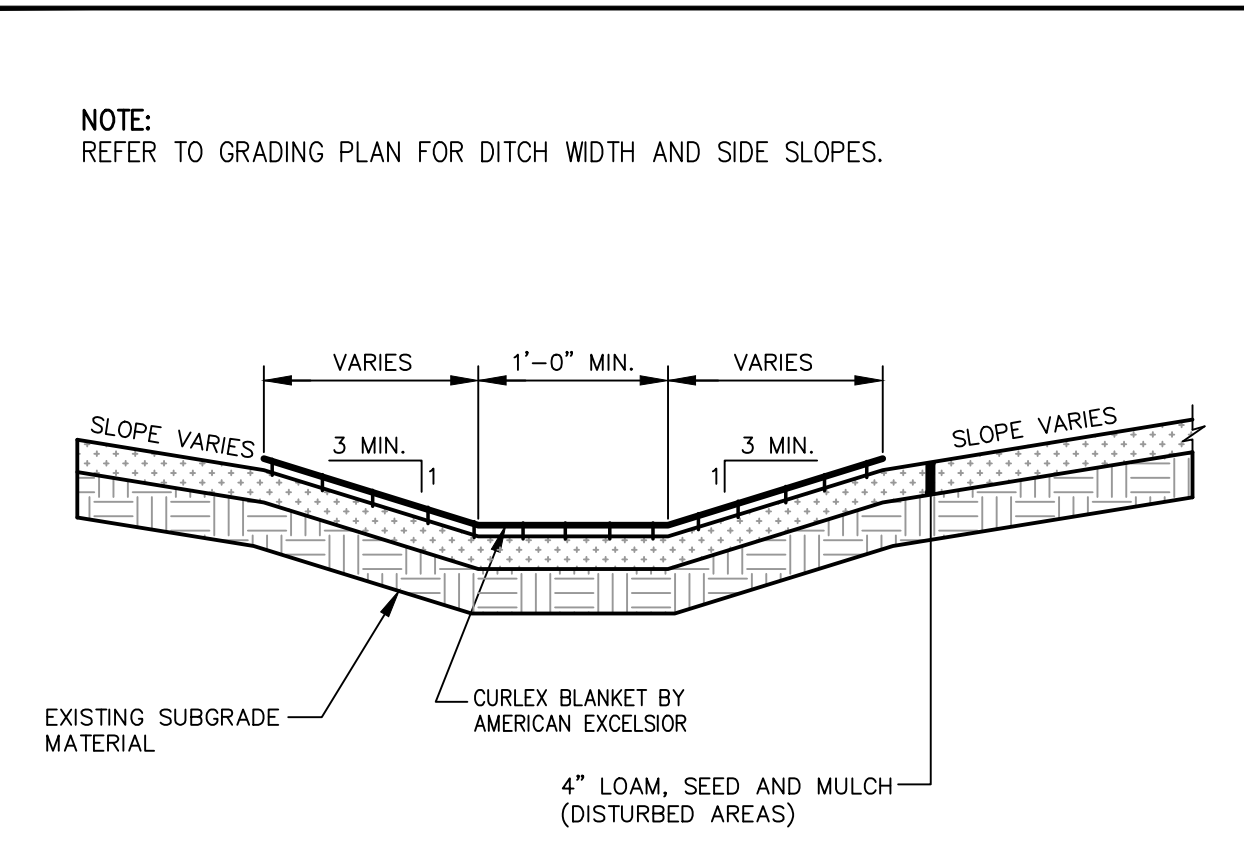


(G) VEGETATED DRAINAGE SWALE
N.T.S.

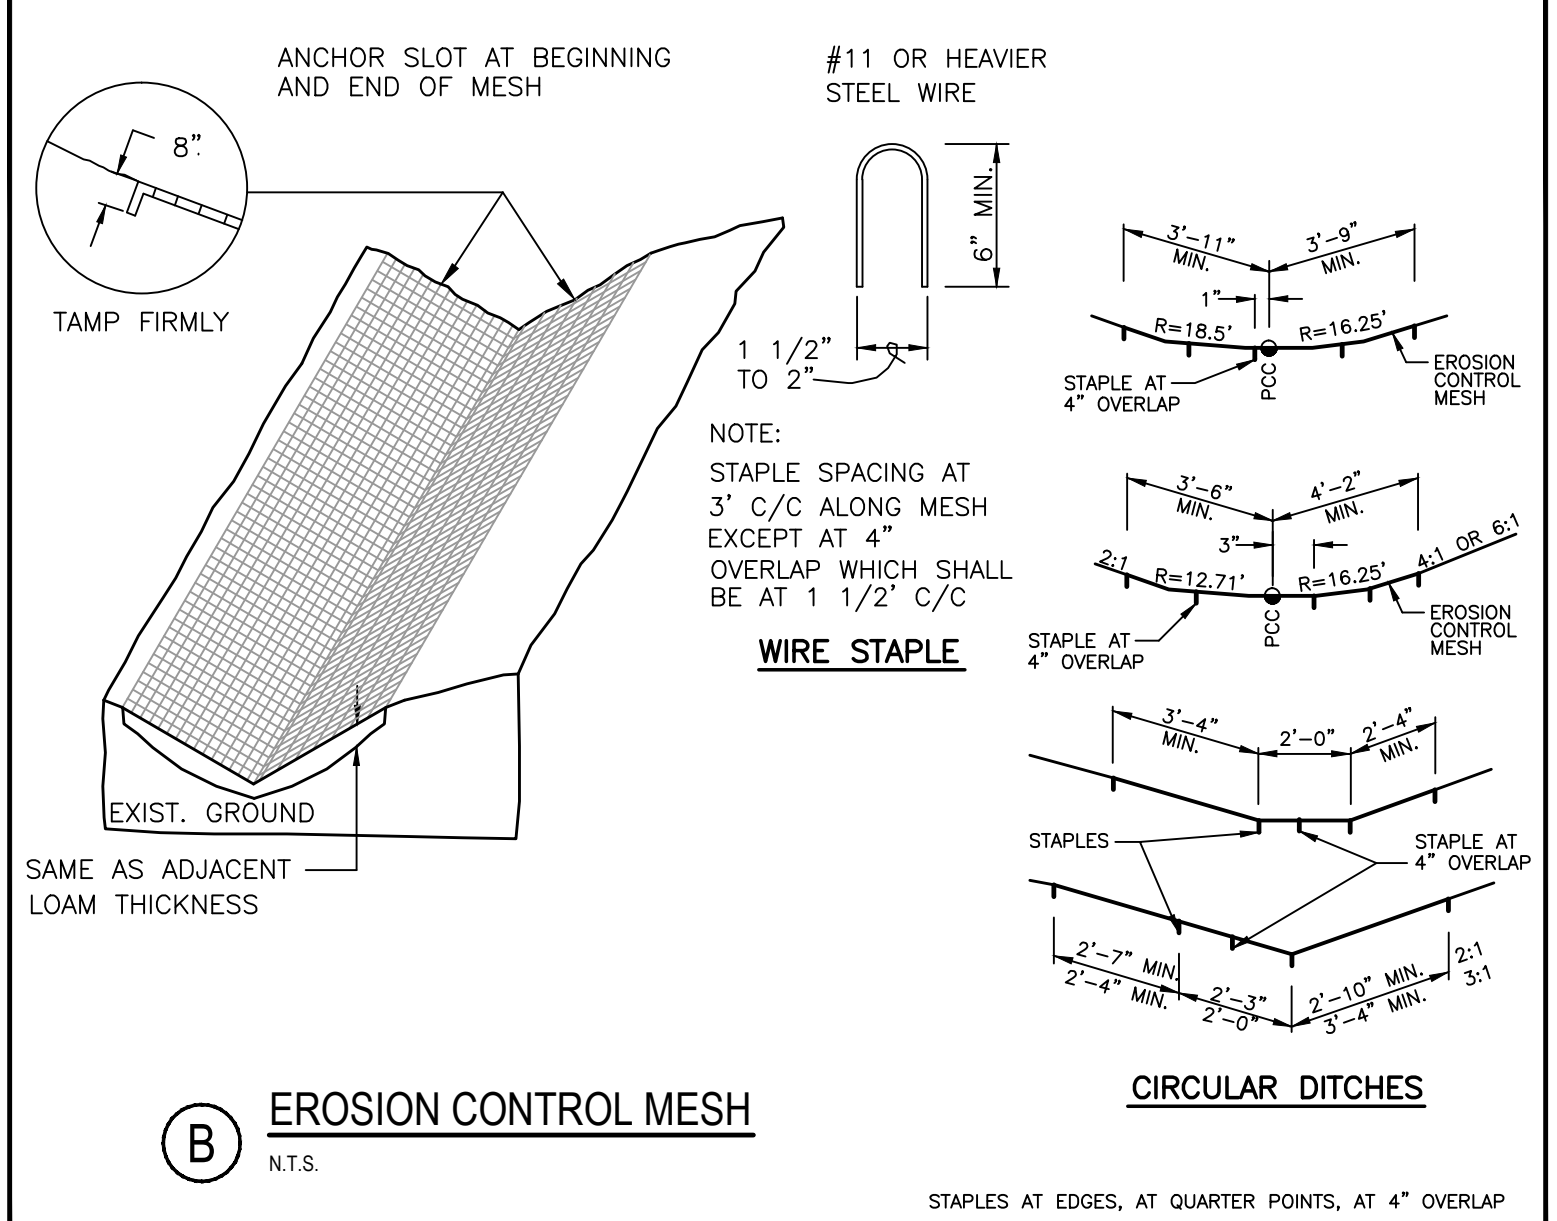


(B) EROSION CONTROL MESH
N.T.S.

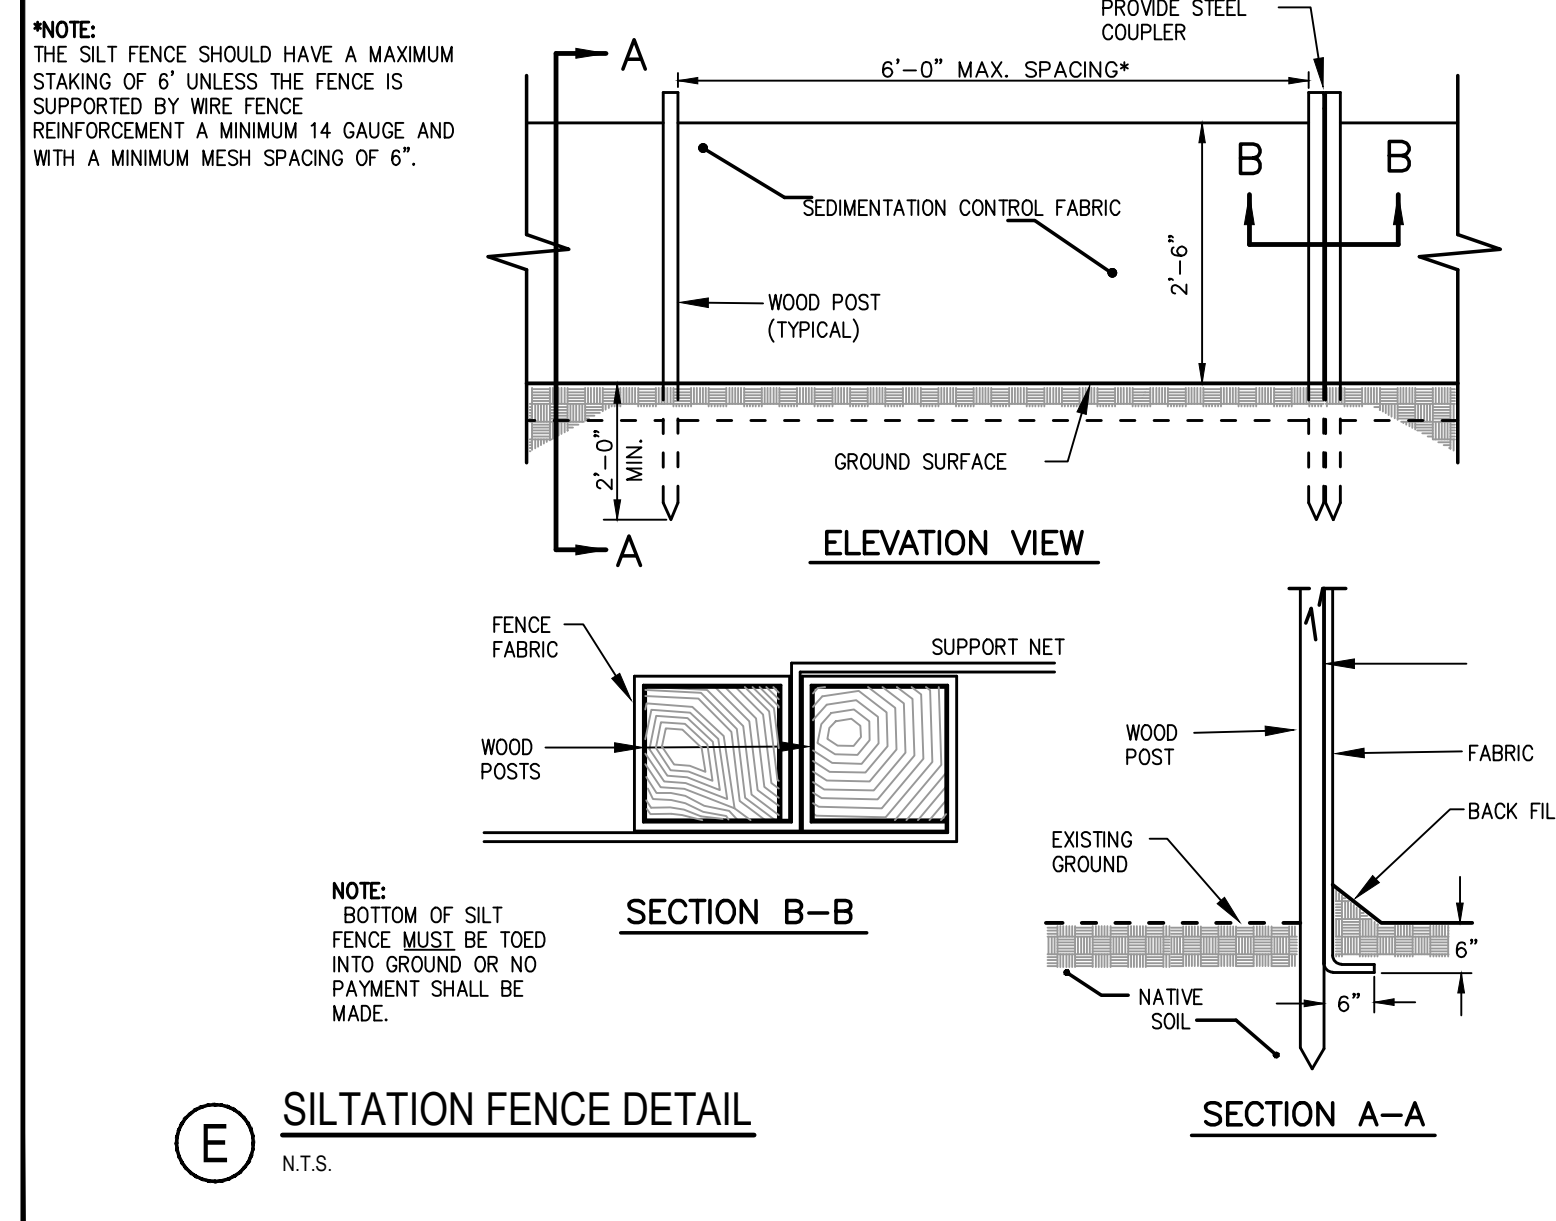

(E) SILTATION FENCE DETAIL
N.T.S.

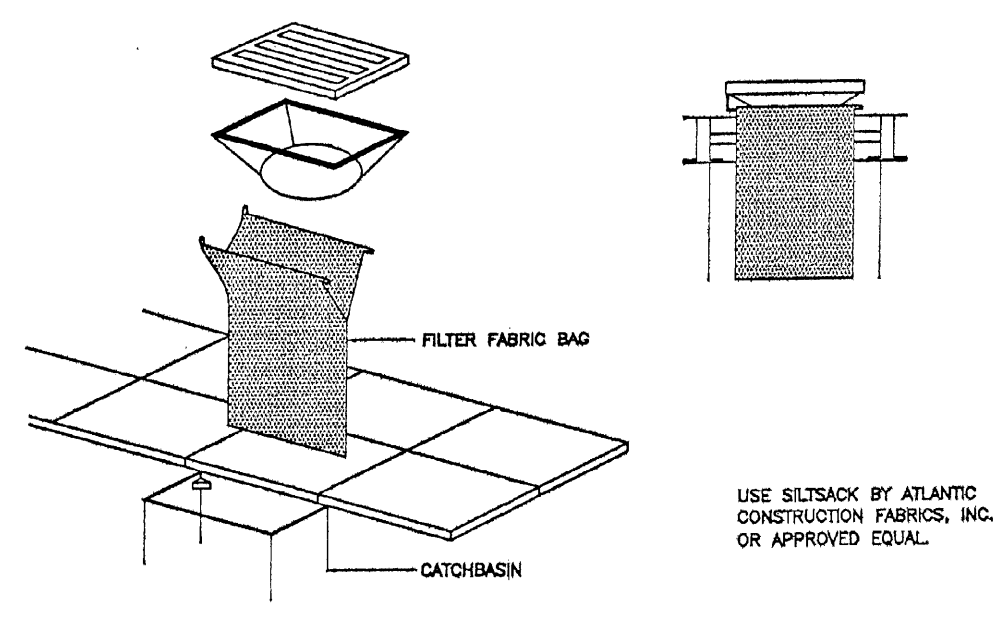

(C) TYPICAL FILTER BAG DETAIL
N.T.S.

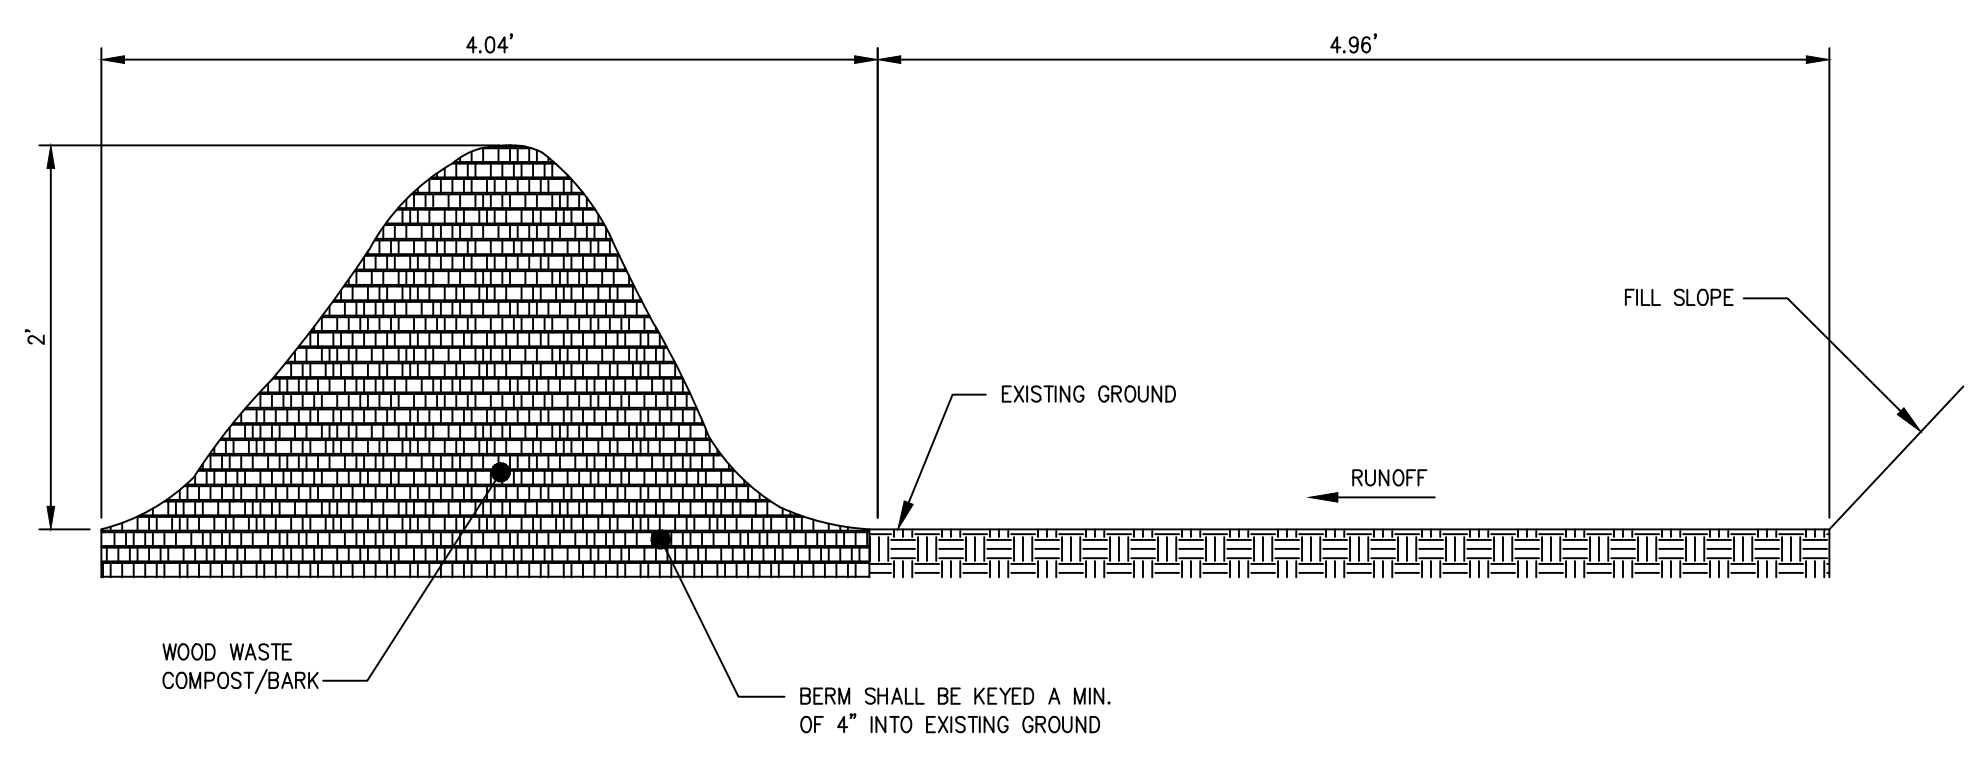


(F) WOOD WASTE COMPOST/BARK FILTER BERM DETAIL
N.T.S.

- NOTES:
- THE WOOD WASTE COMPOST/BARK MIX SHALL CONFORM TO THE FOLLOWING STANDARDS:
A. MOISTURE CONTENT - 30-60%
B. pH - 5.0-8.0
C. SCREEN SIZE - 100% LESS THAN 3", MAX. 70% LESS THAN 1"
D. NO LESS THAN 40% ORGANIC MATERIAL (DRY WEIGHT) BY LOSS OF IGNITION
F. NO STONES LARGER THAN 2" IN DIAMETER
 - THE COMPOST BERM SHALL BE PLACED, UNCOMPACTED, ALONG A RELATIVELY LEVEL CONTOUR.
 - THE WOOD WASTE COMPOST/BARK FILTER BERM MAY BE USED IN LIEU OF SILTATION FENCE, AT THE TOE OF SHALLOW SLOPES, ON FROZEN GROUND, LEDGE OUT CROPS, VERY ROOTED FORESTED AREA OR AT THE EDGE OF GRAVEL PARKING AREAS.
 - BERMS SHALL REMAIN IN PLACE UNTIL UPSTREAM AREA IS COMPLETED OR 70% CATCH OF VEGETATION IS ATTAINED. BERMS SHALL BE REMOVED BY SPREADING SUCH THAT THE NATIVE EARTH CAN BE SEEN BELOW.

REV	DATE	DESCRIPTION
3	05.04.16	SUBMITTED FOR FINAL APPROVAL
2	04.14.16	REVISED SUBMISSION TO CITY OF PORTLAND
1	02.25.16	AMENDED SITE PLAN SUBMISSION

REVISIONS

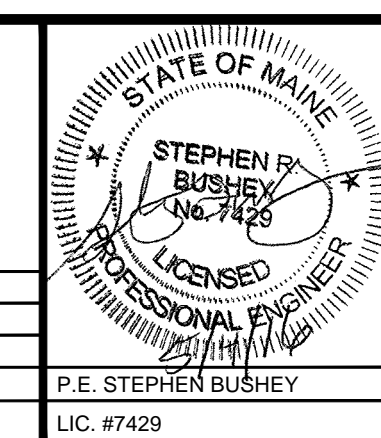

PROJECT SECOND TEE CONDOMINIUM ASSOCIATION BUSINESS PARK EXPANSION - UNIT 2	STANTEC CONSULTING SERVICES INC. 482 PAYNE ROAD SCARBOROUGH, ME 04074 WWW.STANTEC.COM
SHEET TITLE EROSION CONTROL DETAILS	DRAWN: DED DESIGNED: SRB CHECKED: SRB FILE NAME: SP-M168 DETAILS
CLIENT 1039 RIVERSIDE LLC	DATE: FEB 2016 SCALE: AS NOTED JOB NO. 195350348 SHEET C-9