

DOOR SCHEDULE					
NO.	QUANTITY	SIZE	TYPE	FRAME	REMARKS
1	2	EXISTING 3'-0" x 7'-0"	EXISTING FULL GLASS STOREFRONT	METAL	HINGES, PUSH BAR, D-RING PULL HANDLE, CLOSER, ENTRY LOCKSET
2	4	EXISTING 3'-0" x 6'-8"	EXISTING SOLID WOOD	METAL	HINGES, LEVER HARDWARE, ENTRY LOCKSET
3	2	EXISTING 3'-0" x 6'-8"	EXISTING SOLID WOOD	METAL	HINGES, PUSH PLATE, PULL HANDLE, CLOSER
4	1	EXISTING 3'-0" x 6'-8"	EXISTING HOLLOW METAL	METAL	HINGES, LEVER HARDWARE, PRIVACY LOCKSET
5	3	EXISTING 3'-0" x 7'-0"	EXISTING METAL INSULATED	METAL	HINGES, EXTERIOR LEVER HARDWARE, INTERIOR PANIC HARDWARE, ENTRY LOCKSET, CLOSER
6	3	EXISTING VARIES	EXISTING STALL	METAL	HINGES, LEVER HARDWARE, PRIVACY LOCKSET
7	1	EXISTING 3'-0" x 6'-8"	EXISTING HOLLOW METAL	METAL	HINGES, LEVER HARDWARE, ENTRY LOCKSET, CLOSER, INTERIOR PANIC HARDWARE
8	1	EXISTING 3'-0" x 6'-8"	EXISTING HALF GLASS SOLID WOOD	METAL	HINGES, LEVER HARDWARE
9	2	3'-0" x 6'-8"	HOLLOW METAL	METAL	HINGES, LEVER HARDWARE, ENTRY LOCKSET
10	1	3'-0" x 6'-8"	EXISTING HOLLOW METAL	METAL	HINGES, LEVER HARDWARE, CHANGE TO PRIVACY LOCKSET
11	2	3'-0" x 6'-8"	HOLLOW METAL	METAL	HINGES, LEVER HARDWARE

WINDOW SCHEDULE				
NO.	QUANTITY	UNIT DIMENSION	TYPE	FRAME
1	1	5'-0" x 5'-0"	STOREFRONT	METAL

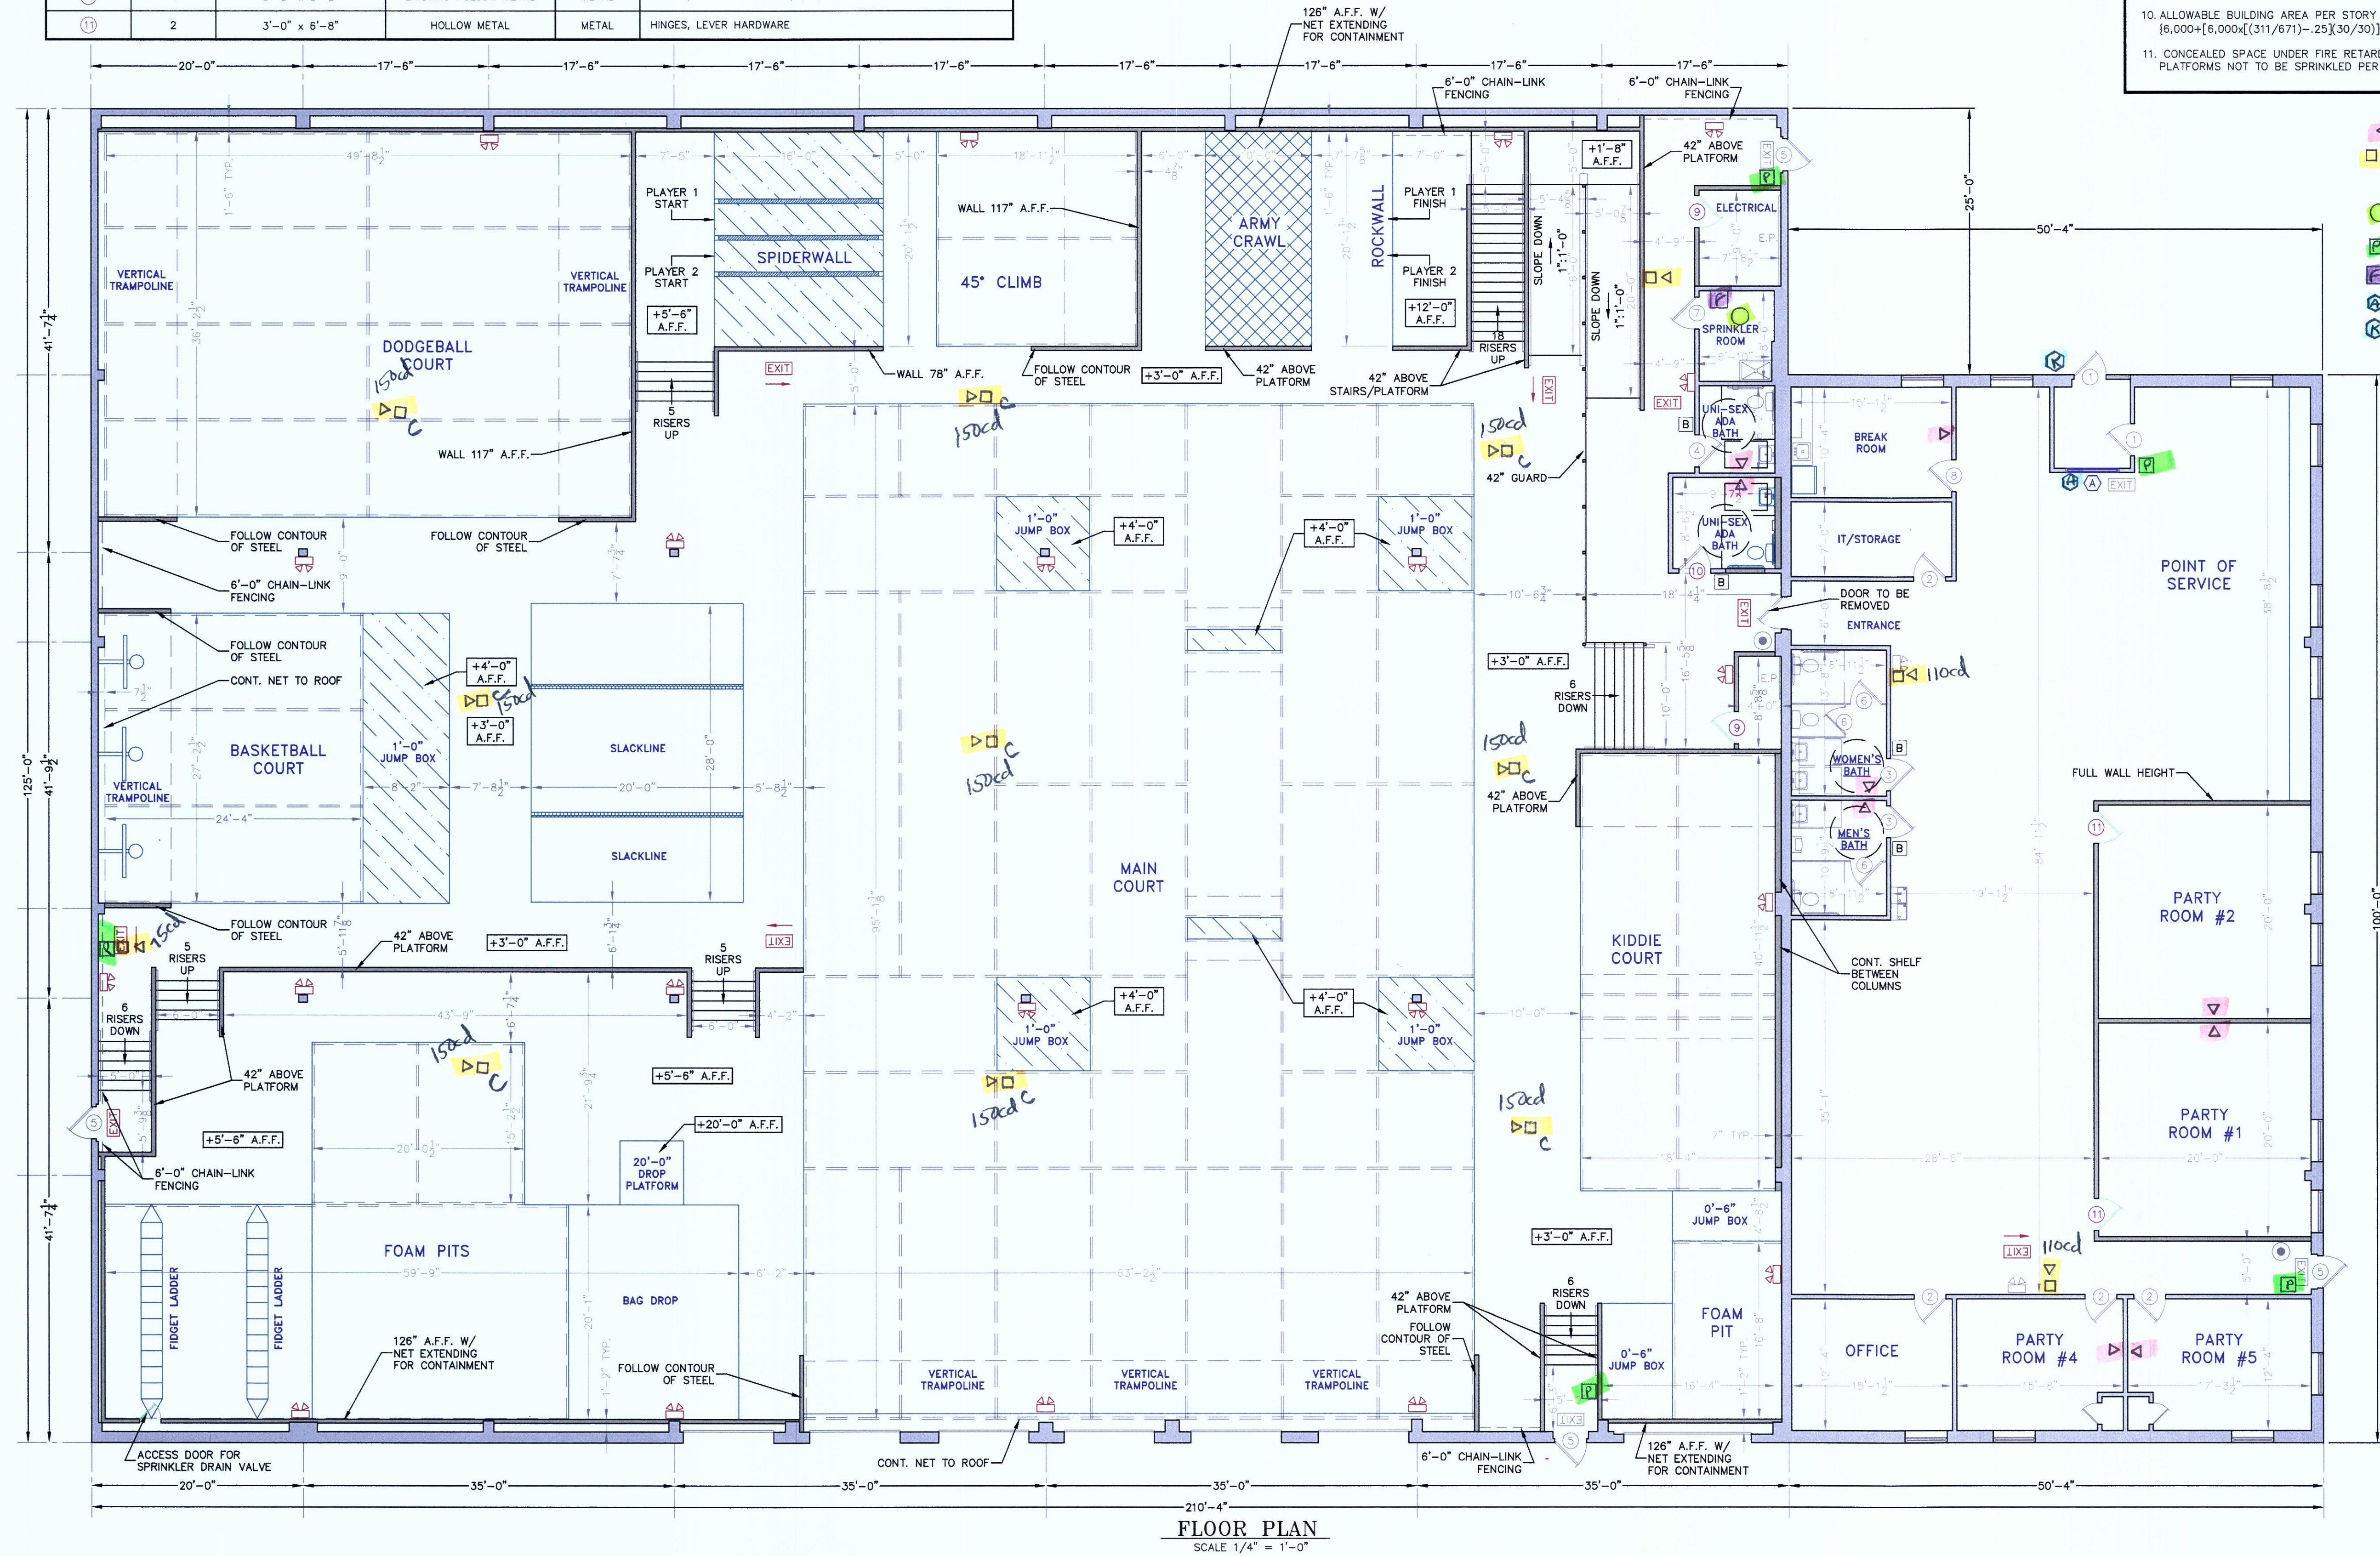
LEGEND

- EXISTING WALL
- PROPOSED WALL
- EXIT SIGN
- EMERGENCY LIGHTING
- FIRE EXTINGUISHER
- BRAILLE SIGNAGE

- PLAN SUBMISSION NOTES & CODE SUMMARY**
- THIS PLAN IS FOR CITY OF PORTLAND BUILDING CODE, LIFE SAFETY CODE, ADA, FIRE MARSHAL AND OCCUPANCY APPROVAL ONLY.
 - PLAN BASED ON PLAN PROVIDED BY THE LESSOR.
 - THE PLUMBING, ELECTRICAL, AND MECHANICAL DESIGN OF THE BUILDING IS BY THE OWNER.
 - IBC USE GROUP: ASSEMBLY (A-3)
 - NFPA LIFE SAFETY OCCUPANCY: ASSEMBLY
 - CONSTRUCTION TYPE: TYPE V B (UNPROTECTED) PRE-ENGINEERED METAL BUILDING EXTERIOR WITH INTERIOR FIRE RETARDANT WOOD SHEATHING FOR PLATFORMS WITH METAL STUD FRAMING
 - BUILDING FULLY EQUIPPED WITH NFPA 13 SPRINKLED SYSTEM
 - ALLOWABLE BUILDING HEIGHT = (2) STORIES (SPRINKLED)
 - TABULAR BUILDING AREA PER STORY = 6,000 SF
 - ALLOWABLE BUILDING AREA PER STORY = $6,000 + [6,000 \times ((311/671) - 25 \times (30/30))] = 6,000(3) = 25,281$ SF
 - CONCEALED SPACE UNDER FIRE RETARDANT WOOD FRAMED PLATFORMS NOT TO BE SPRINKLED PER NFPA 13 SECTION 8.15.1.2.11

STATE OF MAINE
BENJAMIN E. MURRAY
NO. 10128
LICENSED PROFESSIONAL ENGINEER

E.S. COFFIN
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SURVEYING
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FLOOR PLAN	DRAWN BY: JPK CHECKED BY: BEM
SUBJECT TITLE	SCALE: 1/8" = 1'-0"
CLIENT & PROJECT	DATE: JUNE 25, 2014
GET AIR PORTLAND FITUP PLAN	LOCATION: 921 RIVERSIDE STREET TOWN: PORTLAND COUNTY: CUMBERLAND STATE: MAINE
PROJ. NO. 2014-112	REVISIONS
A-1	NO.