

PORTLAND HOUSING AUTHORITY

Portland, Maine ISSUED FOR REVIEW

RIVERTON PARK BOILER REPLACEMENTS: BUILDING NOs 21,22,23

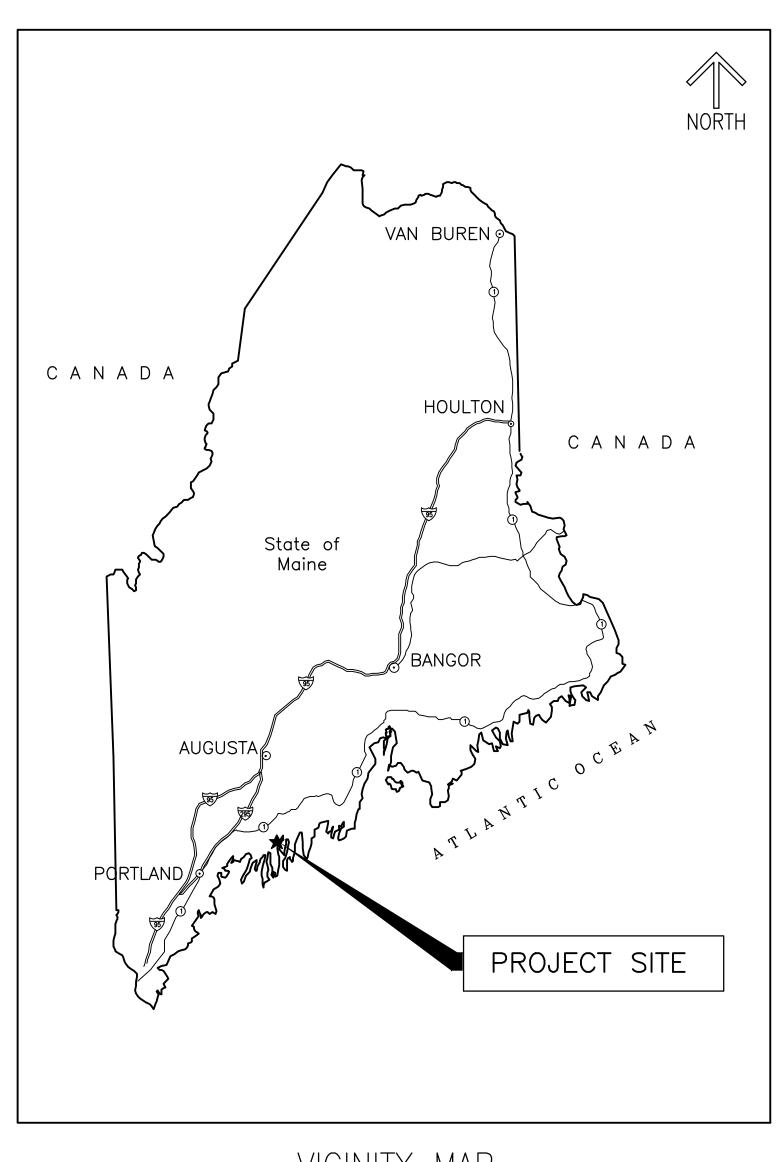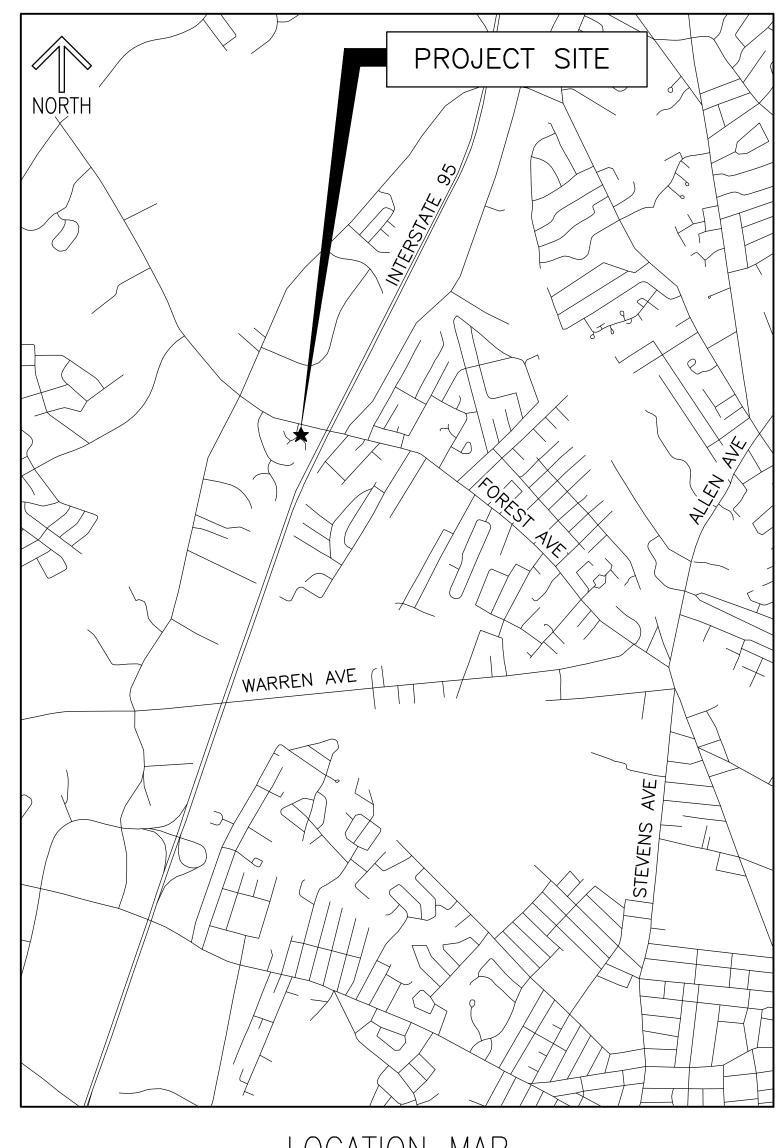

	DRAWING INDEX	
DRAWING	TITLE	SHEET NUMBER
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LOCATION MAP

					PORTLAND HOUSING AUTHORITY PORTLAND, MAINE					
					RIVERTON BOILER REPLACEMENTS BUILDING NOs 21,22,23					
) =V	ISSUED FOR CONSTRUCTION DESCRIPTION	CSS	ERP APP	9-8-15 DATE	COVER SHEET					
<u> </u>	DESCRIPTION	DWN SIZE:		SI D	PROJECT NO. DRAWING NO.					

218.011.001


1 OF 16

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47A York Street Portland, Maine 04101 207.553.7753 DES BY: ERP colbycoengineering.com engineering

G-001

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 $\frac{2}{44}$

EXISTING

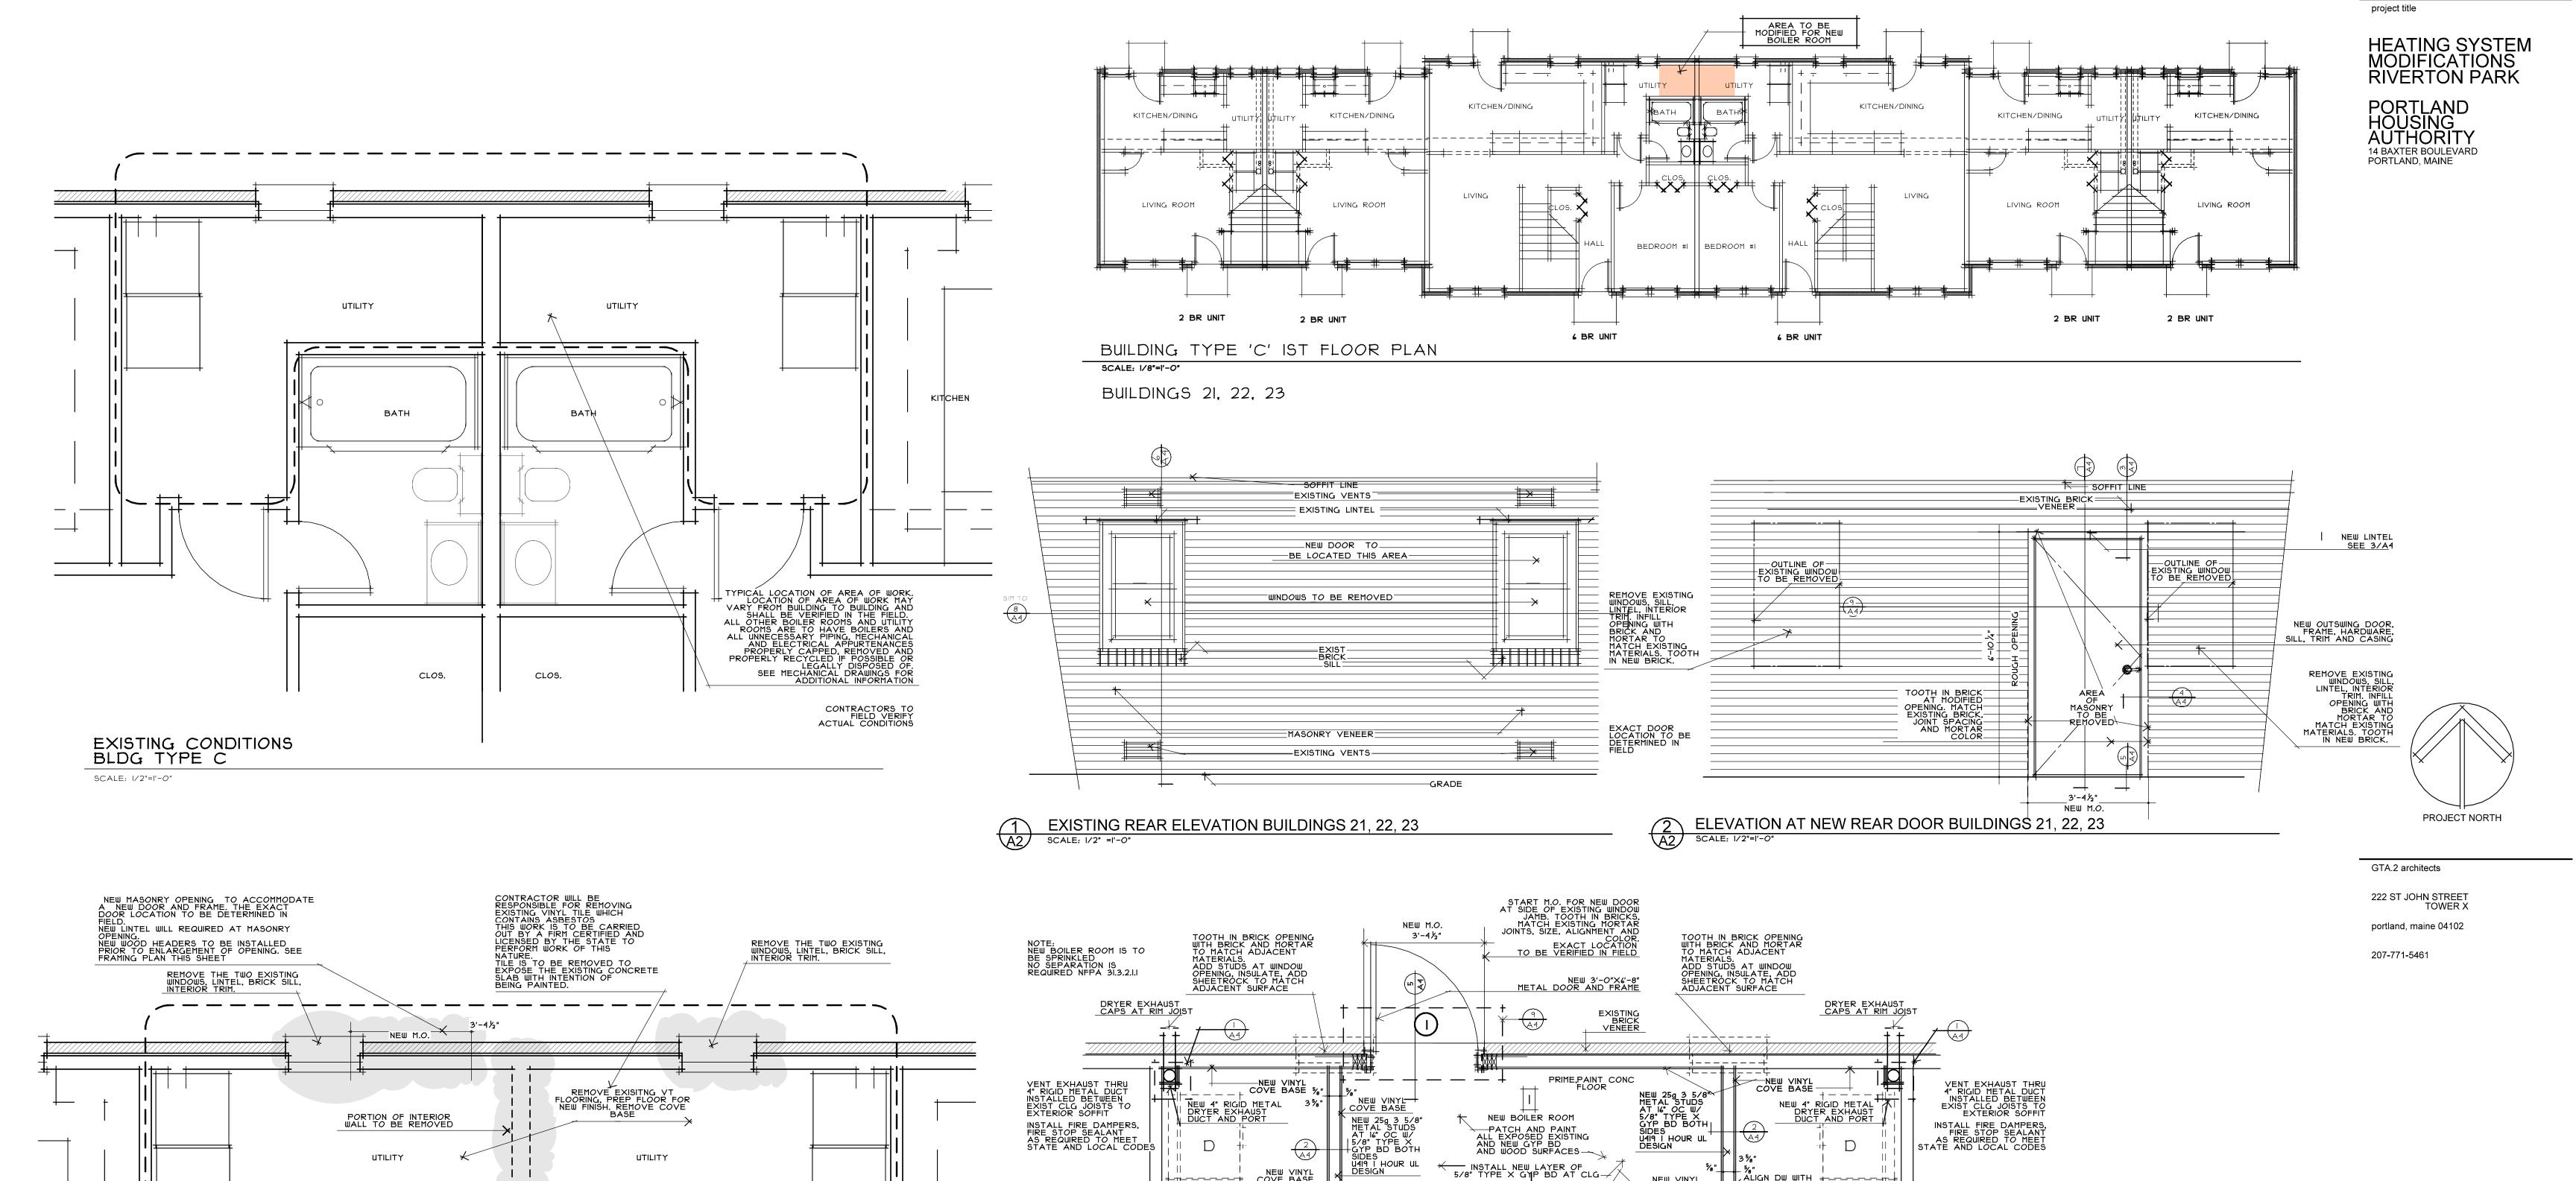NOT RATED

2X4 WOOD STUDS

EXISTING BATH

NEW VINYL COVE BASE

UNIT LAUNDRY

PATCH AND PAINT
ALL EXPOSED EXISTING
AND NEW GYP BD
AND WOOD SURFACES

/ INSTALL NEW LAYER OF 5/8" TYPE X GYP BD AT CLG

ÁLIGN DW WITH

UNIT LAUNDRY ROOM

PATCH AND PAINT ALL EXPOSED EXISTING AND NEW GYP BD AND WOOD SURFACES

NEW TILE LIMIT

NEW VINYL COVE BASE

PROVIDE AND INSTALL
NEW WASHER/DRIER
DRAIN. SUPPLY. VENTS
AND POWER AT LAUNDRY
ROOMS

NEW LIGHT AND SW

NEW VINYL COVE BASE

EXISTING BATH

EXISTING

WALL
5/8" GYP BD
B/S
2×4 STUDS
I HOUR UL DESIGN
U305

ISSUED revisions SEPTEMBER, 2015

> sheet title BUILDING PLAN DEMOLITION PLANS

ELEVATION FLOOR PLAN

scale AS NOTED drawn by SMT project number

sheet number A-2

1615

PLAN MODIFICATIONS BLDG TYPE C SCALE: 1/2"=1'-0"

PROVIDE AND INSTALL
NEW WASHER/DRIER
DRAIN, SUPPLY, VENTS
AND POWER AT LAUNDRY
ROOMS

NEW LIGHT AND SW

UTILITY

BATH

SEE MECHANICAL PLANS FOR EXTENT OF DEMOLITION OF MECHANICALAND ELECTRICAL ITEMS

LIMIT OF TILE REMOVAL

REMOVE DOOR AND HINGES

DEMOLITION PLAN

BLDG TYPE C

SCALE: 1/2"=1'-0"

UTILITY

BATH


CLOS.

PORTIONS OF EXISTING CEILING ARE TO BE REMOVED TO INSTALL VENT EXHAUST DUCTS AND POSSIBLE OTHER MECHANICAL INSTALLATIONS. COORDINATE WITH MECHANICAL/ELECTRICAL CONTRACTORS TO DETERMINE EXTENT REQUIRED


REMOVE DOOR AND HINGES

CONTRACTORS TO FIELD VERIFY ACTUAL CONDITIONS

LIMIT OF TILE REMOVAL

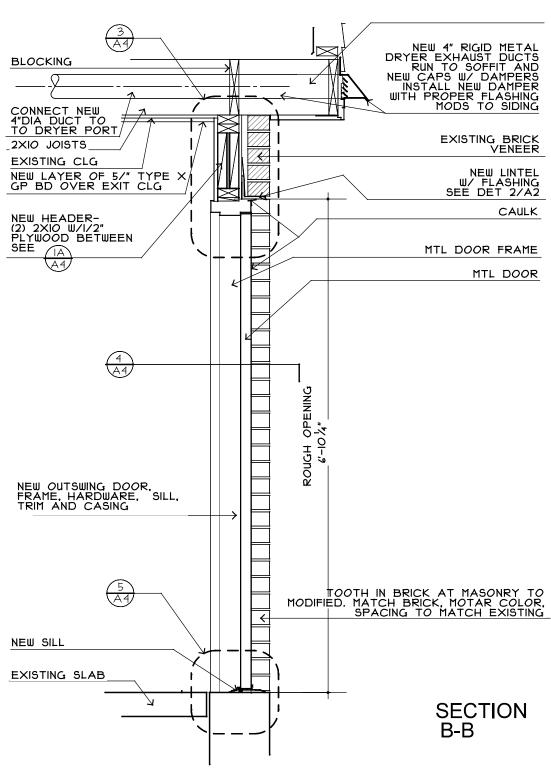





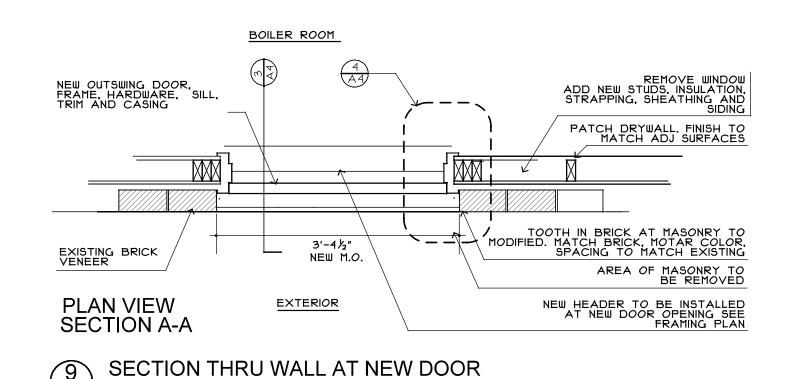




A4 SCALE: 3/4"=1'-0"

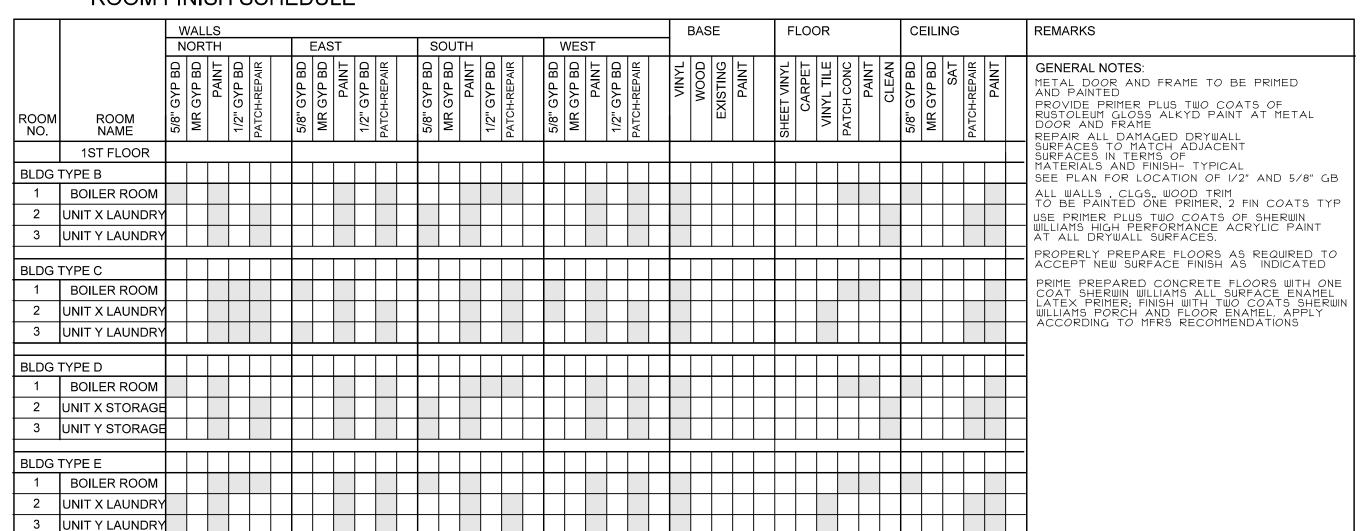


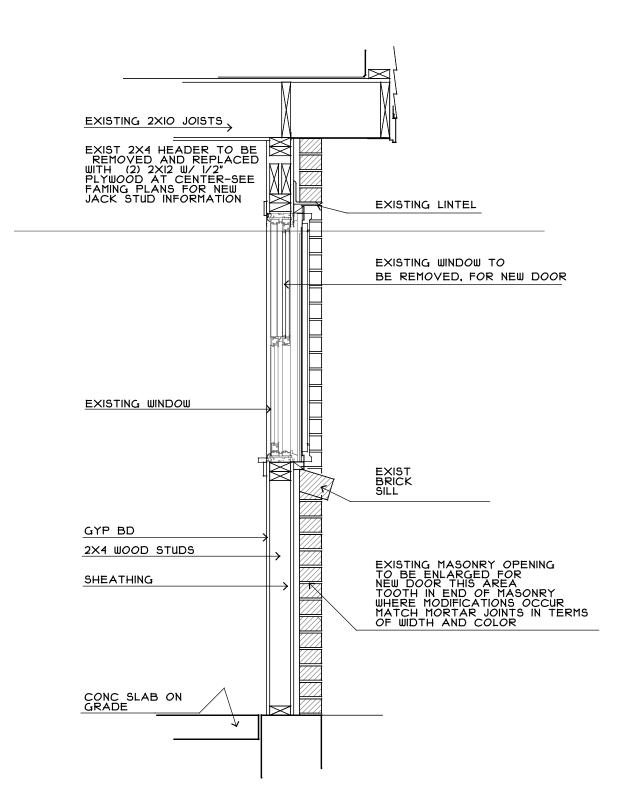


SECTION THRU EXISTING WINDOW

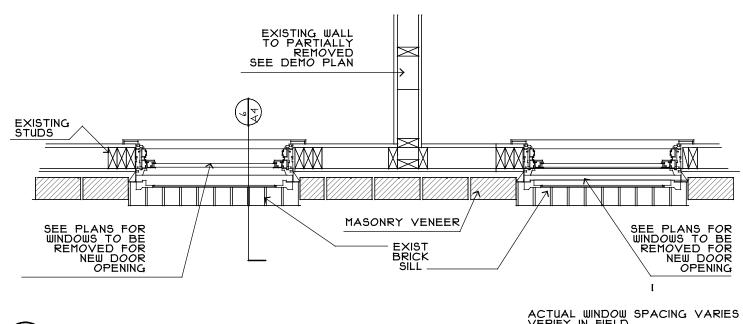



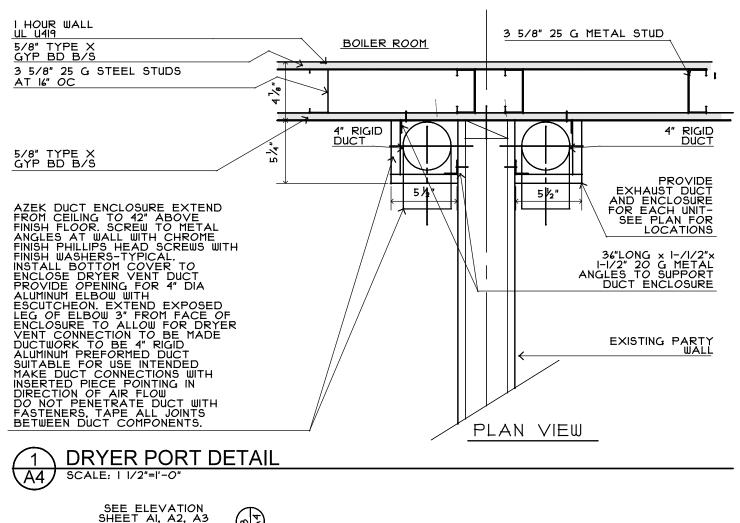


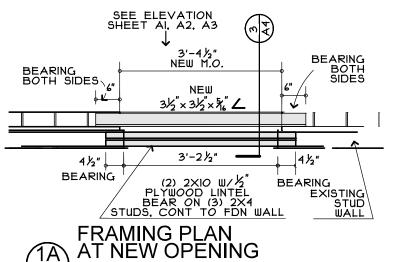



EXISTING SLAB

SCALE: 1/2"=1'-0"

			1	
I HOUR WALL UL DESIGN U419		5/8" 4 1/8"	√ 5⁄8" 1 1	5/8" TYPE X GYP BD
NEW	VINYL BASE	3 ½ "\ 		4" (FOUR INCH ACTUAL) 20 GA STEEL STUDS AT 16" OC 20 G TRACK, TOP AND BOTTOM
NE	W VINYL TILE UNIT		1 /	SEAL, PRIME, PAINT SLAB BOILER ROOM
		71		

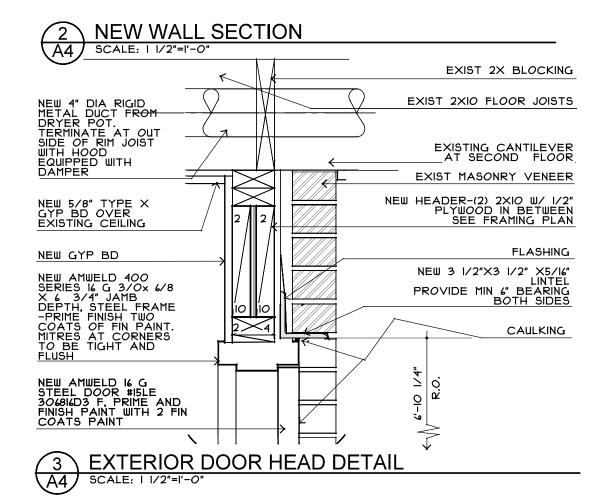

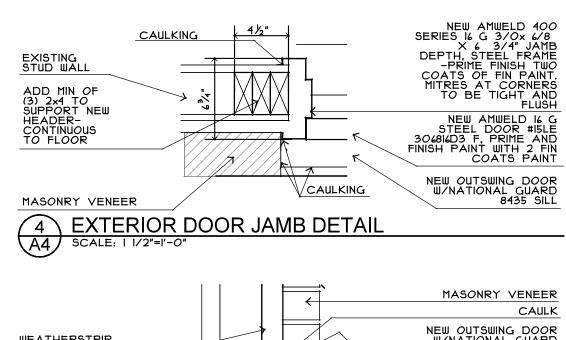

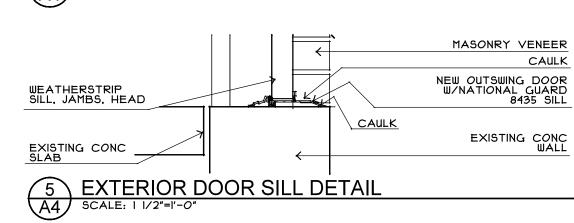


DC	DOOR SCHEDULE														
MARK	LOCATION	TYPE	SIZE	THICKNESS	MATERIAL	MANUFACTURER	FRAME	SILL	TRIM	HARDWARE	FINISH	MFR	MODEL NO.	NOTES	i
1	FIRST FLOOR BOILER ROOM		3'-O"× 6'-8"	I 3/4"	STEEL	AMWELD 16 GA. 15LE 306816 D3 F B-LABEL	STEEL-AMWELD 400 SERIES I6 GA 30/48 W/6 3/4"JAMB DEPTH 20 MIN	NATIONAL GUARDTHERMAL BARRIER THRESHOLD W/VINYL BUMPERSEAL MODEL 8435	INTERIOR WOOD EXTERIOR PAINTED METAL FRAME	CLASSROOM LOCKSET 1.5 PR 4.5x4.5 HINGES	626 US26D	SCHLAGE STANLEY	D-SERIES RHODES (626) FBBIT9	OUTSWING DOOR DOOR SWEEP AND WEATHERSTRIP, PAINT DOOR, COORDINATE W/OWNER REGARDING KEYING COMPARABILITY REQUIREMENTS IVES DOOR STOP F6436 26D FIN OUTSWING THRESHOLD DUR-O-MATIC SC80 ALUM FIN CLOSER, IVES DOOR STOP F6436 26D FIN FIRE RATED HARDWARE B-LABEL	




REMOVE WORK AS SHOWN ON PLANS PROVIDE ADEQUATE BRACING WHEN WORK INVOLVES STRUCTURAL MODIFICATIONS REMOVE WALLS, FRAMING, ETC. TO COMPLETE FINAL LAYOUT AS NOTED ON DRAWINGS.
REMOVE EXCESS MATERIALS FROM SITE AND DISPOSE OF PROPERLY.
HAZARDOUS MATERIALS TO BE REMOVED BY CONTRACTORS LICENSED TO PERFORM THIS TYPE OF WORK. MATERIAL TO BE DISPOSED OF IN A LEGAL AND SAFE MANNER

WORK TO INCLUDE, BUT IS NOT LIMITED TO, THE FOLLOWING:
DEMOLITION, EXCAVATION, CONCRETE WORK, LANDSCAPING AND GRADING, CARPENTRY, SIDING, ROOFING, INSULATION, DRYWALL, PAINTING, FLOORING, CABINETRY, ELECTRICAL, PLUMBING INCLUDING DESIGN AND MODIFICATION OF THE EXISTING HEATING SYSTEM TO SERVICE THE RENOVATED SPACE

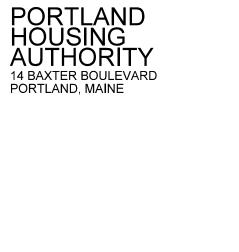

HEATING SYSTEM MODIFICATIONS RIVERTON PARK

project title

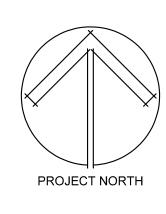

222 ST JOHN STREET TOWER X

207-771-5461

ISSUED

revisions

date SEPTEMBER, 2015

sheet title **SECTIONS DETAILS**


SCHEDULES

AS NOTED drawn by SMT project number 1615

scale

sheet number

A-4

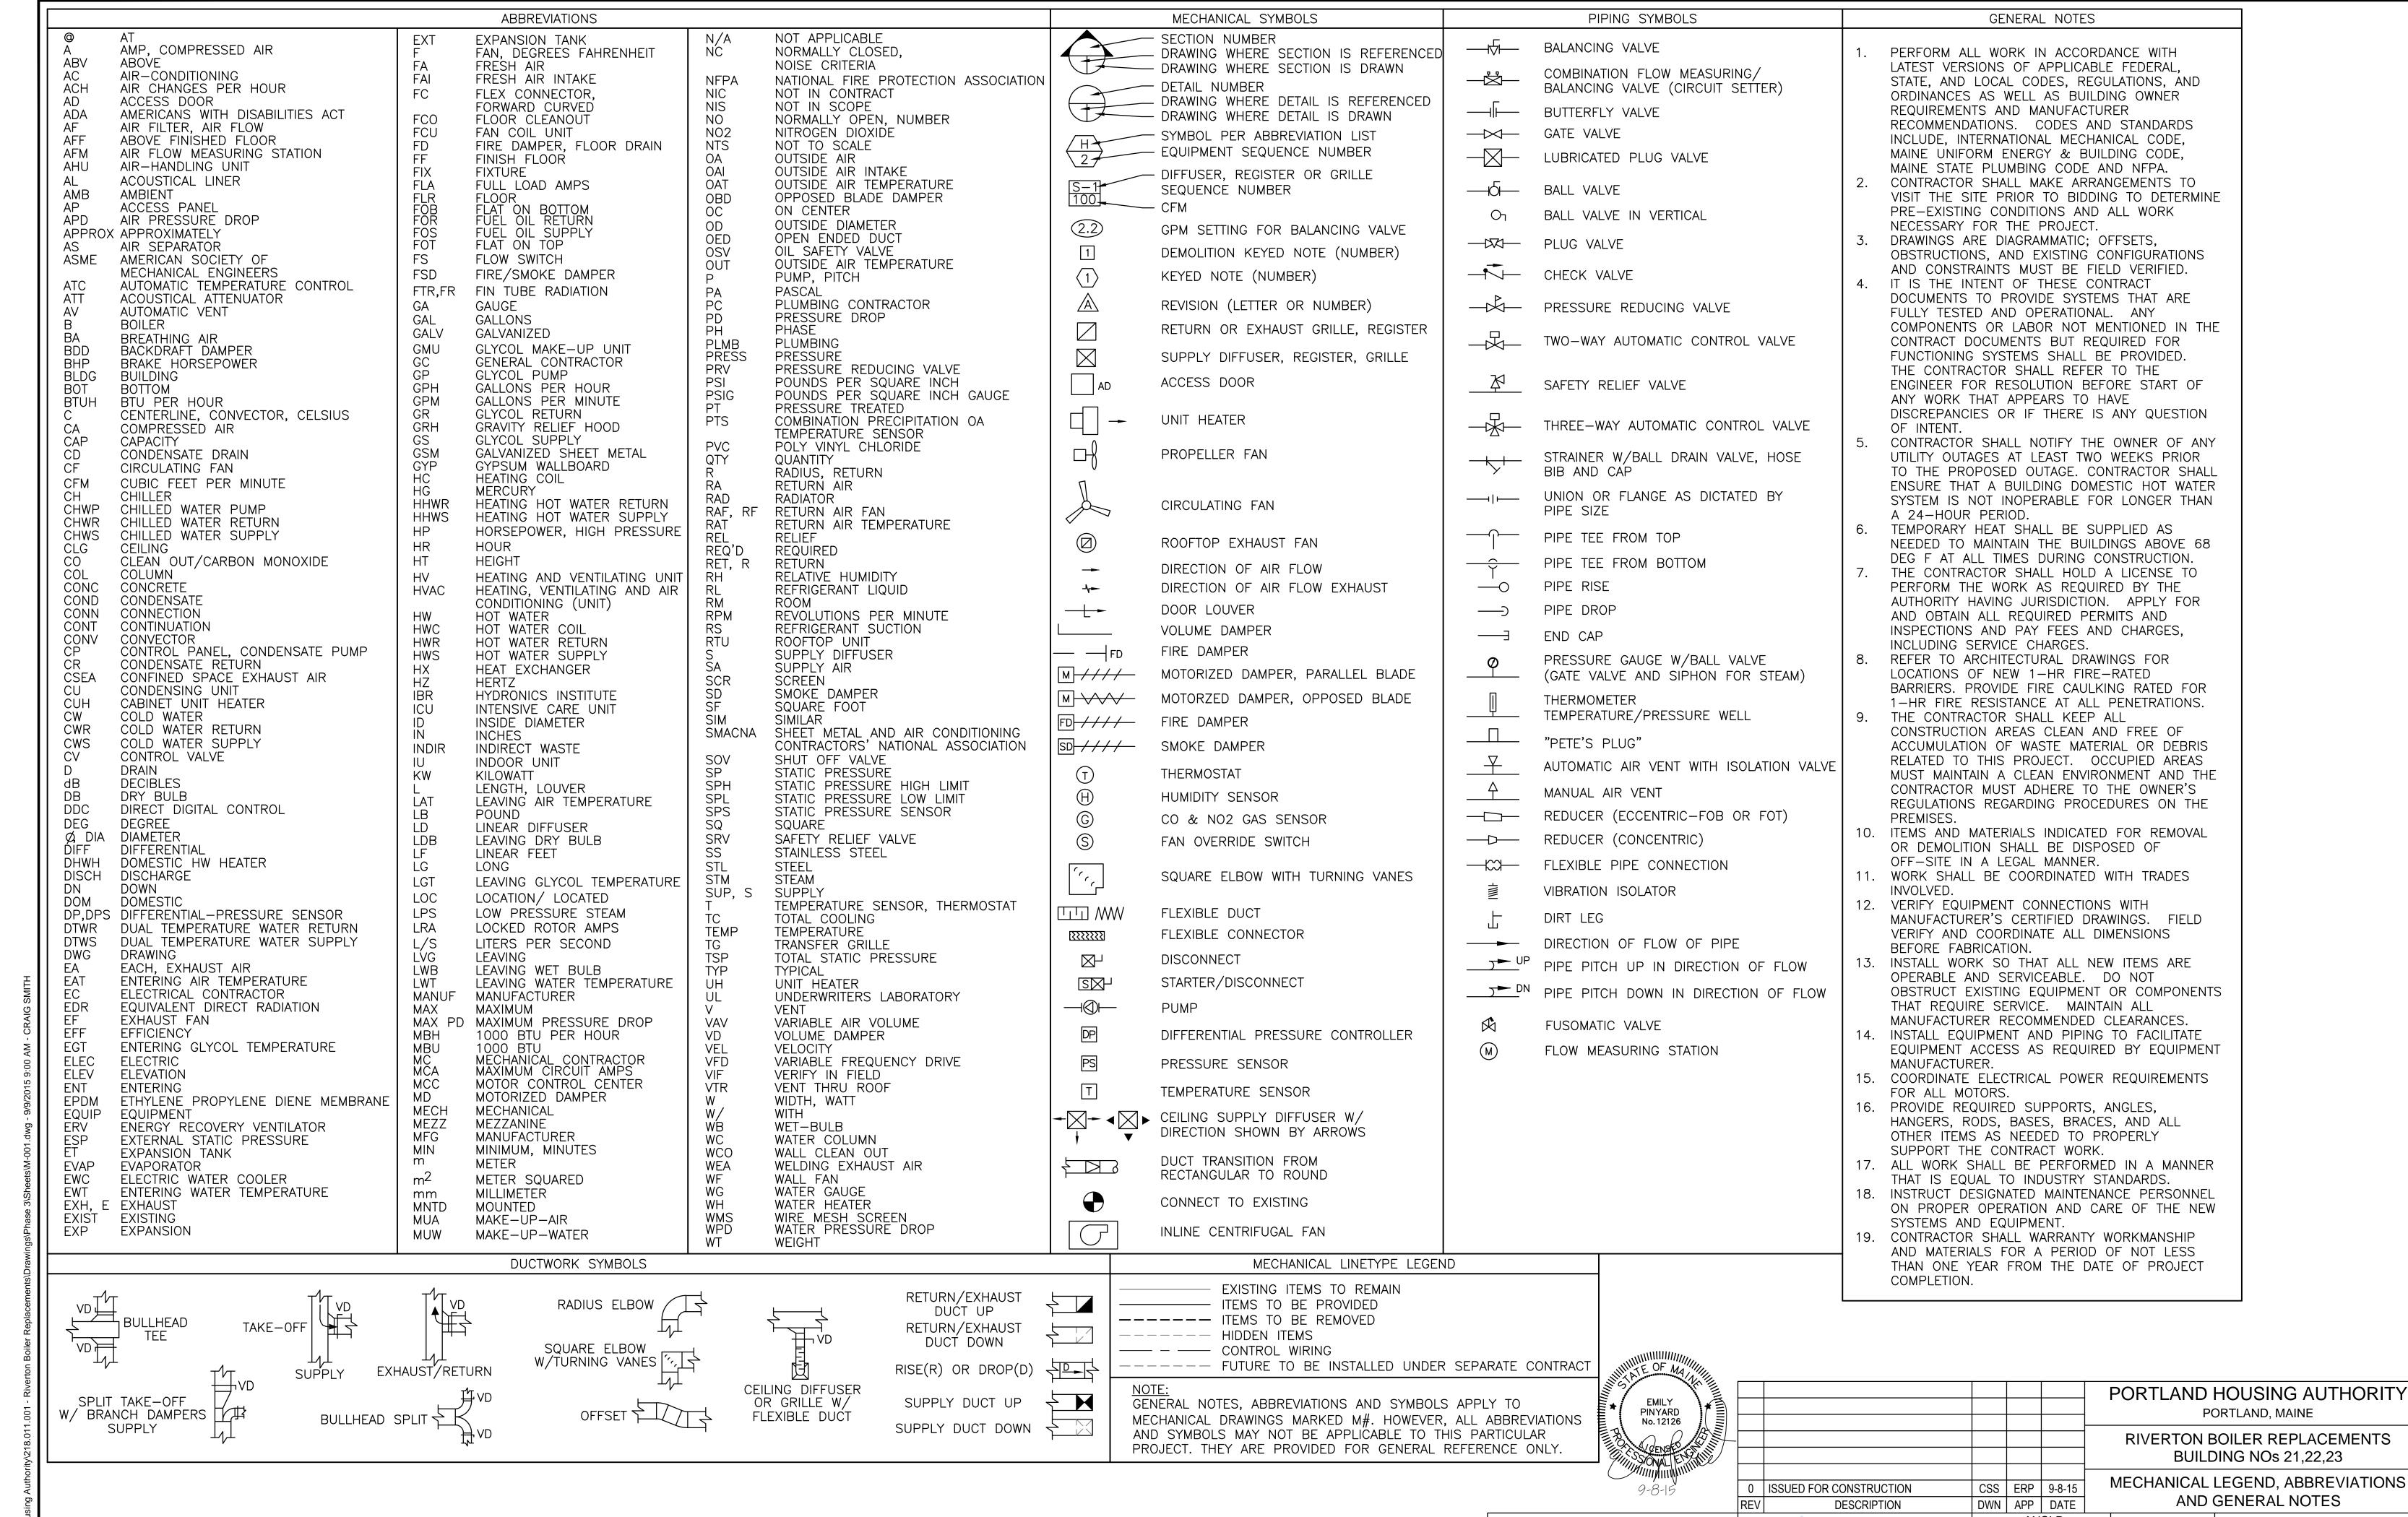

PROJECT NO. DRAWING NO. ANSI D SIZE: 47A York Street 9-8-15 DATE: 218.011.001 Portland, Maine 04101 DES BY: ERP 207.553.7753 SHEET Colby Company DWN BY: CSS colbycoengineering.com 4 of 16 engineering CKD BY: MIF

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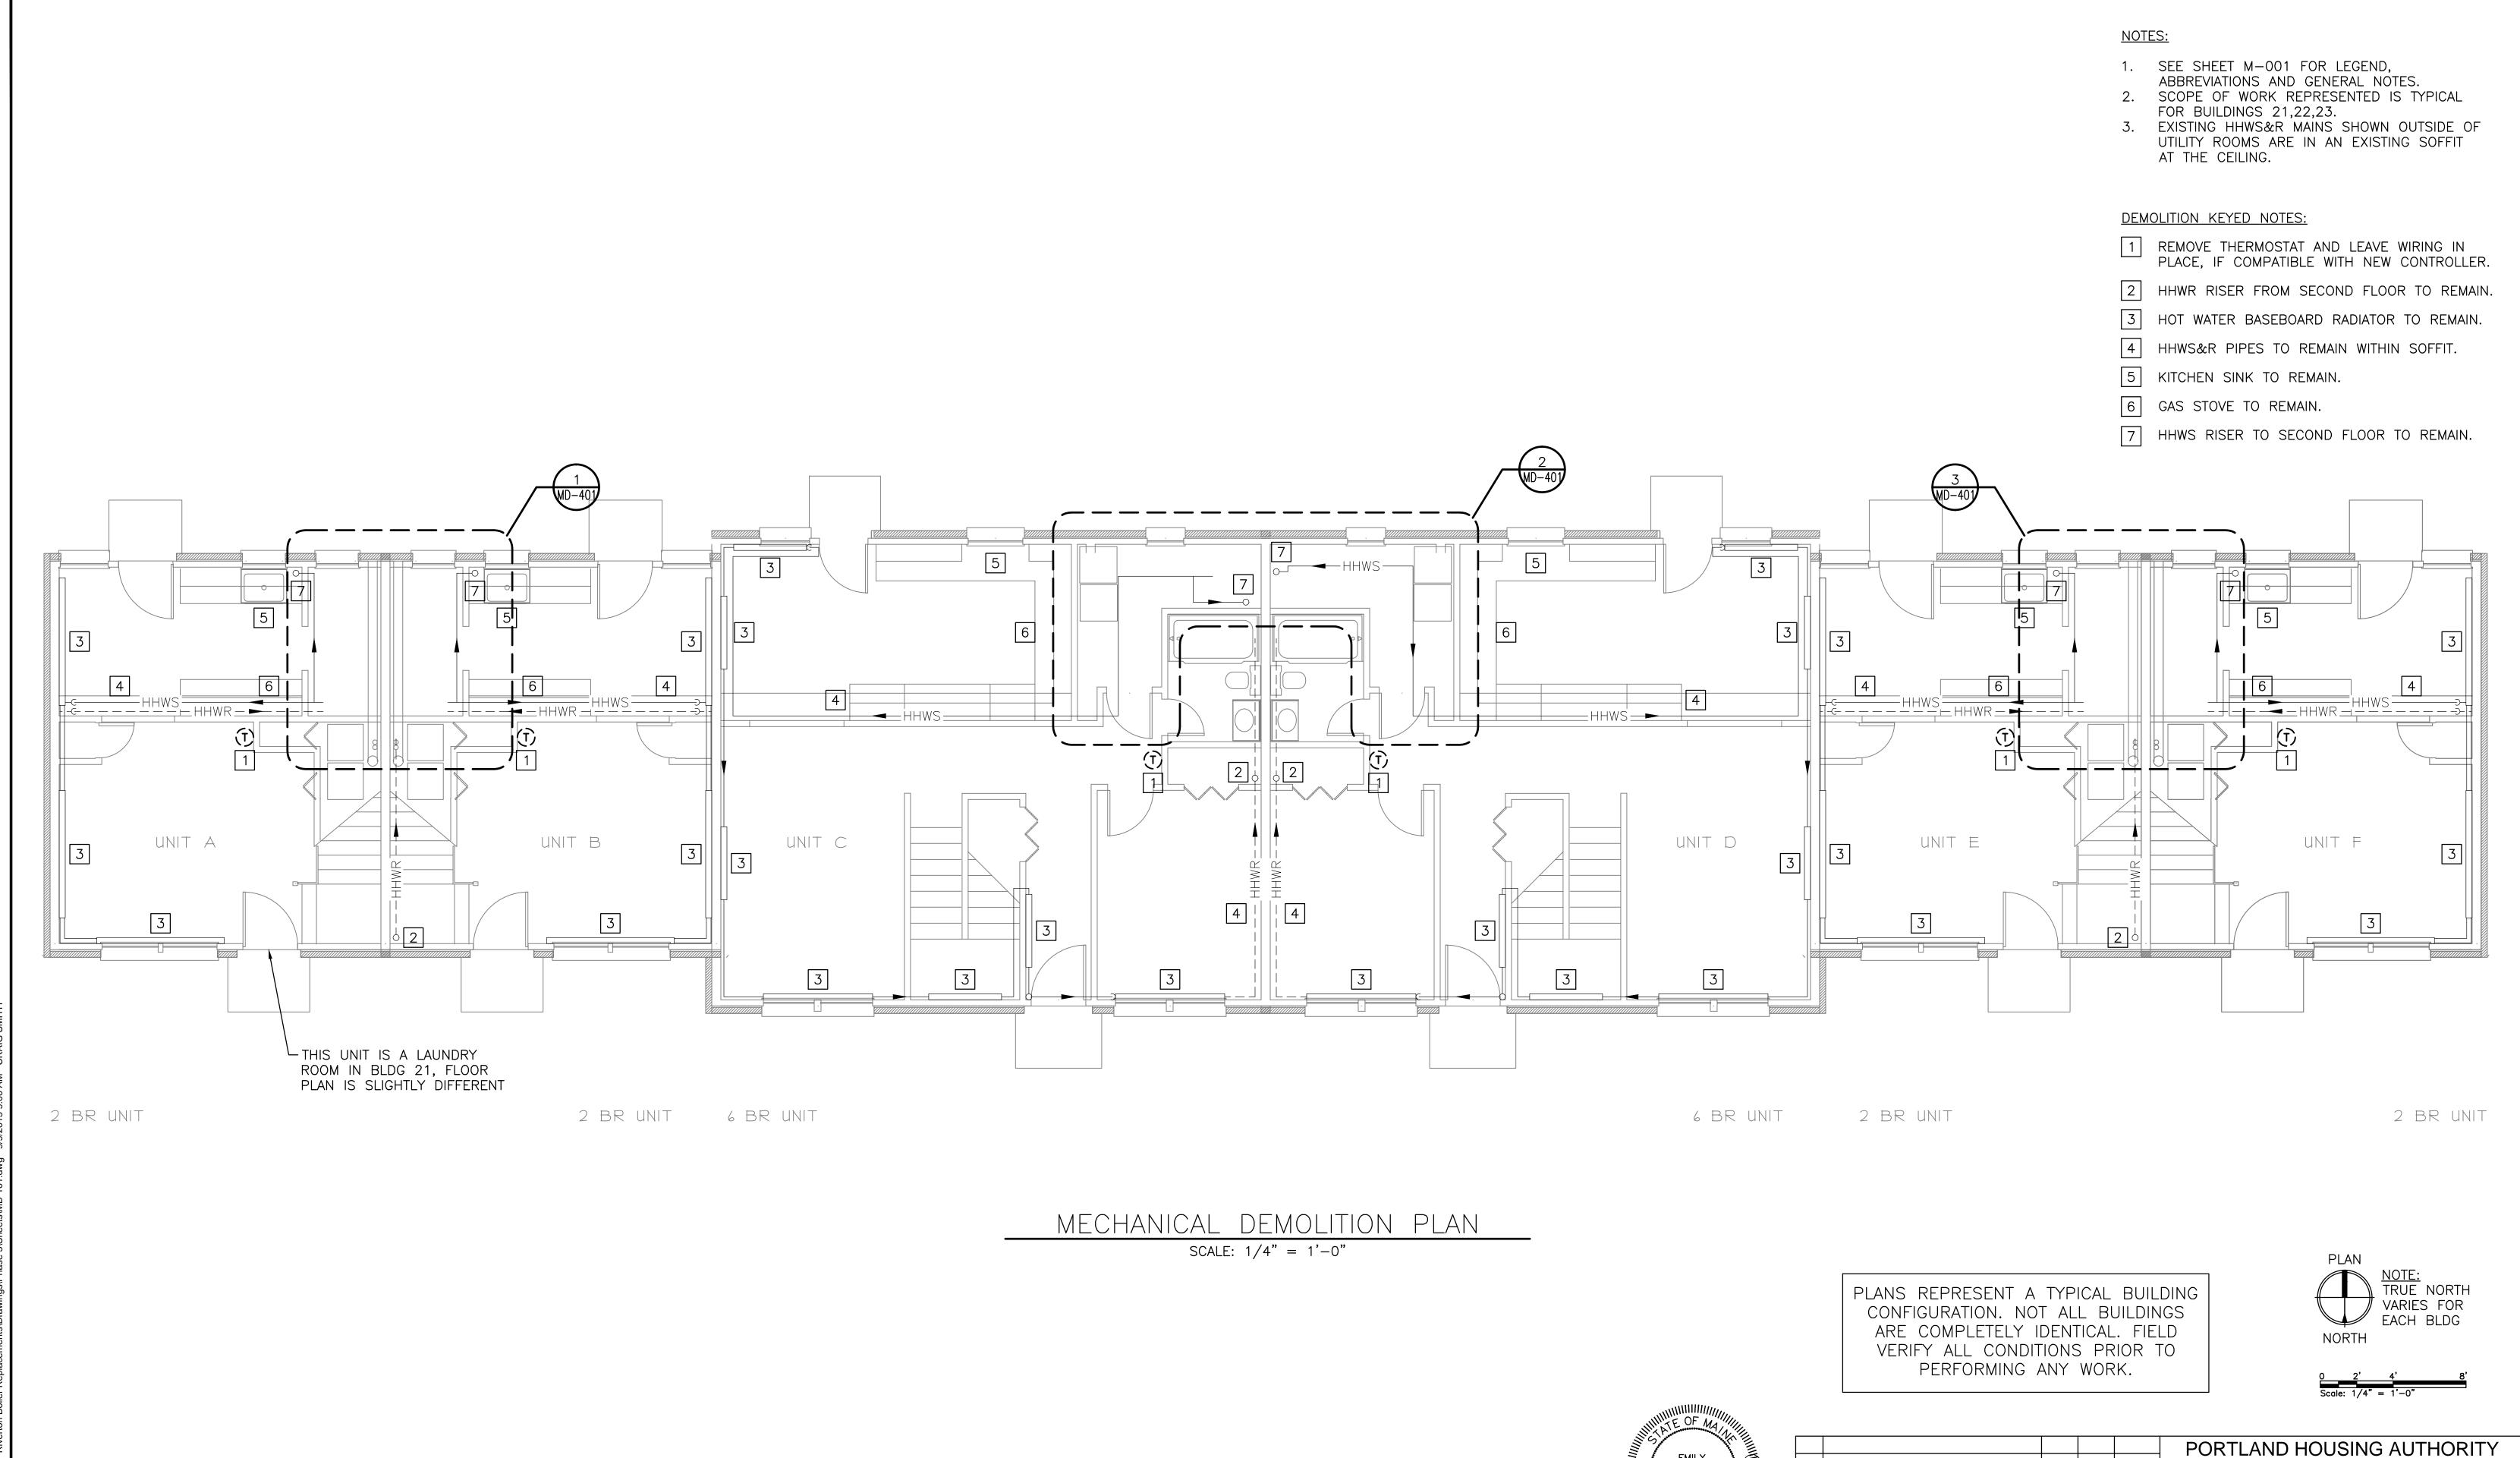
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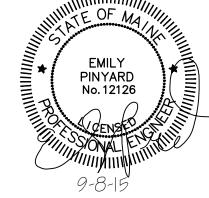
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RIVERTON BOILER REPLACEMENTS CSS ERP 9-8-15 0 ISSUED FOR CONSTRUCTION MECHANICAL DEMOLITION PLAN DWN APP DATE DESCRIPTION

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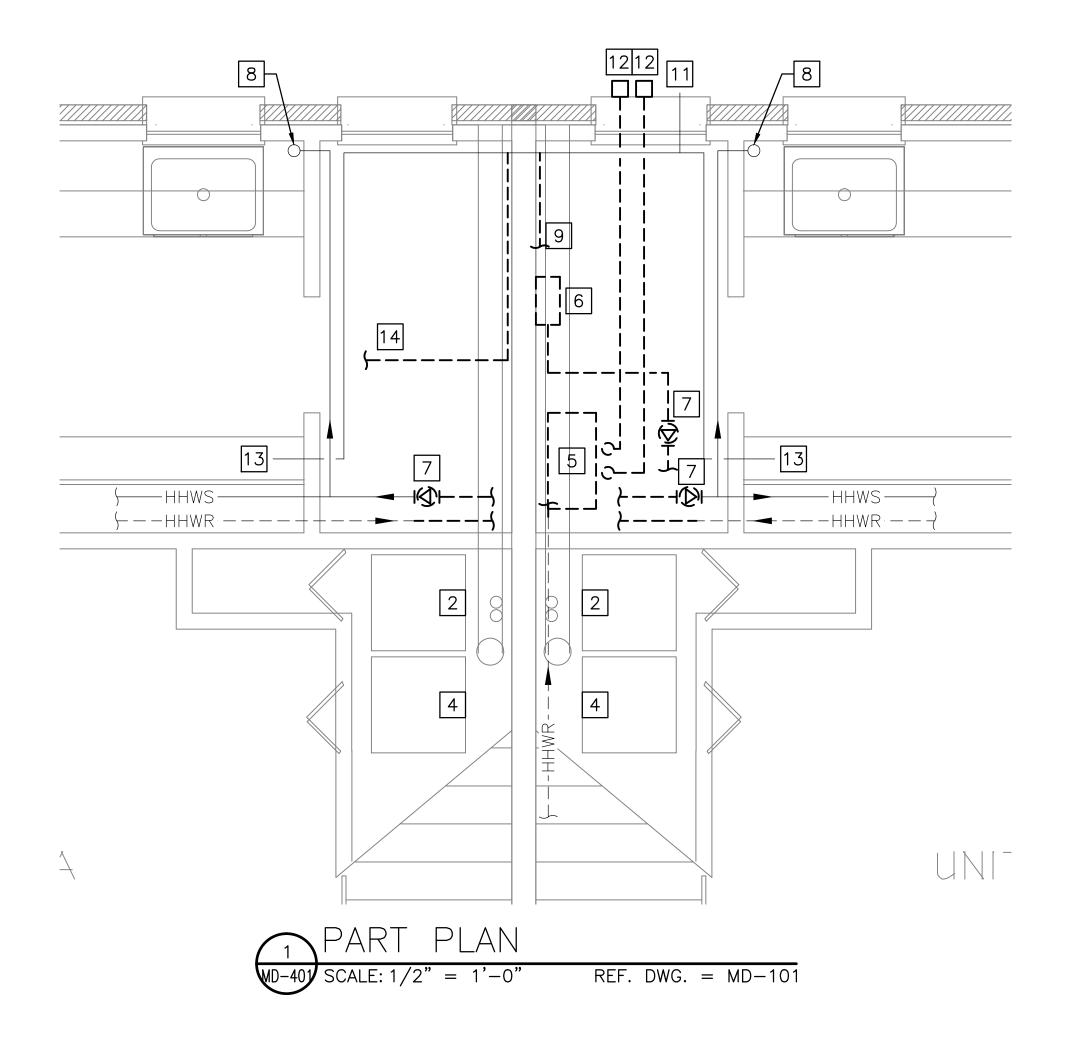
DRAWING NO. PROJECT NO. 218.011.001 MD-101 5 OF 16


PORTLAND, MAINE


BUILDING NOs 21,22,23

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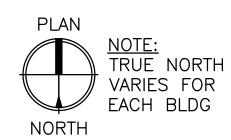
colby Company colbycoengineering.com DWN BY: CSS engineering CKD BY: MIF







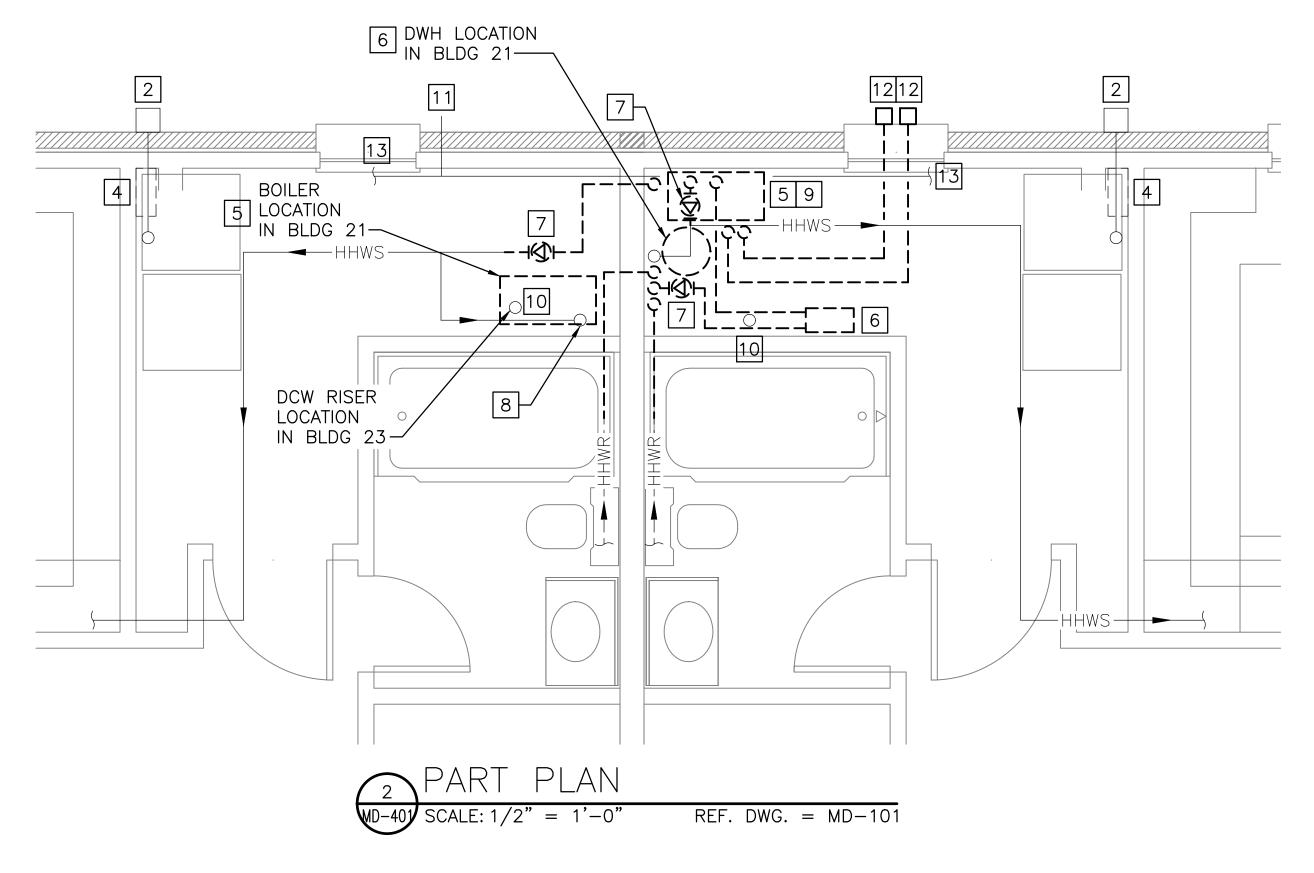

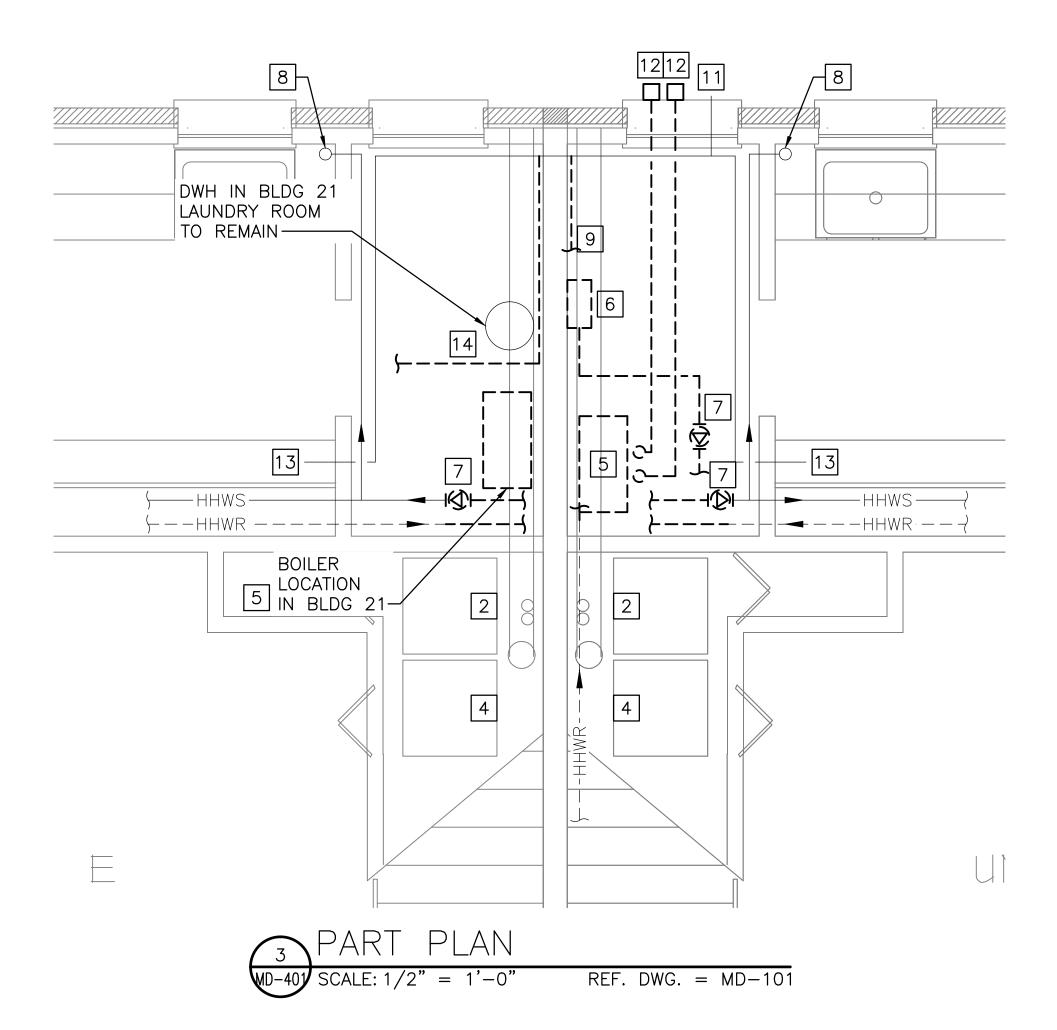PLANS REPRESENT A TYPICAL BUILDING CONFIGURATION. NOT ALL BUILDINGS ARE COMPLETELY IDENTICAL. FIELD VERIFY ALL CONDITIONS PRIOR TO PERFORMING ANY WORK.



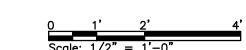

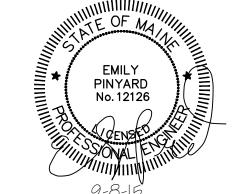

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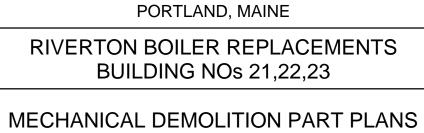
0 ISSUED FOR CONSTRUCTION **Colby Company**

engineering

| CSS | ERP | 9-8-15 DESCRIPTION SIZE: 47A York Street DATE: Portland, Maine 04101 207.553.7753 colbycoengineering.com

DWN APP DATE ANSI D PROJECT NO. 9-8-15 DES BY: ERP SHEET DWN BY: CSS 6 OF 16 CKD BY: MIF

DRAWING NO.



PORTLAND HOUSING AUTHORITY

218.011.001

FOR BUILDINGS 21,22,23. 3. INSPECT AND PRESSURE TEST ALL EXISTING TO REMAIN LOW PRESSURE NATURAL GAS PIPING. REPAIR ANY LEAKS AND REPLACE ANY DAMAGED OR CORRODED OR NFPA 54 NONCOMPLIANT SECTIONS OF PIPING. PAINT ALL NEW AND EXISTING TO REMAIN PIPING

ABBREVIATIONS AND GENERAL NOTES.

SCOPE OF WORK REPRESENTED IS TYPICAL

1. SEE SHEET M-001 FOR LEGEND,

FOR CORROSION RESISTANCE. 4. FOR BIDDING PURPOSES, ASSUME COMPLETE REPLACEMENT OF INTERIOR NATURAL GAS PIPING AND PROVIDE OWNER CREDITS FOR ANY GAS PIPING THAT IS FOUND TO BE SUFFICIENT FOR RE-USE.

DEMOLITION KEYED NOTES:

1 NOT USED.

NOTES:

2 DRYER VENT AND WALL CAP TO REMAIN.

3 NOT USED

CLOTHES WASHER HOOKUPS TO REMAIN.

REMOVE BOILER AND ASSOCIATED BRANCH PIPING & CONTROLS. BOILER CONDENSATE DRAIN PIPE PENETRATES FLOOR SLAB. PATCH DRAIN PIPE OPENING WITH CONCRETE AFTER REMOVAL (APPROX 1"Ø X 6" DEEP)

REMOVE TANKLESS DOMESTIC WATER HEATER AND ASSOCIATED BRANCH PIPING & CONTROLS.

REMOVE PUMP AND CONTROLS.

HHWS RISER UP TO SECOND FLOOR HW BASEBOARD TO REMAIN.

3/4" NATURAL GAS SUPPLY PIPING TO BOILER TO BE REMOVED.

2" DCW SERVICE AND BACKFLOW PREVENTER TO REMAIN. LOCATION VARIES BASED ON BLDG, FIELD VERIFY.

1" NATURAL GAS ENTRANCE TO REMAIN. ACTUAL LOCATION VARIES - CONFIRM IN FIELD. IN ENTRANCE INTERFERES WITH NEW DOOR, RELOCATE.

12 REMOVE BOILER FLUE AND COMBUSTION AIR INTAKE & WALL CAPS.

3/4" GAS SUPPLY PIPING TO STOVE TO REMAIN.


NATURAL GAS PIPING IN BLDG 22 RUNS THROUGH MIDDLE OF ROOM. REMOVE SECTION AND RE-ROUTE RUN TIGHT TO WALLS.

NOTES:

- 1. SEE SHEET M-001 FOR LEGEND,
- ABBREVIATIONS AND GENERAL NOTES. 2. SCOPE OF WORK REPRESENTED IS TYPICAL FOR BUILDINGS 21,22,23.
- 3. CONSTRUCT NEW SOFFIT TO CONTAIN NEW HOT WATER PIPING OUTSIDE OF UTILITY SPACES OR ROUTE NEW PIPING THROUGH EXISTING SOFFIT IF FEASIBLE.


KEYED NOTES:


1 PROVIDE NEW THERMOSTAT TIED TO NEW ZONE CONTROLLER.

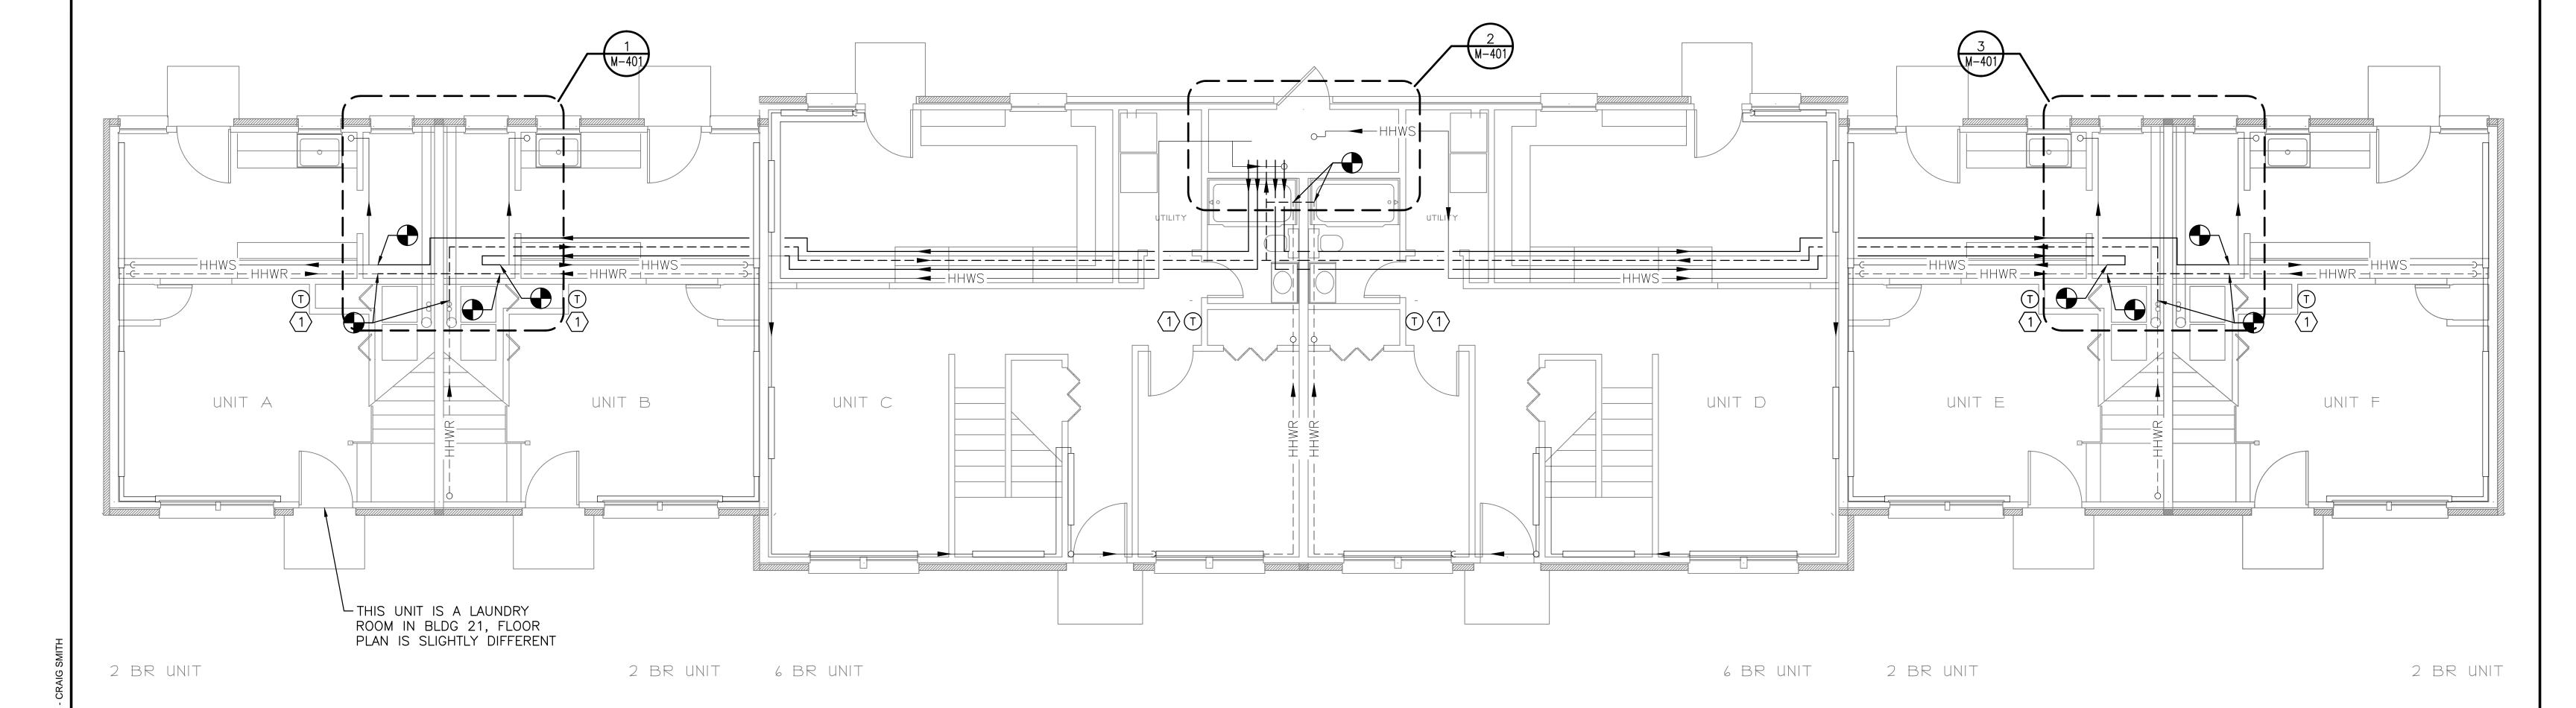

MECHANICAL FIRST FLOOR PLAN — HEATING HOT WATER SCALE: 1/4" = 1'-0"

> PLANS REPRESENT A TYPICAL BUILDING CONFIGURATION. NOT ALL BUILDINGS ARE COMPLETELY IDENTICAL. FIELD VERIFY ALL CONDITIONS PRIOR TO PERFORMING ANY WORK.

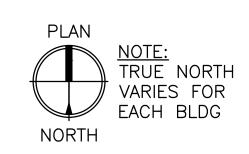


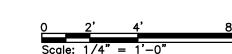

PORTLAND HOUSING AUTHORITY

PORTLAND, MAINE

RIVERTON BOILER REPLACEMENTS BUILDING NOs 21,22,23

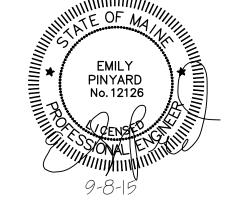

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CKD BY: MIF

colby Company colbycoengineering.com DWN BY: CSS

engineering

MECHANICAL FIRST FLOOR PLAN -HEATING HOT WATER DRAWING NO. PROJECT NO. 218.011.001

7 OF 16


M-101

NOTES:

- 1. SEE SHEET M-001 FOR LEGEND, ABBREVIATIONS AND GENERAL
- SCOPE OF WORK REPRESENTED IS TYPICAL FOR BUILDINGS 21,22,23.

KEYED NOTES:


- 1) EXISTING 2" DCW ENTRANCE WITH VERTICAL BACKFLOW PREVENTER TO REMAIN.
- (2) CONNECT NEW DHWS MAINS TO EXISTING-TO-REMAIN DHWS MAINS.
- 3 DHWR PUMP SHOWN OUTSIDE OF BOILER ROOM FOR CLARITY BUT WILL BE INSTALLED INSIDE BOILER ROOM.
- 4 PROVIDE BALANCING VALVE AT END OF DHWR LINE.
- NEW BOILER ROOM SPRINKLER HEAD, K-5.6 ORIFICE, 200 DEG F TEMPERATURE RATED. PROVIDE ALARM BELL ON OUTSIDE OF BOILER ROOM.
- (6) NEW BOILER ROOM FLOOR DRAIN SHALL TIE INTO EXISTING SANITARY MAIN BELOW SLAB. CUT AND PATCH CONCRETE SLAB.
- (7) INSTALL BOILER CONDENSATE NEUTRALIZER AND PIPE DISCHARGE TO FLOOR DRAIN. PROVIDE PIPE RAMP OVER DRAIN PIPE.
- 8 EXISTING DWH IN BUILDING 21 (LAUNDRY ROOM) TO REMAIN. DO NOT CONNECT NEW DOMESTIC HOT WATER SUPPLY TO LAUNDRY ROOM.

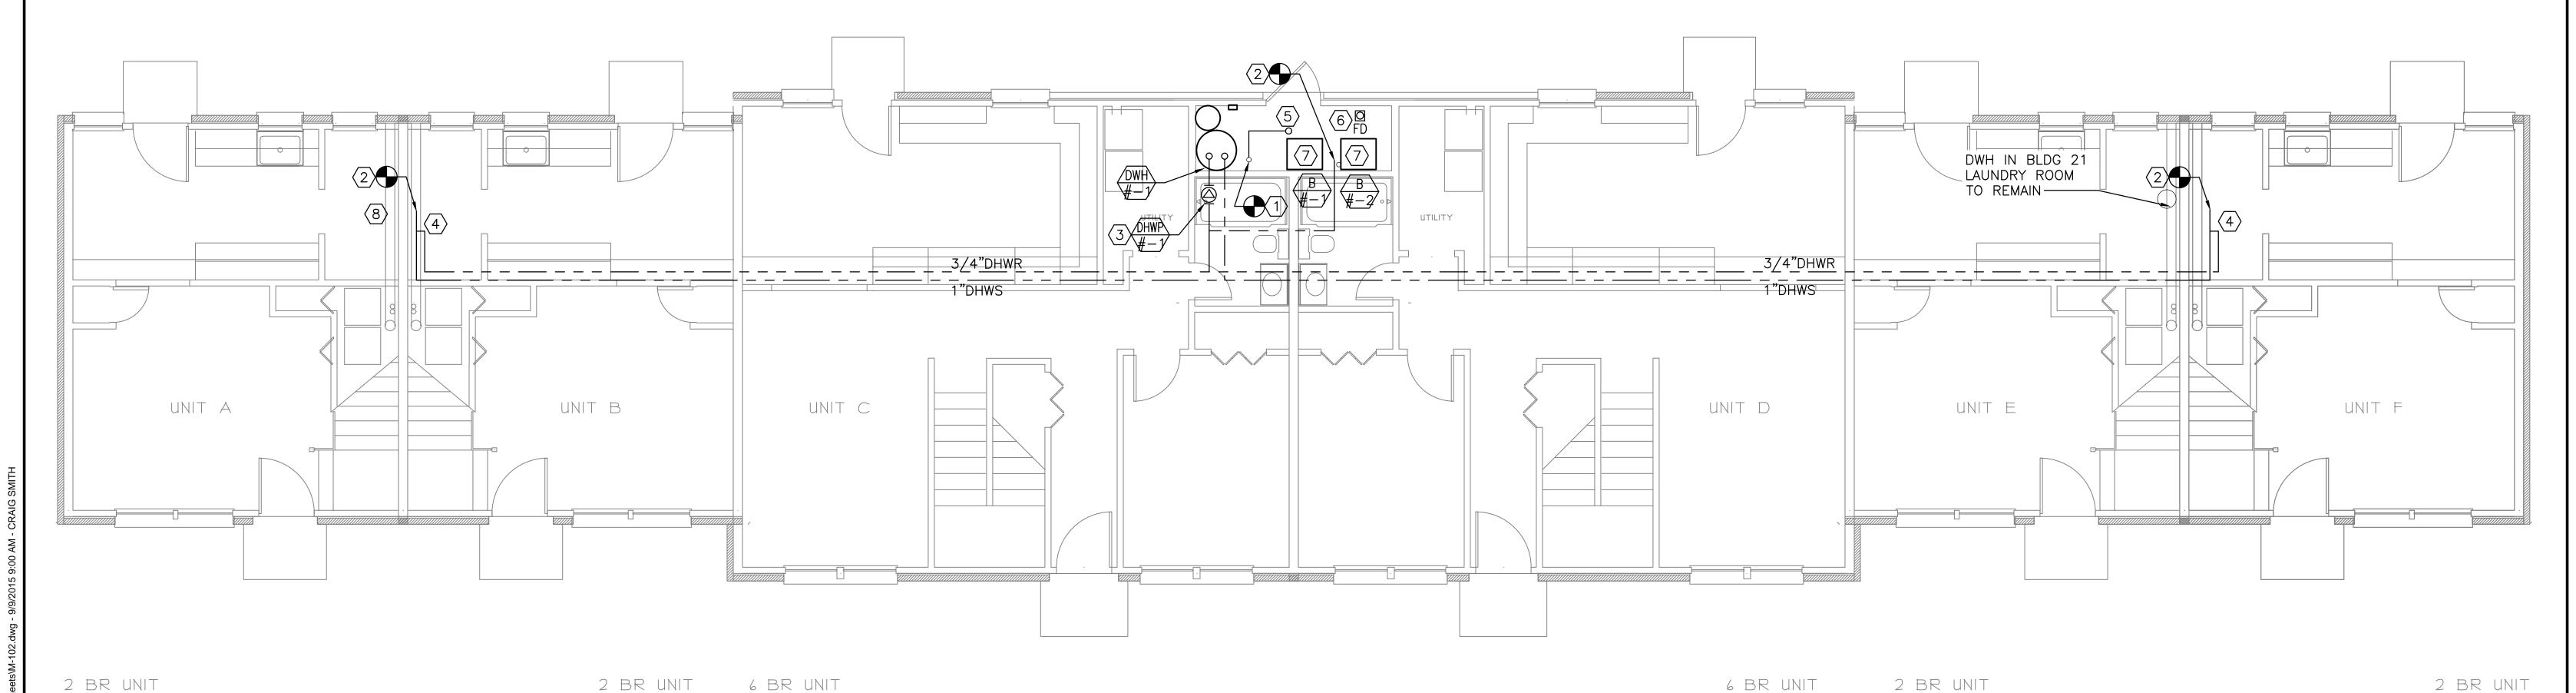

MECHANICAL FIRST FLOOR PLAN - PLUMBING

SCALE: 1/4" = 1'-0"

PLANS REPRESENT A TYPICAL BUILDING CONFIGURATION. NOT ALL BUILDINGS ARE COMPLETELY IDENTICAL. FIELD VERIFY ALL CONDITIONS PRIOR TO PERFORMING ANY WORK.

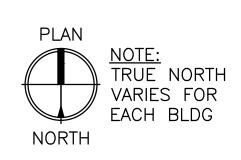




PORTLAND HOUSING AUTHORITY

PORTLAND, MAINE

RIVERTON BOILER REPLACEMENTS BUILDING NOs 21,22,23


PLUMBING

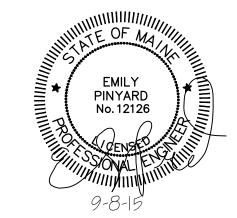


MECHANICAL FIRST FLOOR PLAN -CSS ERP 9-8-15 0 ISSUED FOR CONSTRUCTION DWN APP DATE DESCRIPTION ANSI D PROJECT NO. SIZE: 47A York Street Portland, Maine 04101 207.553.7753 9-8-15 DATE: 218.011.001 DES BY: ERP **Colby Company** colbycoengineering.com DWN BY: CSS 8 OF 16 engineering CKD BY: MIF

DRAWING NO. M-102

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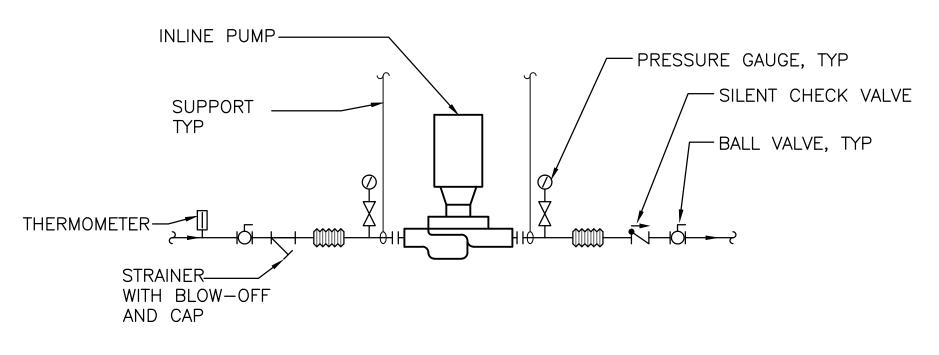


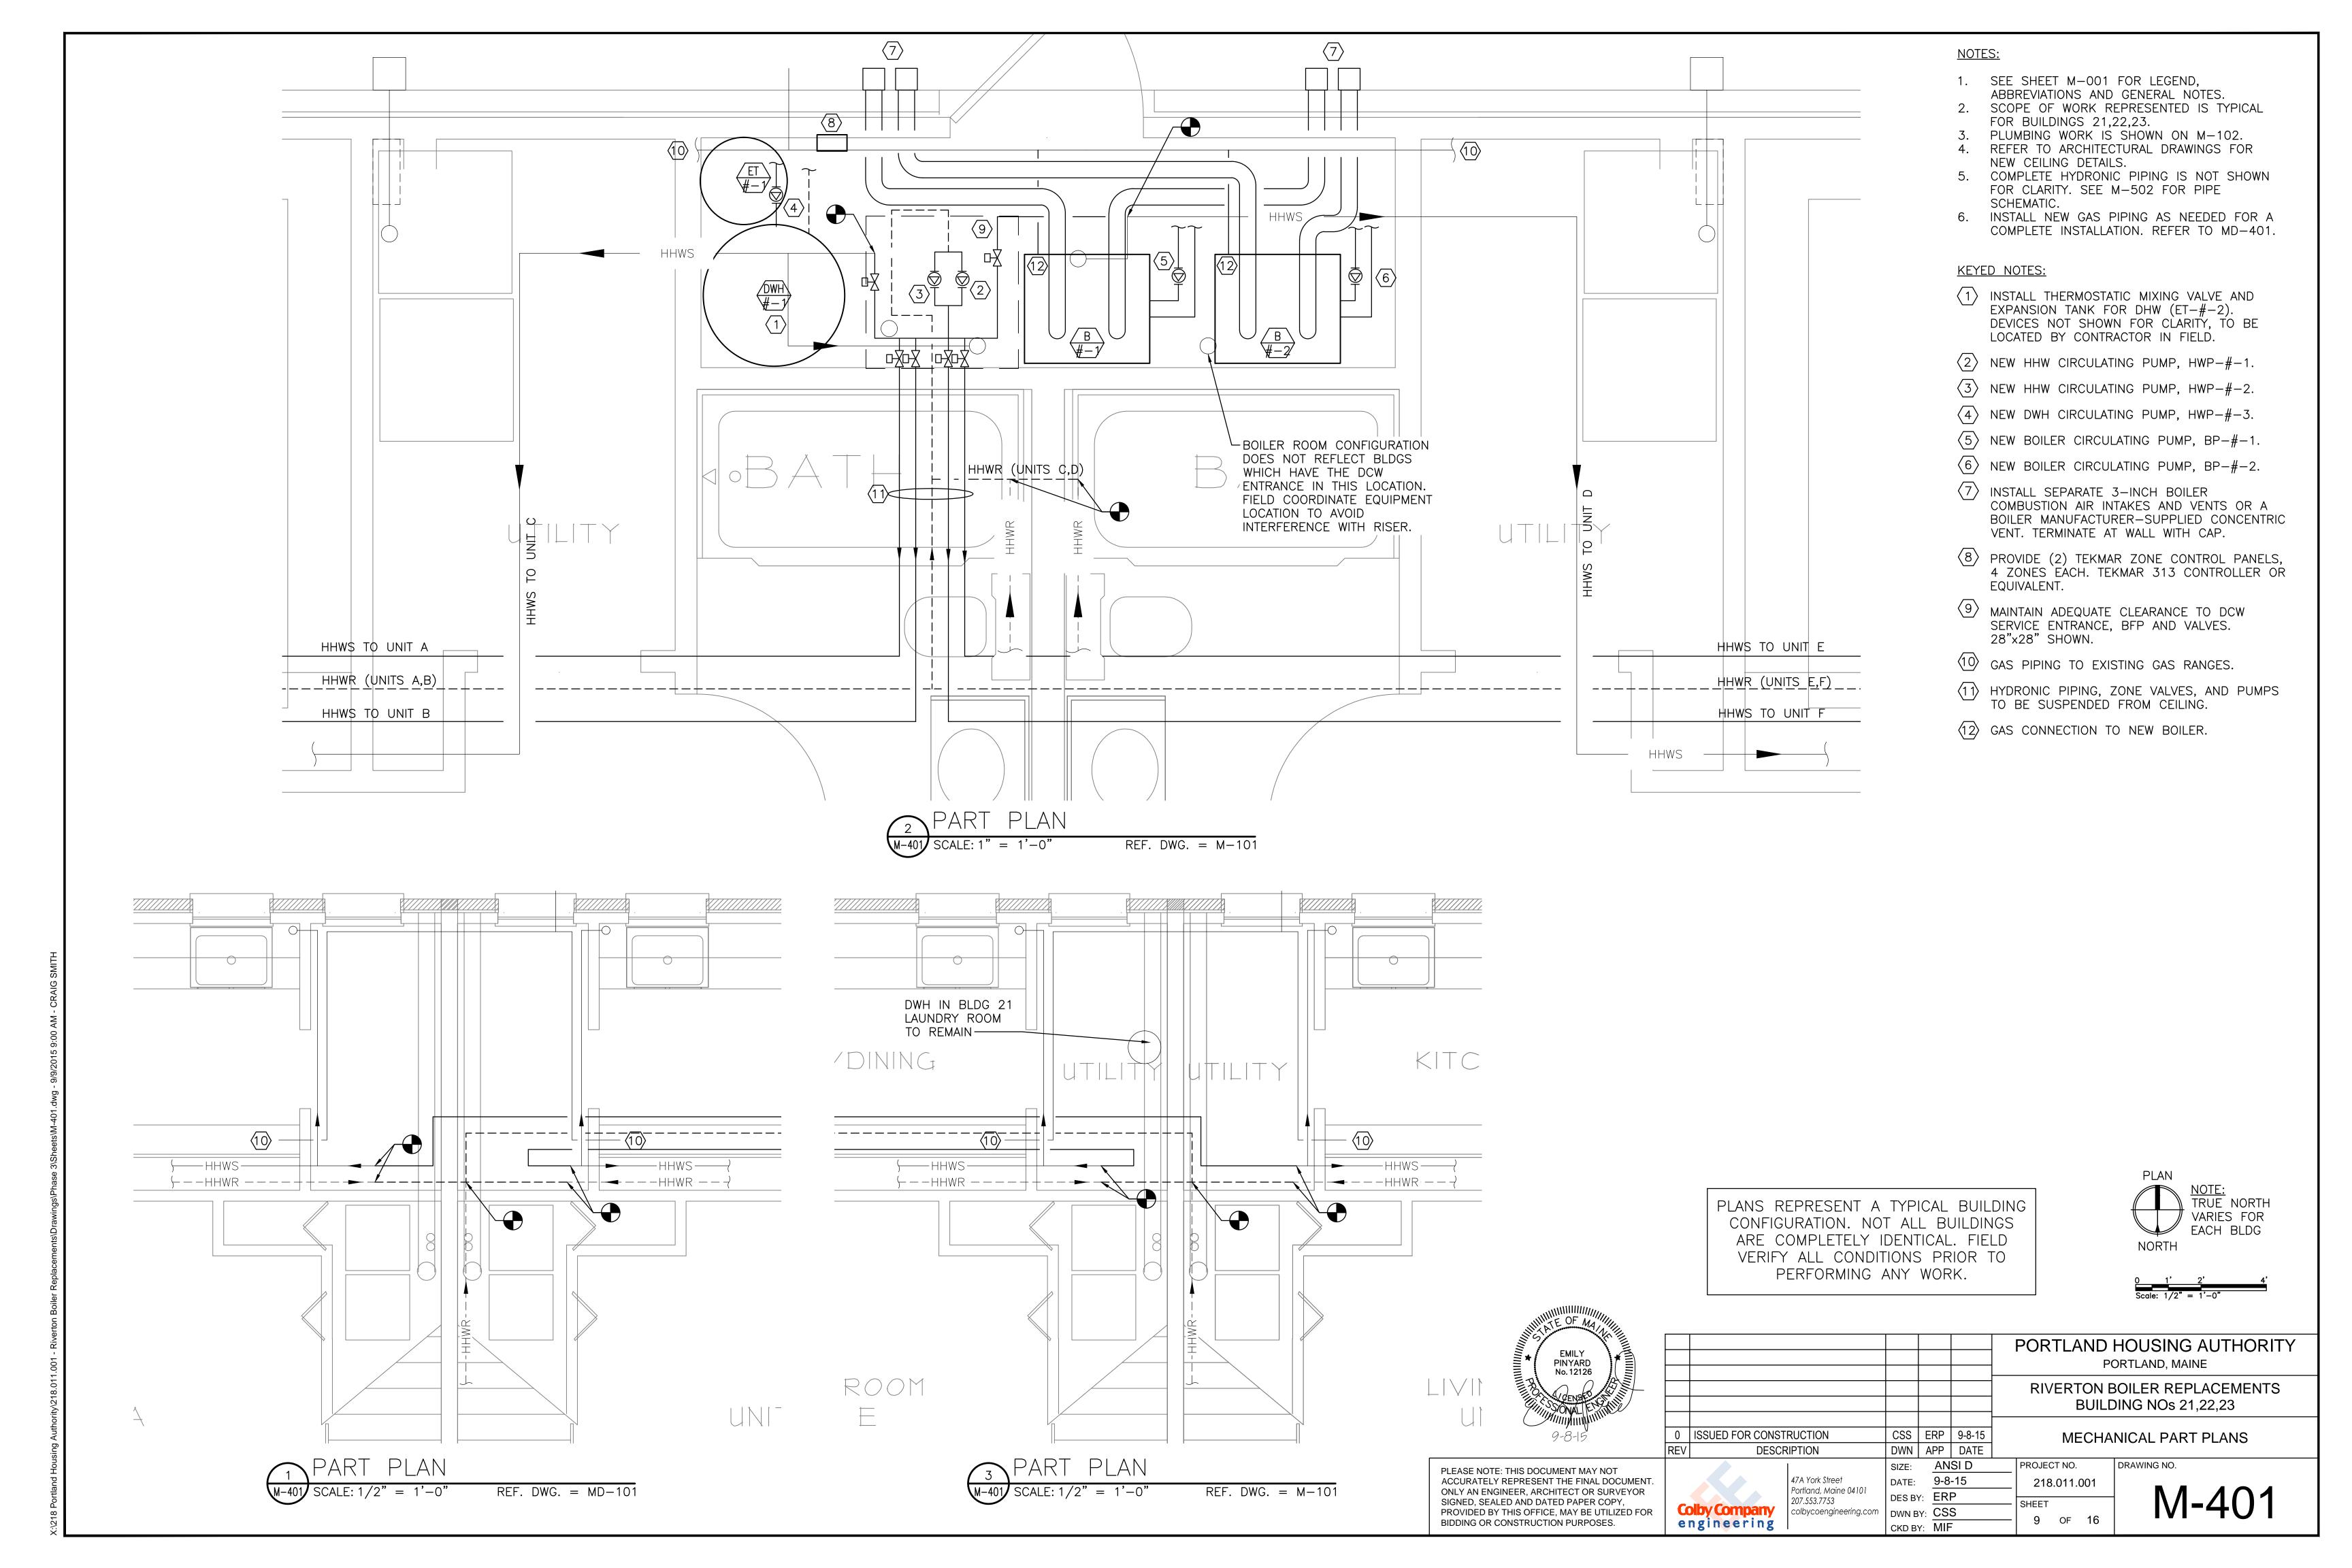

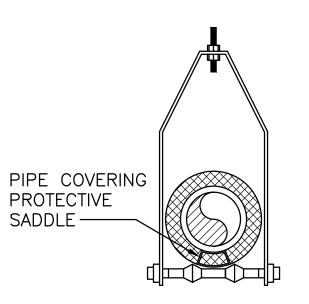CLEVIS HANGER (FOR PIPES 2-1/2" & SMALLER) ADJUSTABLE HANGER W/ROLLER (FOR PIPES 3" THRU 6")

PIPE HANGER ATTACHMENTS DETAIL

SCALE: NTS




NOTES:

1. VALVES SHALL BE SAME SIZE AS PIPE. PROVIDE SPRING VIBRATION ISOLATORS FOR PUMP & PIPE WITHIN 20 FT. OF PUMP.

INLINE PUMP PIPING SCHEMATIC

SCALE: NTS

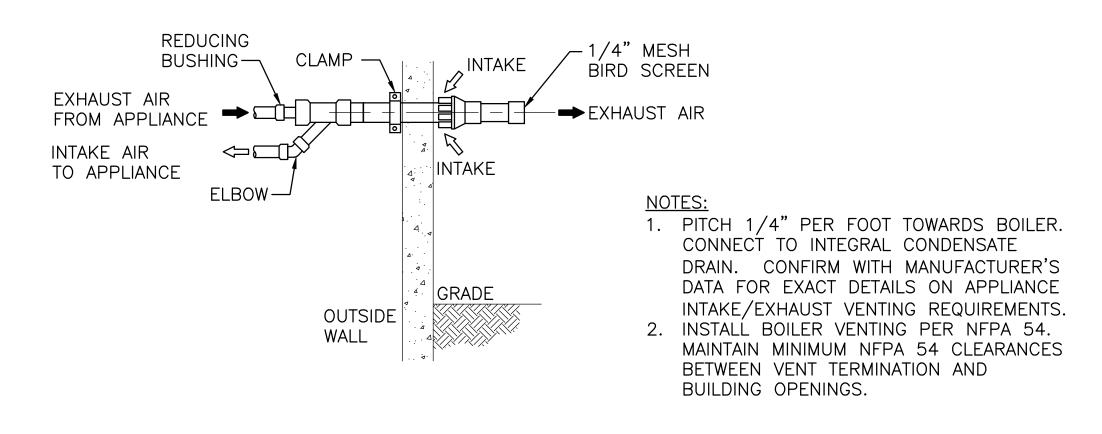


CONCENTRIC WALL TERMINATION DETAIL NOT TO SCALE

- SHUT OFF VALVE (TYPICAL) - STRAINER WITH BLOW-OFF AND CAP - PRESSURE GAUGE (TYPICAL)

- BACK FLOW PREVENTER. • USE INTERMEDIATE VENT (ASSE 1012) ON NON HAZARDOUS SYSTEMS WITH 1/2" AND 3/4" FILL PIPING
- USE DOUBLE CHECK (ASSE 1015) ON NON HAZARDOUS SYSTEMS WITH 1" AND LARGER FILL PIPING

TYPICAL MAKE-UP WATER CONNECTION DETAIL NOT TO SCALE

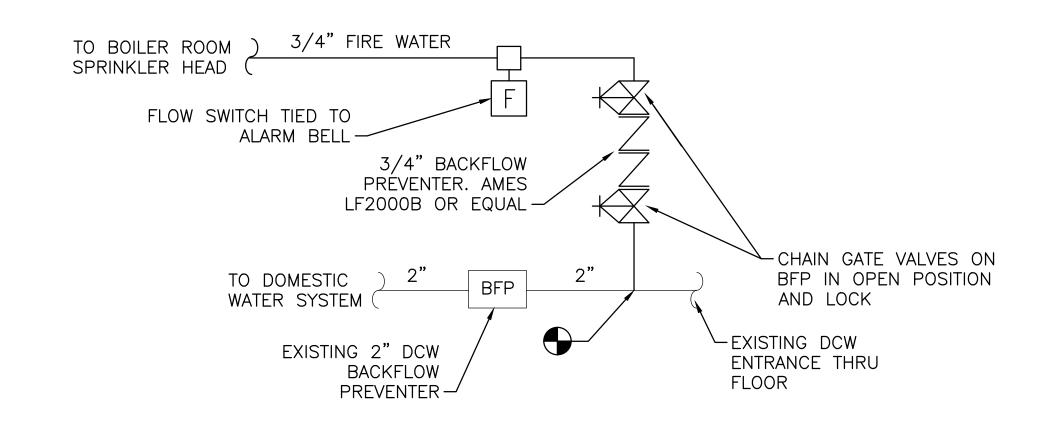

FIRE/DOMESTIC WATER RISER DIAGRAM - LIMITED AREA SCALE: NTS

1-1/2" GAS SUPPLY TO 1" GAS 1" GAS NEW BOILER SUPPLY TO SUPPLY TO ROOM SERVE RANGES SERVE RANGES **UTILITY** 2" METER AND

NOTES:

1. SEE SHEET M-001 FOR LEGEND,


FOR BUILDINGS 21,22,23.

ABBREVIATIONS AND GENERAL NOTES.


SCOPE OF WORK REPRESENTED IS TYPICAL

TYPICAL BUILDING GAS DIAGRAM NOT TO SCALE

REGULATOR AT EACH BUILDING (6" WC MIN SUPPLY)

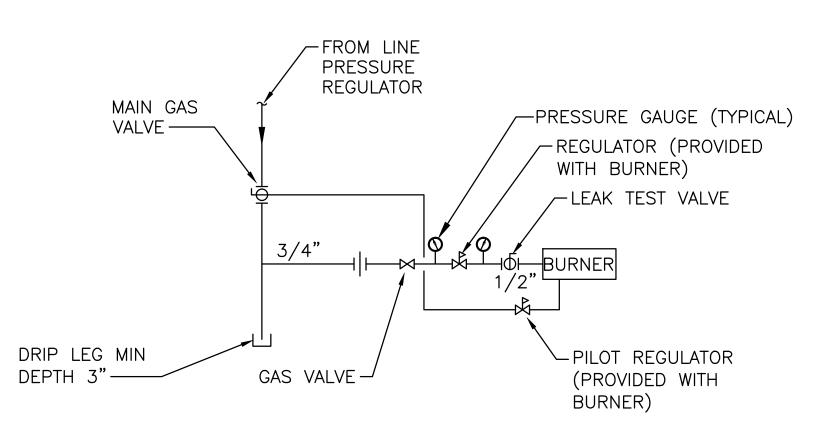

TYPICAL GAS TRAIN ARRANGEMENT NOT TO SCALE

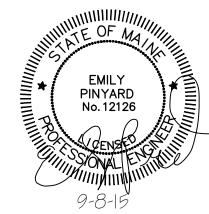

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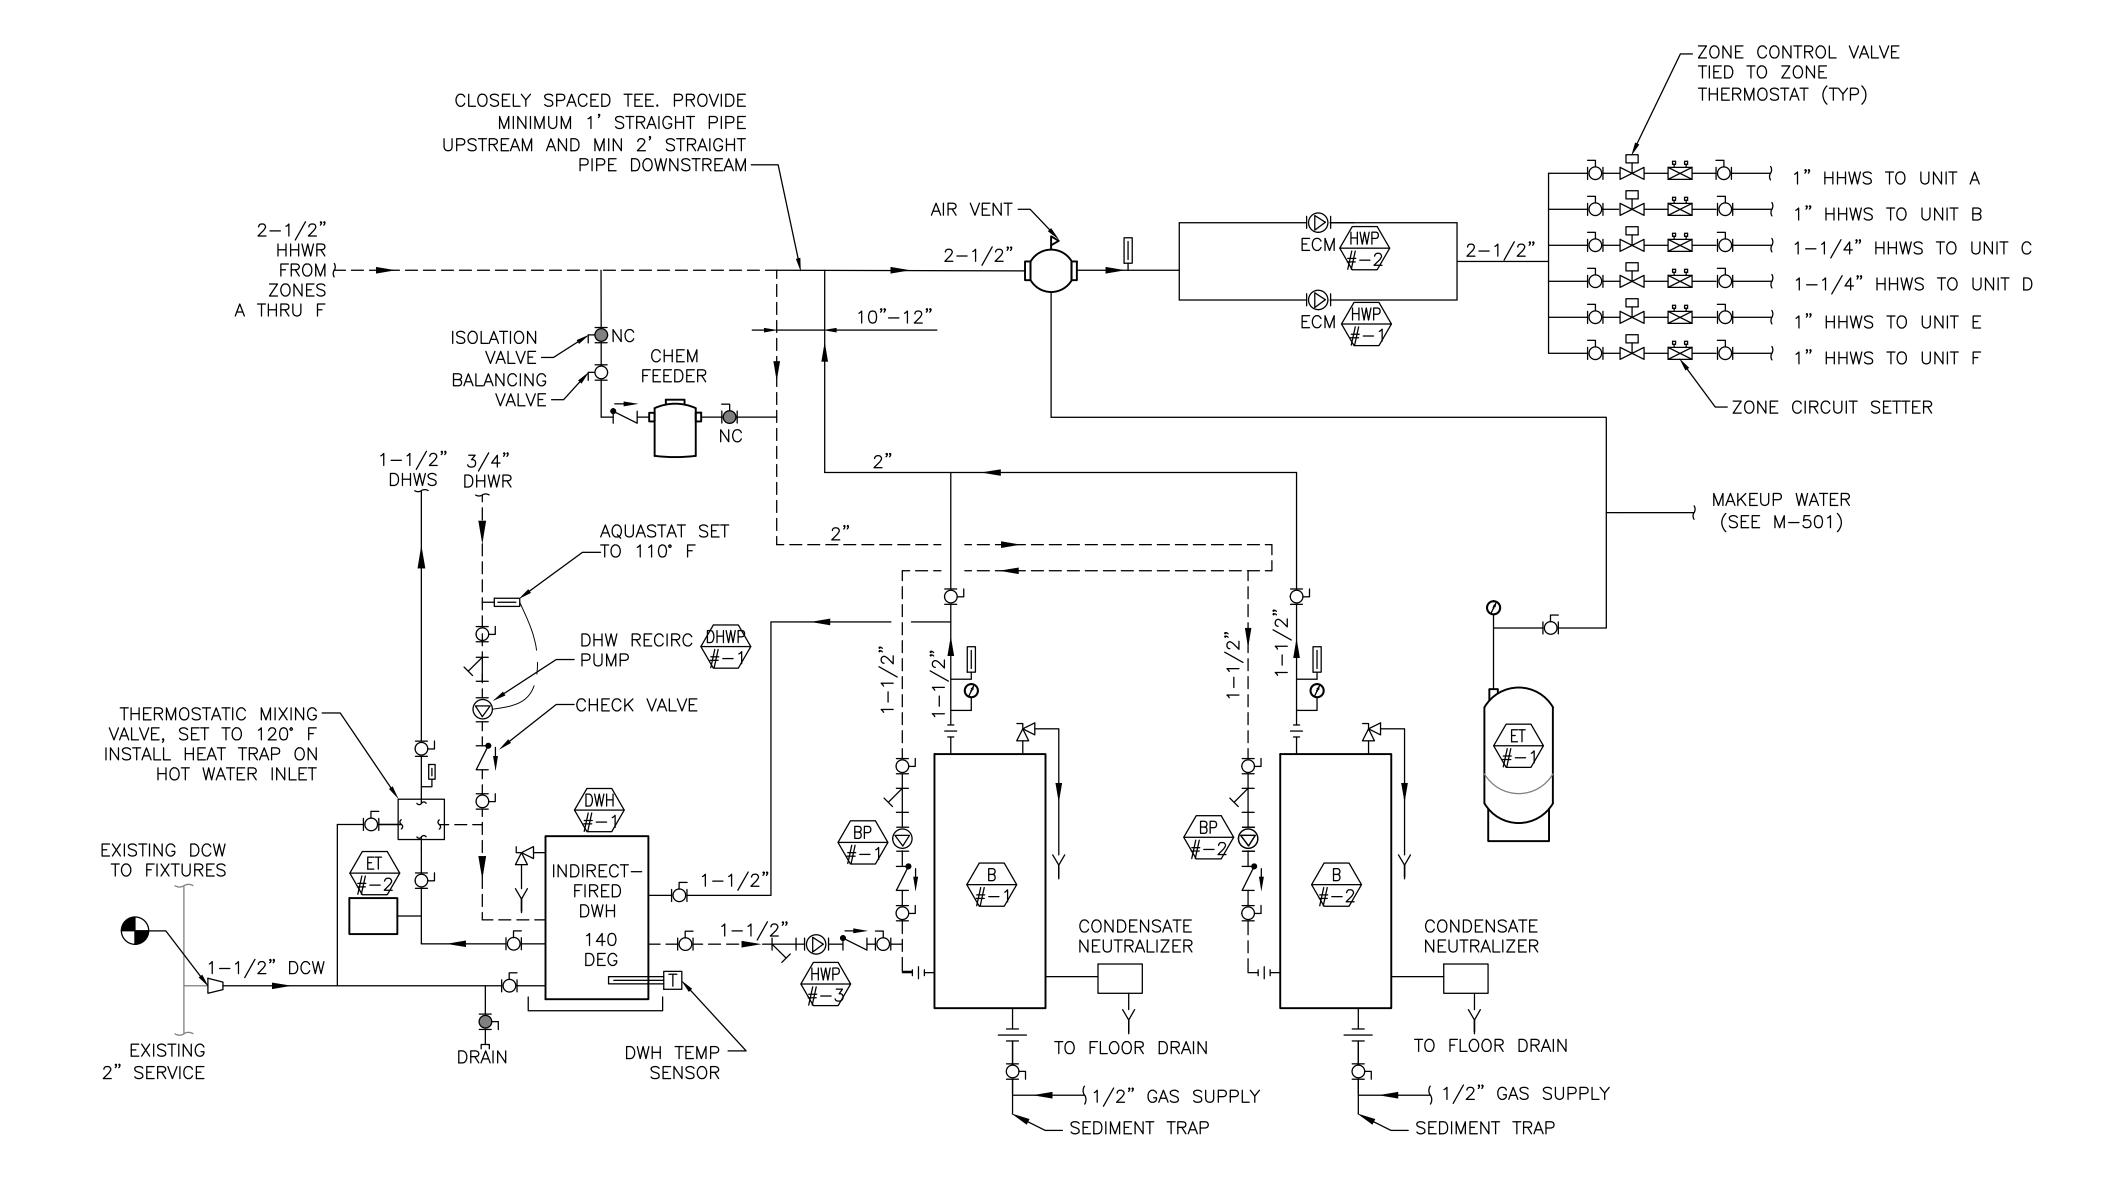
						_	HOUSING AUTHORITY ORTLAND, MAINE				
-						RIVERTON BOILER REPLACEMENTS BUILDING NOs 21,22,23					
-	0 REV	ISSUED FOR CONSTRUCTION DESCRIPTION	CSS DWN	ERP APP	9-8-15 DATE	MECH	HANICAL DETAILS				
Г.	<u> </u>	47A York Street Portland, Maine 04101 207.553.7753	SIZE: DATE: DES B	9-8		PROJECT NO. 218.011.001 — SHEET	DRAWING NO.				

10 OF 16


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engineering

M-501



HEATING & DOMESTIC HOT WATER SCHEMATIC scale: nts

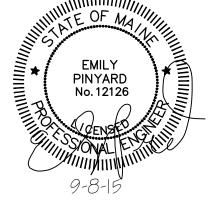

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PORTLAND HOUSING AUTHORITY
PORTLAND, MAINE

PLYEDTON BOILED REDI ACEMENTS

RIVERTON BOILER REPLACEMENTS
BUILDING NOs 21,22,23

0 ISSUED FOR CONSTRUCTION CSS ERP 9-8-15
REV DESCRIPTION DWN APP DATE

MECHANICAL SCHEMATICS

Colby Company engineering Size: ANSI D

47A York Street Portland, Maine 04101 207.553.7753 colbycoengineering.com

Size: ANSI D

DATE: 9-8-15

DES BY: ERP

DWN BY: CSS

CKD BY: MIF

PROJECT NO.

218.011.001

SHEET

11 OF 16

NOTES:

 SEE SHEET M-001 FOR LEGEND, ABBREVIATIONS AND GENERAL NOTES.

2. SCOPE OF WORK REPRESENTED IS TYPICAL

FOR BUILDINGS 21,22,23.

3. CONTRACTOR SHALL FLUSH ALL EXISTING HYDRONIC PIPING AND PROVIDE WATER TREATMENT PER BOILER MANUFACTURER'S INSTRUCTIONS.

BUILDING MANAGEMENT SYSTEM:

1. CONTROLLERS SHALL BE STAND-ALONE AND INSTALLED IN THE BOILER ROOMS.

2. ALARMS SHALL BE LOCAL.

HEATING HOT WATER SYSTEM SEQUENCE OF OPERATIONS

1. WHEN OA TEMPERATURE IS BELOW 68 DEG F AND THERE IS A CALL FOR HEATING AT ONE OR MORE ZONE THERMOSTATS, THE LEAD SPACE HEATING PUMP SHALL BE ENERGIZED AND THE ZONE THERMOSTAT(S) CALLING FOR HEAT SHALL BE OPENED.

2. BOILERS SHALL CASCADE ON AND OFF IN ORDER TO MAINTAIN SUPPLY WATER SETPOINT. BOILER SUPPLY WATER SETPOINT SHALL VARY BASED ON AN OA TEMPERATURE RESET SCHEDULE PROGRAMMED INTO THE BOILER CONTROLLERS. SEE BOILER SPECIFICATION 235216 FOR DETAILS.

3. WHEN THE SPACE TEMPERATURE IS SATISFIED IN A UNIT, THE ASSOCIATED ZONE VALVE SHALL CLOSE.

DOMESTIC HOT WATER SYSTEM SEQUENCE OF OPERATIONS

1. A DIRECT ACTING AQUASTAT SET AT 140 DEGREES F AT THE INDIRECT WATER HEATER STARTS THE BOILER WATER CIRCULATING PUMP SERVING THE INDIRECT HEATER (HWP-#-3) ON A CALL FOR HEATING. THE BOILER TEMPERATURE GOES INTO DOMESTIC PRIORITY WHEN THE AQUASTAT IS CALLING FOR HEATING.

2. THE DOMESTIC HOT WATER CIRCULATION PUMP (DHWP-#-1) SHALL BE ENERGIZED WHEN THE DOMESTIC WATER RETURN PIPE TEMPERATURE REACHES 110 DEG F (ADJUSTABLE) AND SHALL DE-ENERGIZE WHEN THE DHWR TEMPERATURE REACHES 115 DEG F (ADJUSTABLE).

	WALL-MOUNTED CONDENSING BOILER SCHEDULE													
UNIT NO	BLDG NOs (#)	SERVICE	FUEL	INPUT (MBH)	HEATING CAPACITY (MBH)	LWT (°F)	DELTA T (°F)	AFUE (%)	VENT CONNECTION (IN/OUT)	SUPP/RET CONN	GAS CONNECTION	MANUFACTURER AND MODEL	NOTES	
B-#-1	21,22,23	HHW/DHW	NAT GAS	199	185	160	20	95	3"	1 1/2"	1/2"	LOCHINVAR KNIGHT WHN199	1,2	
B-#-2	21,22,23	HHW/DHW	NAT GAS	199	185	160	20	95	3"	1 1/2"	1/2"	LOCHINVAR KNIGHT WHN199	1,2	
	_		•	•	·	•	-							

1. PROVIDE MANUFACTURER'S CONDENSATE NEUTRALIZER.

2. PROVIDE MANUFACTURER'S BACNET COMPATIBLE CONTROLLER.

	EXPANSION TANK SCHEDULE													
UNIT NO	BLDG NOs (#)	SERVICE	TYPE	MIN PRESS (PSIG)	MAX OPER PRESS (PSIG)	TANK VOL (GALS)	TANK ACCEPT VOL (GALS)	DIA (IN)	HEIGHT (IN)	SHIP WEIGHT (LBS)	MANUFACTURER AND MODEL 1	NOTES		
ET-#-1	21,22,23	HHW	BLADDER	40	150	15	10	16	24	64	WATTS DETA-30	1		
ET-#-2	21,22,23	DHW	BLADDER	40	150	3.5	2.1	10	14	22	WATTS DETA-5			

NOTES:

1. PROVIDE 4—INCH HOUSEKEEPING PAD FOR EXPANSION TANK.

INDIRECT-FIRED DOMESTIC WATER HEATER SCHEDULE												
UNIT NO	BLDG NOs (#)	TYPE	TOTAL STORAGE (GAL)	1ST HR RECOVERY (GPH)	BOILER WATER FLOW RATE (GPM)	BOILER FLUID	BOILER EWT (°F)	HEAT EX PD (FT)	STORAGE TEMP (°F)	MANUFACTURER AND MODEL 1	NOTES	
DWH-#-1	21,22,23	STAINLESS STEEL	80	330	12	WATER	180	9.1	140	HTP SUPERSTOR ULTRA SSU-80	1	

NOTES:

1. PROVIDE 4—INCH HOUSEKEEPING PAD FOR WATER HEATER.

	CIRCULATOR PUMP SCHEDULE													
UNIT NO	BLDG NOs (#)	TYPE	FLUID	GPM	HEAD (FT)	MOTOR SIZE	V/PH/HZ	MANUFACTURER AND MODEL (1)	NOTES					
HWP-#-1	21,22,23	HHW	INLINE CIRCULATOR	WATER	30	25	1/2 HP	230/1/60	B&G ECOCIRC XL 55-45	1				
HWP-#-2	21,22,23	HHW	INLINE CIRCULATOR	WATER	30	25	1/2 HP	230/1/60	B&G ECOCIRC XL 55-45	1				
HWP-#-3	21,22,23	DWH	INLINE CIRCULATOR	WATER	12	15	270 WATTS	120/1/60	B&G NRF-45 #103404	2				
DHWP-#-1	21,22,23	DHWR	INLINE CIRCULATOR	WATER	6	8	125 WATTS	120/1/60	B&G NBF-33 #103351LF	3				
BP-#-1	21,22,23	B-1	INLINE CIRCULATOR	WATER	20	50		120/1/60	GRUNDFOS UPS-26-99FC	4				
BP-#-2	21,22,23	B-2	INLINE CIRCULATOR	WATER	20	50		120/1/60	GRUNDFOS UPS-26-99FC	4				

1. PUMP SHALL HAVE ECM DRIVE.

2. PUMP SHALL HAVE A 3—SPEED MOTOR.

21,22,23

3. PUMP SHALL BE BRONZE AND LISTED FOR POTABLE WATER.
4. PUMP SHALL BE SUPPLIED BY BOILER MANUFACTURER.

AIR SEPARATOR SCHEDULE MANUFACTURER BLDG SIZE FLOW (GPM) AND MODEL NOTES NOs SERVICE NO

2-1/2 30 B&G IAS-2-1/2

NOTES:

AS-#-1


NOTES:

1. SEE SHEET M-001 FOR LEGEND, ABBREVIATIONS AND GENERAL NOTES.

2. SCOPE OF WORK REPRESENTED IS TYPICAL FOR BUILDINGS 21,22,23.

KEYED NOTE:

MANUFACTURERS NAME AND MODEL
NUMBER ARE USED FOR DESCRIPTIVE NUMBER ARE USED FOR DESCRIPTIVE PURPOSES ONLY AND ARE INTENDED TO INDICATE THE STANDARD OF MATERIAL OR ARTICLES REQUIRED. DESIGN IS PREDICATED AROUND LISTED MANUFACTURERS AS NOTED ON SCHEDULES AND IS NOT INTENDED TO LIMIT THE CONTRACTOR TO ONE MANUFACTURER.

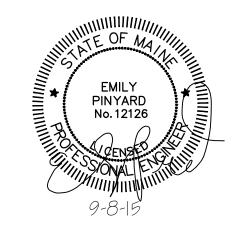

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							HOUSING AUTHORITY ORTLAND, MAINE				
							BOILER REPLACEMENTS				
						BUILDING NOs 21,22,23					
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E - WIRED FOR ELEVATOR RECALL

BT - BEAM TRANSMITTER

CO2 - CARBON DIOXIDE

NO2 - NITROGEN DIOXIDE

BR - BEAM RECEIVER

GAS DETECTOR
CO - CARBON MONOXIDE

LINE TYPES

EXISTING ---- DEMOLITION MATCHLINE -·-·-- PART PLAN OUTLINE

ABBREVIATIONS AMPERE ABOVE FINISHED FLOOR ABOVE FINISHED GRADE AFG AHJ AUTHORITY HAVING JURISDICTION AIC AMPERE INTERRUPTING CAPACITY AMERICAN WIRE GAUGE BELOW FINISHED GRADE BLDG BUILDING BOS BOTTOM OF STEEL CONDUIT CATV CABLE TELEVISION CIRCUIT BREAKER CCTV CLOSED CIRCUIT TELEVISION CPT CONTROL POWER TRANSFORMER CT CURRENT TRANSFORMER COPPER DIGITAL ALARM COMMUNICATOR TRANSMITTER DIRECT BURIED DISCONNECT DOWN ELECTRICAL METALLIC TUBING EMT EWC ELECTRIC WATER COOLER EWH ELECTRIC WATER HEATER EQP EQUIPMENT **EXIST** EXISTING FIRE ALARM ANNUNCIATOR FACP FIRE ALARM CONTROL PANEL FURNISHED BY OTHERS FB0 FLR FLOOR FWE FURNISHED WITH EQUIPMENT FUSE GROUND GENERATOR GROUND FAULT CIRCUIT INTERRUPT CEILING GROUND

FU GEN **GFCI** CLG GND HP HORSEPOWER HEATER ISOLATED GROUND IG INTERMEDIATE METAL CONDUIT

KILO THOUSAND CIRCULAR MILS

KILOVOLT-AMPERE KVAR KILOVOLT-AMPERE REACTIVE KILOWATT KILOWATT-HOUR KWH LA LIGHTNING ARRESTER

KILOVOLT

ΚV

NC

PVC

TOS

TANSF

LIGHTING METAL CLAD MAIN CIRCUIT BREAKER MANUFACTURER MINERAL INSULATED

MAIN LUG ONLY MNS MASS NOTIFICATION SYSTEM MOUNTED MV MEDIUM VOLTAGE

NORMALLY CLOSED

NATIONAL ELECTRICAL CODE NEG NEGATIVE NEUT NEUTRAL NOT IN CONTRACT NO NORMALLY OPEN NOT TO SCALE POWER FACTOR PF PHASE

RMROOM RSC RIGID STEEL CONDUIT RTD RESISTANCE TEMPERATURE DETECTOR SN SOLID NEUTRAL

POLYVINYL CHLORIDE

SPD SURGE PROTECTIVE DEVICE STP SHIELDED TWISTED PAIR STT SHIELDED TWISTED TRIPLET SWITCHBOARD SWBD **SWGR** SWITCHGEAR

TOP OF STEEL

TRANSFORMER

VOLT-AMPERE VOLT-AMPERE REACTIVE WATT METER WEATHER PROOF WP XFMR TRANSFORMER EXPLOSION PROOF

GENERAL NOTES

- ALL GENERAL NOTES, SYMBOL LISTS AND DETAILS ARE TO BE CONSIDERED AS APPLICABLE TO ALL ELECTRICAL DRAWINGS FOR THIS PROJECT. SYMBOLS AND ABBREVIATIONS SHOWN ON THIS SHEET ARE FOR REFERENCE ONLY AND DO NOT INDICATE THEIR INCORPORATION IN THE DESIGN.
- 2. ALL WORK SHALL BE PERFORMED IN ACCORDANCE WITH NFPA-70, NATIONAL ELECTRICAL CODE (NEC) 2014.
- 3. REMOVE ALL ELECTRICAL EQUIPMENT COMPLETELY WHERE INDICATED. REMOVE ALL CIRCUIT CONDUCTORS, SWITCHES, LIGHTING FIXTURES AND MISCELLANEOUS APPLIANCES BACK TO ENERGIZING SOURCE OR JUNCTION BOX WHERE MULTIPLE EQUIPMENT IS POWERED.
- 4. ALL CONDUCTOR MATERIAL, INCLUDING WIRING, PANELBOARD BUSES, TRANSFORMER WINDINGS, AND GROUNDING SHALL BE COPPER. ALUMINUM CONDUCTORS SHALL NOT BE ALLOWED.
- 5. UNLESS OTHERWISE NOTED, WIRING SHALL BE 2#12 AWG CONDUCTORS AND #12 GND. HOME RUNS FED FROM 20A-1P CIRCUITS IN EXCESS OF 100 FEET SHALL BE #10 AWG.
- 6. LIGHTING TOGGLE SWITCHES SHALL BE COMMERCIAL SPECIFICATION GRADE 277/120 VOLT, SIDE WIRED AND PROVIDED WITH GROUNDING SCREW. LEVITON, PASS AND SEYMOUR OR APPROVED EQUAL. COORDINATE COLOR WITH OWNER.
- CONVENIENCE RECEPTACLES SHALL BE COMMERCIAL SPECIFICATION GRADE GROUNDING TYPE NEMA 5-20R, SIDE WIRED. LEVITON, PASS AND SEYMOUR OR APPROVED EQUAL.
- ALL EQUIPMENT DISCONNECTS AND MANUAL MOTOR STARTERS ARE PROVIDED BY ELECTRICAL CONTRACTOR UNLESS NOTED AS FURNISHED WITH EQUIPMENT (FWE). MOUNT ALL DISCONNECTS AND MOTOR STARTERS IN AN ACCESSIBLE LOCATION WITHIN SIGHT OF THE LOAD SERVED.
- 9. UNLESS OTHERWISE NOTED CONVENIENCE RECEPTACLES SHALL BE MOUNTED 18-INCHES AFF AND LIGHTING TOGGLE SWITCHES 48-INCHES AFF.
- 10. ALL PENETRATIONS THROUGH FLOORS, RATED WALLS AND PARTITIONS SHALL BE SEALED WITH UL APPROVED FIRE SEALANT MATERIAL TO MAINTAIN THE RATING OF SEPARATION.
- EQUIPMENT CONNECTIONS ARE SHOWN FOR BASIS-OF-DESIGN PRODUCTS. CONTRACTOR SHALL COORDINATE ALL EQUIPMENT CONNECTIONS - INCLUDING DISCONNECTING MEANS, OVERCURRENT PROTECTION, AND WIRE SIZING - WITH SELECTED MANUFACTURER'S RECOMMENDED INSTRUCTIONS.
- 12. CONTRACTOR SHALL PROVIDE ALL MOUNTING HARDWARE NECESSARY FOR A COMPLETE INSTALLATION. MOUNT EQUIPMENT AND ROUTE CONDUIT SO AS NOT TO INTERFERE WITH OPERATIONS SUCH AS OVERHEAD DOORS, DOOR SWINGS, ETC.
- 13. MANUFACTURERS NAME AND MODEL NUMBERS ARE USED THROUGHOUT THE PROJECT FOR DESCRIPTIVE PURPOSES ONLY AND ARE INTENDED TO INDICATE THE STANDARD OF MATERIAL OR ARTICLES REQUIRED. DESIGN IS PREDICATED AROUND LISTED MANUFACTURERS AS NOTED ON SCHEDULES AND NOTES AND IS NOT INTENDED TO LIMIT THE CONTRACTOR TO ONE MANUFACTURER.

LOADCENTER REPLACEMENT SCOPE

- 1. ALL EXISTING FEDERAL PACIFIC LOADCENTERS ARE TO BE REPLACED. EXISTING FEDERAL PACIFIC LOADCENTERS ARE MODEL NUMBER LX108-16.
- NEW LOADCENTERS SHALL BE HOMELINE HOM12L125GC OR APPROVED EQUAL.
- 3. ALL APARTMENTS UNLESS OTHERWISE NOTED BELOW HAVE A FEDERAL PACIFIC LOADCENTER THAT SHALL BE REPLACED. THE FOLLOWING APARTMENTS DO NOT REQUIRE A REPLACEMENT LOADCENTER:
 - BUILDING 21 UNIT A
 - BUILDING 22 UNIT D BUILDING 23 — UNIT E

JASON M. BEAULIEU

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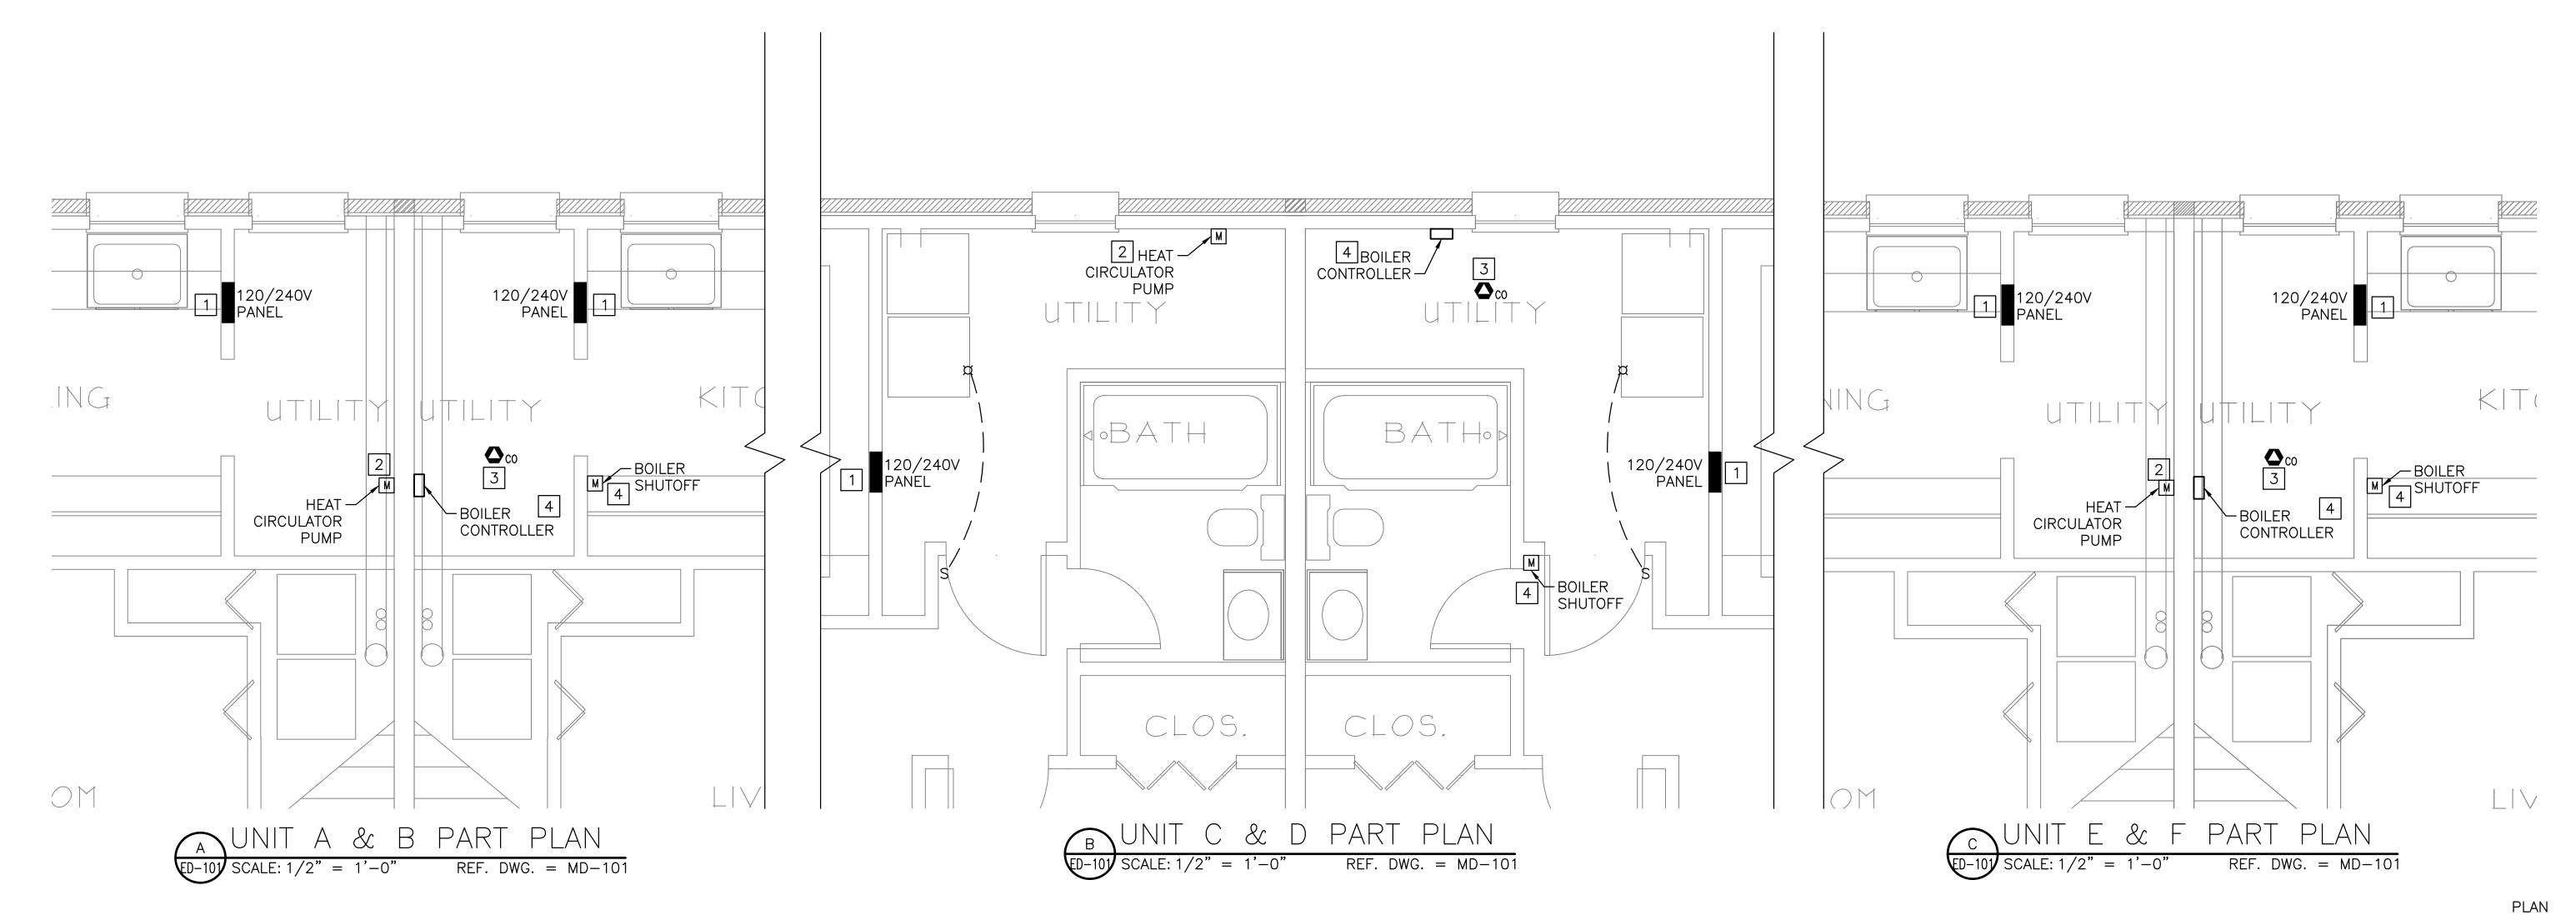
0 I ISSUED FOR CONSTRUCTION JMB | MRL | 9-8-15 GENERAL NOTES DWN APP DATE DESCRIPTION ANSI D PROJECT NO. DRAWING NO. SIZE: 47A York Street DATE: 9-8-15 218.011.001 Portland, Maine 04101 DES BY: JMB 207.553.7753 SHEET Colby Company DWN BY: JMB colbycoengineering.com 13 OF 16 engineering CKD BY: BCT

PORTLAND, MAINE RIVERTON BOILER REPLACEMENTS **BUILDING NOs 21.22.23** ELECTRICAL LEGEND, ABBREVIATIONS AND


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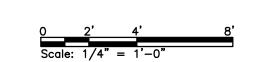
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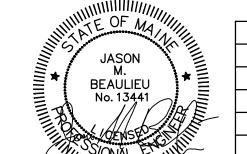
- SEE SHEET E-001 FOR LEGEND, ABBREVIATIONS, AND GENERAL NOTES.
- 2. SCOPE OF WORK REPRESENTED IS TYPICAL FOR BUILDINGS 21,22,23.
- 3. HEATING SYSTEM CIRCUITS ARE FED FROM "HOUSE" PANEL, LOCATED ON EXTERIOR OF BUILDING NEAR METER BANK. METER BANK LOCATION VARIES FROM BUILDING TO BUILDING. GENERALLY, METER BANK IS LOCATED AT NORTH WEST OR NORTH EAST CORNER OF BUILDING.
- **DEMOLITION KEYED NOTES:**
- 1 REPLACE ALL FEDERAL PACIFIC PANELBAORDS.
 REFER TO SHEET E-601 FOR PANELBOARD
 REPLACEMENT SCHEDULE.
- 2 REMOVE CIRCULATION PUMP MANUAL MOTOR STARTER AND CIRCULATION PUMP CIRCUIT COMPLETELY BACK TO ENERGIZING SOURCE.
- 3 REMOVE CARBON MONOXIDE DETECTOR.
- 4 REMOVE BOILER CIRCUIT AND ALL ASSOCIATED EQUIPMENT COMPLETELY BACK TO ENERGIZING SOURCE.



PLANS REPRESENT A TYPICAL BUILDING CONFIGURATION. NOT ALL BUILDINGS ARE COMPLETELY IDENTICAL. FIELD VERIFY ALL CONDITIONS PRIOR TO PERFORMING ANY WORK.





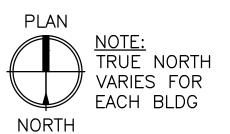

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REV	DESCRIPTION	DWN	APP	DATE	

RIVERTON BOILER REPLACEMENTS
BUILDING NOs 21,22,23

ELECTRICAL DEMOLITION PLAN


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PORTLAND, MAINE



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ED-101



KEY PLAN

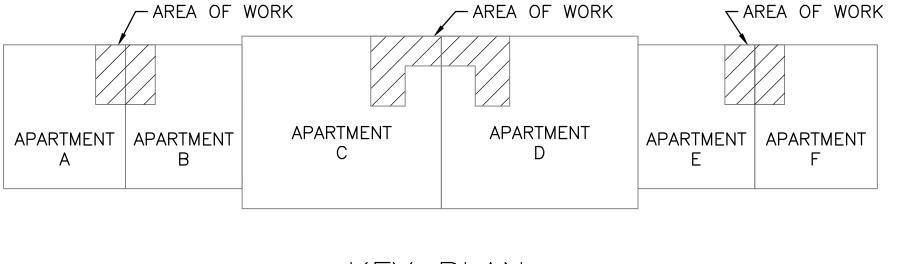SCALE: NTS

NOTES:

- 1. SEE SHEET E-001 FOR LEGEND, ABBREVIATIONS, AND GENERAL NOTES.
- 2. SCOPE OF WORK REPRESENTED IS TYPICAL FOR BUILDINGS 21,22,23.
- 3. HOUSE PANELBOARD LOCATED ON EXTERIOR OF BUILDING NEAR METER BANK. METER BANK LOCATION VARIES FROM BUILDING TO BUILDING. GENERALLY, METER BANK IS LOCATED AT NORTH WEST OR NORTH EAST CORNER OF BUILDING. ROUTE NEW CONDUIT ON EXTERIOR OF BUILDING.

KEYED NOTES:

- 1 PROVIDE NEW UTILITY LIGHT FIXTURE AND CONVENIENCE RECEPTACLE. PROVIDE 120V 20A-1P CIRCUIT FROM SPACE IN HOUSE PANELBOARD FOR LIGHT AND RECEPTACLE.
- PROVIDE 120V 20A-1P CIRCUIT FROM A SPARE IN HOUSE PANELBOARD FOR EACH BOILER AND BOILER PUMP PAIR. PROVIDE BOILER SHUT OFF SWITCH FOR EACH BOILER ON WALL NEAR EXIT. PROVIDE TOGGLE SWITCH DISCONNECT FOR BOILER PUMP.
- PROVIDE POWER TO BOILER PUMPS THROUGH BOILER INTEGRATED CONTROL PANEL.

KEYED NOTES CONTINUED:

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9-8-15

PROJECT NO.

218.011.001

15 OF 16

SIZE:

DATE:

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Portland, Maine 04101 207.553.7753

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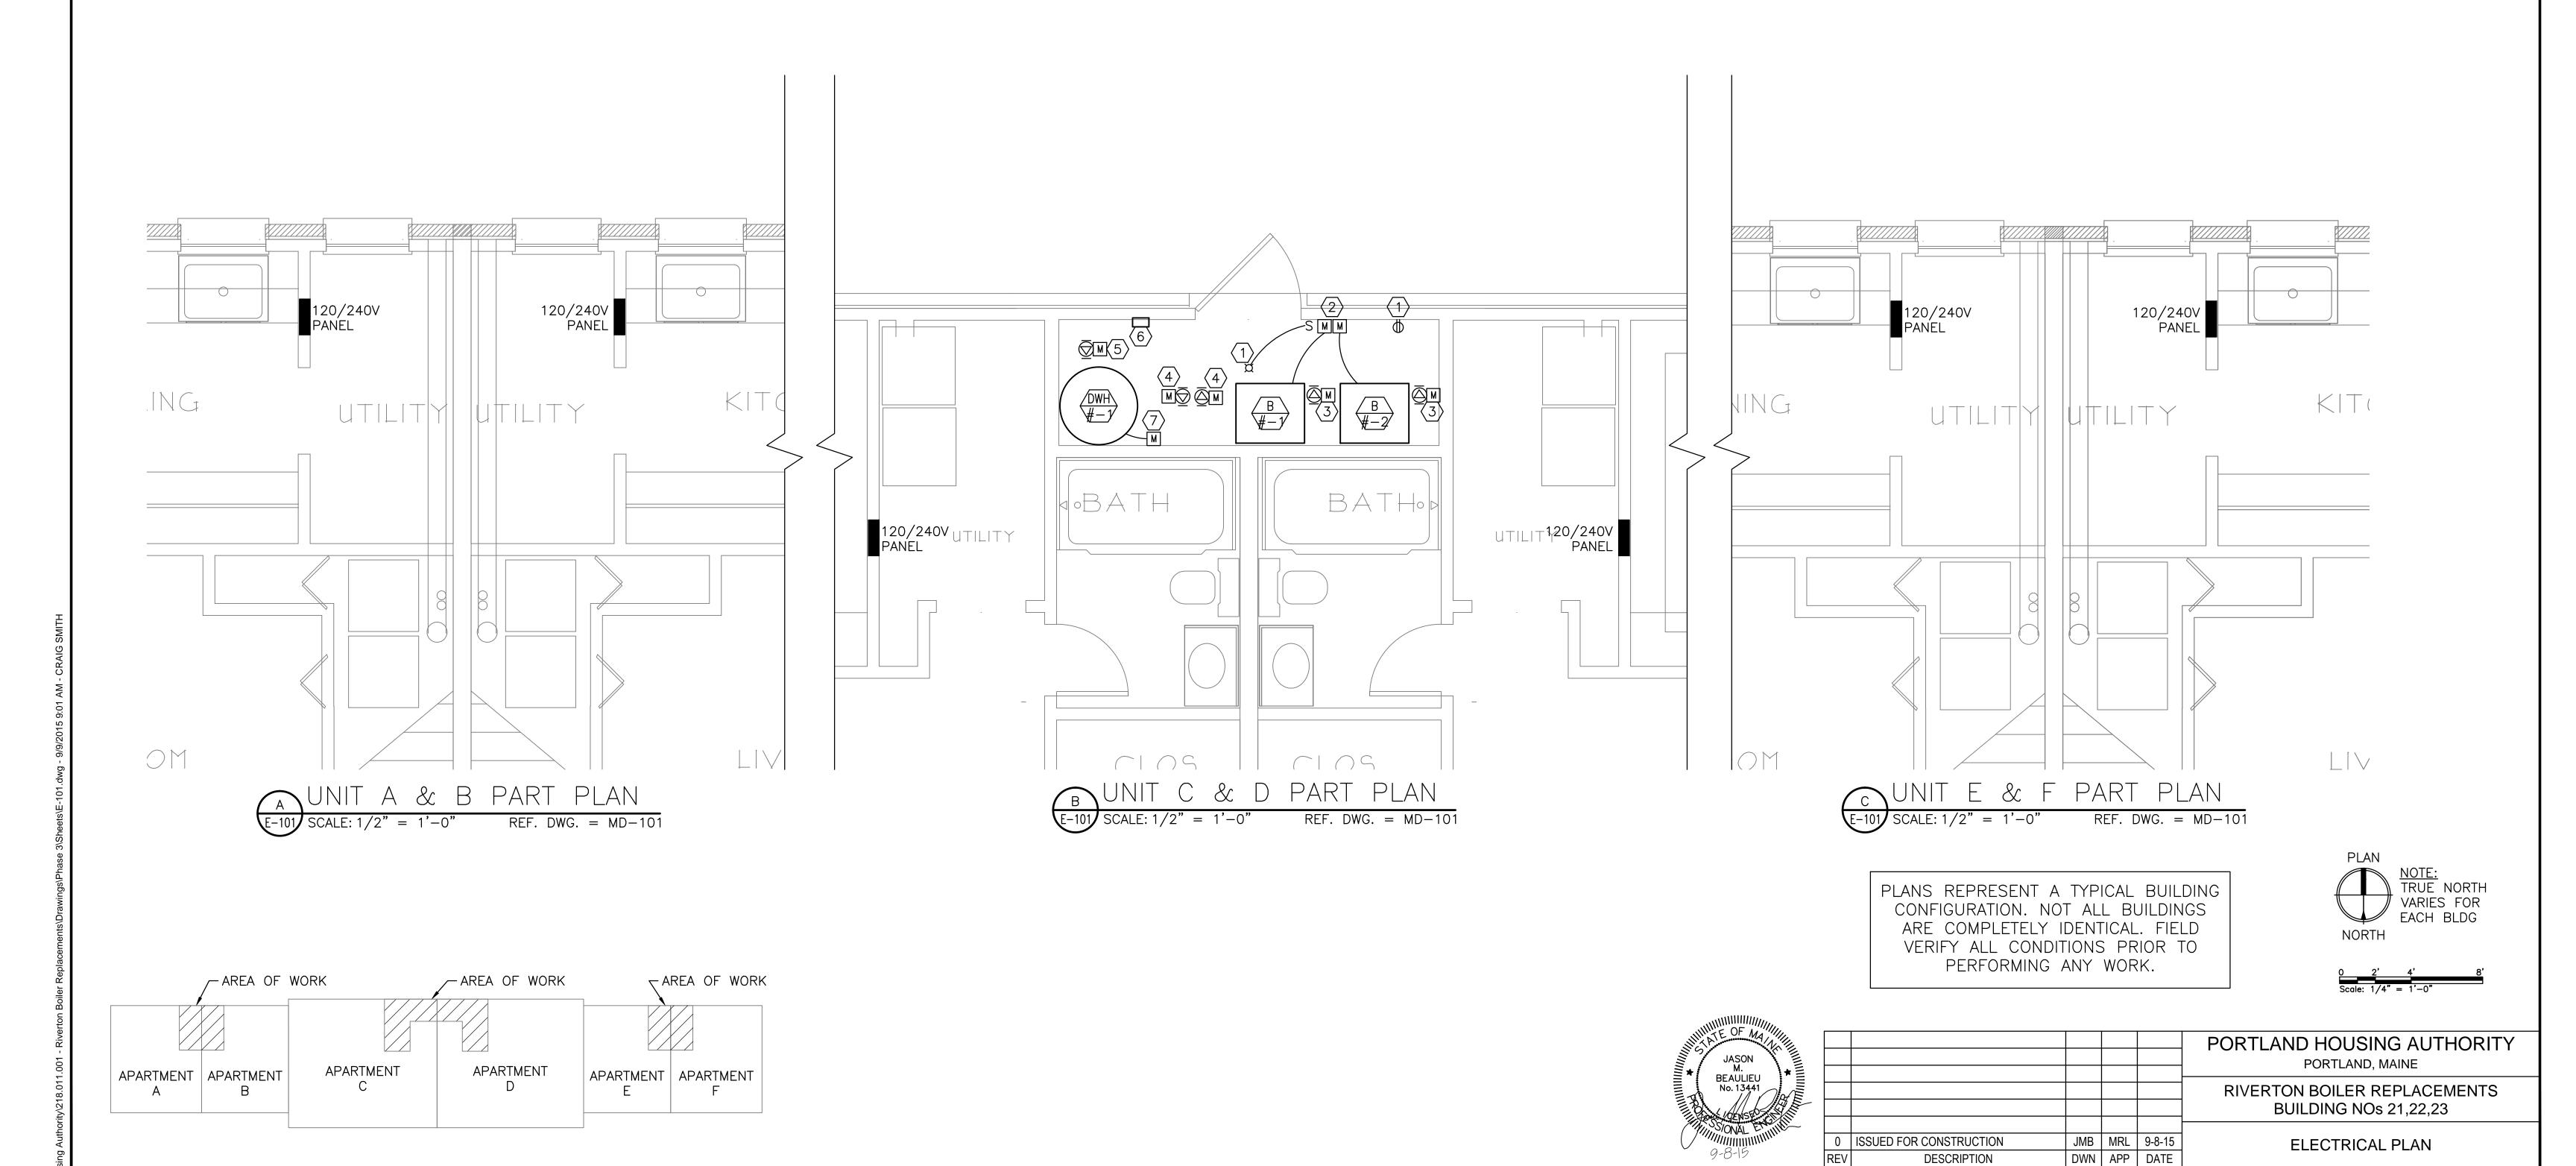
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E-101

- 4 PROVIDE 240V 20A-2P CIRCUIT FROM SPACE IN HOUSE PANELBOARD FOR HEATING HOT WATER CIRCULATOR PUMPS. PROVIDE TOGGLE SWITCH DISCONNECT FOR EACH PUMP.
- 5 PROVIDE 120V 20A-1P CIRCUIT FROM SPACE IN HOUSE PANELBOARD FOR DOMESTIC HOT WATER CIRCULATOR PUMP. PROVIDE TOGGLE SWITCH DISCONNECT.
- 6 PROVIDE 120V 20A-1P CIRCUIT FROM SPACE IN HOUSE PANELBOARD FOR ZONE CONTROLLERS.
- 7 PROVIDE 120V 20A-1P CIRCUIT FROM A SPARE IN HOUSE PANELBOARD FOR DOMESTIC WATER HEATER.



PANELBOARD NO:	TYPICAL PANEL	SC RATING:	10 KAIC	
PANELBOARD TYPE:	HOMELINE LOAD CENTER HOM12L125GC	MOUNTING:	FLUSH	125 AMP MAIN LUGS
PANEL LOCATION:	SEE PLANS	VOLTAGE:	120/240V, SINGLE PHASE	125 AMP BUS

CKT NO.	TRIP AMPS	NO. POLES	WIRE / CONDUIT	GND. WIRE	LOAD SERVED	LOAD VA	ф	LOAD VA	LOAD SERVED	WIRE / CONDUIT	GND. WIRE	NO. POLES	TRIP AMPS	
1	20	1	1	_	KITCHEN COUNTER OUTLETS (NOTE 1)		Α		LIGHTS (NOTE 1)	_	_	1	15	2
3	20	1	1	_	KITCHEN COUNTER OUTLETS (NOTE 1)		В		KITCHEN LIGHTS (NOTE 1)	_	_	1	15	4
5	20	1	_	_	LIVING ROOM OUTLETS (NOTE 1)		Α		CLOTHES WASHER (NOTE 1)	_	_	1	20	6
7	20	1	_	_	LAUNDRY OUTLETS (NOTE 1)		В		DRYER	_		2	30	8
9	15	1	_	_	UPSTAIRS BEDROOM AND BATH (NOTE 1)		Α							10
11							В							12

1. PROVIDE ARC-FAULT CIRCUIT-INTERRUPTER CIRCUIT BREAKER.

2. ALL LOADS SHOWN ARE EXISTING LOADS TO BE RECONNECTED.

TYPICAL PANEL SCHEDULE

SCALE: NTS

JASON M. BEAULIEU No. 13441

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PORTLAND HOUSING AUTHORITY

PORTLAND, MAINE