



- FRAMING NOTES:
- INDICATES SPAN DIRECTION OF 1/2" - 20GA VLI COMPOSITE FLOOR DECK FOR 5" CONCRETE SLAB (TOTAL SLAB DEPTH = 5"). HILTI X-ENP-19 PINS IN 3/4" PATTERN, (3) #10 TEK SIDELAP SCREW PER SPAN. SLAB REINFORCING TO BE 6X6 W1.4XW1.4 WWF. FINISHED TOP OF SLAB (+14'-6" VIF - MATCH EXISTING). PRIME AND PAINT UNDERSIDE OF DECK.
  - MEZZ TOS (+14'-1") INDICATES TOP OF BEARING STEEL REFERENCED FROM FIN. FIRST FLOOR ELEVATION 0'-0" = (03.5'). TOP OF BEARING STEEL DESIGNATED AT COLUMN CENTERLINE TYPICAL UNLESS NOTED OTHERWISE (UNO). CONTRACTOR VERIFY TOSLBS AT EXISTING MEZZANINE - TOSLBS AT NEW MEZZANINE IS TO MATCH EXISTING. NOTIFY ENGINEER AND ADJUST TOP OF MEZZANINE STEEL IF NECESSARY.
  - EDGE OF DECK TO BE EXTERIOR EDGE OF PERIMETER BEAM FLANGE, TYP UNO.
  - INDICATES BEAM TO COLUMN MOMENT CONNECTION, SEE DET. B4/S4.
  - UNO INDICATES "UNLESS NOTED OTHERWISE"
  - ALL WOOD IN CONTACT WITH CONCRETE TO BE PRESSURE TREATED.
  - ALL FASTENERS IN PT LUMBER TO BE HOT DIPPED G90 GALVANIZED.
  - ALL STRUCTURAL STEEL TO BE PRIMED (GREY) AND PREPPED FOR PAINT. SEE SPECS FOR PAINTING REQUIREMENTS.

- PLATFORM/STAIR NOTES:
- HANDRAILS AND STAIR TREADS / RISERS TO MEET OSHA AND IBC 2009 STANDARDS.
  - SUBMIT PE STAMPED SHOP DRAWINGS OF PLATFORM AND STAIR CONSTRUCTION, CONNECTION DESIGN BY FABRICATOR, UNO.
  - DESIGN FLOOR LIVE LOAD = 100 PSF
  - SEE ARCH A11 FOR HANDRAIL/GUARDRAIL DETAILS.
  - STEEL FABRICATOR MAY PROPOSE ALTERNATE DESIGN FOR STAIR STRINGERS, BEAMS, COLUMNS, CONNECTIONS ETC.

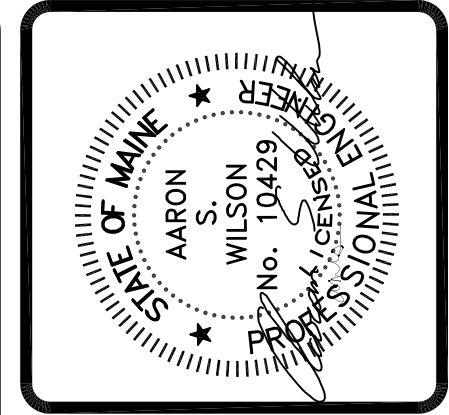

B3 CORNER REINFORCING IN FOOTING AND WALL  
SCALE: 1" = 1'-0"


A4 SLAB AT EXTERIOR DOORS  
SCALE: NO SCALE

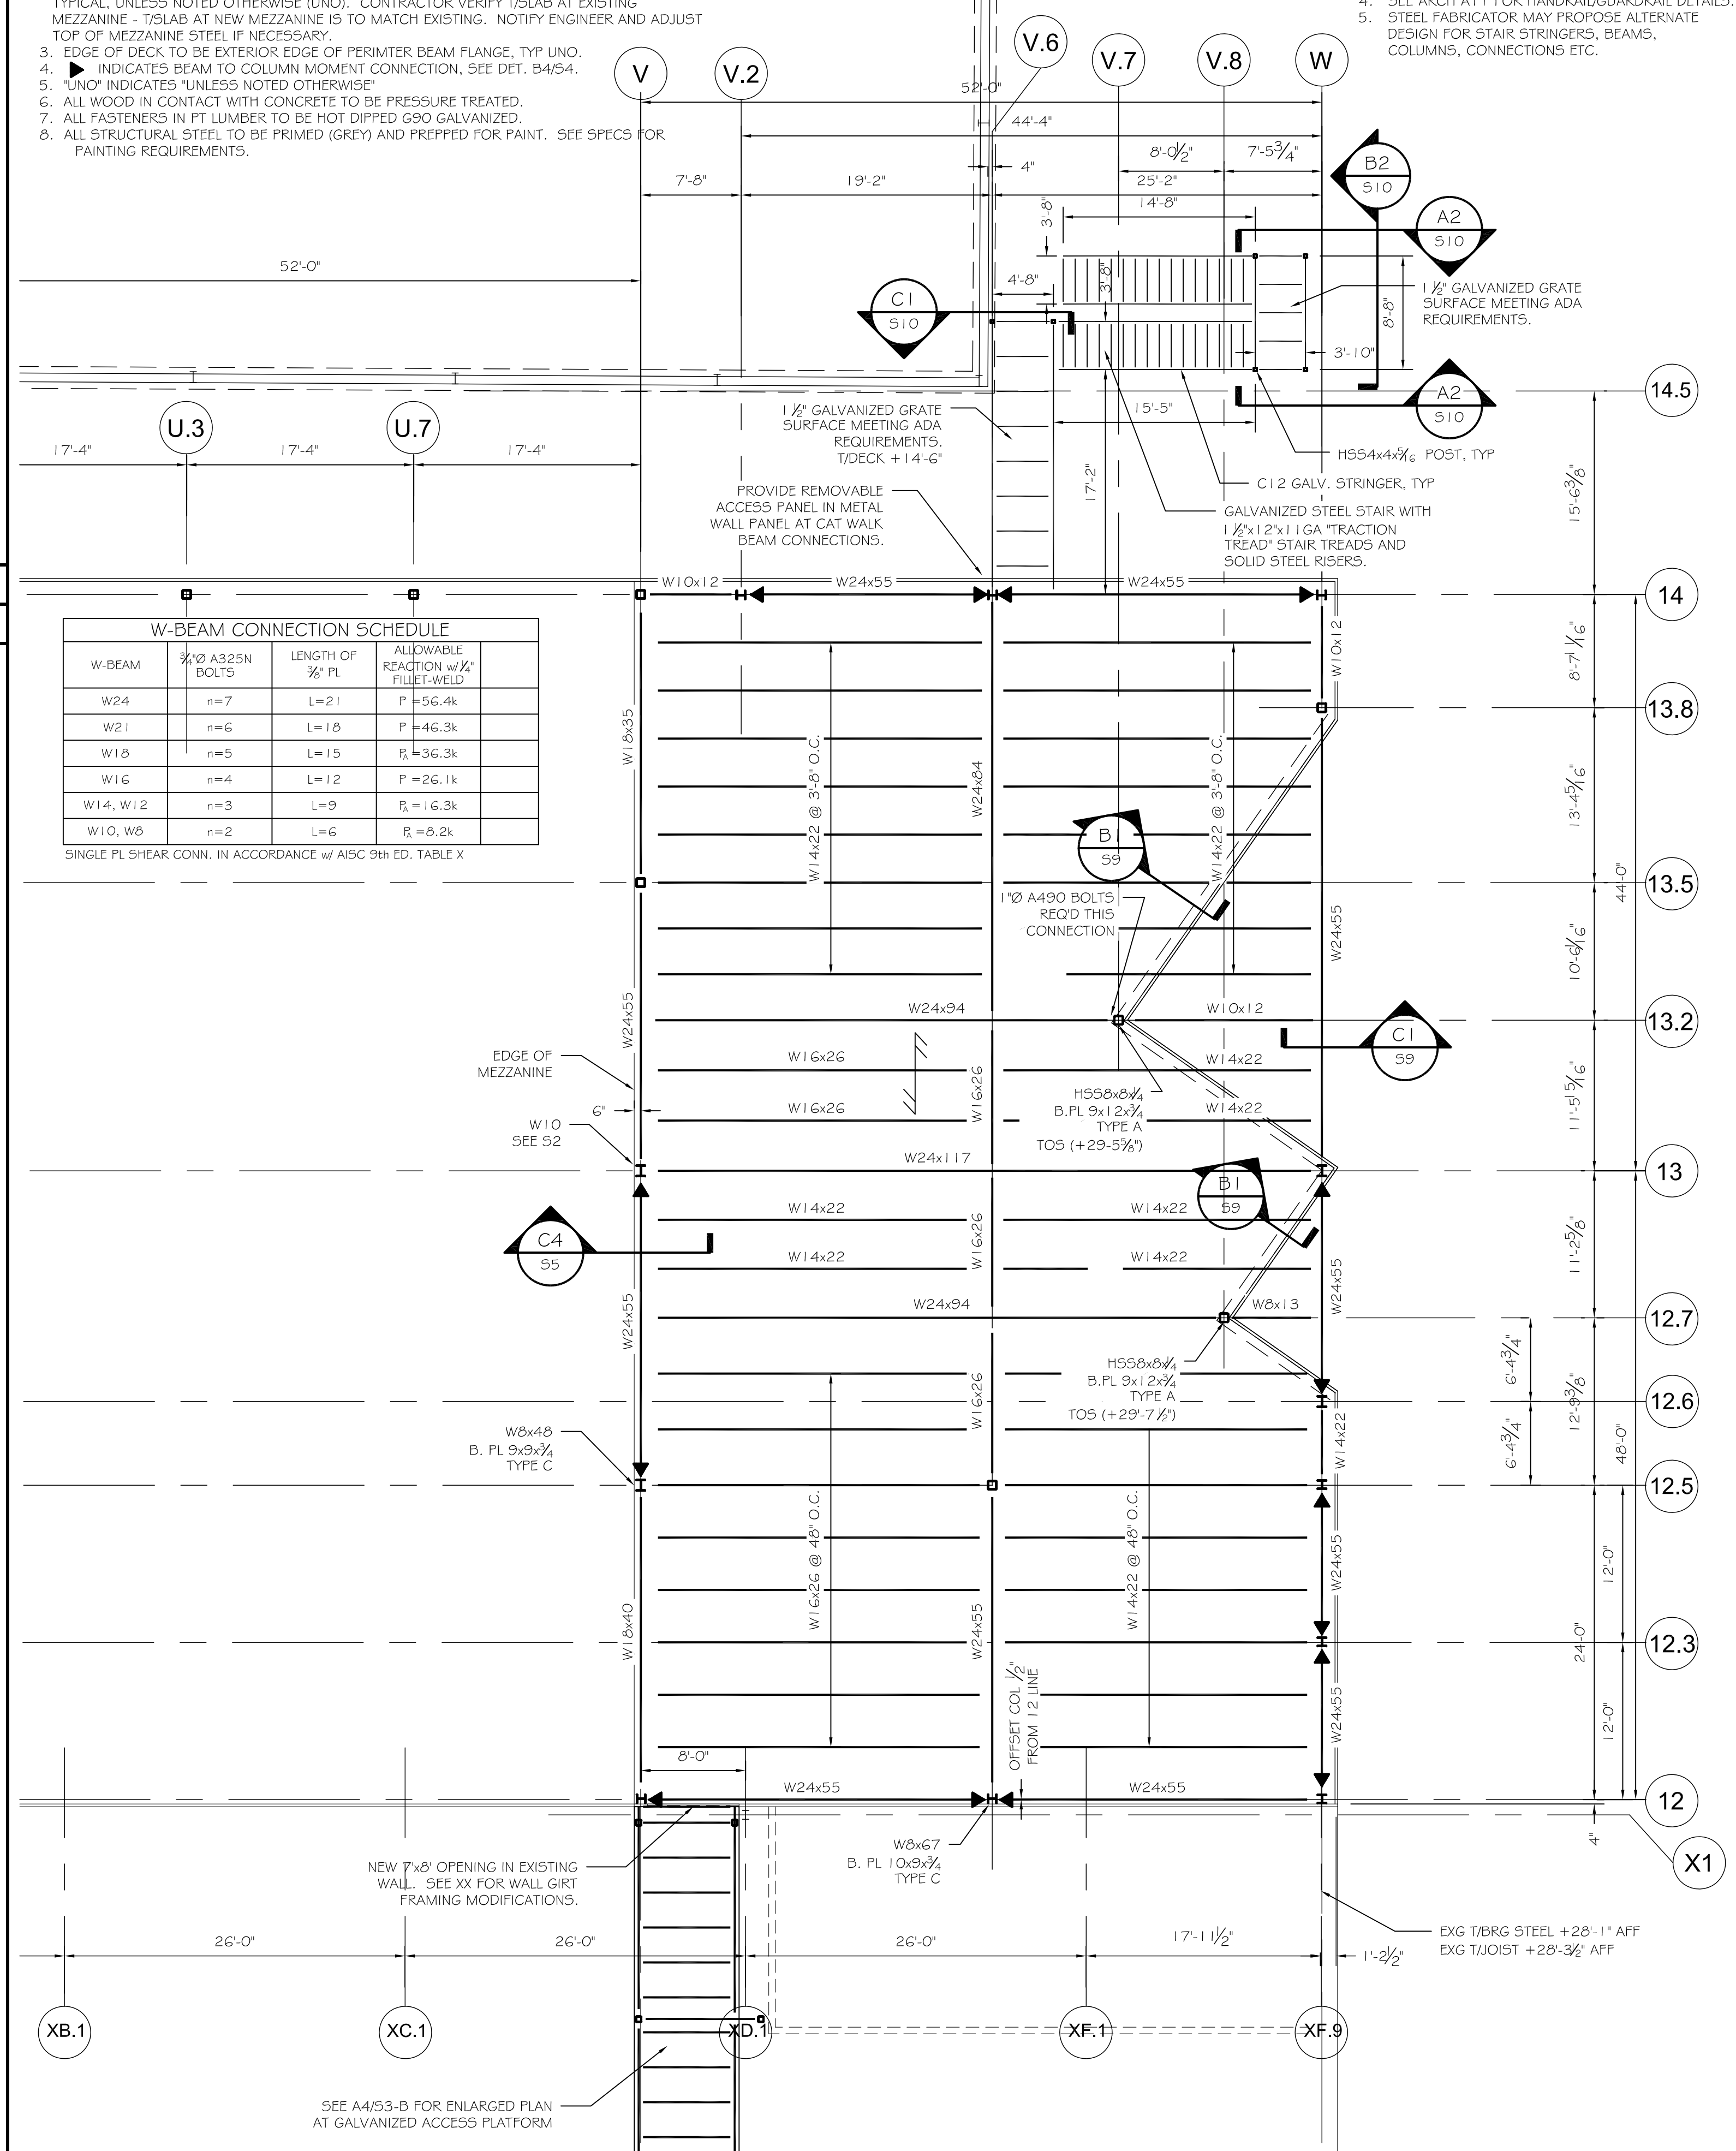

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PROJECT: **ALLAGASH 2015 EXPANSION**  
100 INDUSTRIAL WAY, PORTLAND, MAINE  
FOR: ALLAGASH BREWING CO.  
SHEET TITLE: **MEZZANINE FRAMING PLAN**  
ISSUED FOR PERMITTING



- PLATFORM/STAIR NOTES:
- EXG. SLAB SLOPES, FIELD VERIFY ALL REQUIRED COLUMN LENGTHS.
  - HANDRAILS AND STAIR TREADS / RISERS TO MEET OSHA AND IBC 2009 STANDARDS.
  - SUBMIT PE STAMPED SHOP DRAWINGS OF PLATFORM AND STAIR CONSTRUCTION, CONNECTION DESIGN BY FABRICATOR.
  - DESIGN FLOOR LIVE LOAD = 100 PSF.
  - SEE ARCH A11 FOR HANDRAIL/GUARDRAIL DETAILS.
  - STEEL FABRICATOR MAY PROPOSE ALTERNATE DESIGN FOR STAIR STRINGERS, BEAMS, COLUMNS, CONNECTIONS ETC.

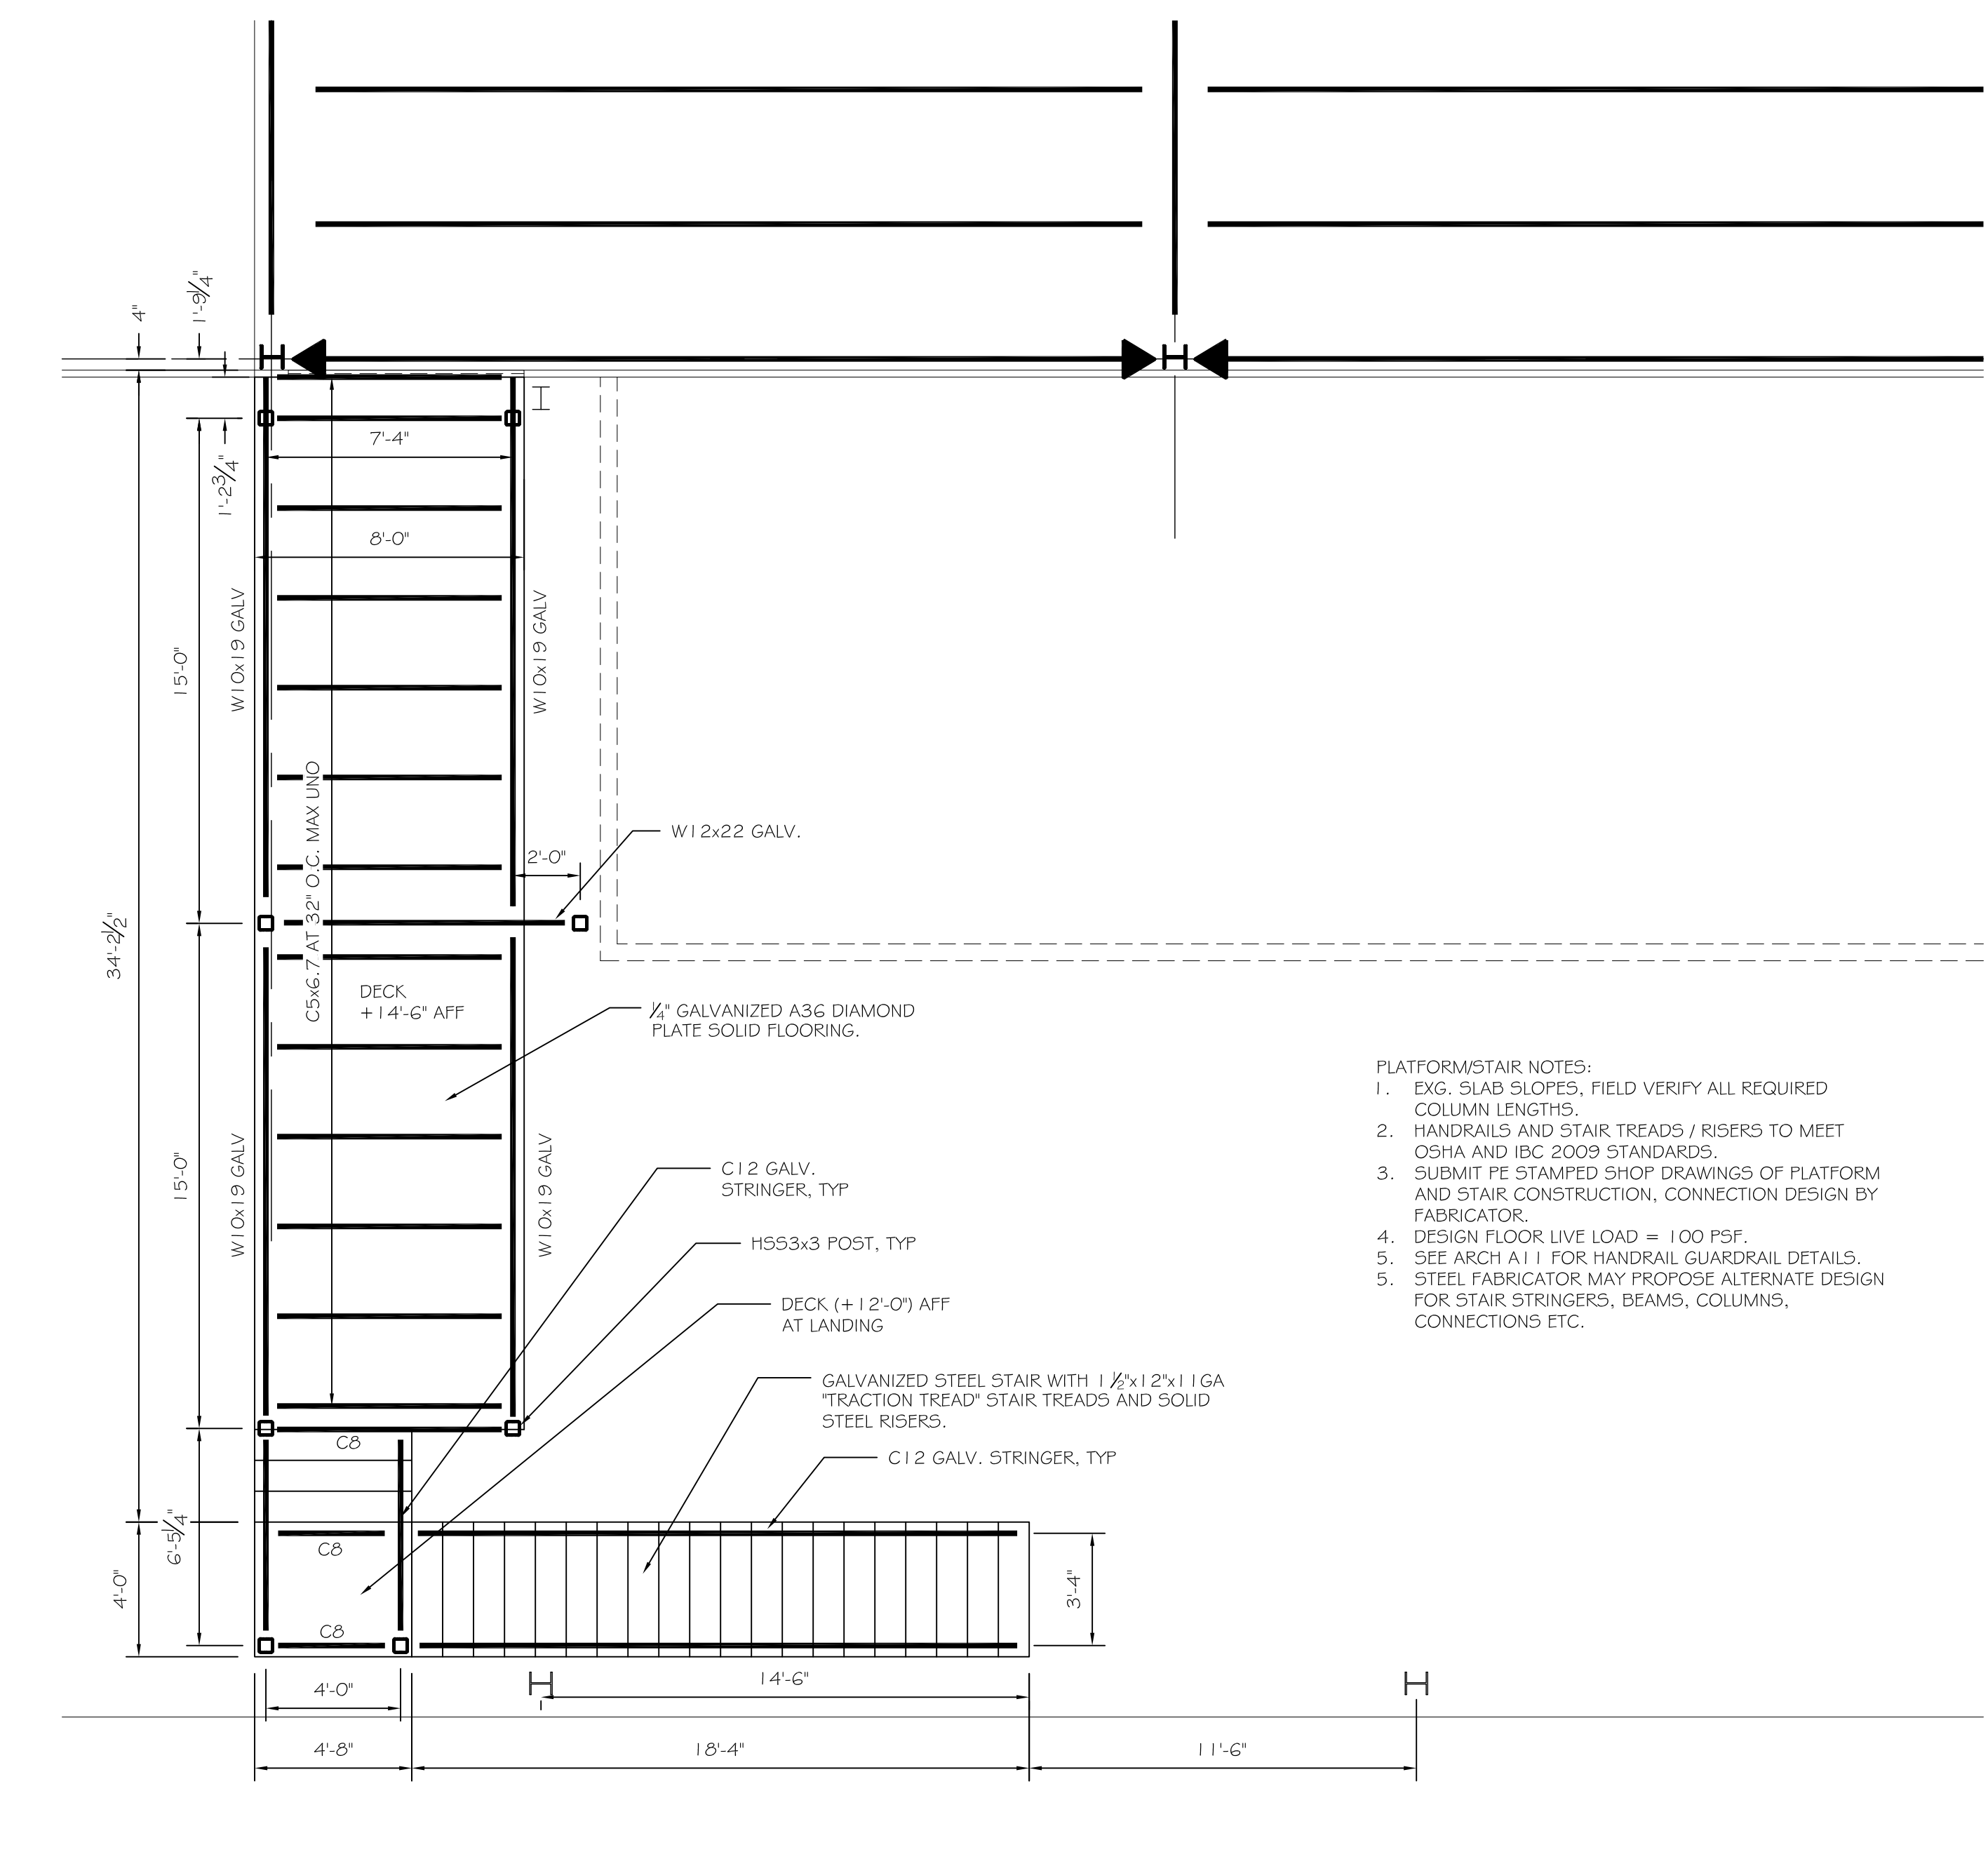A4 GALVANIZED ACCESS PLATFORM  
SCALE: 1/4" = 1'-0"

A2 MEZZANINE FRAMING PLAN  
SCALE: 1/8" = 1'-0"

NO.	BY	DATE	DESCRIPTION

DATE : 7/25/14  
SCALE : AS NOTED  
DESIGN BY: ASW  
DRAWN BY: RSC  
FILE #: 12160-S1  
PROJECT NUMBER:  
**12160**  
SHEET NO:  
**53**