


C4 BRACE DETAIL
SCALE: 1" = 1'-0"


C3 BRACE DETAIL
SCALE: 1" = 1'-0"

C2 SIDE ELEVATION
SCALE: 1/4" = 1'-0"


- FRAMING NOTES:
- INDICATES SPAN DIRECTION OF 22GA FIRESTONE VR CLASSIC OMEGA CORRUGATED STEEL ROOFING. MIN F_y=30KSI STEEL. GALVANIZED WITH KYNAR 500 / HYNAR 5000 FLUOROCARBON. FASTEN ROOFING TO TIMBERS WITH #9-15x2" TRUE GRIP GT METAL TO WOOD FASTENERS BY ITW BUILDUP AT 3/4" PATTERN (EVERY RIB- 7.2' O.C.). PROVIDE #1 2X3/4" TRUE GRIP GT SIDELAP SCREWS AT 24" O.C. AT PANEL LAP SEAMS. ALL SCREWS TO HAVE GASKETED BONDED WASHERS AND HEX WASHER HEAD AND BE COATED OR GALVANIZED FOR EXTERIOR USE. FASTENER HEAD COLOR TO MATCH PANEL AS CLOSE AS POSSIBLE (GREY/SILVER). ALL DIMENSIONS NOTED +/- TO BE FIELD VERIFIED BY CONTRACTOR PRIOR TO CONSTRUCTION.
 - ALL FASTENERS IN FT LUMBER TO BE HOT DIPPED G90 GALVANIZED.
 - GENERAL CONTRACTOR TO COMPLY WITH IBC 2009 TABLE 2304.9.1 FASTENING SCHEDULE.
 - ALL STRUCTURAL HEAVY TIMBER MEMBERS TO BE DOUGLAS FIR #1 OR BETTER.
 - ALL TIMBER POSTS TO HAVE SIMPSON CP57 HOLD DOWNS, SEE C1/S1.

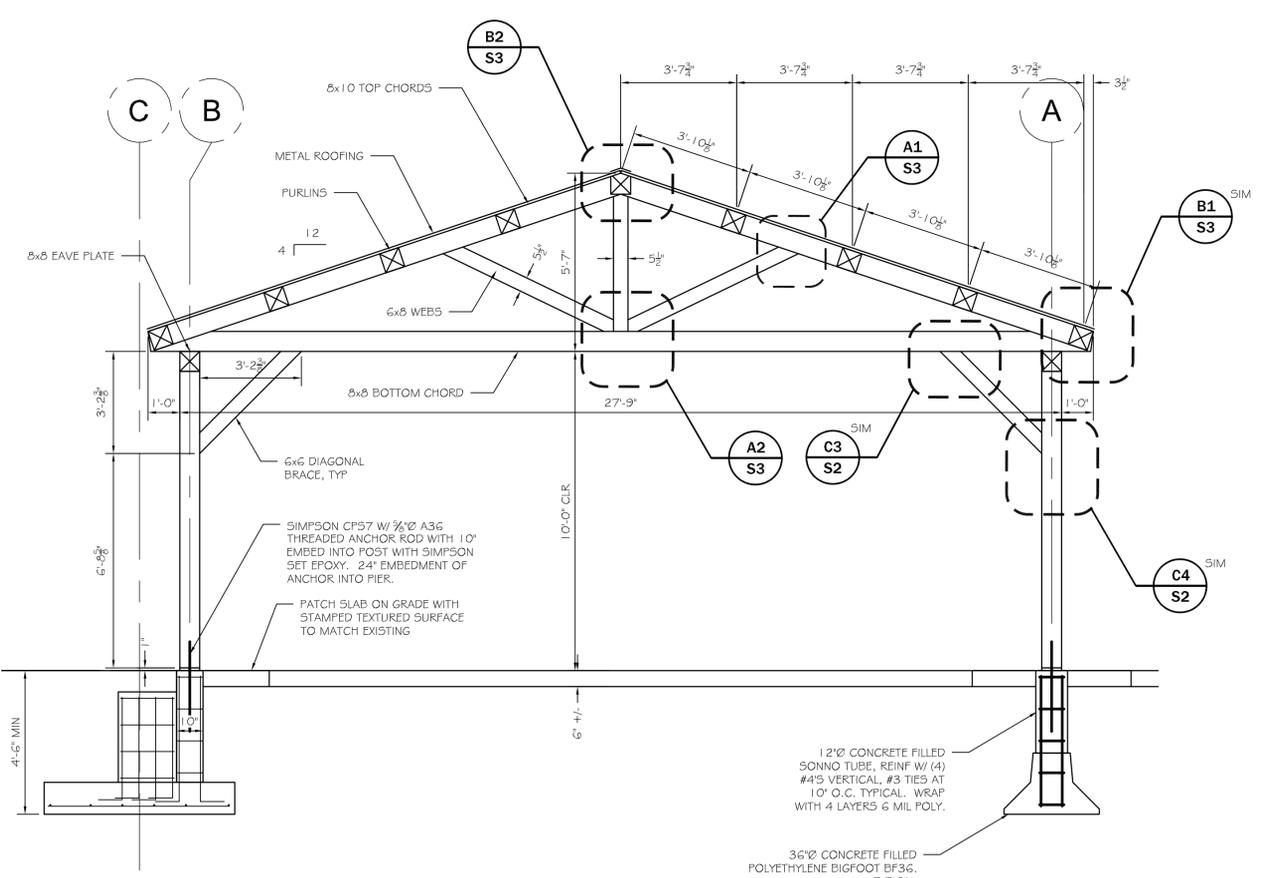

A4 CROSS SECTION
SCALE: 3/8" = 1'-0"

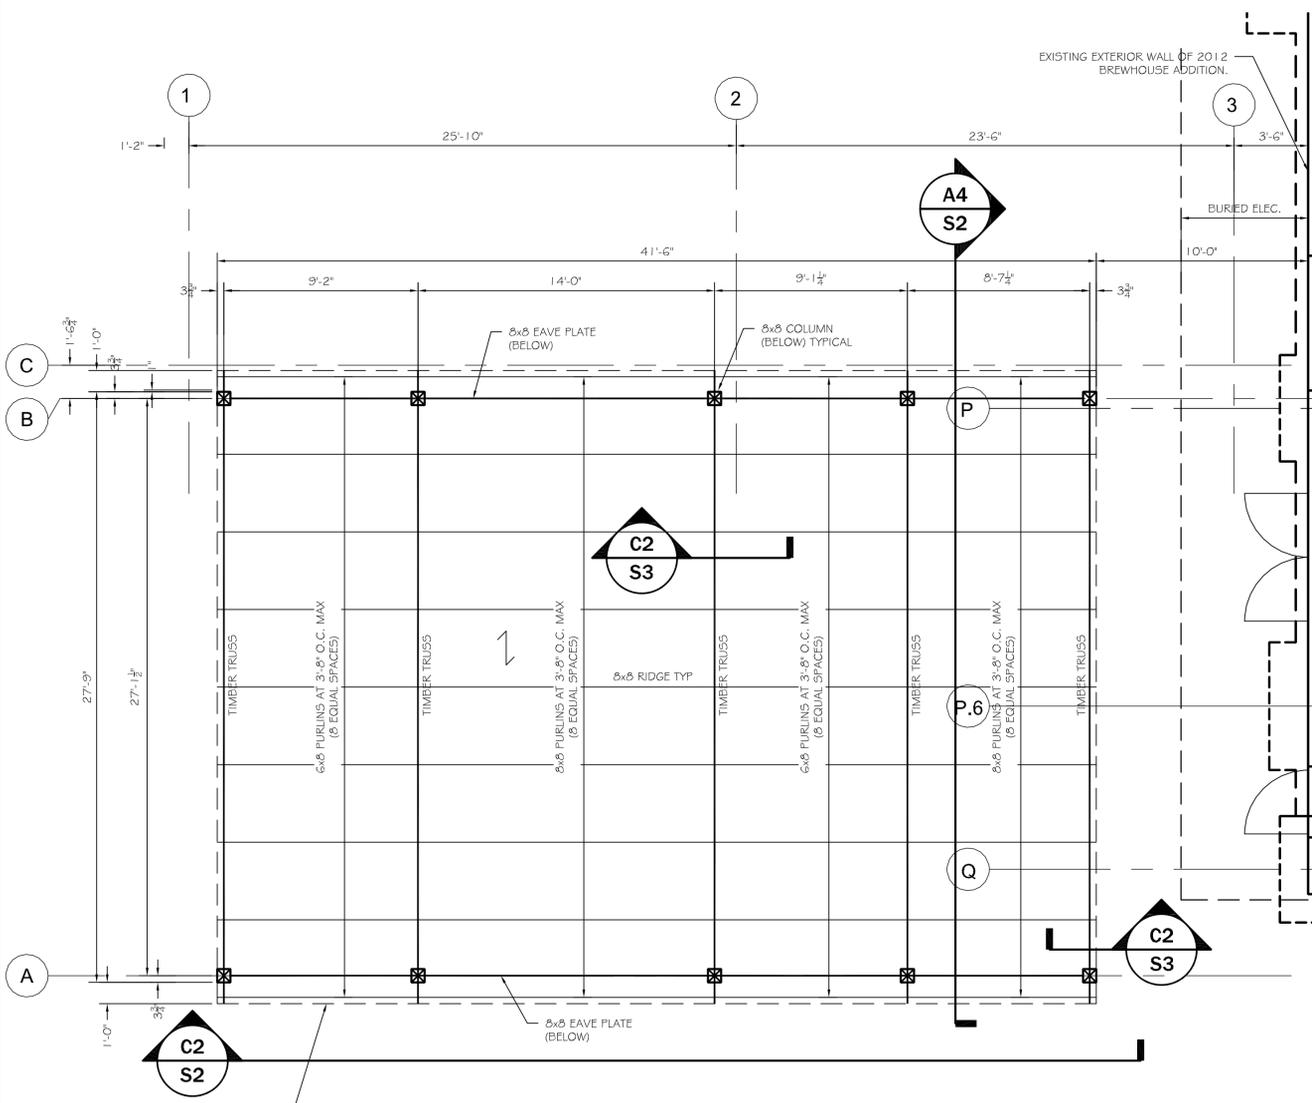

A1 ROOF FRAMING PLAN
SCALE: 1/4" = 1'-0"

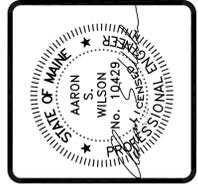

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PROJECT: **ALLAGASH BREWING CO.**
PORTLAND, MAINE
SHEET TITLE: **PATIO ROOF PROJECT**
ROOF FRAMING PLAN - ISSUED FOR PERMITTING

REVISIONS	DATE
No.	BY

DATE: 6-11-15
SCALE: 1/4" = 1'-0"
DESIGN BY: ASW
DRAWN BY: RSC
PROJECT NUMBER: **15192**
SHEET NO: **S2**