


HVAC PLAN - FIRST FLOOR

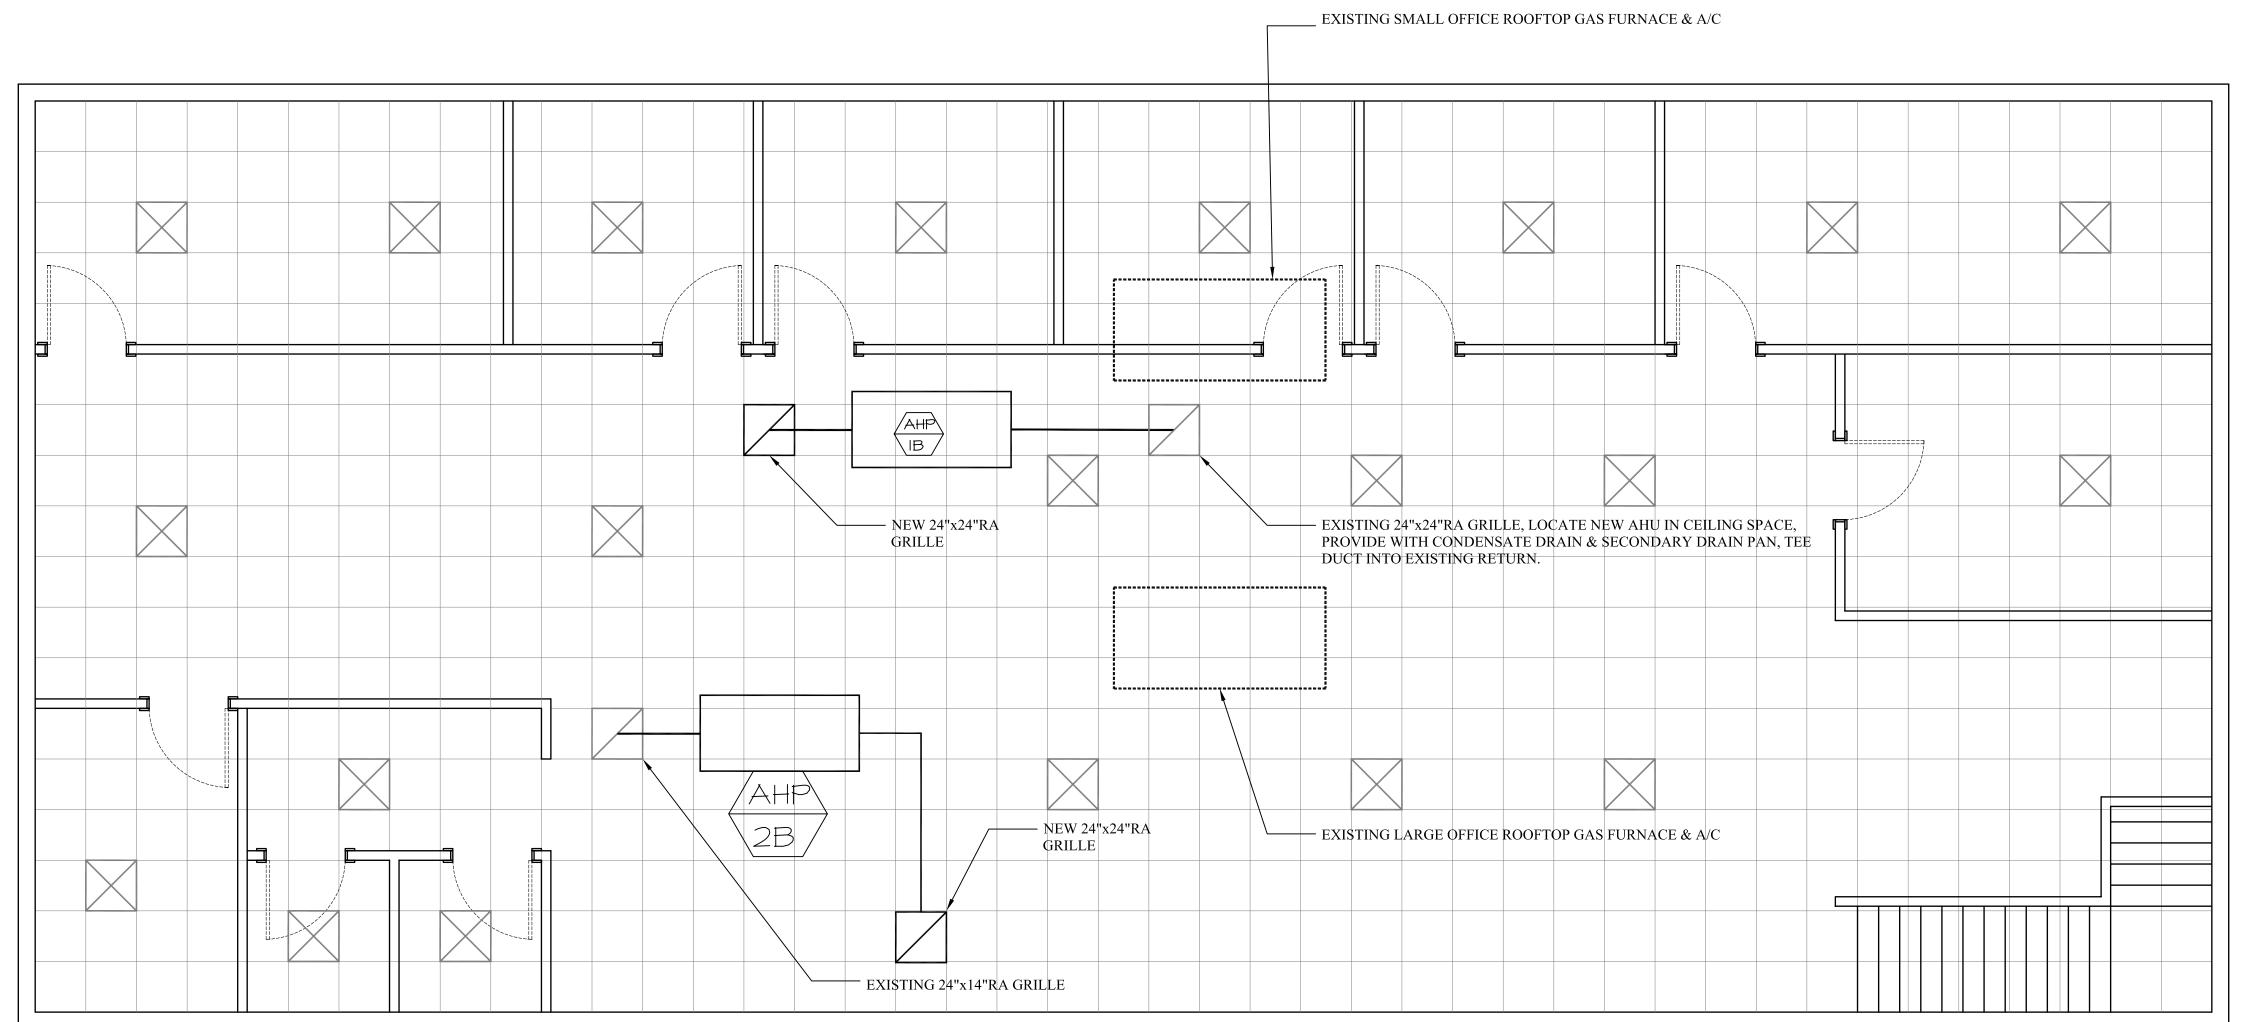

GENERAL NOTE:

1. THE EXISTING HVAC SYSTEMS IN THIS BUILDING ARE NOT BEING RENOVATED. THE SYSTEMS BEING ADDED ARE ONLY PROVIDING SUPPLEMENTAL HVAC FROM A GEO-EXCHANGE HEAT SOURCE / SINK.

CONTROLS:

THE EXISTING GAS FURNACE & A/C ARE TO REMAIN FUNCTIONAL WITH NO CHANFES TO PROVIDE SYSTEM BACK UP FOR NEW HEAT PUMPS.

NEW HEATPUMPS ARE TO BE PROVIDED WITH NEW ECOBEE WIFI THERMOSTATS, WHEN THE NEW UNITS RUN, THE "G" ON THE EXISTING UNITS SHALL BE ENERGIZED TO PROVIDE FULL AIRFLOW AND FRESH AIR. LOCATE NEW THRMOSTATS NEXT TO THE EXISTING STATS.

THE NEW UNITS ARE TO SUPPLY THE "BASE LOAD" AS A SUPPLEMENT TO THE EXISTING SYSTEM. tHE EXISTING SYSTEM WILL STILL PROVIDE PEAK LOAD HEATING AND COOLING WHEN NEEDED.



REV. DE	SCRIPTION	DATE	APPROVED
TOLERANCES DECIMAL:	BLAKE		4 Odlin Road n, ME 04401
FRACTIONAL: ANGULAR:	EQUIPMENT	8	300-883-7661 47-6845 FAX
MATERIAL:	NORTHEAST MECHANICAL DIVISIO		nemech.com
DWN BY: JJH	Peak Performance Solutions		
CKD BY:	TITLE: BLAKE EQUIPMENT GEO-EXCHANGE HEAT PUMPS		
DATE: 3.12.14	PLAN VIEWS		
SCALE: 1/4"=1'0"	JOB No.	DWG No. H1	REV.