

PROPOSED INTERIOR RENOVATION

AMERICAN TIRE DISTRIBUTION

765 Warren Avenue, Portland, ME 04101

CBL: 316 A003001

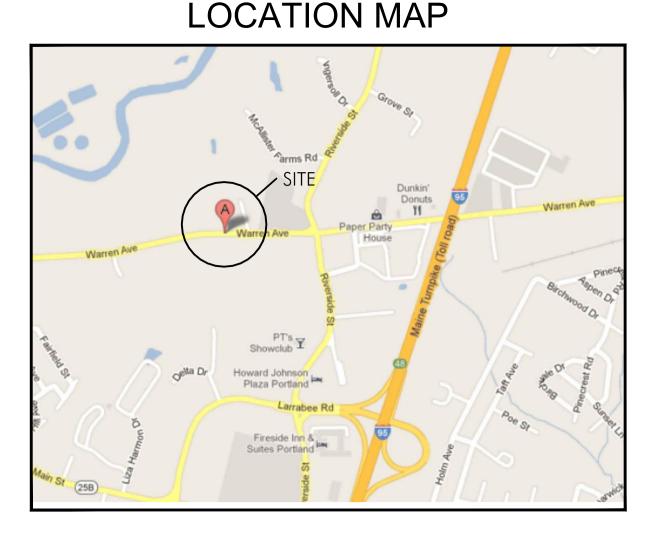

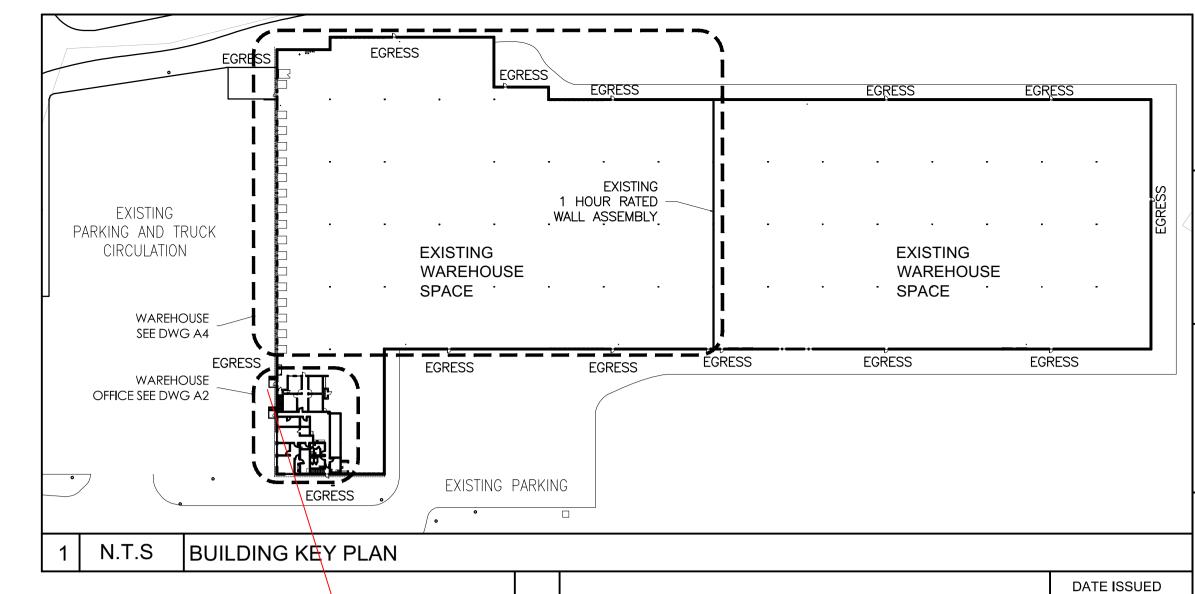

Kennebunkport, ME 04046 207.967.8850 www.grahamarchitects.com

STRUCTURAL ENGINEER

ARREVIATIONS

	Α	F	M	S
ABV. A.F.F. A.D. AC.BD. AC.CLG. AC.T. ADJ. AG. ALT. AL. ANCH. A.B. ANOD. ARCH. ASPH. ASSY.	ABOVE ABOVE FINISHED FLOOR ACCESS DOOR ACOUSTICAL BOARD ACOUSTICAL TILE ADJUSTABLE AGGREGATE ALTERNATE ALUMINUM ANCHOR ANCHOR BOLT ANODIZED ARCHITECT ASPHALT ASSEMBLY	FAB. FABRICATE FAS. FASTEN F.GL. FIBER GLASS FIN. FINISH F.F. FINISH FLOOR F.E. FIRE EXTINGUISHER F.E.C. FIRE EXTINGUISHER F.H.C. FIRE HOSE CABINET F.H.R. FIRE HOSE RACK FPRF. FIRE PROOFING FLG. FLASHING F.H.S. FLAT HEAD SCREW FL. FLOOR F.D. FLOOR DRAIN FL. MTD. FLOOR MOUNTED FT. FOOT FDN. FOUNDATION FUT. FUTURE	MFR. MANUFACTURER MRB. MARBLE MAS. MASONRY M.O. MASONRY OPENING MAX. MAXIMUM MEMB. MEMBRANE MTL. METAL MTL. DK. METAL DECK MTL. L. METAL LATH M. METER MEZZ. MEZZANINE MM. MILLIMETER MLWK. MILLWORK MIN. MINIMUM MISC. MISCELLANEOUS MOD. MODULE MLDG. MOULDING MTG. MOUNTING MULL. MULLION	SAF. GL. SAFETY GLASS S.N.D. SANITARY NAPKIN DISPENSER SCHED. SCHEDULE SLNT. SEALANT SMLS. SEAMLESS SECT. SECTION SEP. SEPERATE SERV. SERVICE S.S. SERVICE SINK SHWR. SHOWER SH. SHEET SIM. SIMILAR S.C. SOLID CORE SPCL. SPECIAL SPEC. SPECIFICATION SQ. SQUARE S. STL. STAINLESS STEEL STD. STANDARD STL. STEEL S.D. STORM DRAIN
	В	GAL. GALLON GALV. GALVANIZED		STRUC. STRUCTURAL SURF. SURFACE
BSMT. BM. B.M. BTWN. BIT. BLK. BLKG.	BASEMENT BEAM BENCH MARK BETWEEN BITUMINOUS BLOCK BLOCKING	GA. GAUGE GL. GLASS GR. GRADE GRAN. GRANITE GYP. BD. GYPSUM BOARD GYP. PLASGYPSUM PLASTER	NAT. NATURAL NOM. NOMINAL N.I.C. NOT IN CONTRACT N.T.S. NOT TO SCALE NO. NUMBER	SUSP. SUSPEND SUSP. CLGSUSPENDED CEILING
BK. BLDG. B.U.R.	BRICK BUILDING BUILT-UP ROOFING	Н	NO. NOWBER	TEL. TELEPHONE TEMP. TEMPERED T.C. TERRA COTTA TERR. TERRAZO THK. THICKNESS
	C	HDW. HARDWARE HD. HEAD		THD. THREAD THRESH. THRESHOLD
CAB. CPT. C.I.P. C.I. CLG. CEM. CTR. C.L. CER. C.T.	CABINET CARPET CAST—IN PLACE CAST IRON CEILING CEMENT CENTER CENTER LINE CERAMIC CERAMIC TILE	HT. HEIGHT H.PT. HIGH POINT H.C. HOLLOW CORE H.M. HOLLOW METAL H.B. HOSE BIBB HR. HOUR	O.C. ON CENTER OPNG. OPENING OPP. OPPOSITE OP.HD. OPPOSITE HAND O.D. OUTSIDE DIAMETER OA. OVERALL OVHD. OVERHEAD OZ. OUNCE OXY. OXYGEN	T.ACC. TOILET ACCESSORY T.P.D. TOILET PAPER DISPENSER T.O.C. TOP OF CURB T.O.SL. TOP OF SLAB T.O.STL. TOP OF STEEL T.B. TOWEL BAR TRAV. TRAVERTINE T. TREAD TYP. TYPICAL TLT. TOILET
CLO. COL.	CLOSET COLUMN	IN. INCH	PTD. PAINTED	1.1
CONC. C.M.U. CONST. C.JT. CONT. CSK. CU.FT.	CONCRETE CONCRETE MASONRY UNIT CONSTRUCTION CONTROL JOINT CONTINUOUS COUNTERSUNK CUBIC FOOT	INCL. INCLUDE INSUL. INSULATION INT. INTERIOR I.D. INSIDE DIAMETER INTG. INTEGRAL	PR. PAIR PNT. PAINT PNL. PANEL P.T.D. PAPER TOWEL DISPENSER PART. BD. PARTICAL BOARD PART. PARTITION PC. PIECE	U.C. UNDERCUT U.L. UNDERWRITERS LABORATORIES INC. UR. URINAL U.N.O. UNLESS NOTED OTHERWISE
	D	J	PLAS. PLASTER PL. PLASTIC PL. LAM. PLASTIC LAMINATE PLT. PLATE	V
DP. DET. DIA. DIM. DR. DN. DWG. D.F.	DAMPROOFING DETAIL DIAMETER DIMENSION DOOR DOWN DRAWING DRINKING FOUNTAIN DRYWALL	JT. JOINT JST. JOIST	P.W. PLYWOOD PT. POINT POL. POLISHED LB. POUND PVC POLYVINYL CHLORIDE P.C. PLAS.PORTLAND CEMENT PT. PLASTER PRCST. PRECAST PROP. PROPERTY	VAC. VACUUM V.B. VAPOR BARRIER VAR. VARIES VERT. VERTICAL V.W.C. VINYL WALL COVERIN V.C.T. VINYL COMPOSITION TILE VNR. VENEER
D.	DEPTH	K.PL. KICK PLATE KO. KNOCKOUT KW. KILOWATT	P.S.I. POUND PER SQUARE INCH	W
	E		Q	W.T.W. WALL TO WALL
EA. ELAS. E.D.F.	EACH ELASTIC ELECTRIC DRINKING FOUNTAIN	LBL. LABEL	QTY. QUANTITY Q.T. QUARRY TILE	W.H. WALL HUNG W.C. WATER CLOSET WP. WATER PROOFING WND. WINDOW
EL. ELEV.	ELEVATION ELEVATOR	L.B. LAG BOLT LAM. LAMINATE LAV. LAVATORY	R	W.W.F. WELDED WIRE FABRIC WD. WOOD W.P. WORK POINT
ENCL. EQ. EQUIP. EXH. EXIST. EXP. EXP.ANCH EXP.BLT. EXP.JT. EXT.	ENCLOSURE EQUAL EQUIPMENT EXHAUST EXISTING EXPANSION .EXPANSION ANCHOR EXPANSION BOLT EXPANSION JOINT EXTERIOR	LT. LIGHT WEIGHT LT. WT. LIGHT WEIGHT LW.C. LIGHT WEIGHT CONCRETE LMS. LIMESTONE L.F. LINEAR FEET LNTL. LINTEL LG. LONG LVR. LOUVER L.PT. LOW POINT L. LENGTH	RAB. RABBET RAD. RADIUS RE: REFER, REFERENCE R.D. ROOF DRAIN RFG. ROOFING REFL. REFLECTED REINF. REINFORCE REQD. REQUIRED R.A. RETURN AIR REV. REVISE R.O.W. RIGHT OF WAY R. RISER	W.I. WROUGHT IRON W/O WITHOUT W/ WITH W. WIDTH

R.O.W. RIGHT OF WAY RISER ROOM

> ROUGH OPENING RUBBER

R.O.

SYMBOLS

ACOUSTICAL TILE	MARBLE, TRAVERTIN	
ALUMINUM	PLASTER	8 0 0 0 0 8 0 0 0 8
BRASS, BRONZE	PLYWOOD	
BRICK	STEEL	
CONCRETE	STONE, GRANITE	
CONCRETE MASONRY UNITS	TERRAZZO	V
EARTH	TILE CERAMIC OR QUARI	
GLASS	WOOD BLOCKING OR SHIM	1S
GYPSUM WALL BOARD	WOOD- FINISHED	
INSULATION BATT OR BLANKET	WOOD- ROUGH	
INSULATION- RIGID		

GENERAL NOTES

1. The intent of the drawings is to include items necessary for the proper execution and completion of the work. The contractor shall review all drawings, and carefully verify existing conditions for coordination before proceeding with the work. The Architect shall be notified immediately of any discrepancy.

2. All work shall be done in an orderly and professional manner. The Contractor is responsible for coordinating work to be done by its subcontractors, with local authorities, state agencies, or utility companies which may have jurisdiction over this

3. All contractors shall visit the site at designated times to review existing conditions and should verify the location of existing utilities before commencing work.

4. All utility extensions and connections shall be done in accordance with the State of Maine and the City if Portland laws. In case of conflict, the most restrictive rule applies.

5. Exterior wall is existing and not affected in this scope unless otherwise noted.

6. Interior partition shall be Type 1—Typical, unless noted otherwise.

7. In all cases, dimensions take precedence over scale.

8. All building elevations are taken from the site elevation 0'-0" as related to ground floor top of slab elevation.

9. Contractor shall provide 2x wood blocking nested in steel studs for support/fastening of specialties and accessories where indicated on the drawings.

10. Drywall contractor shall be responsible for providing additional (secondary) bracing, or stiffening framing required to meet the maximum deflection values specified for the height limitations of partition types indicated on drawings.

11. Installation of systems shall be made only by persons properly trained and qualified to install the specific system being provided. The installer shall certify that the installation is in complete agreement with the terms of the listing and the manufacturer's instructions for the approved system design.

18. Bottom stud channel—track of light steel stud framing walls and partitions shall be fastened to floor slabs. Top stud channel—track shall be properly secured to the underside of the floor structure above conforming with their corresponding wall or partition type. Nest top track to account for deflection

19. General Contractor shall be responsible to incorporate and coordinate the thru floor concrete work such as floor electrical and telephone and data "furnished-by-others" systems.

20. All Interior joints between dissimilar materials, installed by the same or different trade, shall receive "caulking." General Contractor shall be responsible to delegate "caulking" work to the joint sealants sub-contractor.

REFERENCE

	\		
GLAZING TYPE	(A)	new exterior stairs adjacent to existing	
ROOM/SPACE NUMBER	ENTRY 100	exterior stairs	
EQUIPMENT NUMBER	X-690		F
REVISION	<u> </u>		
REVISION CLOUD			שׁ
INTERIOR ELEVATION	45 A5		DRAWING I
EXTERIOR ELEVATION	3/A7.1		A A C
TEST BORING	TB-1		
NEW OR REQUIRED POINT ELEVATION	+461.00		
EXISTING POINT ELEVATION	+461.00		
NEW CONTOURS (ELEV. NOTED ON HIGH SIDE)	320		BL
EXISTING CONTOURS (ELEV. NOTED ON HIGH SIDE)	318		Сι
FLOOR LINES IN EXTERIOR ELEVATION			Int IB(
BREAK LINE			Int
PROPERTY LINES, BOUNDRY LINES			NF
MATCH LINE			ΑĽ

REFERENCE OR LEVEL LINE COLUMN REFERENCE GRIDS TOILET ACCESSORY SECTION/DETAIL WITH SHEET REFERENCE 3 A6.1 BUILDING SECTION PARTITION TYPE ENLARGED PLAN REFERENCE

ENLARGED DETAIL REFERENCE NORTH ARROW

PROJECT NORTH ARROW DOOR DESIGNATION F C-1 Flooring

W P-1 B B-1 Base FINISH SCHEDULE

UILDING CODE DATA

Surrent Codes Used for Code Information ternational Building Code BC Maine Amendment 2009 nternational Energy Conservation Code 2009 FPA 101

LIST OF DRAWINGS

A-0 COVER SHEET AND PROJECT DATA

EX-1 EXISTING CONDITIONS PLAN

A-1 PROPOSED PARTIAL PLAN A-2 REFLECTED CEILING PLAN A-3 OFFICE LIFE SAFETY PLAN

A-4 WAREHOUSE LIFE SAFETY PLAN

D-1 DEMOLITION PLAN

2010 ADA Standards for Accessible Design

OCCUPANCY -MIXED OCCUPANCY STORAGE GROUP S-1(IBC) STORAGE ORDINARY (NFPA 101)

BUSINESS GROUP B OCCUPANT LOAD

WAREHOUSE: 83,230 GROSS S.F. /500 = 166 PPL

3,065 S.F. /100

TYPE OF CONSTRUCTION IIB - ESFR SPRINKLER SYSTEM

= 30 PPL

INTERIOR FINISH CLASSIFICATION OFFICE ROOMS & SPACES - CLASS C

NON-SEPARATED OCCUPANCY

FULLY SPRINKLED AND MONITORED BUILDING WAREHOUSE SPRINKLER TO BE A ESFR SYSTEM

EGRESS

BUSINESS:

BUSINESS OCCUPANCY COMMON PATH LIMIT: 100 FT (SPRINKLED) 300 FT (SPRINKLED) TRAVEL DISTANCE LIMIT:

STORAGE OCCUPANCY (IBC S-1, NFPA 101 ORDINARY) COMMON PATH LIMIT (IBC): 250 FT (SPRINKLED) COMMON PATH LIMIT (NFPA): 100 FT (SPRINKLED) 250 FT (SPRINKLED) TRAVEL DISTANCE (IBC): TRAVEL DISTANCE (NFPA): 400 FT (SPRINKLED)

Existing Warehouse Office Expansion Portland, ME 04101

Portland, ME 04101



ISSUED FOR PERMIT


INFORMATION M:/boulos/warren Issue Date: 12/17/14

Drawn By: djg Checked By: Revision:

COVER PAGE

SCALE N.T.S.

ormation, material, and designs in this document are oprietary to and owned by Endodontic Associates. and uted in any way without the written consent fron

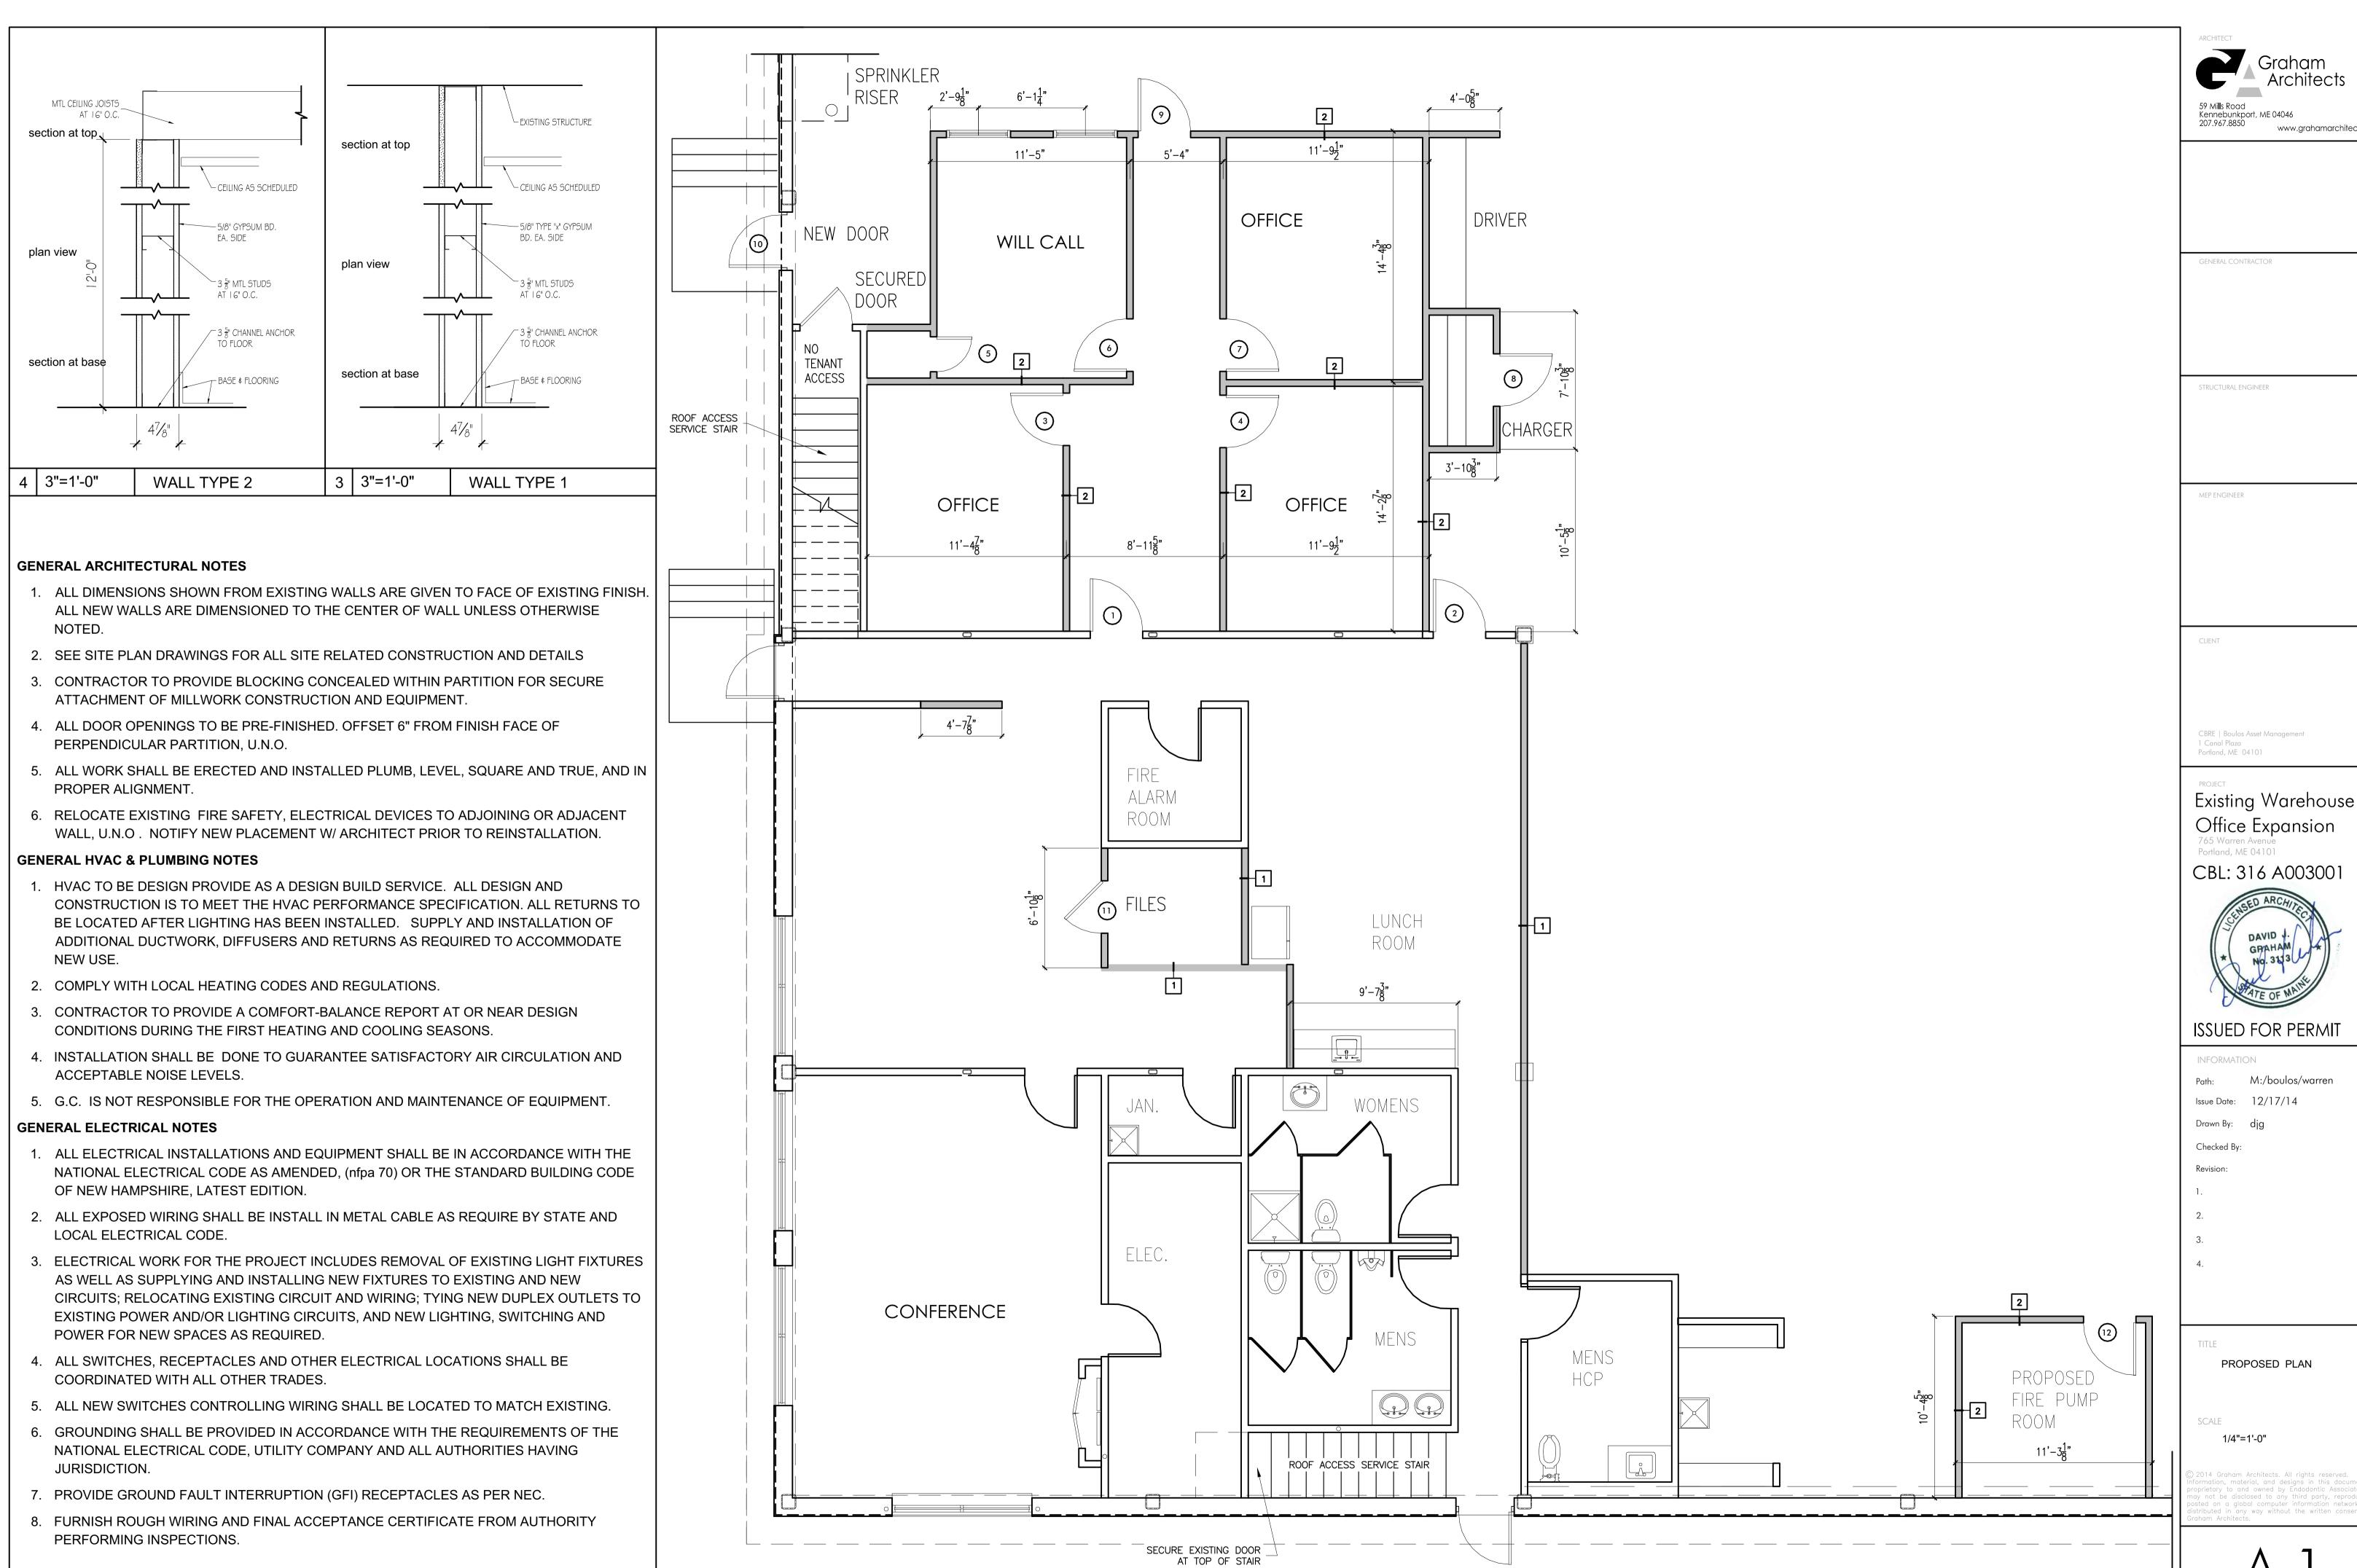

1/4"=1'-0"


PROPOSED PLAN


DO NOT SCALE DRAWINGS

NTS

GENERAL NOTES

www.grahamarchitects.com

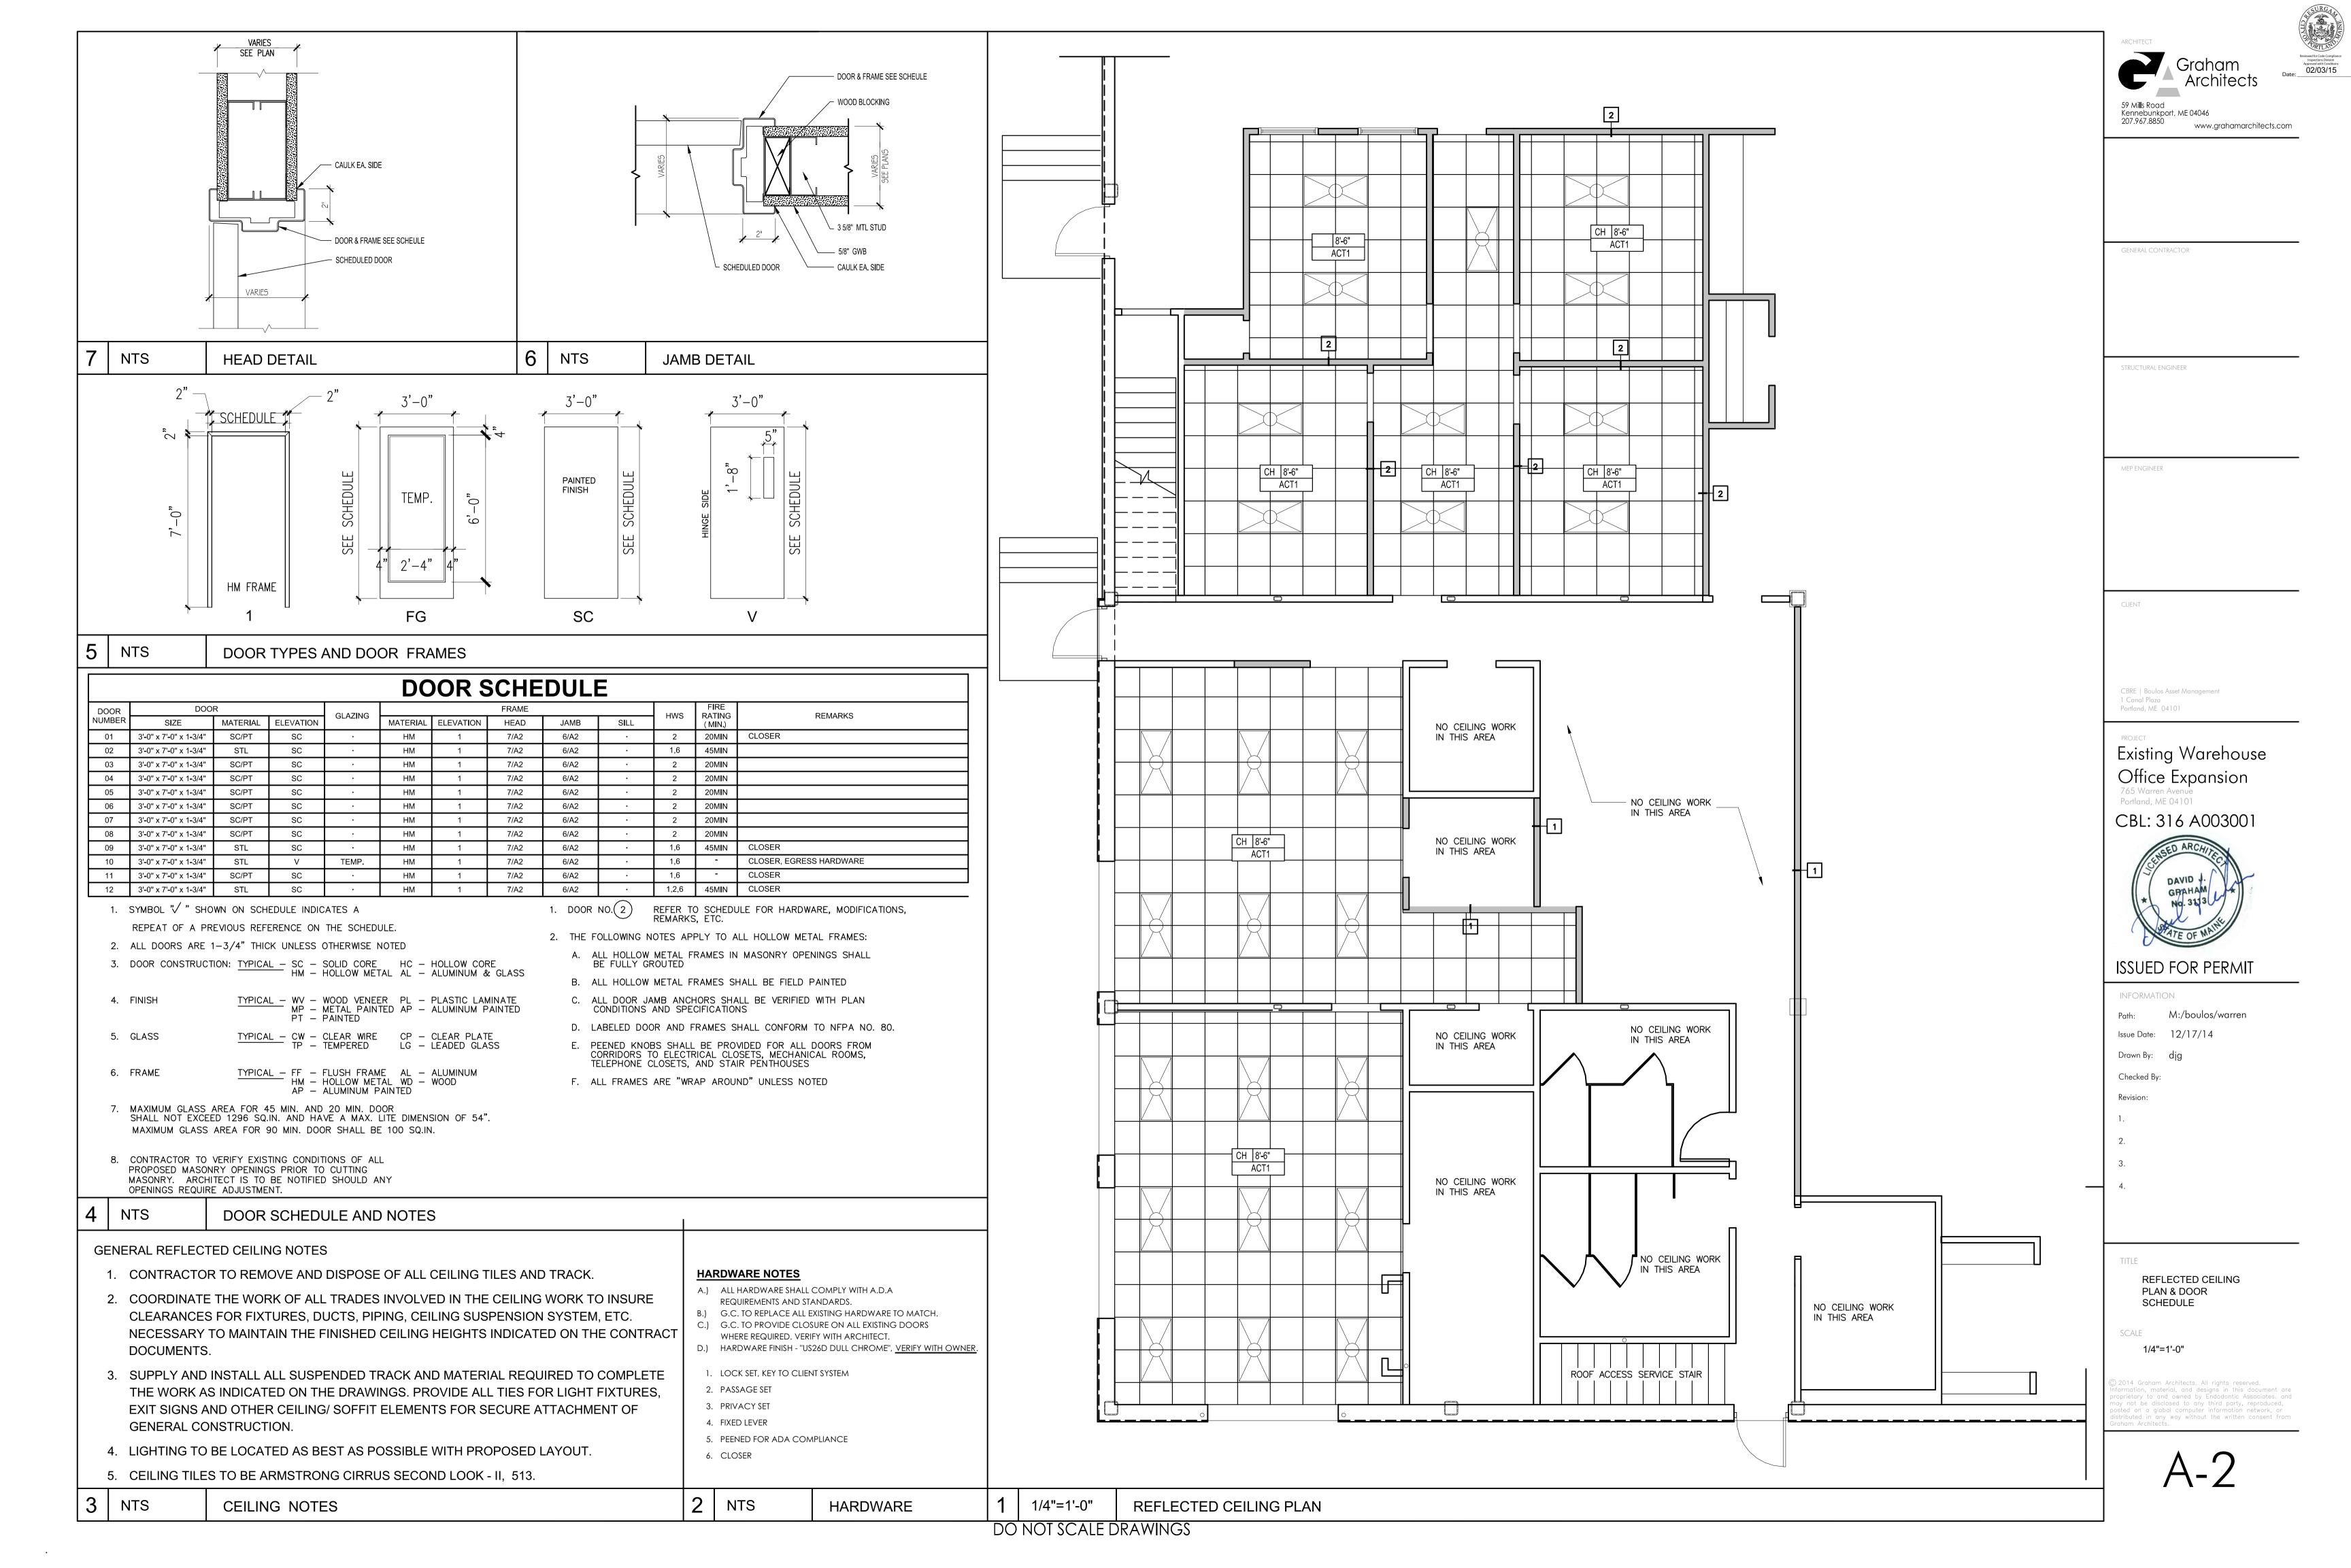

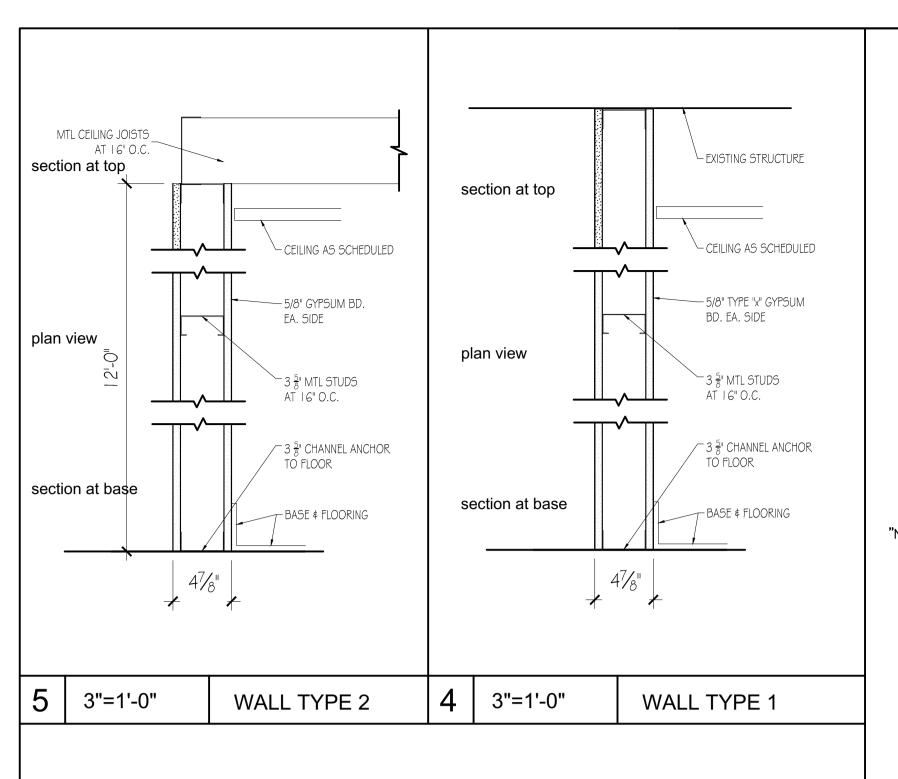

OCCUPANT LOAD:

USE	FLOOR AREA	OCC. LOAD FACTOR (SF/OCC)	OCC. LOAD		
OFFICE CONFERENCE	2,570 422	100 GROSS 15 NET	26 28		
TOTAL = 54					

NTS LEGEND

LIFE SAFETY SYMBOLS:


TRAVEL DISTANCE (FROM FURTHEST POINT) OCCUPANCY LOAD

OCCUPANT LOAD EGRESS CAPACITY

CONFERENCE USE



DIRECTIONAL EXIT SIGN WALL MOUNT & CEILING MOUNT

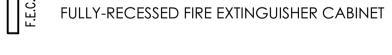

EMERGENCY LIGHTS, SEE ELECTRICAL DRAWINGS



FIRE ALARM AUDIO/VISUAL ALARM, 6'-8" AFF, WITH "C" CEILING MOUNTED



FIRE ALARM VISUAL ALARM, 6'-8" AFF, WITH "C" CEILING MOUNTED



FIRE ALARM MANUAL PULL STATION




FIRE ALARM CONTROL PANEL

FACP

2 NTS

LEGEND

EGRESS DIAGRAM - WAREHOUSE OFFICE SPACE DO NOT SCALE DRAWINGS

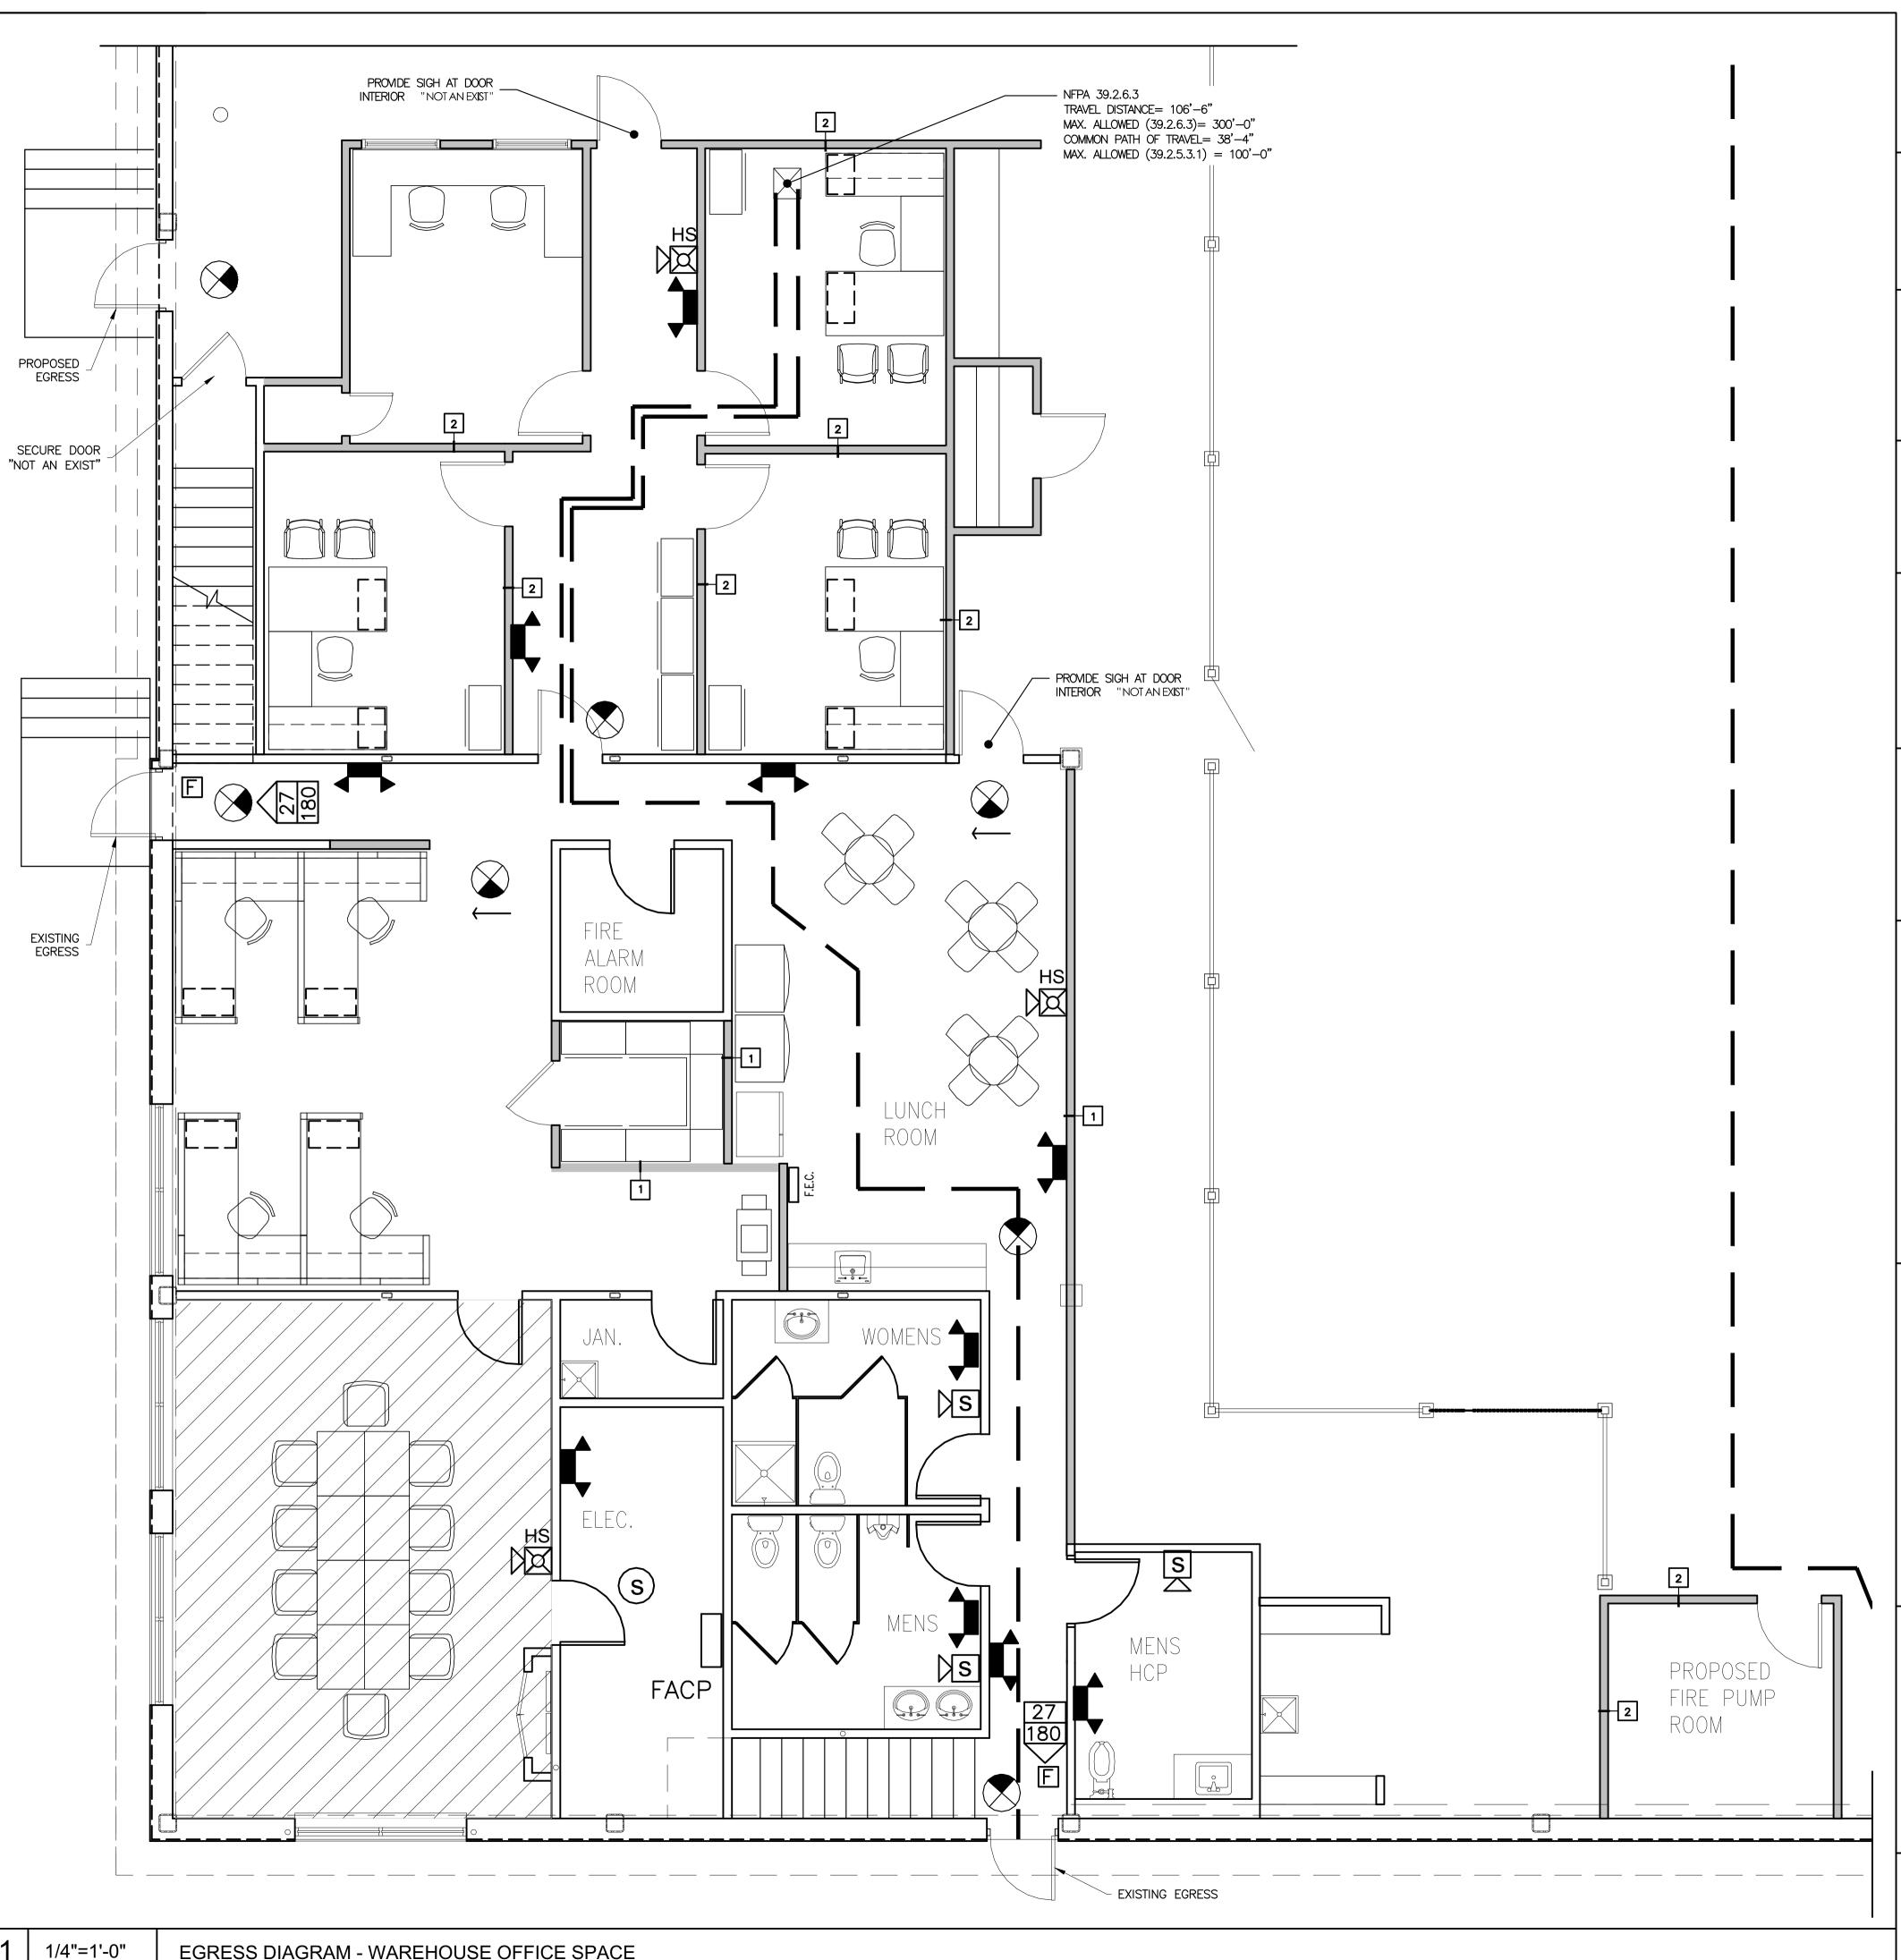

59 Mi**ll**s Road Kennebunkport, ME 04046 207.967.8850 www.grahamarchitects.com


GENERAL CONTRACTOR

STRUCTURAL ENGINEER

CBRE | Boulos Asset Management 1 Canal Plaza Portland, ME 04101

Existing Warehouse Office Expansion Portland, ME 04101

CBL: 316 A003001

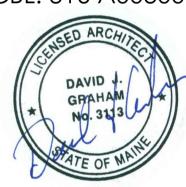

ISSUED FOR PERMIT

INFORMATION


Drawn By: djg Checked By:


LIFE SAFETY &

EGRESS PLAN

AS NOTED

SCALE

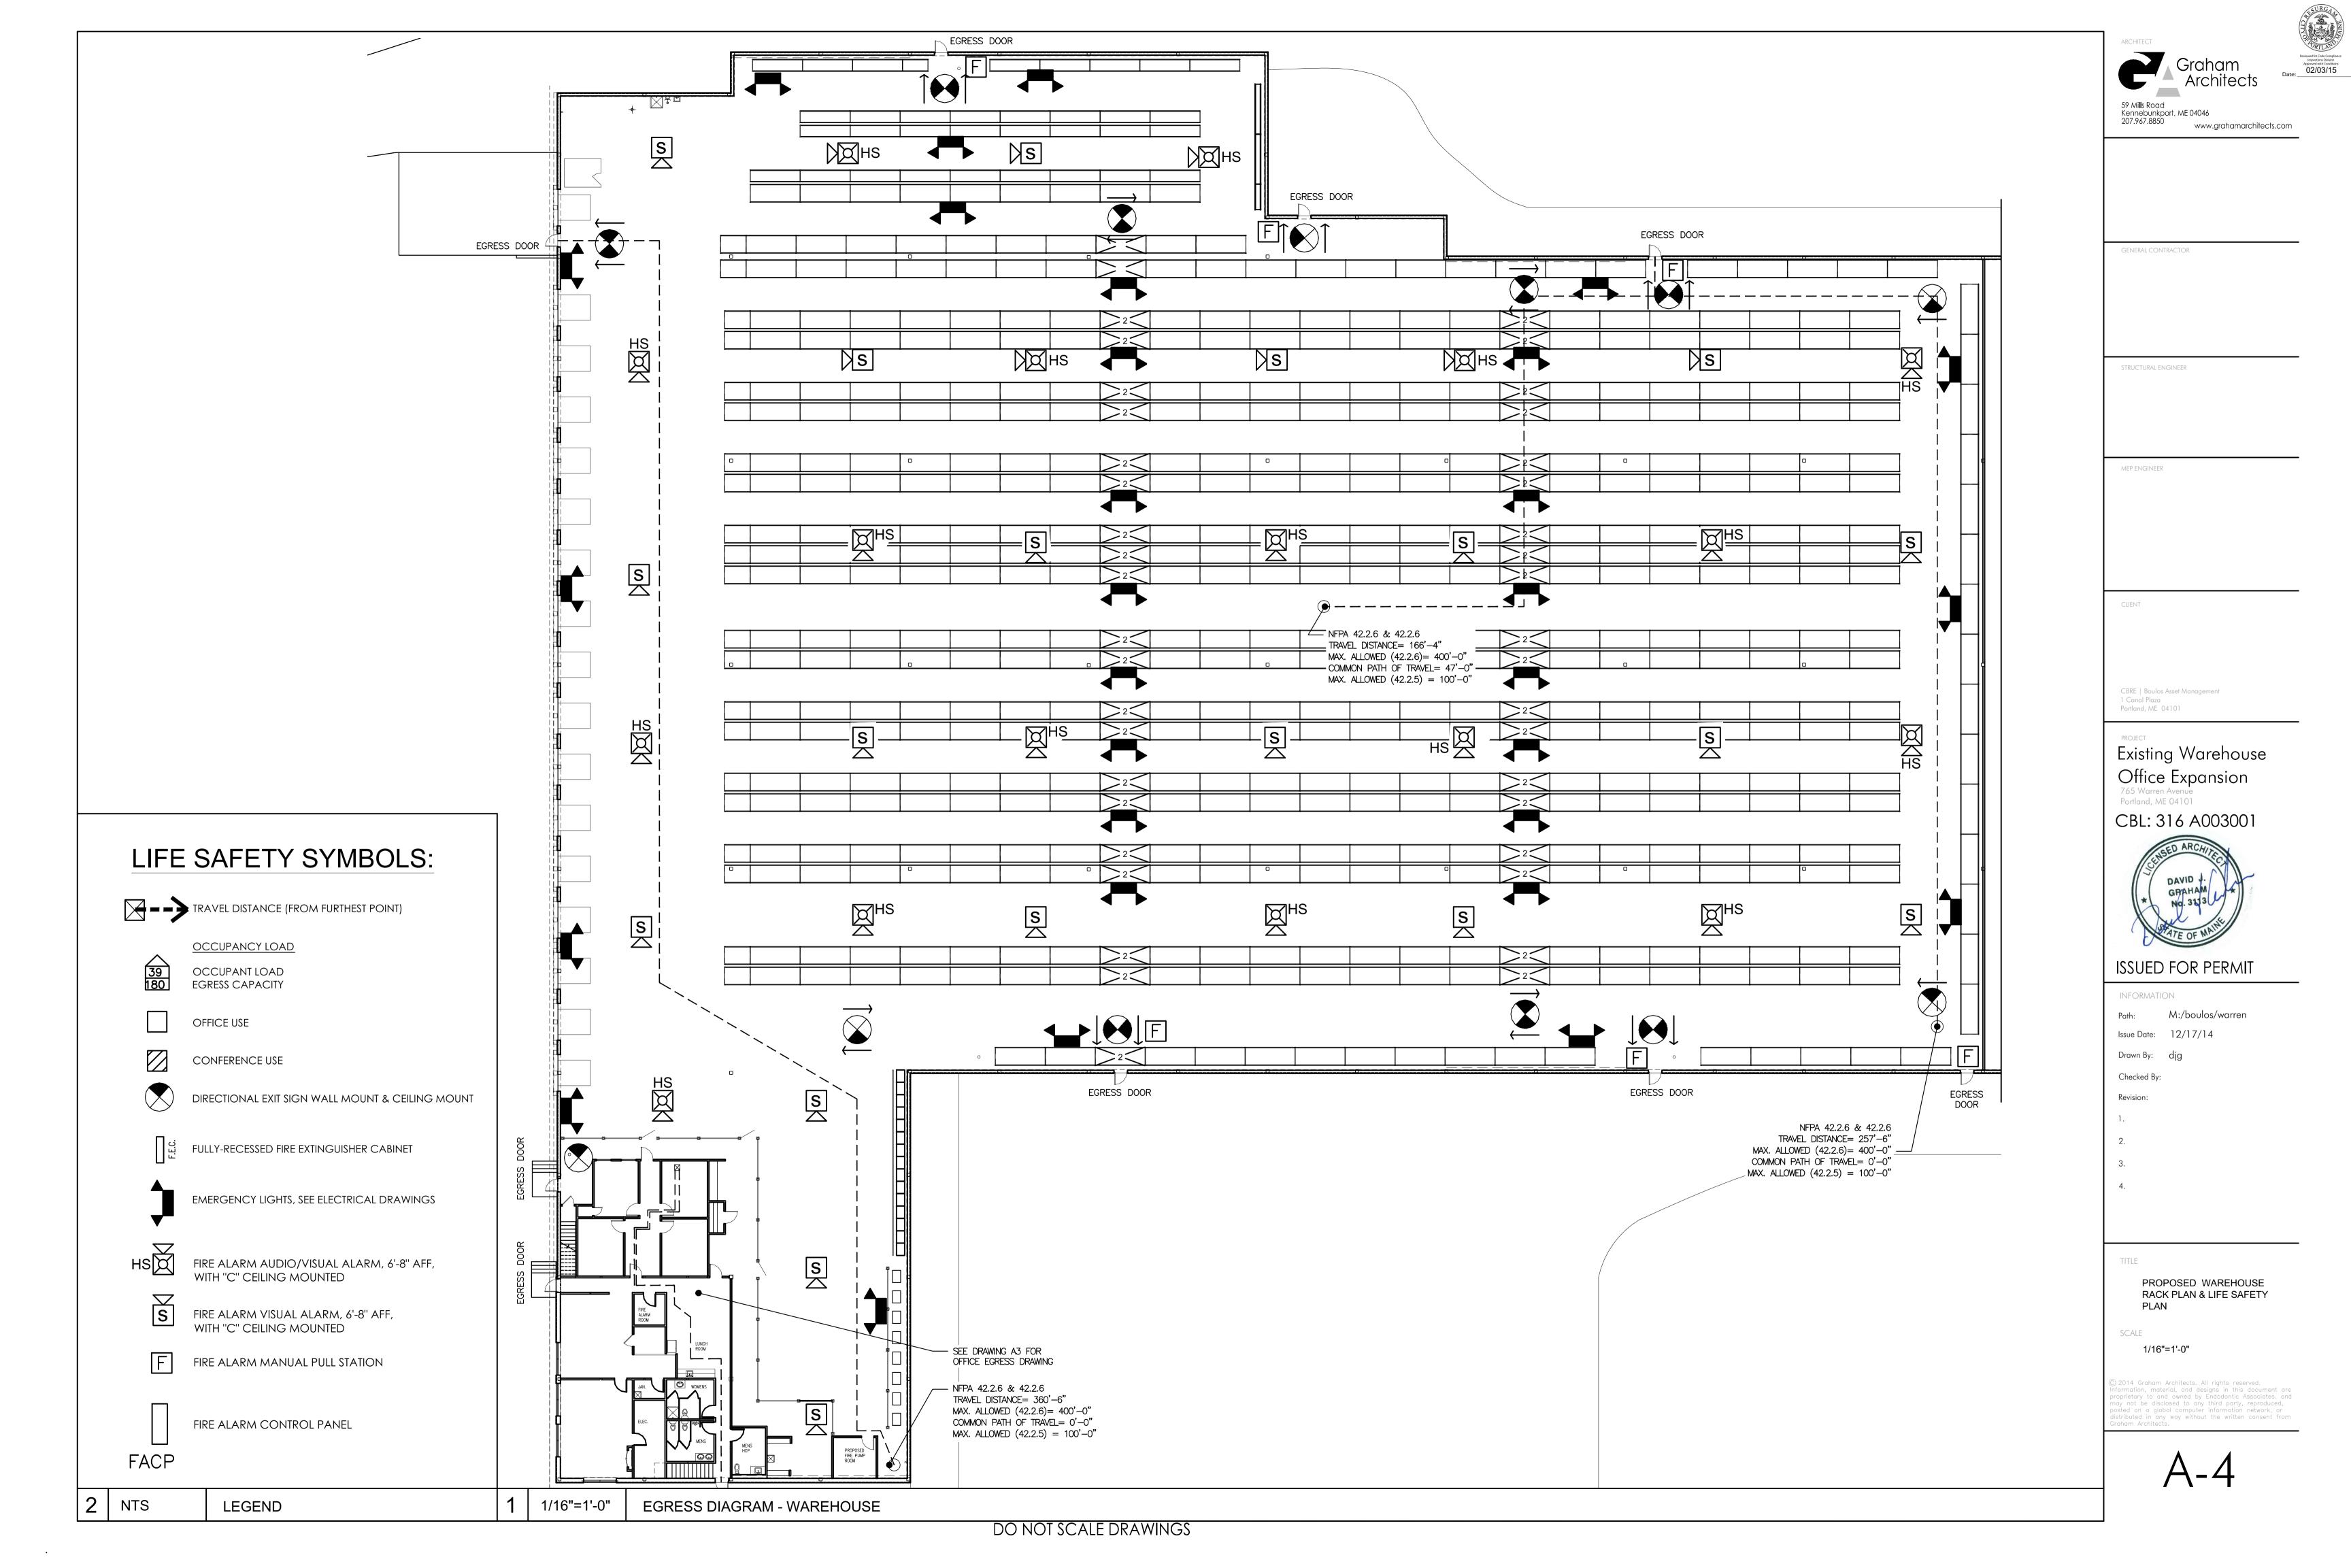

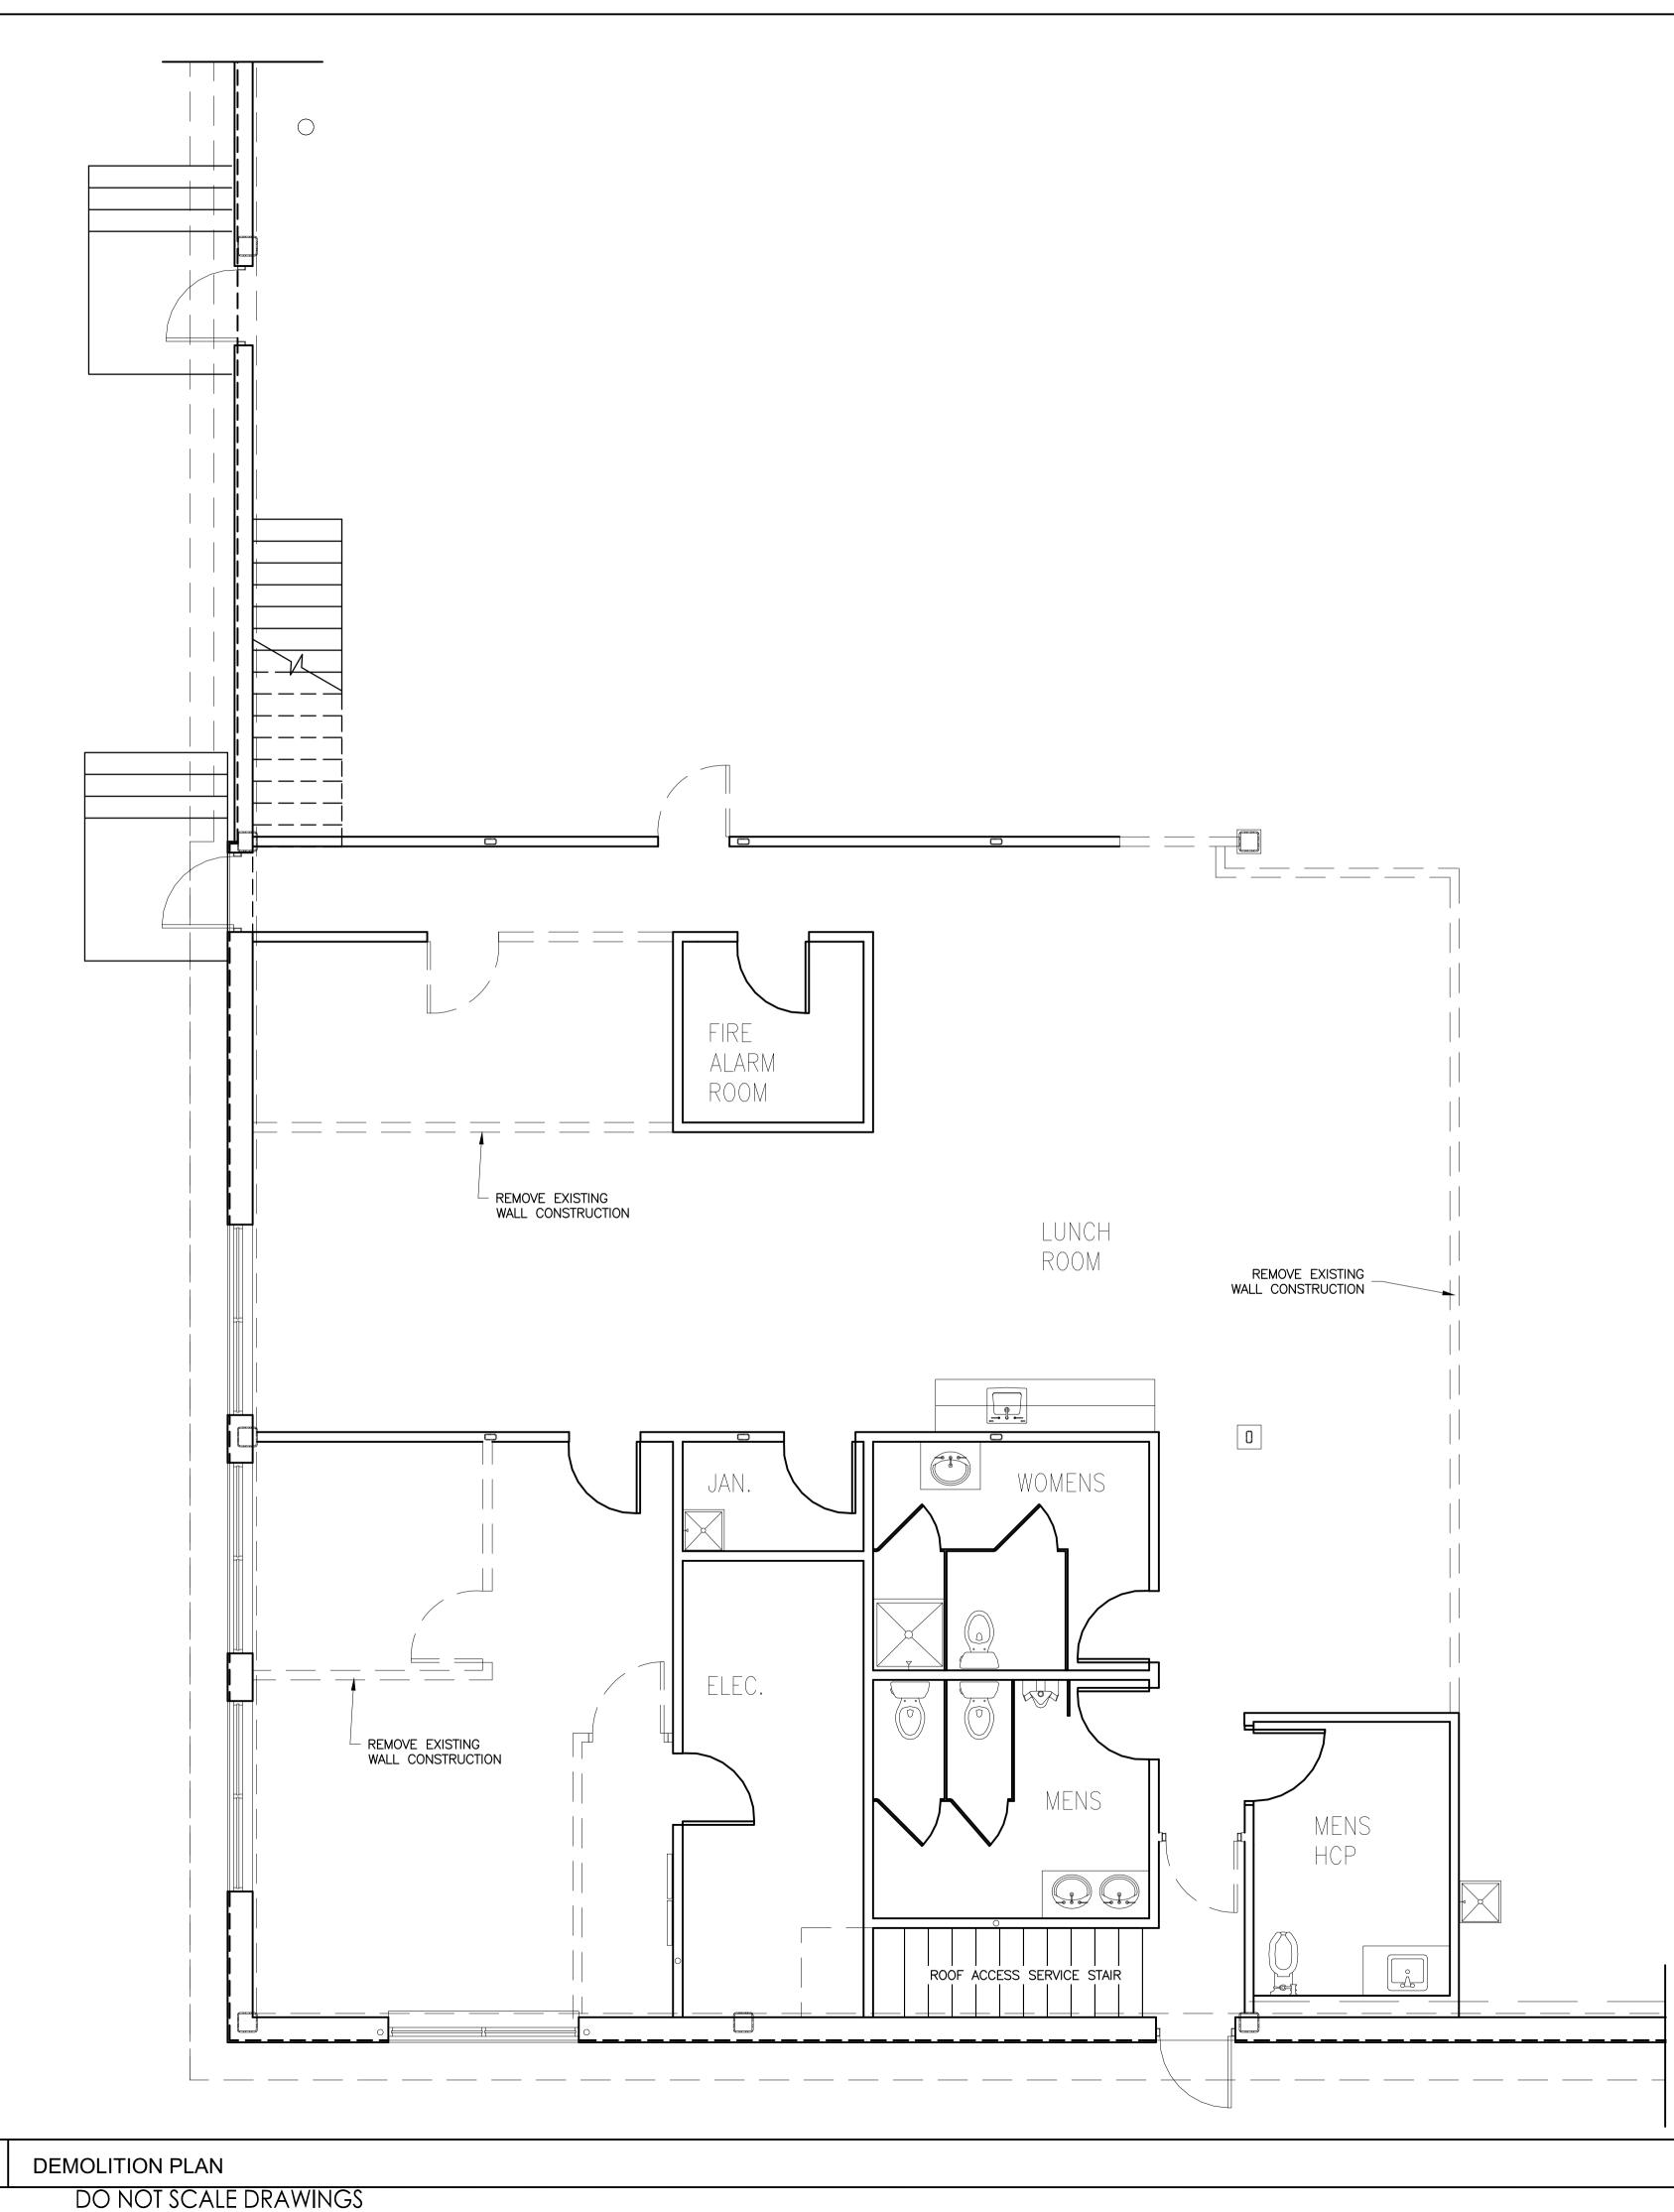



GENERAL CONTRACTOR

STRUCTURAL ENGINEER

CBRE | Boulos Asset Management 1 Canal Plaza

Portland, ME 04101

Existing Warehouse Office Expansion Portland, ME 04101

CBL: 316 A003001



ISSUED FOR PERMIT

INFORMATION

Issue Date: 12/17/14

Drawn By: djg

Checked By:


DEMOLITION PLAN

1/4"=1'-0"

SCALE

GENERAL DEMOLITIONS NOTES


- 1. GENERAL CONTRACTOR IS RESPONSIBLE TO COORDINATE CONSTRUCTION PHASING.
- 2. IN AREA OF WORK, G.C. SHALL BE RESPONSIBLE TO PATCH AND REPAIR ALL EXISTING CONSTRUCTION WHICH IS TO REMAIN.
- 3. GENERAL CONTRACTOR SHALL NOTIFY OWNER OF ANY HAZARDOUS MATERIALS DISCOVERED DURING DEMOLITION OR RE-CONSTRUCTION. G.C. SHALL REMOVE AND DISPOSE OF ALL HAZARDOUS MATERIALS IN ACCORDANCE WITH STATE AND LOCAL LAWS. ALL WORK SHALL BE PERFORMED BY A LICENSED ABATEMENT PROFESSIONAL. G.C. SHALL PROVIDE THE OWNER WITH ALL DOCUMENTS CERTIFYING THAT THE REMOVAL AND DISPOSAL MEETS ALL STATE AND LOCAL LAWS.
- 4. IF ANY QUESTIONS ARISE AS TO THE REMOVAL OF ANY MATERIAL, CLARIFY THE POINT WITH THE ARCHITECT BEFORE PROCEEDING.
- 5. DEMOLITION IS NOT NECESSARILY LIMITED TO WHAT IS SHOWN ON THE DRAWINGS. THE INTENT IS TO INDICATE THE GENERAL SCOPE OF DEMOLITION REQUIRED TO COMPLETE THE WORK IN ACCORDANCE WITH THE CONTRACT DOCUMENTS.
- 6. CONTRACTOR TO REMOVE AND DISPOSE OF ALL CARPET AND VCT IN ACCORDANCE WITH STATE AND LOCAL LAWS.
- 7. CONTRACTOR TO PREPARE EXISTING SUB-FLOOR AS REQUIRED FOR NEW FLOOR FINISHES.
- 8. ANY/ ALL EXISTING FIREPROOFING FOUND ON EXISTING STRUCTURE (COLUMNS, BEAMS, SLAB) SHALL BE PROTECTED & REMAIN INTACT.
- 9. IN PARTITIONS TO BE REMOVED REMOVE AND CAP ALL ELECTRICAL OUTLETS, SWITCHES, THERMOSTATS, WIRES, ETC. TO THEIR SOURCE AS REQUIRED.
- 10. CONTRACTOR TO STORE AND REMOVE ALL DEBRIS FROM SITE.
- 11. CONTRACTOR IS RESPONSIBLE TO CHECK WITH THE BUILDING OWNER OF ANY ITEMS TO BE SAVED AND RETURNED TO THE BUILDING OWNER PRIOR TO REMOVAL.
- 12. ALL WIRING, SWITCHING AND OUTLETS TO BE REMOVED A TERMINATED AT THE PANEL.
- 13. ALL ELECTRICAL WIRE MOLDING TO BE REMOVED AND SURFACES TO BE CLEAR OF ALL FASTENERS.

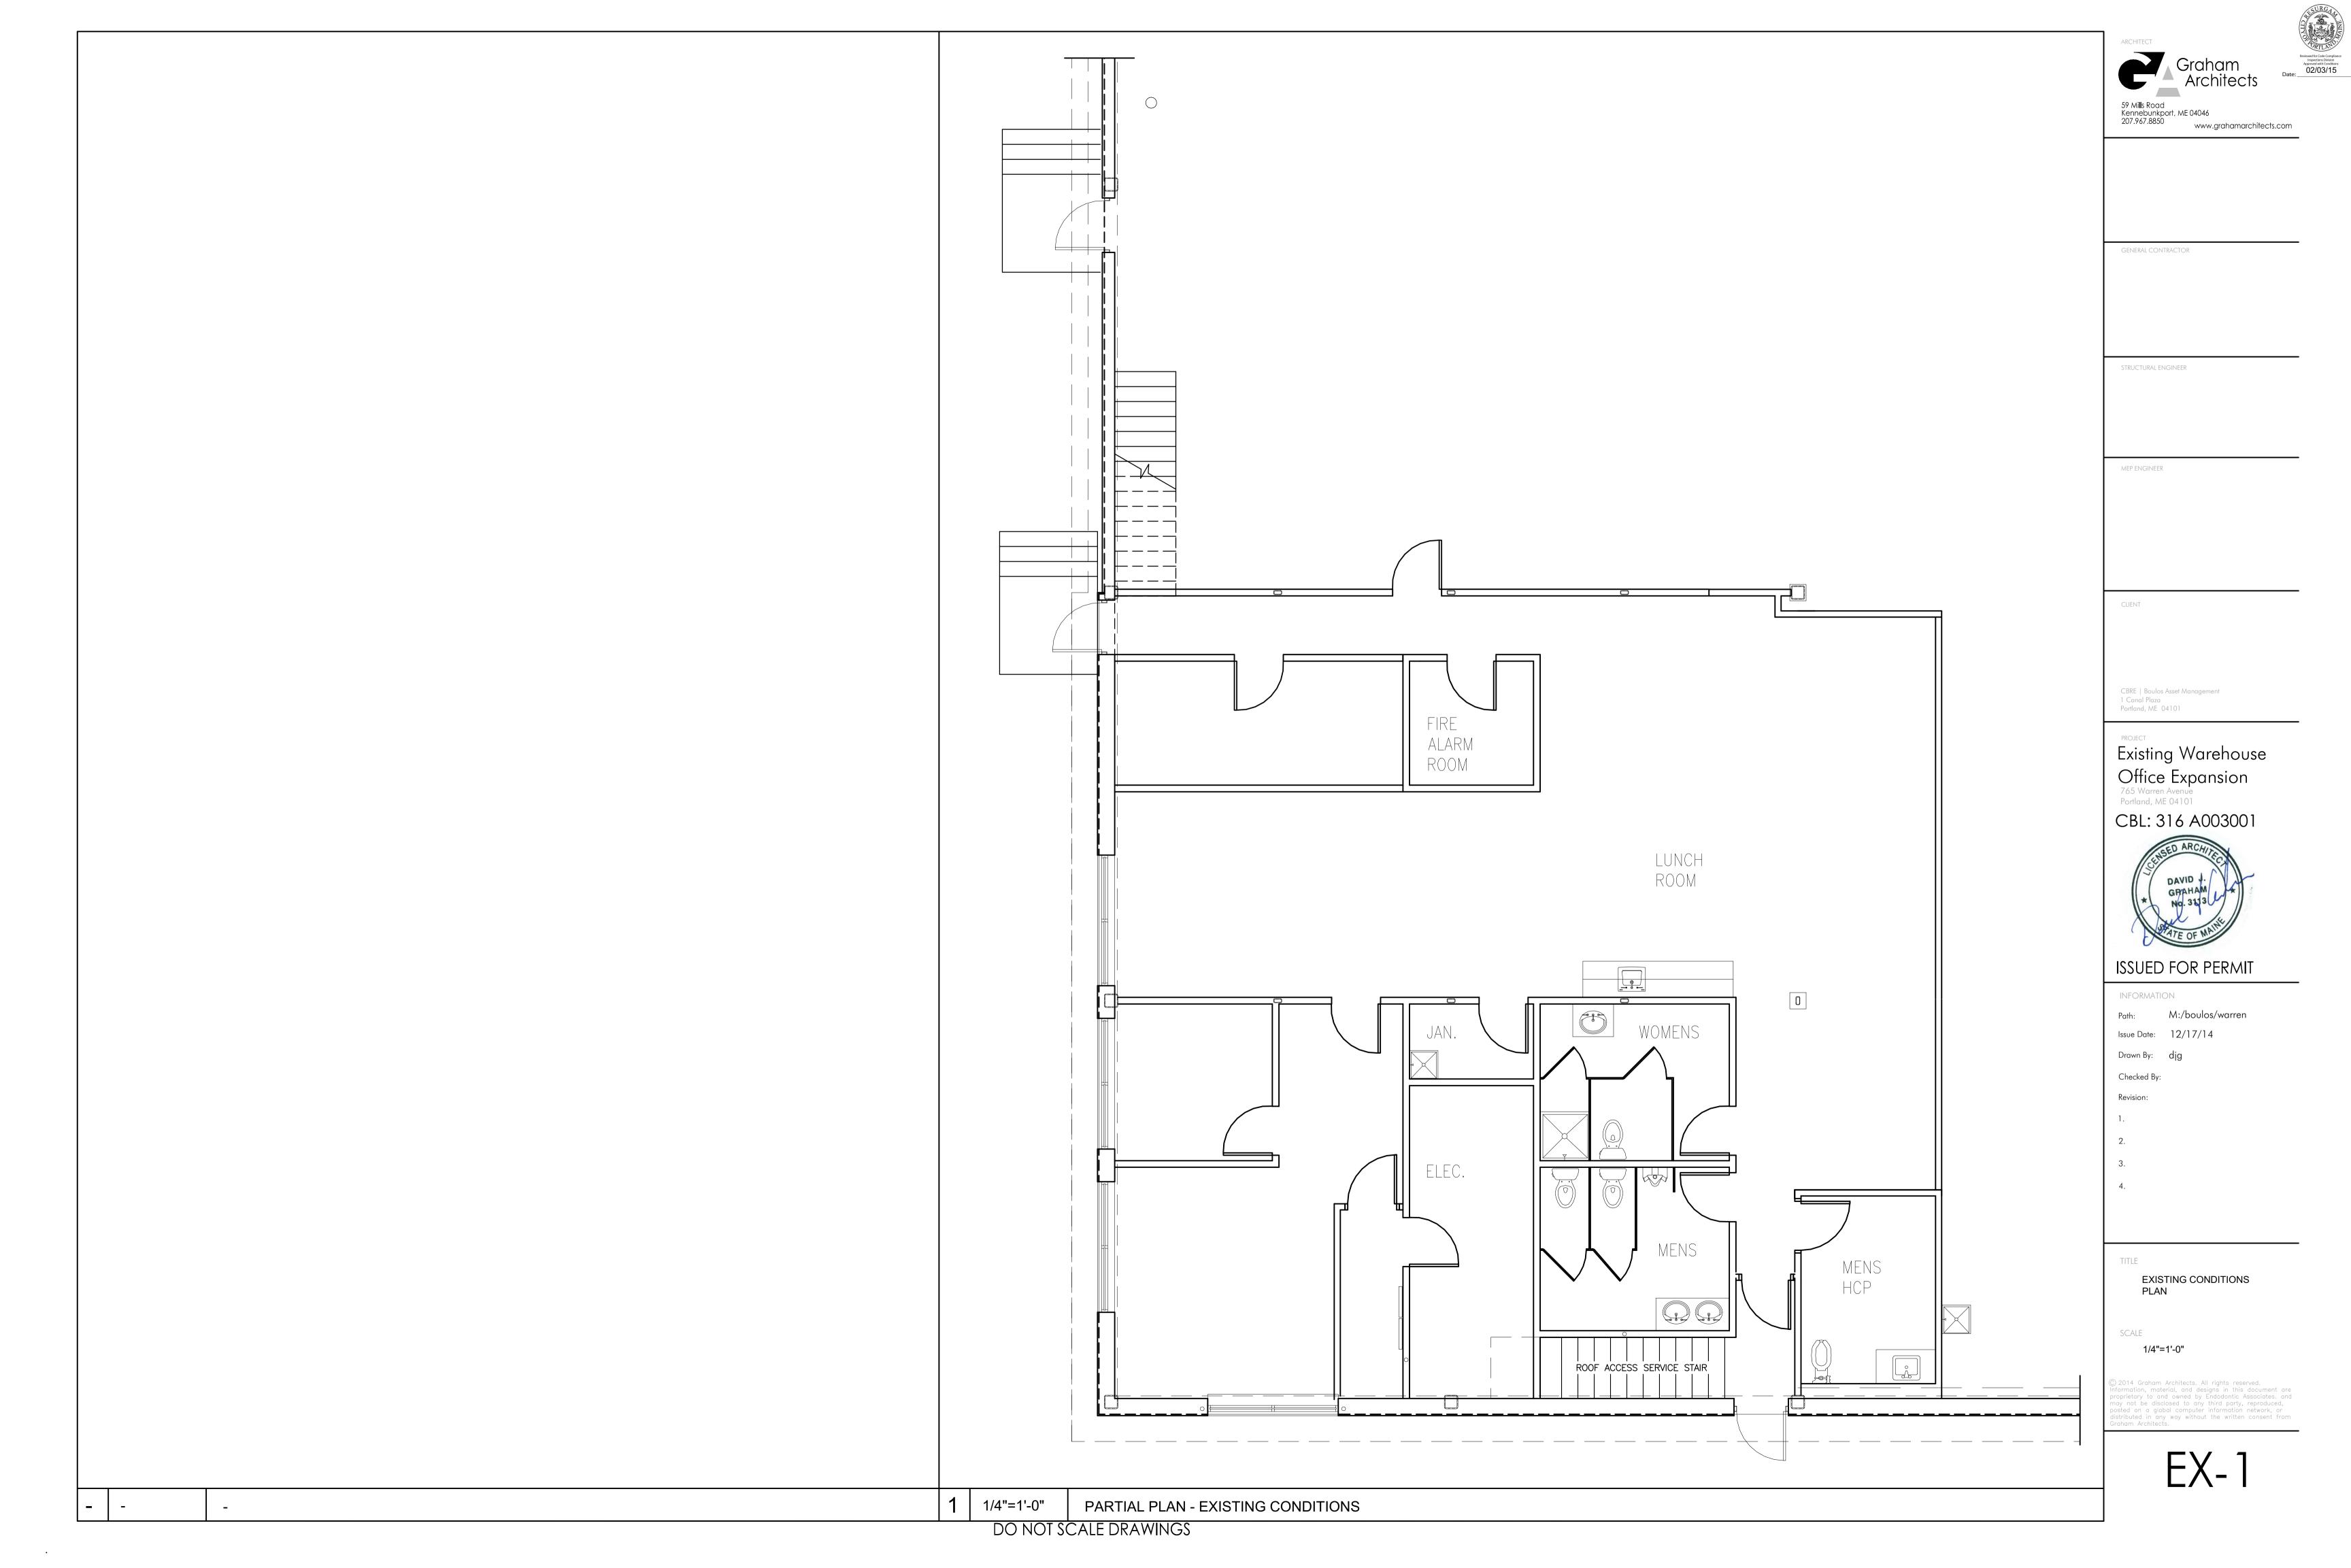



50" Wide, 7 Riser, 60" Platform 7/11 Step Sideway



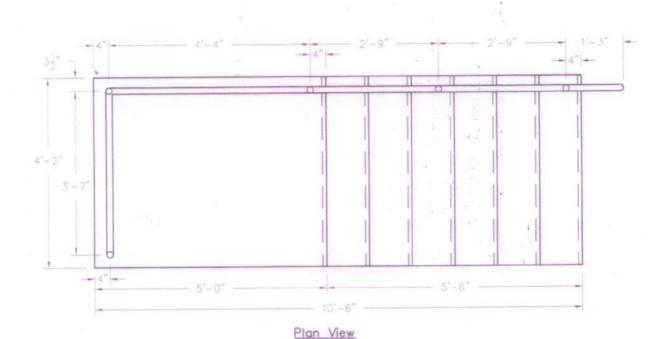

1 1/4" Sch. 40 Steel Pipe Rail Powder-Coated Black All concrete shall achieve a minimum 28 day compressive strength of 5,000 psi. 2. Concrete to be Sealed W/ Baracade WB 244 3. Treads & Landing will have Broom Finish 4. Rail Pockets to be 2 1/2"¢ EMT x 4" Deep 5. Reinforcement: -Min. 1.5" Bar Cover -Grade 60 Welded Woll

Elevation View





General Building Permit Application

Inspections Division Approved with Conditions

If you or the property owner owes real estate or personal property taxes or user charges Date: 02/03/15 within the City, payment arrangements must be made before permits of any kind are accepted.

Address/Location of Construction: 765 WARREN AVE PORTLAND ME.							
Total Square Footage of Proposed Structure: 960 +/- SF. CONSTRUCTION EXISTING BLDG.							
Applicant Name: WARREN AVE DEVELOPMENT LLC & CHUNKY MONKEY LLC C/O CBRE BOULOS 1 CANAL PLAZA	Telephone: 207 871 1290 Email:						
City, State & Zip PORTLAND ME.	PURENECK@BOULOS.						
Contractor Name: SAME (if different from Applicant) Address:	Cost Of Work: \$\$316,716.00 C of O Fee: \$						
City, State & Zip:	Historic Rev \$						
Telephone & E-mail:	Total Fees:\$						
Current use (i.e. single family)WAREHOUSE If vacant, what was the previous use?WAREHOUSE Proposed Specific use:WAREHOUSE Is property part of a subdivision? If yes, please name Project description: WAREHOUSE TO REMAIN AS IS, ESFR SPRINKLER UPGRADE, OFFICE AREA TO BE EXPANDED +/- 960 SF; PLANS ATTACHED							
Who should we contact when the permit is ready: PAUL URENECK							
City, State & Zip: 1 CANAL PLAZA PORTLAND ME							
ОМ	9						
2	φ.						
	Applicant Name: WARREN AVE DEVELOPMENT LLC & CHUNKY MONKEY LLC C/O CBRE BOULOS 1 CANAL PLAZA City, State & Zip PORTLAND ME. Contractor Name: SAME (if different from Applicant) Address: City, State & Zip: Telephone & E-mail: HOUSE VAREHOUSE S, please name PRINKLER UPGRADE, OFFICE NS ATTACHED ady: PAUL URENECK AND ME DM						

Please submit all of the information outlined on the applicable checklist. Failure to do so causes an automatic permit denial.

In order to be sure the City fully understands the full scope of the project, the Planning and Development Department may request additional information prior to the issuance of a permit. For further information or to download copies of this form and other applications visit the Inspections Division on-line at www.portlandmaine.gov, or stop by the Inspections Division office, room 315 City Hall or call 874-8703.

I hereby certify that I am the Owner of record of the named property, or that the owner of record authorizes the proposed work and that I have been authorized by the owner to make this application as his/her authorized agent. I agree to conform to all applicable laws of this jurisdiction. In addition, if a permit for work described in this application is issued, I certify that the Code Official's authorized representative shall have the authority to enter all areas covered by this permit at any reasonable hour to enforce the provisions of the codes applicable to this permit.

	1	1					
Signature:	KARRU		nevel	N	Date:	12.22.14	
	10000						

This is not a permit; you may not commence ANY work until the permit is issued.







Reviewed for Code Complianc Inspections Division Approved with Conditions

From Designer:	David Graham, ARC	3113 Date:		
Date:	December 17, 2014	Date.		
Job Name:	American Tire Distribu	ution		
Address of Construction:	765 Warren Avenue	1 - 10 - 10 - 10 - 10 - 10 - 10 - 10 -		
Constr	2009 International luction project was designed to the	Building Code e building code criteria listed below:		
Building Code & Year 2009	Use Group Classification	(s) STORAGE (S-1) & Business (B)		
Type of Construction 2 (B)		(/		
	ression system in Accordance with Se	ection 903.3.1 of the 2009 IBC YES		
Is the Structure mixed use? Yes		rated or non separated (section 302.3) Separated		
Supervisory alarm System? YFS	Geotecnnical/Soils report rec	quired? (See Section 1802.2)NA		
Structural Design Calculations		Live load reduction		
Submitted for all str	uctural members (106.1 – 106.11)	Roof live loads (1603.1.2, 1607.11)		
		Roof snow loads (1603.7.3, 1608)		
Design Loads on Construction I Uniformly distributed floor live loads (Ground snow load, Pg (1608.2)		
	oads Shown	If Pg > 10 psf, flat-roof snow load pr		
		If $Pg > 10$ psf, snow exposure factor, C		
F10.		If $Pg > 10$ psf, snow load importance factor, I_k		
2		Roof thermal factor, ((1608.4)		
		Sloped roof snowload, P ₃ (1608.4)		
Wind loads (1603.1.4, 1609)		Seismic design category (1616.3)		
Design option utilized	(1609.1.1, 1609.6)	Basic seismic force resisting system (1617.6.2) Response modification coefficient, Rt and		
Basic wind speed (1809	.3)			
Building category and	wind importance Factor, _{Lu} table 1604.5, 1609.5)	deflection amplification factor C_{I} (1617.6.2)		
Wind exposure categor	ry (1609.4)	Analysis procedure (1616.6, 1617.5)		
Internal pressure coefficient	ent (ASCE 7)	Design base shear (1617.4, 16175.5.1)		
	pressures (1609.1.1, 1609.6.2.2)	Flood loads (1803.1.6, 1612)		
Main force wind pressure		Flood Hazard area (1612.3)		
Earth design data (1603.1.5, 1614-		Elevation of structure		
Design option utilized		Other loads		
Seismic use group ("Ca		Concentrated loads (1607.4)		
2	ficients, SDs & SD1 (1615.1)	Partition loads (1607.5)		
Site class (1615.1.5)		Misc. loads (Table 1607.8, 1607.6.1, 1607.7, 1607.12, 1607.13, 1610, 1611, 2404		





Accessibility Building Code Certificate Date:

Reviewed for Code Compliance Inspections Division Approved with Conditions

oate: 02/03/1

Designer:	David Graham, ARC 3113
Address of Project:	765 Warren Avenue
Nature of Project:	Renovate and expand existing warehouse office space
& ~	Install new ESFR sorinkler system in existing warehouse.

The technical submissions covering the proposed construction work as described above have been designed in compliance with applicable referenced standards found in the Maine Human Rights Law and Federal Americans with Disability Act. Residential Buildings with 4 units or more must conform to the Federal Fair Housing Accessibility Standards. Please provide proof of compliance if applicable.



For more information or to download this form and other permit applications visit the Inspections Division on our website at www.portlandmaine.gov



Reviewed for Code Compliance Inspections Division Approved with Conditions

Date: 02/03/15



Certificate of Design

Date:	December 17, 2014	
From:	David Graham	
These plans and / o	or specifications covering construction work on:	
Proposed ware	rehouse office renovation	
at 765 Warren	n Avenue, Portland Maine	

Have been designed and drawn up by the undersigned, a Maine registered Architect / Engineer according to the 2009 International Building Code and local amendments.



For more information or to download this form and other permit applications visit the Inspections Division on our website at www.portlandmaine.gov