



DECK / JOIST DETAIL SCALE: 1"=1'-0

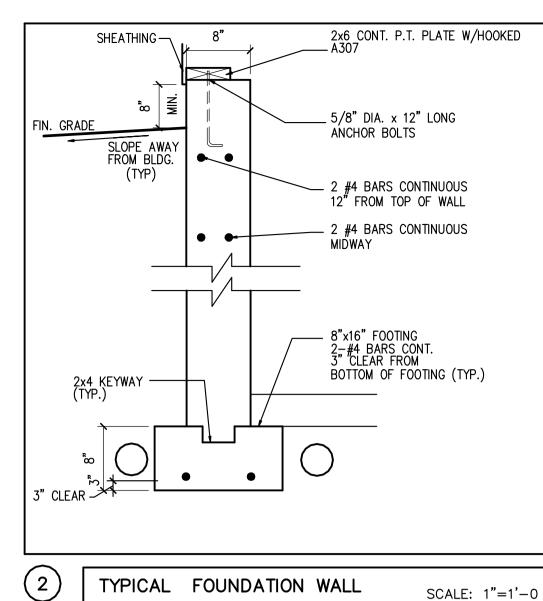

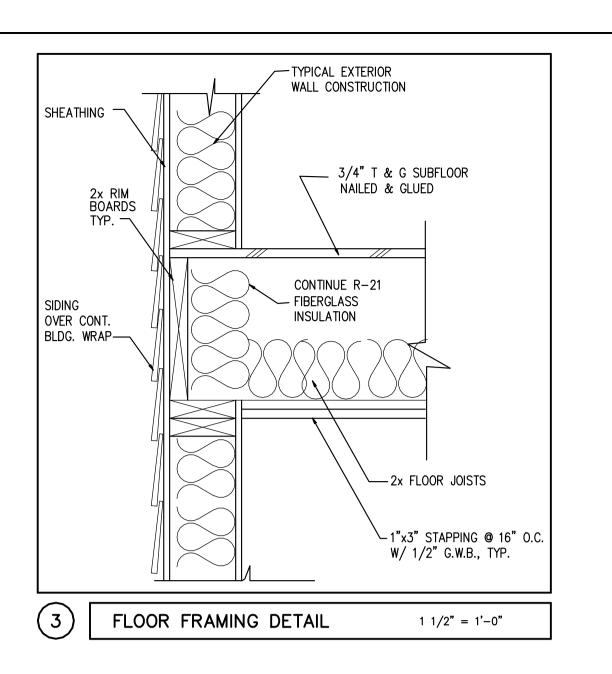

GENERAL NOTES:

- 1. All work shall be in accordance with IRC 2009, IBC Basic Building Code, NFI Maine State Plumbing Code, ASHRAE, U.L., NFPA Codes and all local, State ar 2. All required City and State permits must be obtained before any constructions.
- All required City and State permits must be obtained before any constructi
 Structural, Mechanical, Electrical and Plumbing design and installation by ot performed in accordance with local, State and Federal standards.
- 4. Seal all openings & mechanical penetrations with approved fire safing mate5. Building shall have approved smoke detectors in accordance with NFPA-101




Inspections Division


Date: 10/10/14

HEADER SC	HEDULE
ROUGH OPENING	HEADER SIZE
0 - 3'-0" 3'-1" - 4'-6" 4'-7" - 5'-8"	(3) - 2x6 (3) - 2x8 (3) - 2x10
5'-9" - 7'-0"	(3) - 2x12


NOTE: PROVIDE JAMBS BOTH ENDS AS FOLLOWS:
2x6 JACK PLUS 2x6 KING UP TO 4'-6" ROUGH OPENING
(2) 2x6 JACKS PLUS (2) 2x6 KINGS UP TO 7'-0" ROUGH OPENING

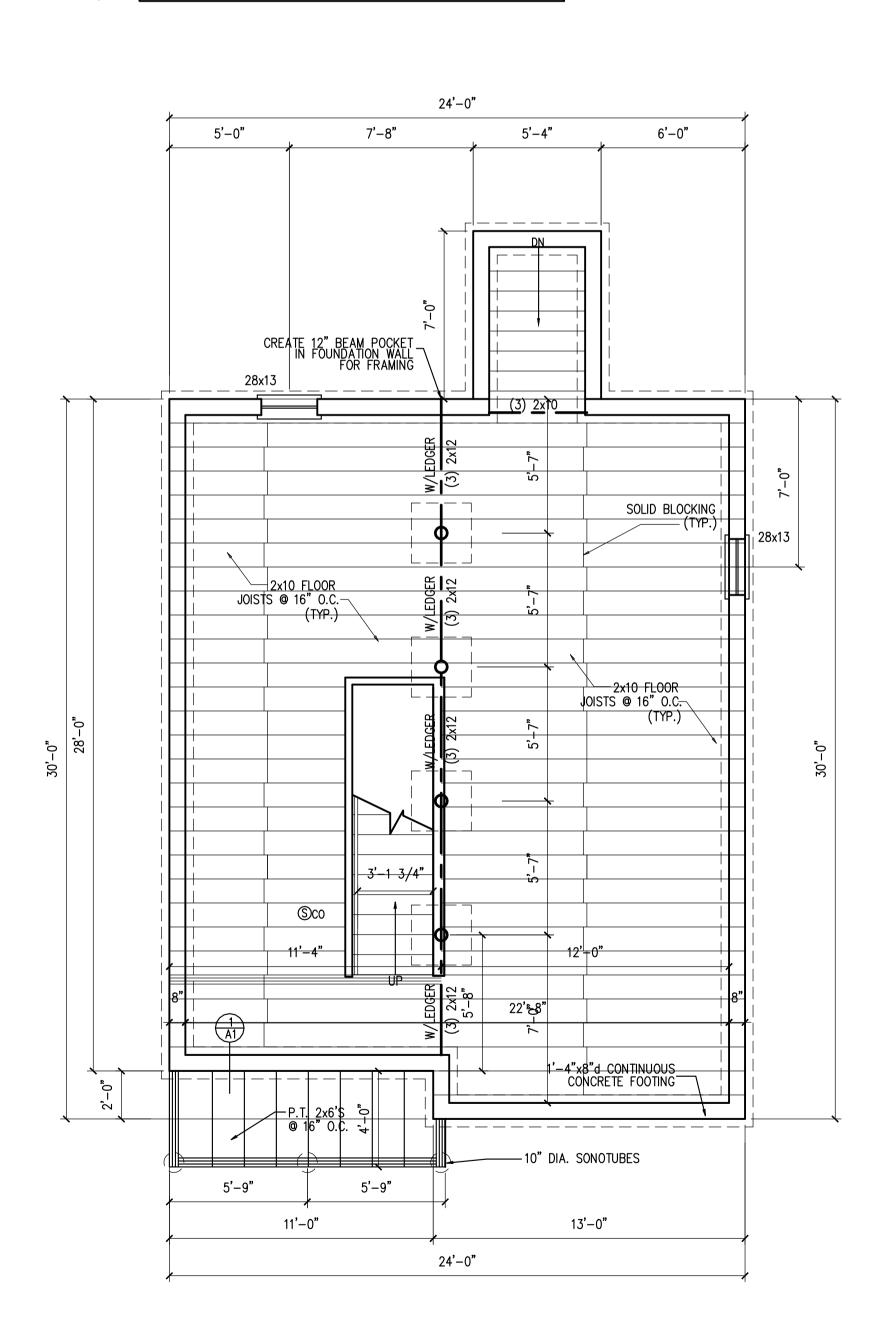

FOUNDATION/FRAMING PLAN
SCALE:1/4"=1'-0"

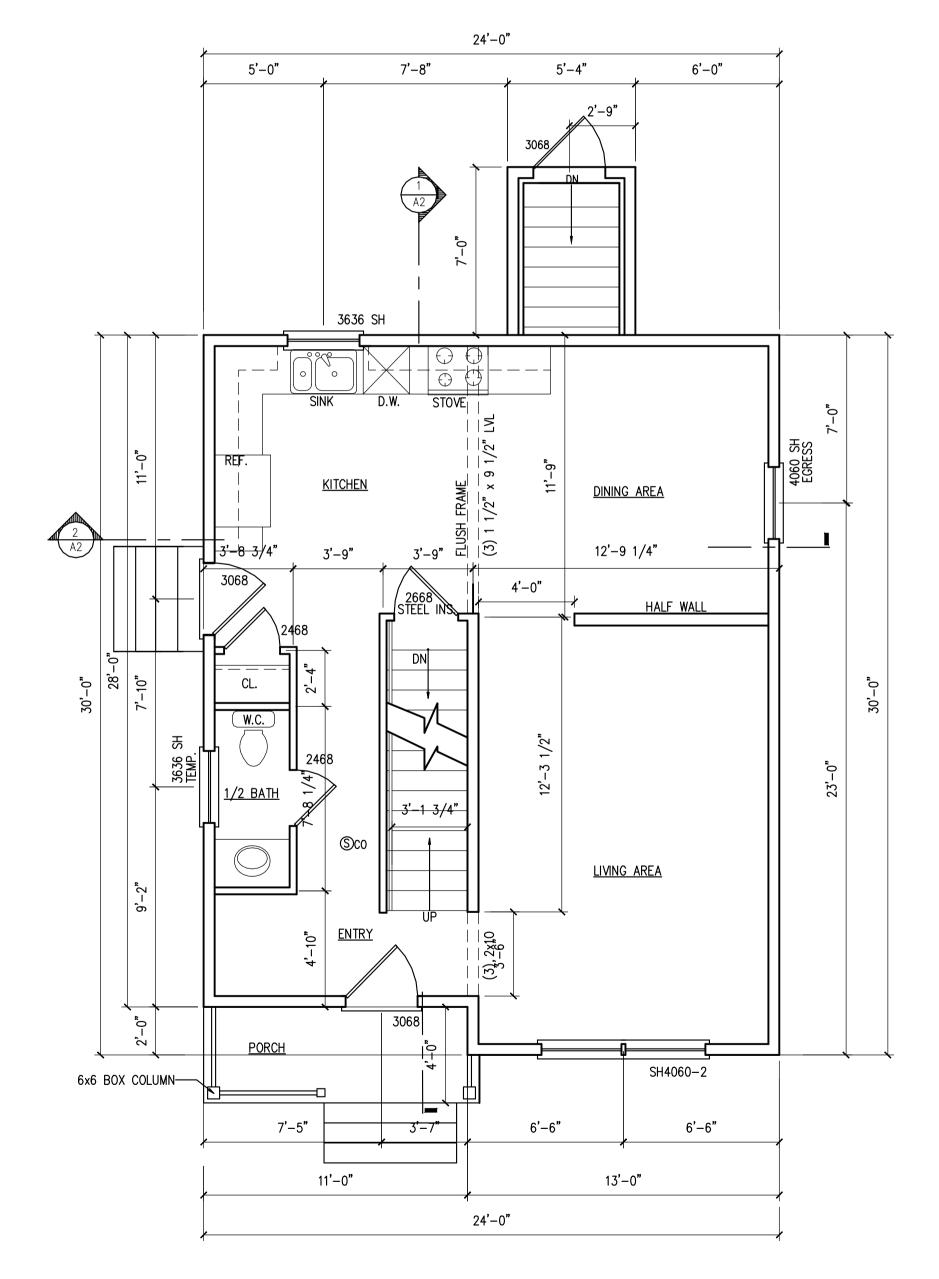

FIRST FLOOR PLAN
698 S.F. SCALE :1/4"=1'-0"

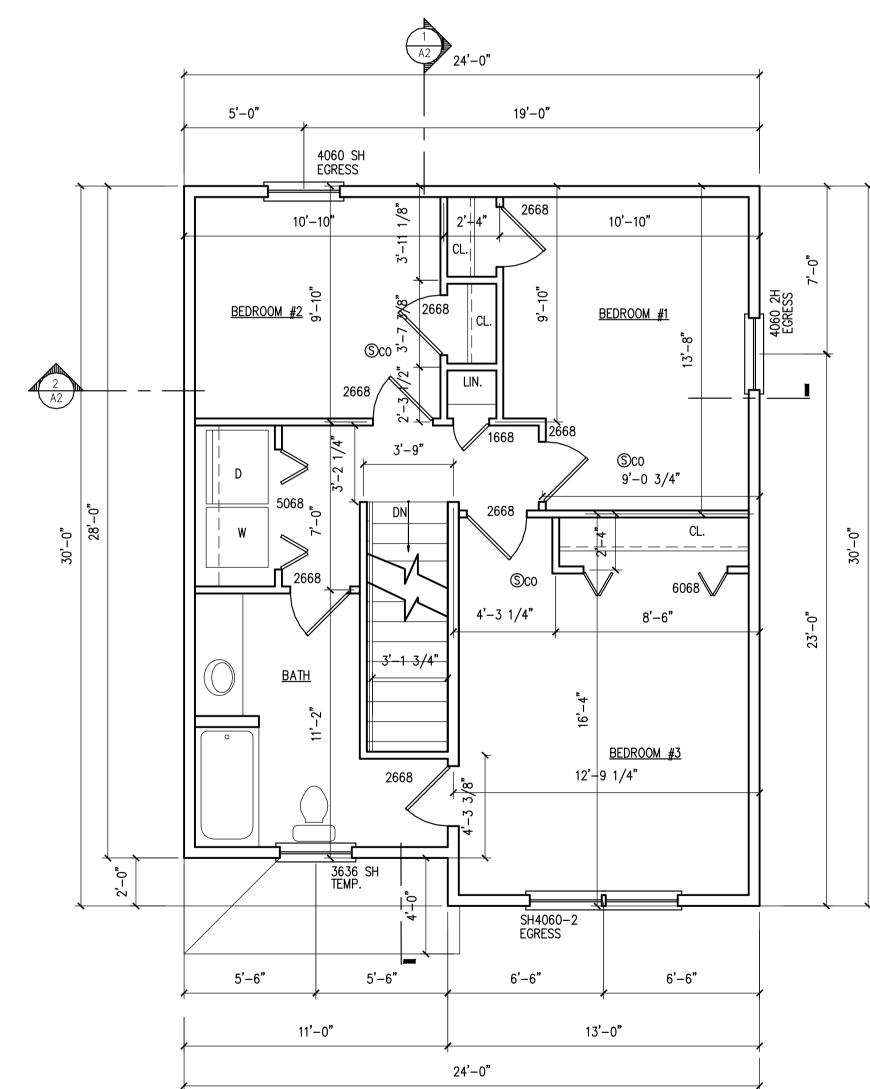


SECOND FLOOR PLAN
698 S.F. SCALE:1/4"=1'-0"


A

24x30 COLONIAL PORTLAND, MAINE

FOUNDATION/FRAMING PLAN
FIRST FLOOR PLAN
SECOND FLOOR PLAN
DETAILS

09/08/14

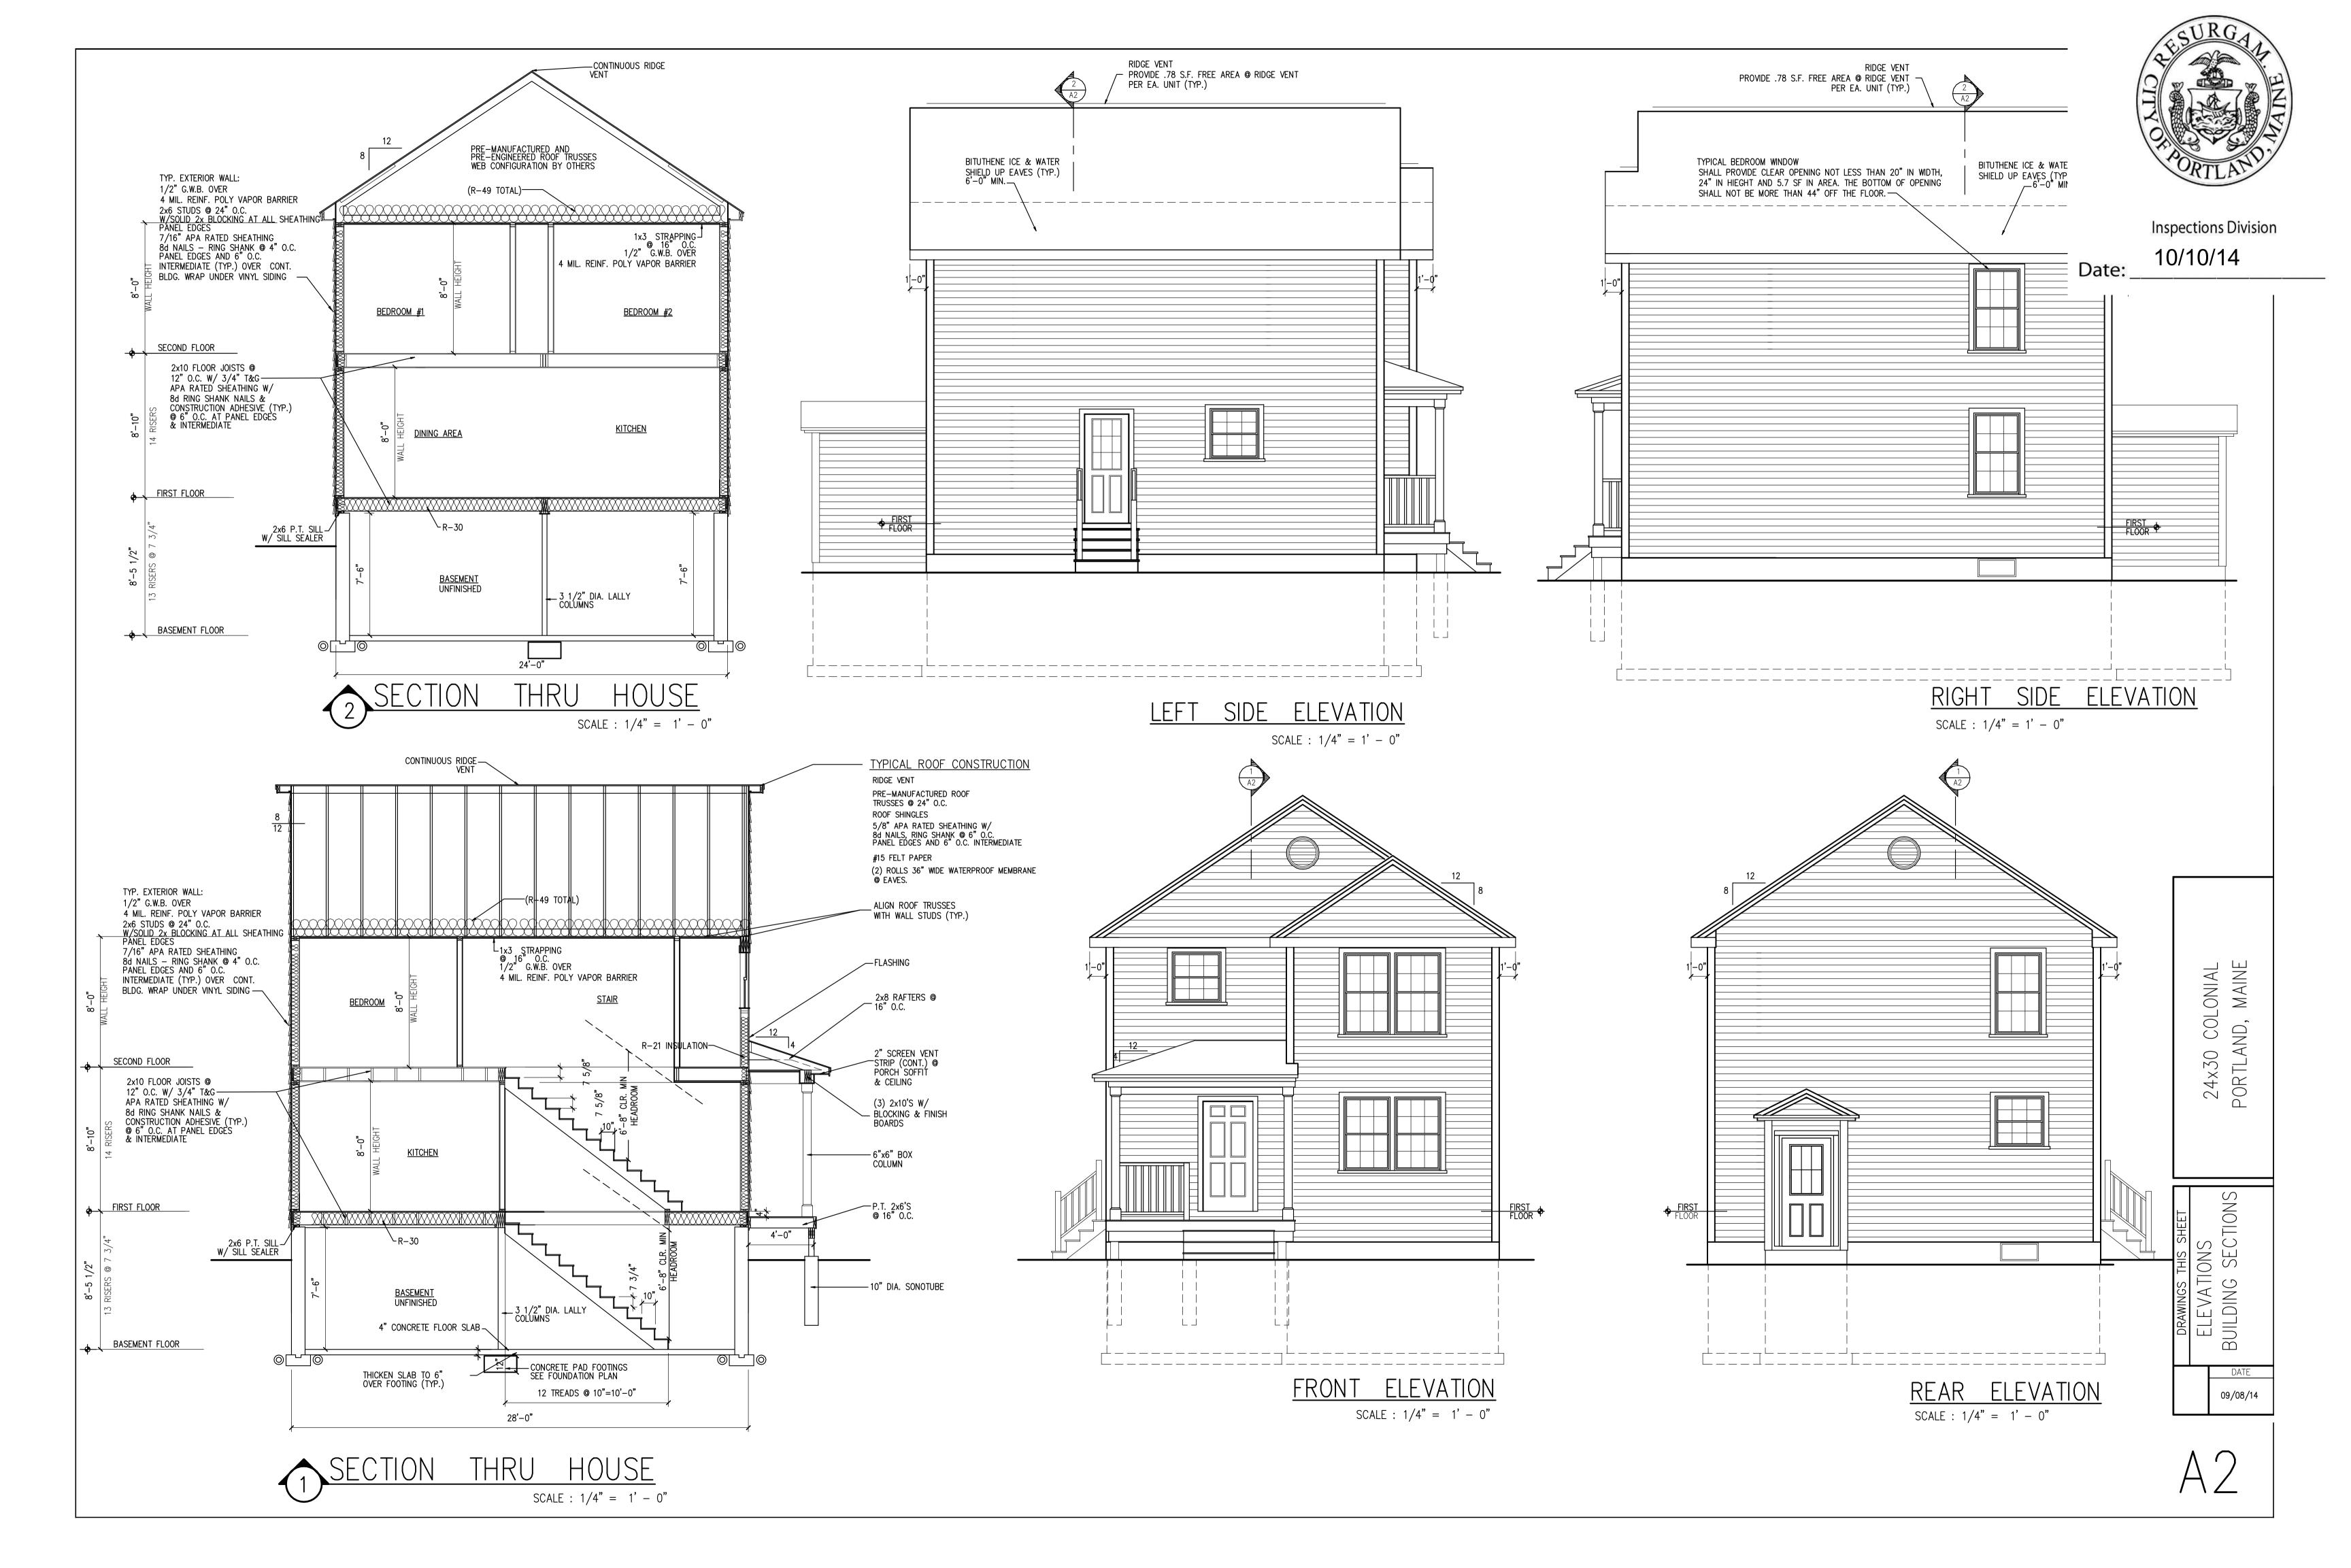

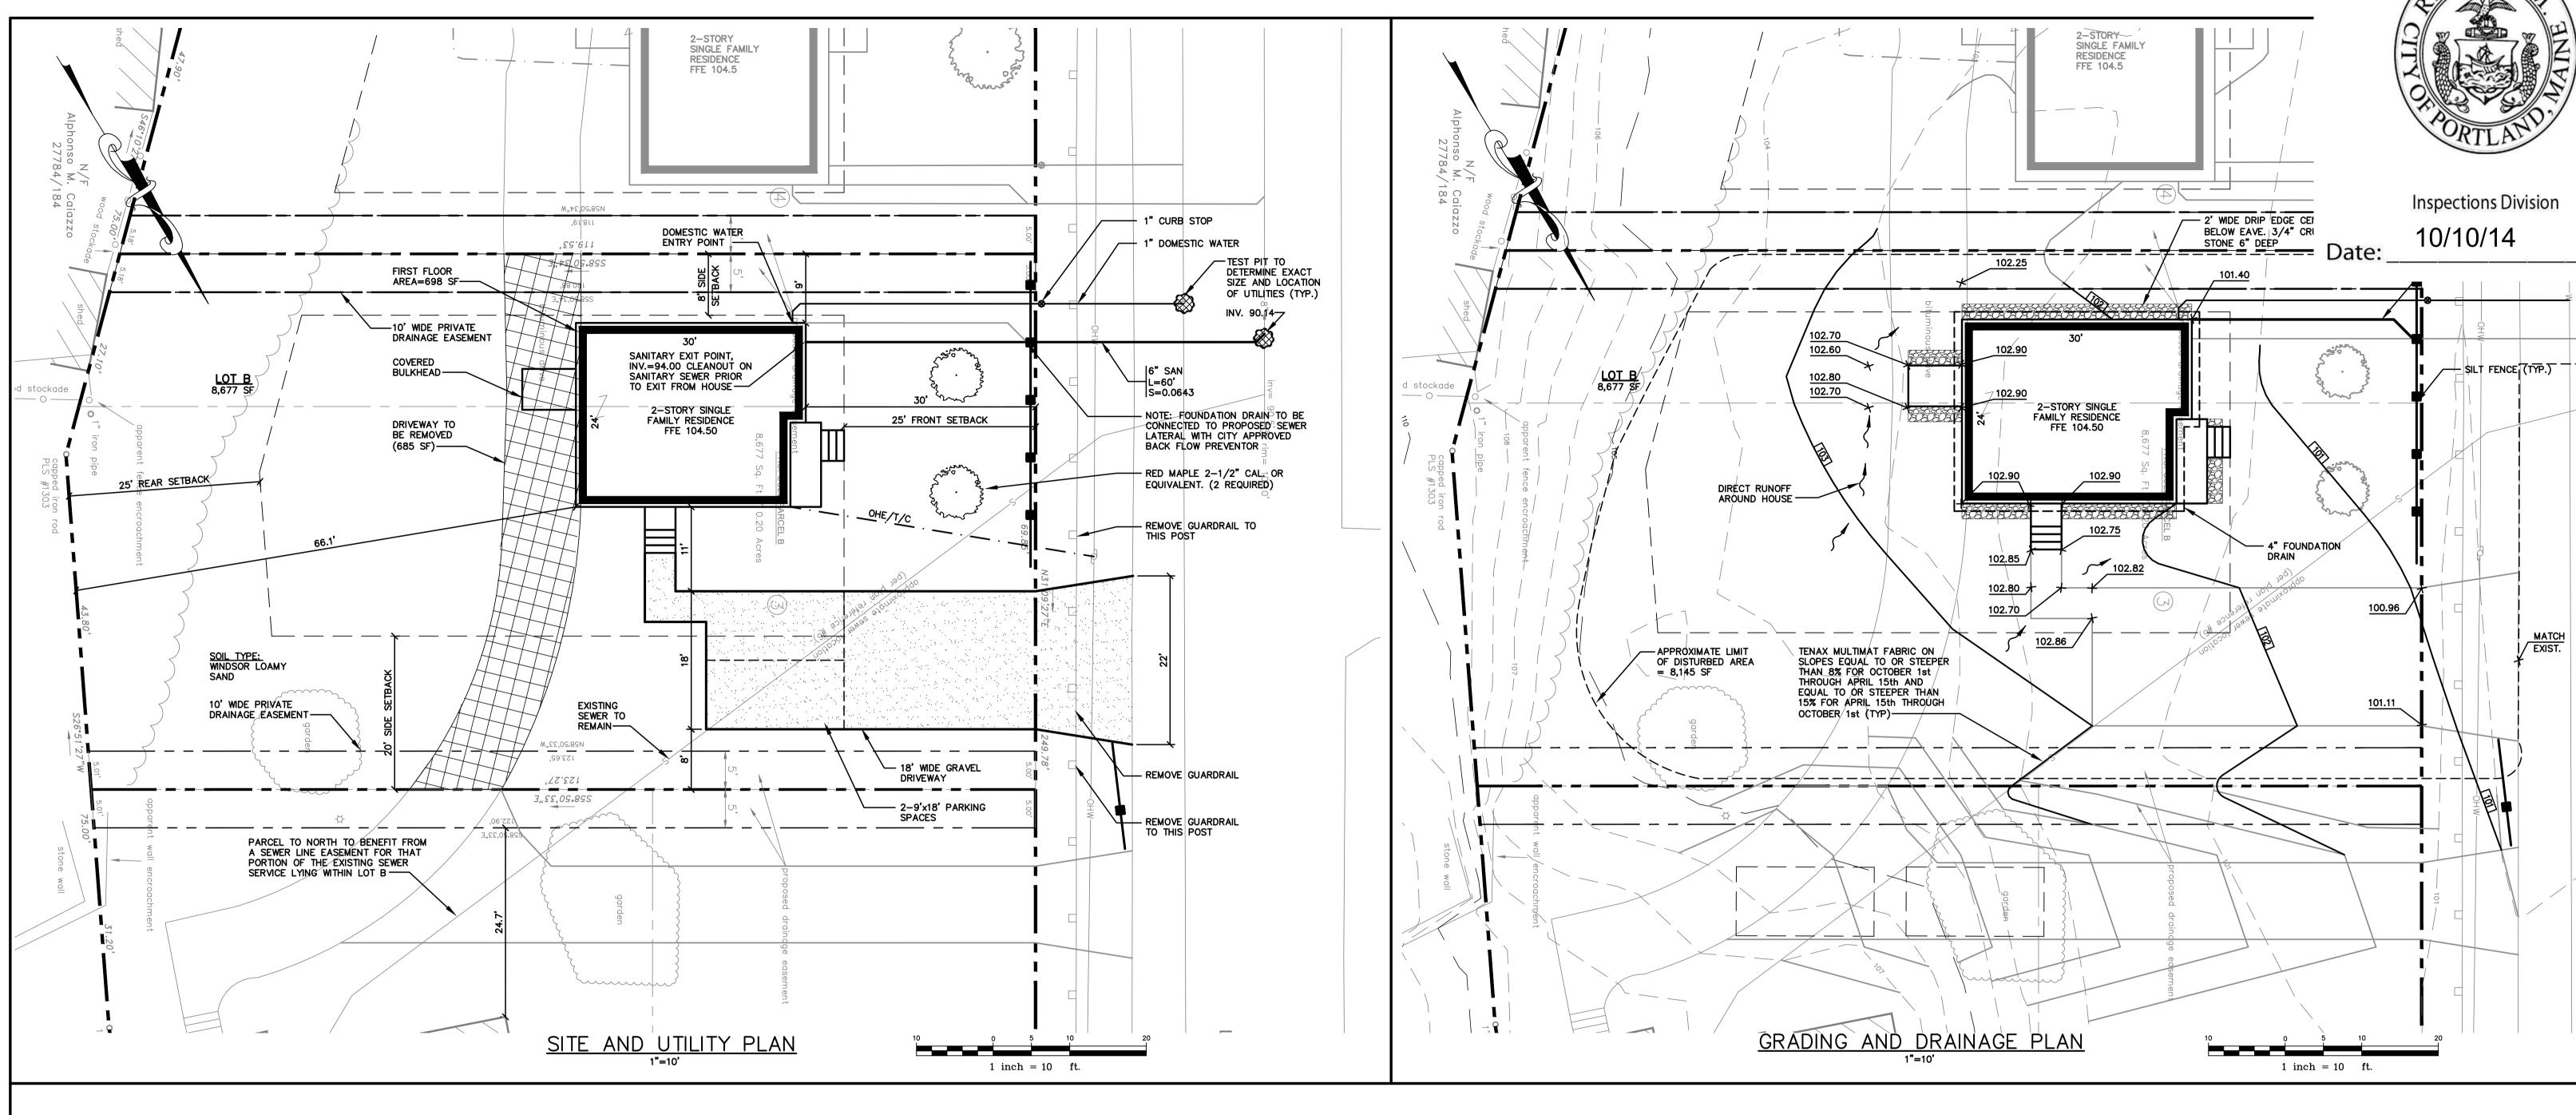

SPACE AND BULK REQUIREMENTS - R3 ZONE

MINIMUM LOT SIZE: 6,500 S.F. MINIMUM FRONTAGE: 50 FT. MINIMUM SETBACKS: FRONT YARD REAR YARD 25 FT SIDE YARD* 1 STORY 1 1/2 STORY 8 FT. 2 STORY 14 FT. 2 1/2 STORY MINIMUM LOT WIDTH: 65 FT. OTHER USES:

* THE WIDTH OF ONE (1) SIDE YARD MAY BE REDUCED ONE (1) FOOT FOR EVERY FOOT THAT THE OTHER SIDE YARD IS CORRESPONDINGLY INCREASED, BUT NO SIDE YARD SHALL BE LESS THAN EIGHT (8) FEET IN WIDTH.

GRADING AND DRAINAGE NOTES:

FURTHER APPROVAL FROM THE PLANNING AUTHORITY.

1. ALL DISTURBED AREAS THAT ARE NOT PAVED SHALL RECEIVE 4" LOAM &

COMMON BORROW SHALL MEET MDOT SPECIFICATION 703.18.

3. THE GRADING AND DRAINAGE SYSTEM ON THE PROPERTY SHALL BE CONSTRUCTED AND LOCATED AS DEPICTED ON THE APPROVED SITE PLAN AND SAID GRADING AND DRAINAGE SYSTEM SHALL NOT BE MODIFIED WITHOUT

GENERAL NOTES

1. TOPOGRAPHIC DATA AND EXISTING CONDITIONS ARE BASED UPON A GROUND SURVEY CONDUCTED BY TITCOMB SURVEY IN 2014.

2. THE CONTRACTOR IS SPECIFICALLY CAUTIONED THAT THE LOCATION AND/OR THE ELEVATION OF THE EXISTING UTILITIES AS SHOWN ON THESE PLANS IS BASED ON RECORDS OF THE VARIOUS UTILITY COMPANIES AND WHERE POSSIBLE MEASUREMENTS TAKEN IN THE FIELD. THIS INFORMATION IS NOT TO BE RELIED ON AS BEING EXACT OR COMPLETE. THE CONTRACTOR MUST CALL THE APPROPRIATE UTILITY COMPANY AND DIG SAFE AT LEAST 72 HOURS PRIOR TO ANY EXCAVATION TO REQUEST EXACT FIELD LOCATION OF UTILITIES. IT SHALL BE THE RESPONSIBILITY OF THE CONTRACTOR TO RELOCATE ALL EXISTING UTILITIES WHICH CONFLICT WITH THE PROPOSED IMPROVEMENTS SHOWN ON THE PLANS.

3. MAINTENANCE OF EROSION CONTROL MEASURES IS OF PARAMOUNT IMPORTANCE TO THE OWNER AND THE CONTRACTOR IS RESPONSIBLE FOR COMPLYING WITH ALL EROSION CONTROL MEASURES SHOWN ON THE PLANS. ADDITIONAL EROSION CONTROL MEASURES SHALL BE INSTALLED IF DEEMED NECESSARY BY ON—SITE INSPECTIONS OF THE OWNER OR THEIR REPRESENTATIVES AT NO ADDITIONAL COST TO THE OWNER.

STANDARDS. DISINFECTION OF WATER LINES SHALL CONFORM TO AWWA STANDARD C651, LATEST REVISION.

5. ALL SEWER MATERIALS SHALL CONFORM TO THE REQUIREMENTS OF THE CITY OF PORTLAND TECHNICAL AND DESIGN STANDARDS AND GUIDELINES.

4. ALL WATER UTILITY MATERIALS AND INSTALLATION METHODS SHALL CONFORM TO PORTLAND WATER DISTRICT

6. ALL MATERIALS AND CONSTRUCTION METHODS SHALL CONFORM TO MAINE DEPARTMENT OF TRANSPORTATION

SPECIFICATIONS. AND CITY OF PORTLAND TECHNICAL AND DESIGN STANDARDS AND GUIDELINES.

7. LOT OWNER IS RESPONSIBLE FOR LAYOUT AND EXTENSION OF ELECTRIC SERVICE, COORDINATE WITH CMP.

8. THE LOT SHALL BE PROVIDED WITH AT LEAST TWO (2) TREES MEETING THE CITY'S ARBORICULTURE SPECIFICATIONS AND WHICH ARE CLEARLY VISIBLE FROM THE STREET LINE AND ARE LOCATED SO AS TO VISUALLY WIDEN THE NARROW DIMENSION OR PROPORTION OF THE UNIT.

9. SEWER AND WATER SERVICES SHALL BE INSTALLED BY THE DEVELOPER 5' INTO THE PROPERTY. CONNECTION

TO THE HOUSE WILL BE THE RESPONSIBILITY OF THE LOT OWNER.

10. EQUIVALENT STREET TREE SHALL INCLUDE RETENTION OF EXISTING TREES OF SAME OR GREATER CALIPER.

11. ALL WORK SHALL BE DONE IN CONFORMANCE WITH THE CITY OF PORTLAND TECHNICAL STANDARDS, SECTION

12. ANY CURBING REMOVED WITHIN THE RIGHT-OF-WAY IS THE PROPERTY OF THE CITY OF PORTLAND AND SHALL BE DELIVERED TO THE PUBLIC WORKS FACILITY ON OUTER CONGRESS STREET.

VIII EROSION AND SEDIMENTATION CONTROL STANDARDS FOR SINGLE AND TWO FAMILY HOMES.

13. SECTION 14-425 OF THE LAND USE CODE STATES: ANY YARD MAY BE OCCUPIED BY A ONE-STORY ENTRANCE PORCH NOT ENCLOSED, WITH OR WITHOUT A ROOF, IF THE AREA OF THE PORCH DOES NOT EXCEED FIFTY SQUARE FEET, NOR THE PROJECTION FROM THE BUILDING EXCEED SIX FEET.

NOTE: THIS PLAN SET IS ISSUED FOR PERMITTING PURPOSES AND SHALL NOT BE USED FOR CONSTRUCTION.

4	
Ψ	
e e	
Poy Date Poyician	
Rev. Date Revision	

1			
	CITY REVIEW	9/25/14	AMP
	Issued For	Date	Ву
•			

Design: JWA	Draft: CG	Date: SEPT 2014
Checked: DER	Scale: 1"=10'	Job No.: 2929
File Name: 2929-p	base-3-lots.dwg	
This plan shall permission from		
Engineers, Inc.(
authorized or o	therwise, shall b	e at the user's

GP	Gorrill-Palmer	Consulting	Engineers, Inc.
	Fnaineerina Ercellence		207-657-6910

PO Box 1237	Engineering	Excellence	Since	1998	207-657-6910
15 Shaker Road	o o				FAX: 207-657-6912
Gray, ME 04039					E-Mail: mailbox@gorrillpalmer.com

Drawing Name:	Site, Utility, Grading and Drainage Plans
Project:	Lane Avenue
	Portland, Maine
Client:	Divesified Properties
	P.O. Box 10127, Portland, Maine 04104

Drawing No.

