





DEPT. OF BUILDING INSPECTION CITY OF PORTLAND, ME			Traditional 2"x10" or 2"x8" framing TBD onsite by builder and/or site engineer.	
RESIDENCE	Conceptual Plans for: Garage/Office Addition	FRAMING Scale: 3/16" = 1' - 0"	It is the responsibility of the owner(s) and/or contractor to verify all dimensions and structural design prior to proceeding with construction	
	PT. OF BUILDING INSPECTION CITY OF PORTLAND. ME DONELSON RESIDENCE	CITY OF BUILDING INSPECTION NE TONELSON RESIDENCE Portland Maine	CONELSON Conceptual Plans for:	PT OF BUILDING INSPECTION Traditional 2"x10" TBD onsite by builder and/or site engineer. PONELSON RESIDENCE Portland Maine

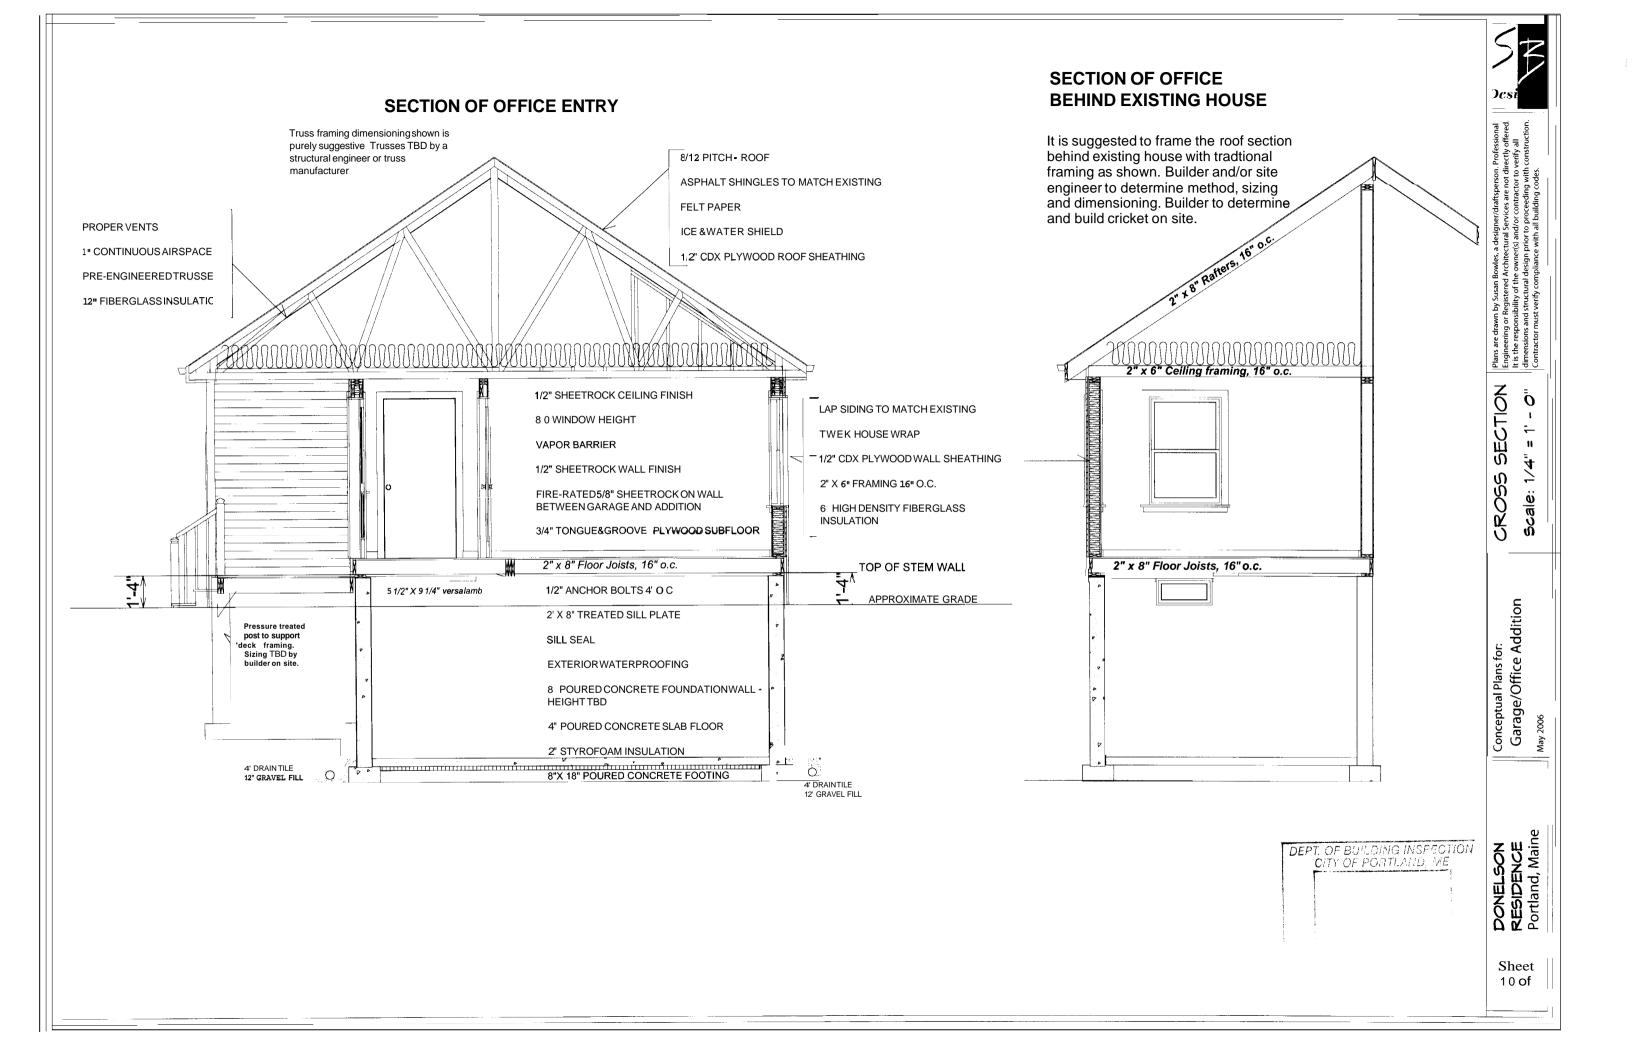


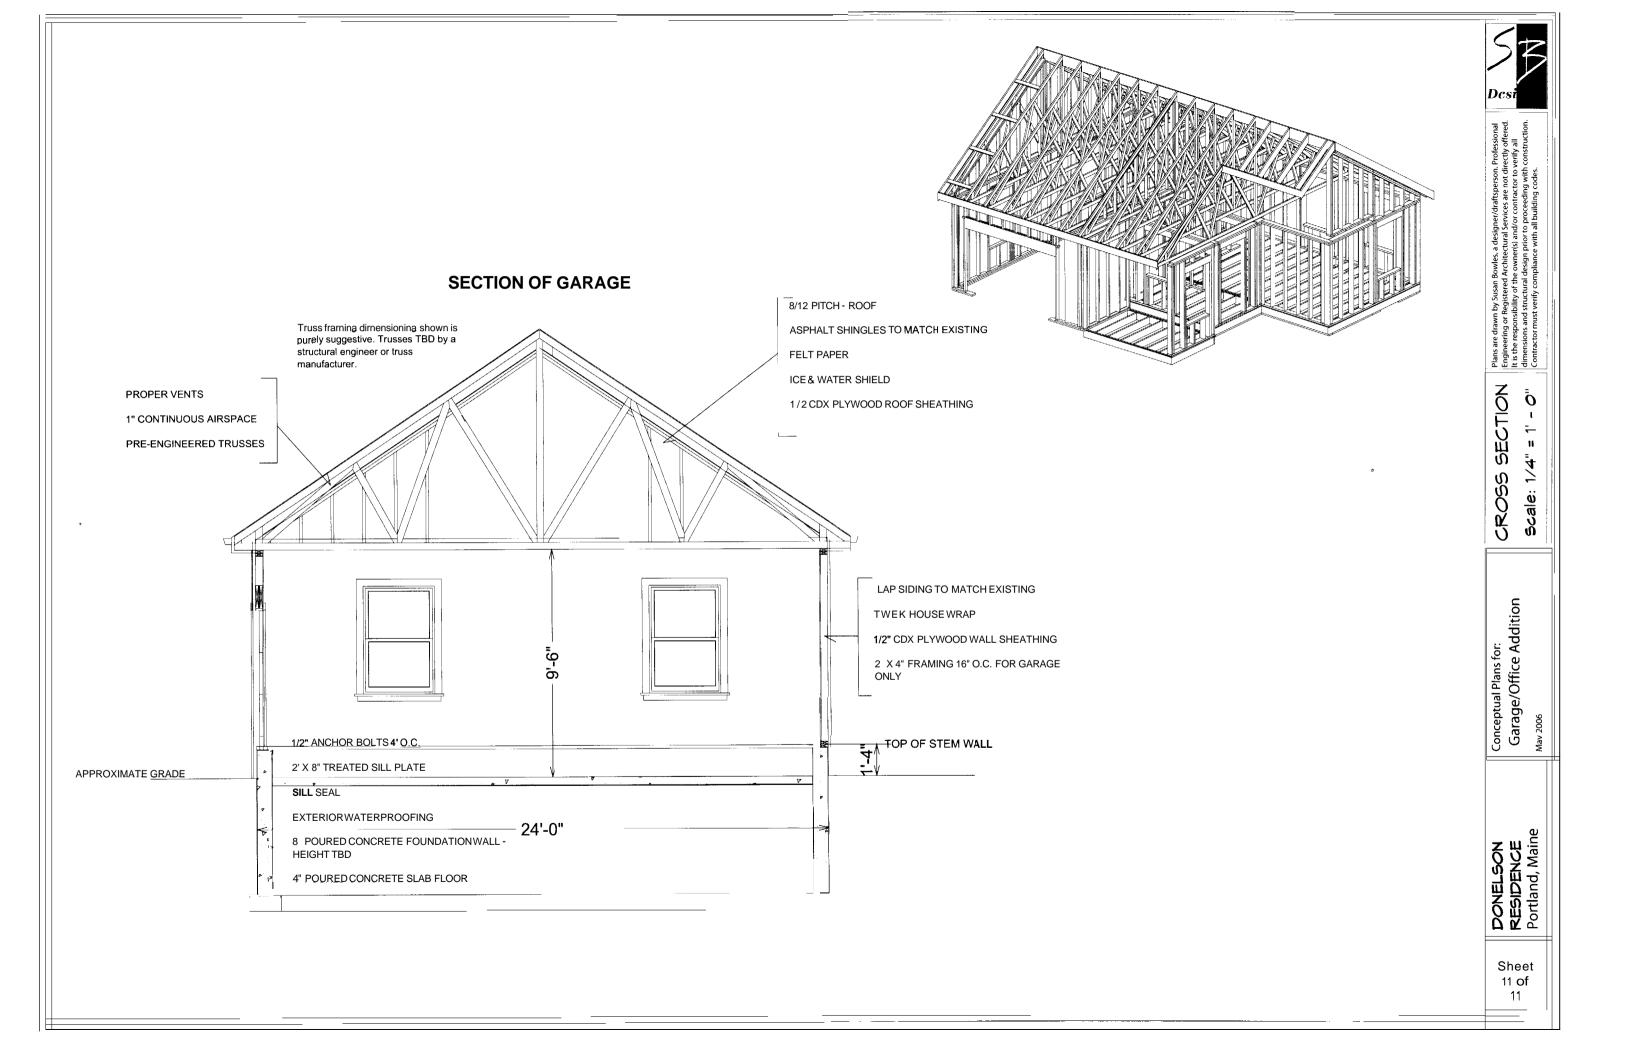

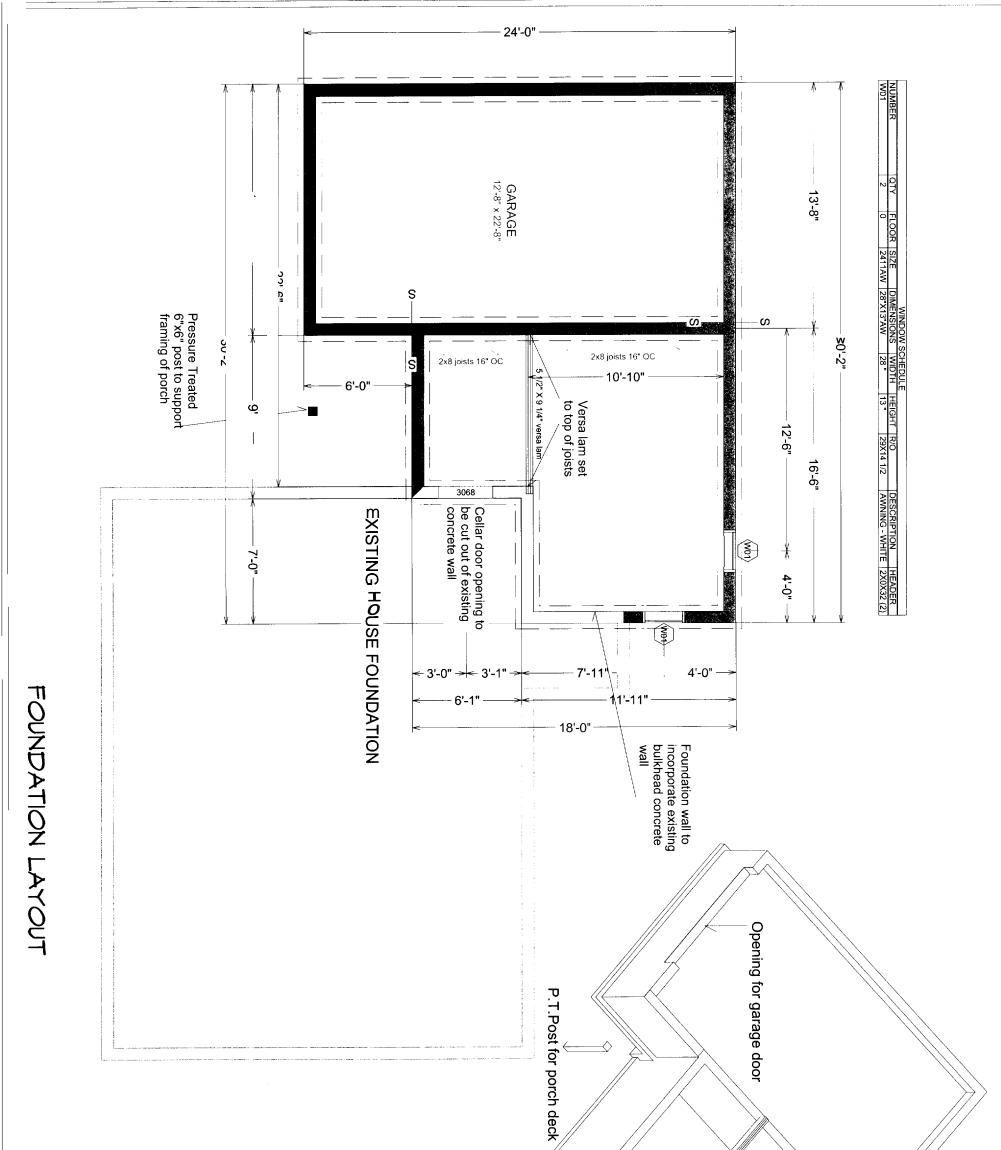


Sheet 6 of 11	DONELSON RESIDENCE Portland, Maine	Conceptual Plans for: Garage/Office Addition May 2006	FLOOR PLAN5 Scale: 3/16" = 1' - 0"	Plansare drawn by Susan Bowles, a designer/draftsperson. Professional Engineering or Registered Architectural Services are not directlyoffered. It is the responsibilityofthe owner(s) and/or contractor to verify all dimensions and structural design prior to proceeding with construction. Contractor must verify compliance with all building codes.	D _{cst}
RECEIVED	DEPT. OF BUILDING INSPECTION CITY OF PORTLAND, ME			Opening in stem wall for door top of sill	

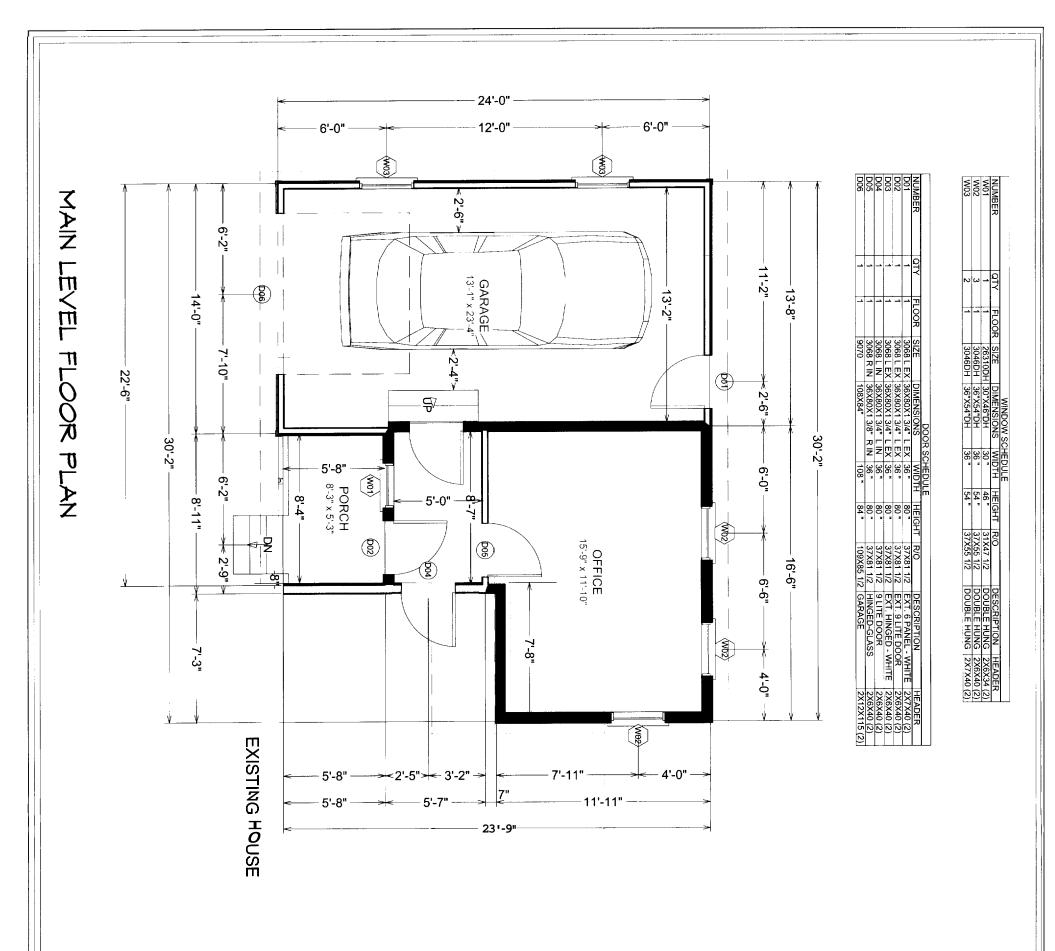


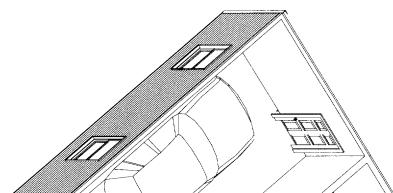

DEPT. OF BUILDING IMSPECTION CITY OF PORTLAND, ME			
DONELSON RESIDENCE Portland, Maine	Conceptual Plans for: Garage/Office Addition May 2006	FLOOR PLANS Scale: 3/1 ^{6''} = 1' - 0''	Plansare drawn by Susan Bowles. a designer/draftsperson. Professional Engineering or Registered Architectural Services are not directly offered. It is the responsibility of the owner(s) and/or contractor to verify all dimensionsand structural design prior to proceeding with construction. Contractor must verify compliance with all building codes.

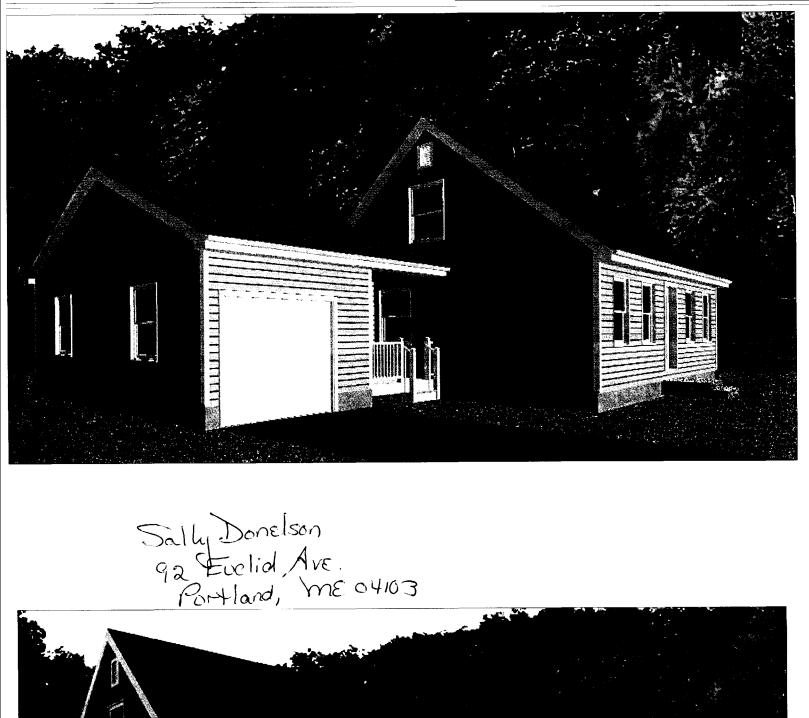



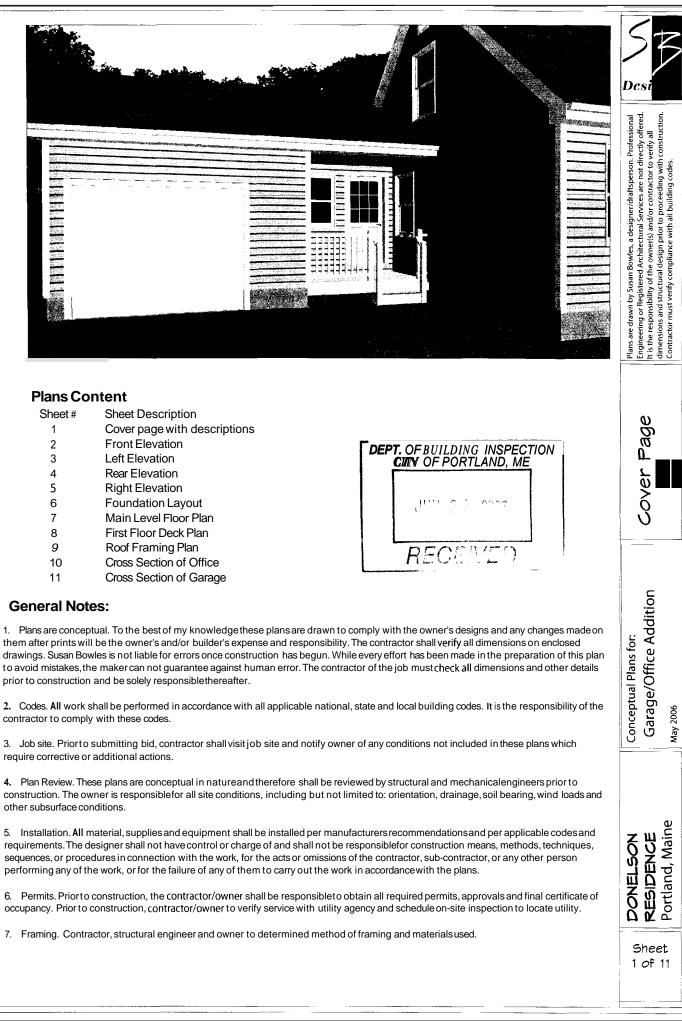

General Notes:

prior to construction and be solely responsible thereafter.

contractor to comply with these codes.

require corrective or additional actions.

other subsurface conditions.

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