

## LEGEND

\$5 REBAR WITH PLASTIC CAP STAMPED "NCS, INC PLS 1314" SET ON 12/29/2009 (UNLESS NOTED OTHERWISE) FOUND IRON PIPE (SIZE AS NOTED) FOUND IRON ROD FOUND CAPPED IRON ROD (NUMBER AS NOTED) UTILITY POLE WITH LIGHT (NUMBER AS NOTED) UTILITY POLE (NUMBER AS NOTED)

CONIFEROUS TREE (SIZE AND TYPE AS NOTED)

BOUNDARY LINE -----EDGE OF GRAVEL

EDGE OF PAVEMENT ABUTTER LINE OVERHEAD UTILITY

BRACKETS DENOTE RECORD DATA FROM PLANS

NOW OR FORMERLY OWNED BY DEED BOOK AND PAGE (CCRD) TAX MAP-BLOCK-LOT

## NOTES

- THE BASIS OF BEARING FOR THIS SURVEY IS MAINE STATE COORDINATE SYSTEM WEST ZONE (2 ZONE PROJECTION) GRID NORTH.
- DEED AND PLAN BOOK REFERENCES ARE TO THE CUMBERLAND COUNT REGISTRY OF DEEDS, (CCRD).
- RECORD OWNERSHIP OF THE PARCEL SURVEYED CAN BE FOUND IN THE FOLLOWING DEEDS:

   CITY OF PORTLAND TO JOHN & JOAN VANCE DATED AUGUST 13, 1965

   AND RECORDED IN DEED BOOK 2922, PAGE 550 (PARCELS 12 & 13).

d. CITY OF PORTLAND TO JOHN & JOAN VANCE DATED JUNE 21, 1973 AND RECORDED IN DEED BOOK 3418, PAGE 136 (PARCELS 10-12).

B. DANIEL DIPIETRO TO JOHN & JOAN VANCE DATED JUNE 27, 1964 AND RECORDED IN DEED BOOK 2833, PAGE 192 (PARCELS 4-11).

- REFERENCE IS MADE TO THE FOLLOWING PLANS:

  o. "MARREN AVENUE TERRACE" BY ERNEST W. BRANCH, C.E. DATED APRIL,
  1911 AND RECORDED IN PLAN BOOK 12, PAGE 2.
- INDEP 305, BLUCK C, PARCELS 4-15 & 17-26.

  HE PARCEL SURVEYED IS LOCATED IN THE 84 ZONE. PORTIONS OF BULK AND SPACE REQUIREMENTS ARE AS FOLLOWS:

  MINIMUM FRONTIAGE = 60°

  SETBACKS:

  FRONT = 20'

  SIGES:

  1-2 STORIES = 10'

  3- STORIES = 12'

  REAR = 20'

Subject to Dept. Conditions

3-22-2010

DRAWING NAME: 29968.DWG PROJECT: 29968.3 SCALE: 1"= 30"

BOUNDARY SURVEY/EXISTING CONDITIONS
3S5 WARREN AVENUE, PORTLAND, MAINE

JOHN VANCE 383 WARREN AVENUE, PORTLAND, MAINE 04103

JOHN VANCE
383 WARREN AVENUE, PORTLAND, MAINE 04103



SURVEYING ENGINEERING LAND PLANNING Northeast Civil Solutions 153 US ROUTE 1, SCARBOROUGH, MAINE 04074


DRAWN BY: JAP


fox s-mail 207.883.1001 Info@northe 207.883.1000 800.882.2227


STAMP AND SIGNATURE




IF THIS PLAN DOES NOT CONTAIN AN ELEGOSSED SEAL, IT IS NOT AN ORIGINAL AND MA

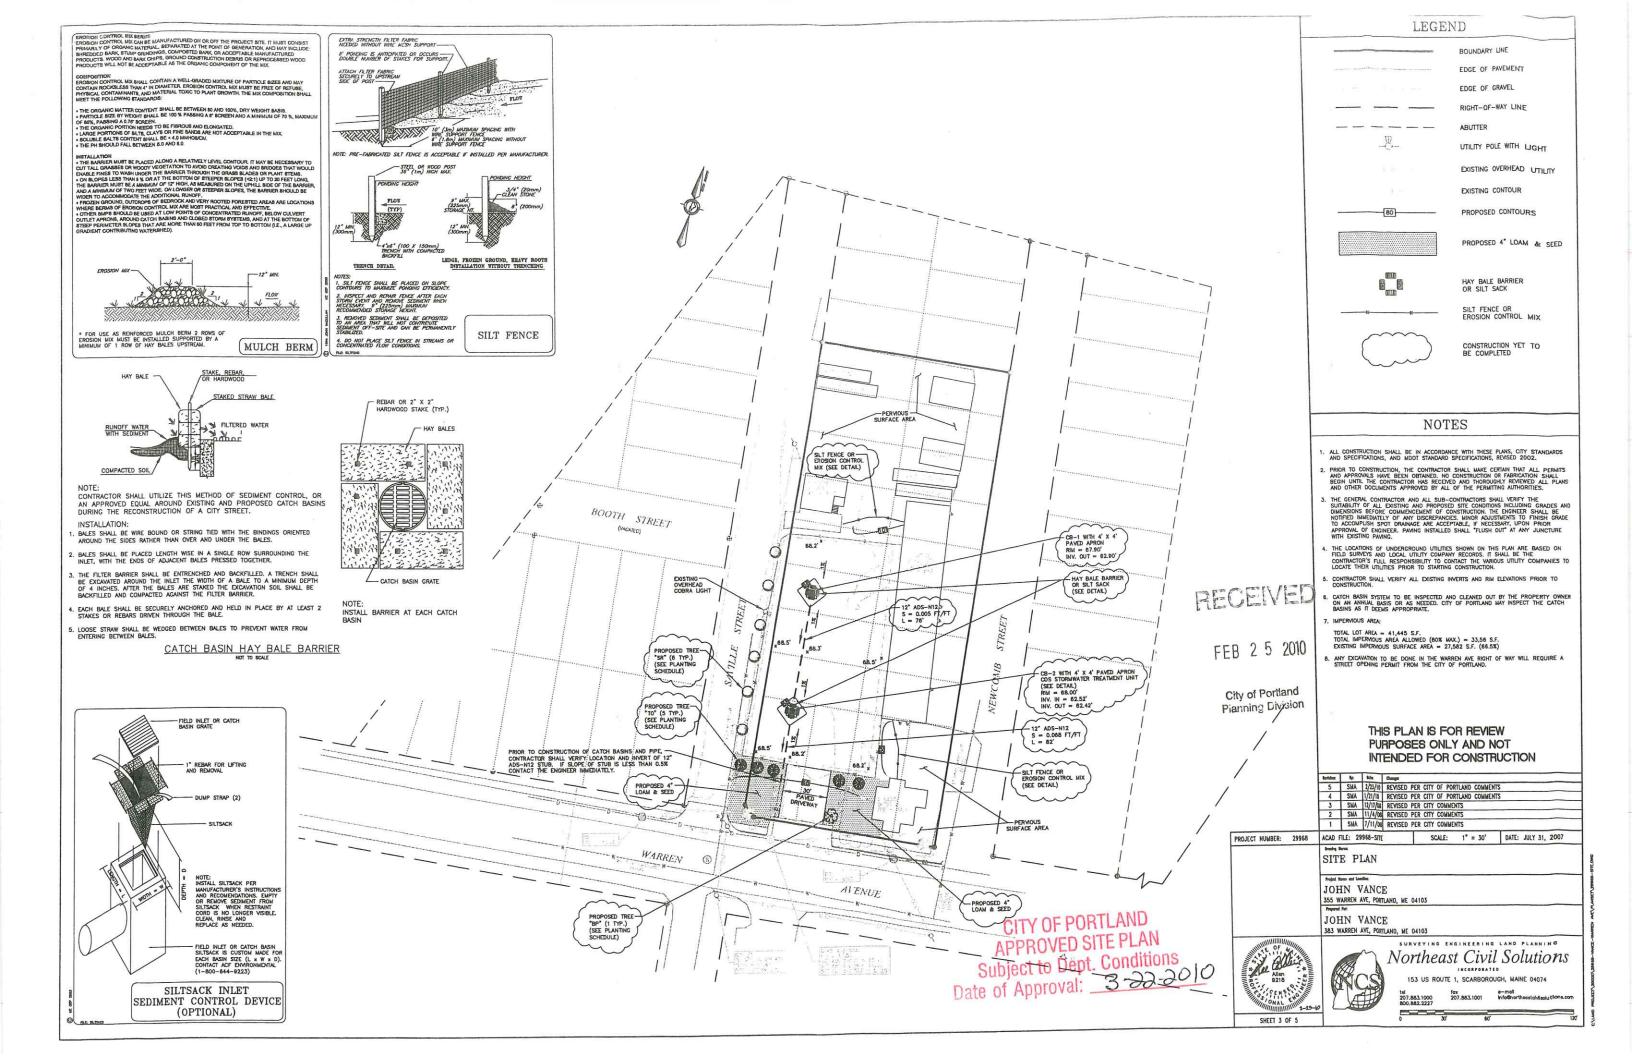


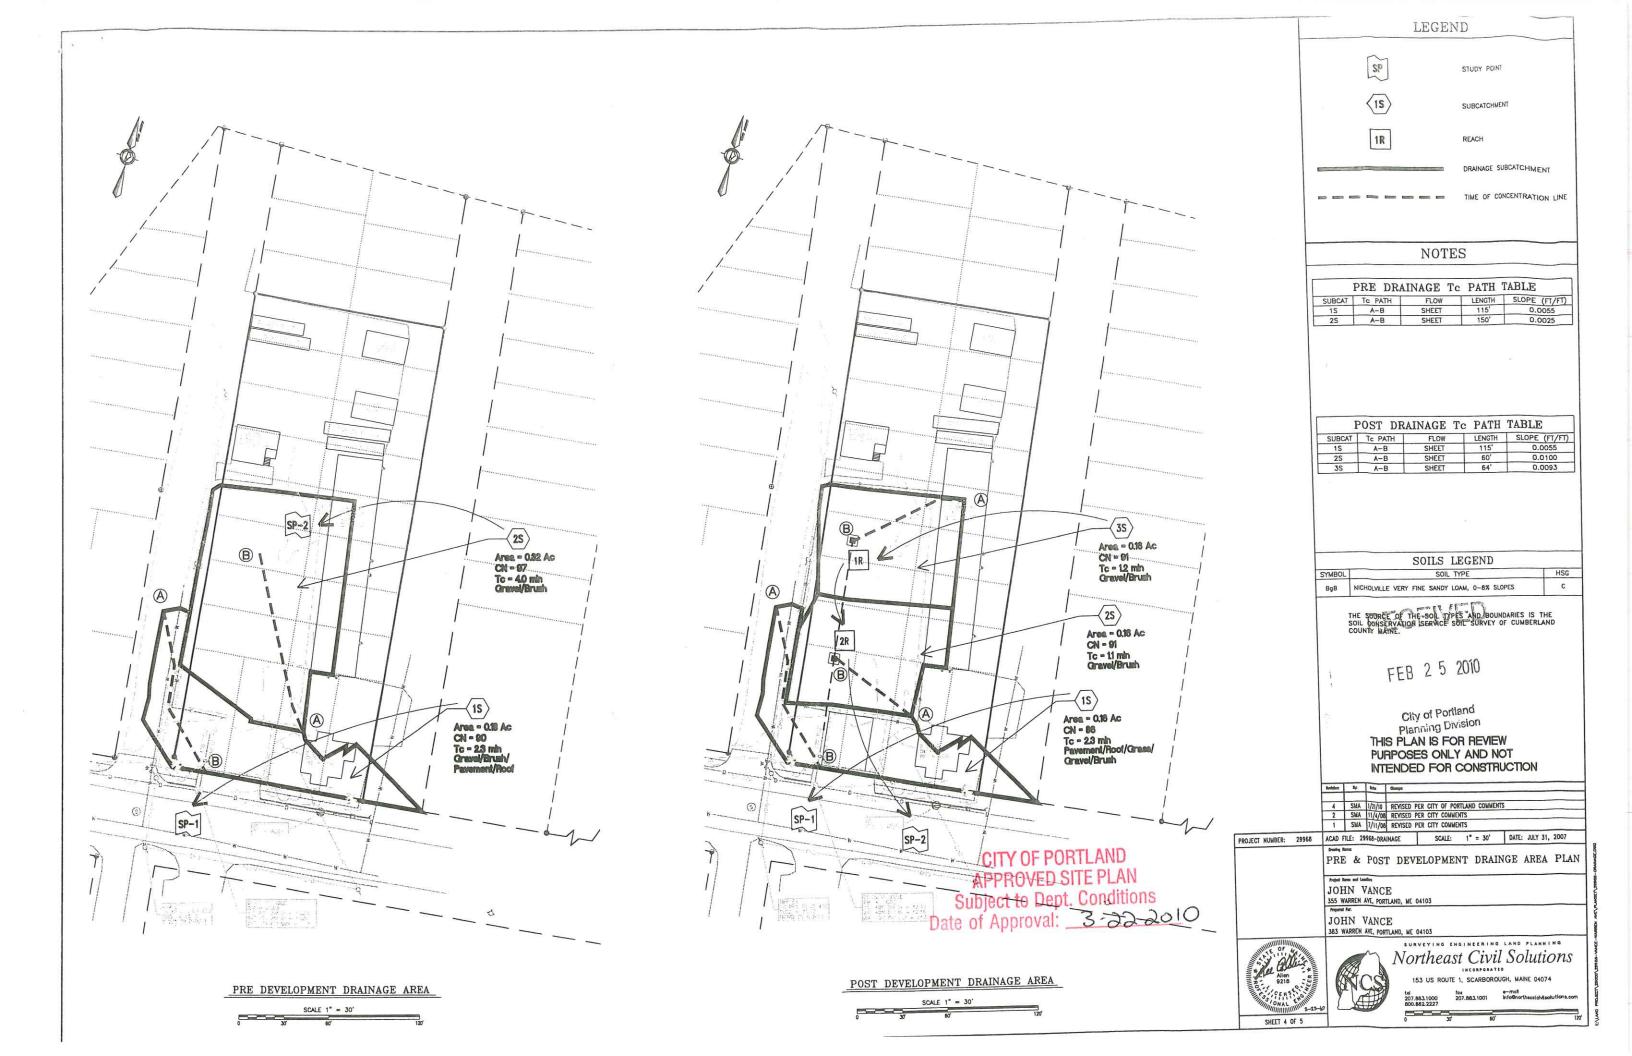

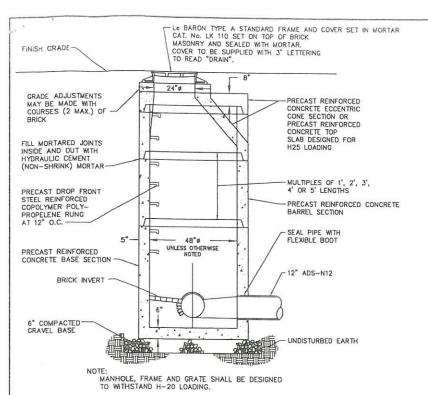


PRECAST CONCRETE DRAIN MANHOLE

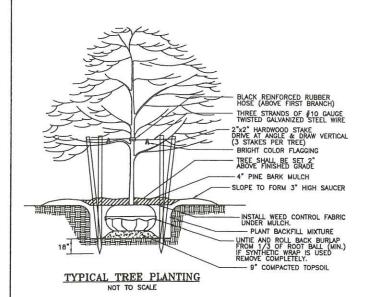

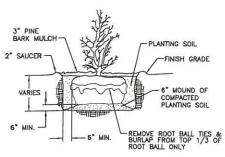

TYPICAL SHRUB PLANTING DETAIL

PLANTING SCHEDULE				
PLANT	QUANTITY	BOTANICAL NAME	COMMON NAME	SIZE
SR	6	SYRINGA RETICULATA	LILAC TREE	2" CAL
TO	5	THUJA OCCIDENTAUS 'AMERICAN'	ARBORVITAE	2 FEET
BP	1	CHINENSIS 'BLUE POINT' JUNIPER	JUNIPER	2" CAL

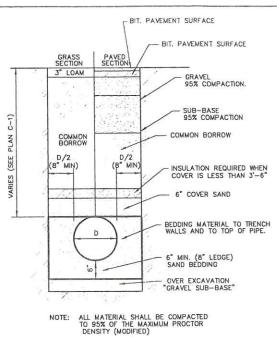

## TYPICAL STORMWATER TRENCH SECTION

PLAN VIEW


TYPICAL / GENERIC

INSTALLATION

CDS MODEL PMIU20\_15

STORMWATER TREATMENT UNIT

PROJECT NAME

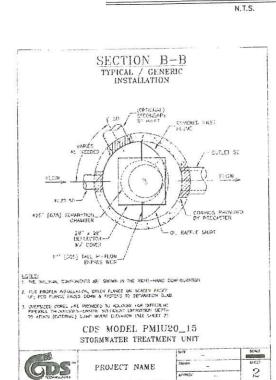

FINISH -GRADE

GRADE ADJUSTMENTS -

MAY BE MADE WITH COURSES (2 MAX.) OF

PRECAST REINFORCED CONCRETE ECCENTRIC

PRECAST REINFORCED

CONCRETE RISER SECTION

CONE SECTION -

6" COMPACTED

GRAVEL BASE-


≥ 24"ø

3'-0" SUMP

CATCH BASIN, FRAME AND GRATE SHALL BE DESIGNED TO WITHSTAND H-20 LOADING.

PRECAST CONCRETE CATCH BASIN DETAIL

UNLESS OTHERWISE NOTED

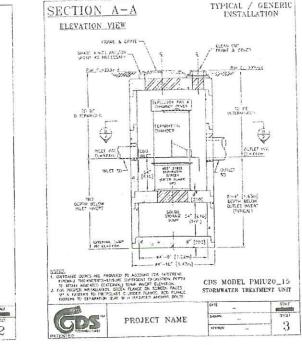

Le BARON HEAVY DUTY FRAME AND GRATE -LF248-2, FOUR FLANGE, (OR APPROVED EQUAL) SET IN MORTAR

-PRECAST REINFORCED CONCRETE ECCENTRIC

SLAB DESIGNED FOR H-20 LOADING

ADS-N12 OUTLET WITH

NEENAH R-3701

CATCH BASIN HOOD (CASCO TRAP)

PRECAST REINFORCED CONCRETE BASE SECTION


UNDISTURBED EARTH

CONE SECTION

FLEXIBLE BOOT

PAVED APRON (SEE FRAME AND GRATE DETAIL FOR

DIMENSIONS)

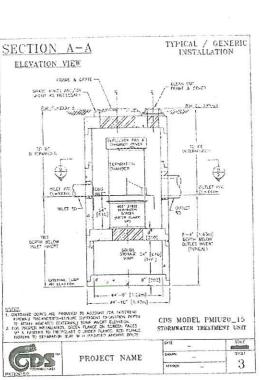

1. CATCH BASIN STRUCTURES


CATCH BASIN SUMPS SHOULD BE

CLEANED IN THE SPRING TO REMOVE ACCUMULATED WINTER SAND AND PERIODICALLY DURING THE YEAR ON AN AS-NEEDED

BASIS (SEDIMENT DEPTHS OF 1.0'
OR GREATER), REMOVAL MAY BE
ACCOMPLISHED BY A VACUUM

STORMMATER STATEM AS IT MILE
REDUCE SYSTEM EFFICIENCY.
CATCH BASIN HOODS AND PIPES
SHOULD ALSO BE INSPECTED FOR
LARGE DEBRIS AND BLOCKAGE.
LOOSE OR BROKEN HOODS SHALL
BE REATTACHED OR REPLACED.

TRUCK OR ANY MECHANICAL MEANS; HOWEVER, CARE SHOULD BE TAKEN AS TO NOT FLUSH THE SEDIMENT INTO THE STORMWATER SYSTEM AS IT WILL

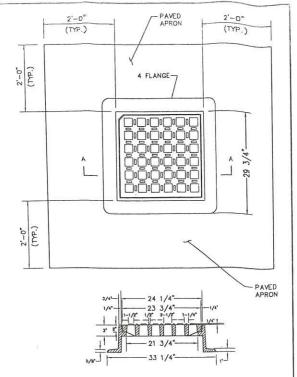

SECTION A-A

1. FRAME AND GRATE SHALL HEAVY DUTY CLASS 30 GRAY

CATCH BASIN FRAME AND GRATE N.T.S.

RECEIVED

FEB 2 5 2010

City of Portland Planning Division


THIS PLAN IS FOR REVIEW PURPOSES ONLY AND NOT INTENDED FOR CONSTRUCTION

SCALE: NTS

ACAD FILE: 29968-DETAILS

JOHN VANCE

CONSTRUCTION DETAILS

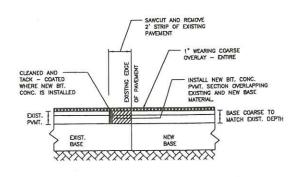

TYPICAL PAVEMENT JOINT @ TIE INTO ROAD & ABUTTING PAVEMENT

CITY OF PORTLAND APPROVED SITE PLAN Subject to Dept. Conditions

Pate of Approval: 3-22-2010

PROJECT NUMBER: 29968 1" BIT. WEARING COURSE "C" GRADE -2" BIT. BASE COURSE "B" GRADE -

TYP. PARKING PAVEMENT SECTION





DATE: JULY 31, 2007