

GROUNDING PLAN SCALE: N.T.S.

GROUNDING CONNECTIONS

- EQUIPMENT CABINET GROUND WIRE, #2 BARE

 SOLID TINNED COPPER GROUND WIRE, (2) PER CABINET. FASTENED TO CONCRETE PAD.
- MASTER BUS BAR, (2) #2 BARE SOLID TINNED COPPER GROUND WIRE.
- 3 ICE BRIDGE POST & CANOPY POST GROUND, #2 BARE SOLID TINNED COPPER GROUND WIRE.
- INTERIOR TELCO CABINET EGB, #2 BARE SOLID TINNED COPPER GROUND WIRE
- MAIN DISCONNECT SWITCH GROUND #2 BARE TINNED COPPER GROUND WIRE.

LEGEND


- 3/4" X 10' COPPERCLAD GROUND ROD SPACED AT 10' O.C. MIN. CADWELD CONNECTION TO GROUND ROD
- VERTICAL CADWELD MOLD
- CADWELD CONNECTION
- INSPECTION WELL SEE DETAIL DWG
- CADWELD CONNECTION TO TOWER

NOTES

- 1. ALL ENDS OF CONDUIT SHALL BE SEALED WITH A FOAM SEALANT AFTER WIRES AND CABLES ARE
- 2. ALL EQUIPMENT GROUND LEADS, CORNER GROUNDS, EXTERIOR GROUND BAR, TO BE #2
- 3. IF EXISTING GROUND RING IS ACCIDENTALLY BROKEN DURING CONSTRUCTION IT SHALL BE

- APPLICANT:
- TINNED SOLID TO GROUND RING.
 - verizon CELLCO PARTNERSHIP d/b/a VERIZON WIRELESS

PREPARED BY:

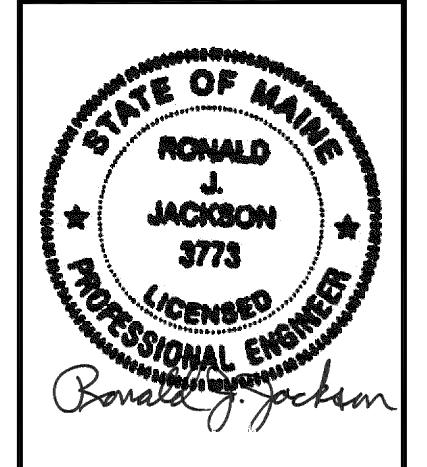

A&E OFFICE: **7A LYBERTY WAY**

WESTFORD, MA 01886

1 (972) 755-1882

118 FLANDERS ROAD, 3RD FLOOR WESTBOROUGH, MA 01581

THIS DOCUMENT IS THE DESIGN PROPERTY AND OPYRIGHT OF NEXIUS AND FOR THE EXCLUSIVE US BY THE TITLE CLIENT. DUPLICATION OR USE WITHOUT THE EXPRESS WRITTEN CONSENT OF THE CREATOR IS STRICTLY PROHIBITED.

DRAWING SCALES ARE INTENDED FOR 24"x36" SIZE PRINTED MEDIA ONLY. ALL OTHER PRINTED SIZES ARE DEEMED "NOT TO SCALE".

SUBMITTALS			
REV	DATE	DESCRIPTION	BY
Α	01/20/16	FOR REVIEW	JM
В	06/23/16	REVISED PER SA	JM
SITE INFO:			

SITE NAME:

PORTLAND_12_ME

LOCATION CODE:

136569 SITE ADDRESS:

188 WARREN AVENUE PORTLAND, ME 04103 CUMBERLAND COUNTY


SHEET TITLE:

GROUNDING PLAN, DETAILS & NOTES

NEXIUS PROJ. NO: SHEET NUMBER: VZ11509 CHECKED BY: E-3 MS CHECKED BY DATE:

01/12/16

- INSTALLED.
- RECONNECTED VIA CADWELD.

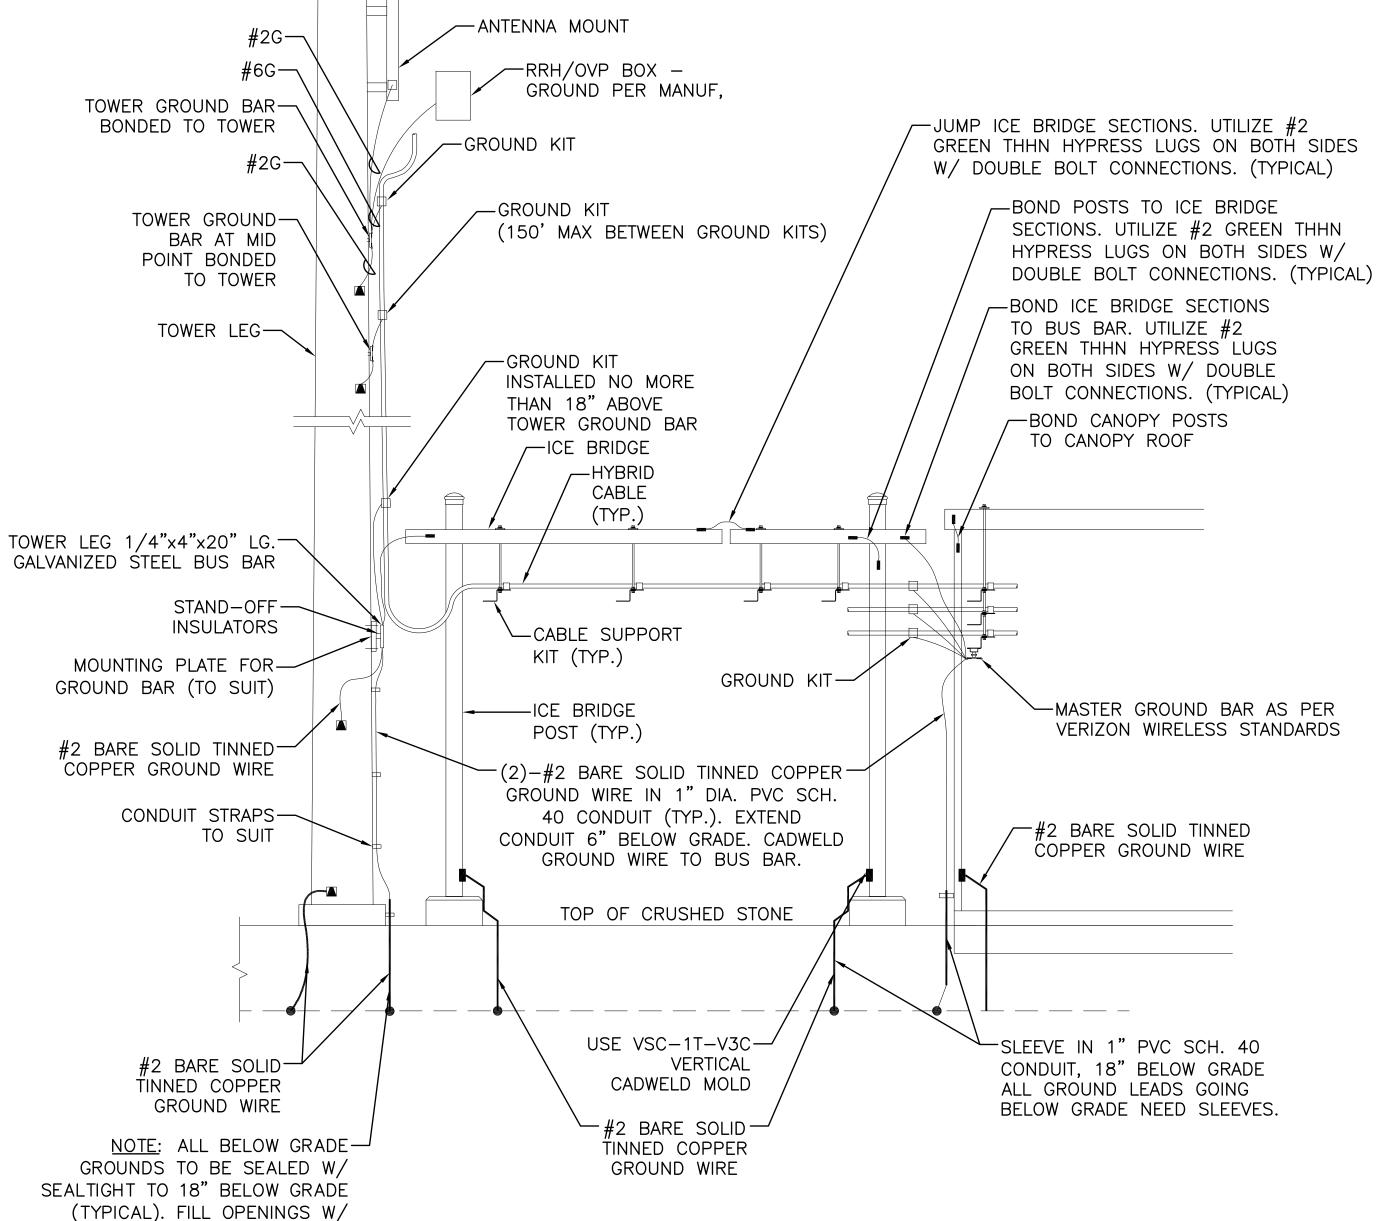

NOTES:

CLEAR SILICONE CAULKING.

- 1. CONTRACTOR SHALL ADD ADDITIONAL GROUND RODS & CONDUCTORS OR APPROVED GROUND ENHANCING MATERIAL TO ACHIEVE LESS THAN 5 OHMS RESISTANCE TO GROUND.
- 2. MAXIMUM VERTICAL/HORIZONTAL DISTANCE BETWEEN CABLE GROUNDING KITS SHALL NOT EXCEED 150 FEET. INSTALL ADDITIONAL KITS AS REQUIRED BY FIELD CONDITIONS.
- 3. GROUND ALL EQUIPMENT AT ANTENNAS AS REQUIRED BY MANUFACTURER.

GROUNDING RISER DIAGRAM SCALE: N.T.S.