

GENERAL NOTES:

- SITE AREA: 52,383 SF OR 1.20 ACRES
- APPLICANT: AVESTA 72 BISHOP, LP
307 CUMBERLAND AVENUE
PORTLAND, MAINE 04101
- OWNER: AVESTA HOUSING DEVELOPMENT CORP.
307 CUMBERLAND AVENUE
PORTLAND, MAINE 04101
- ZONING DISTRICT: B-2-C COMMUNITY BUSINESS DISTRICT
- PARCEL IS SHOWN AS LOT 2 AND LOT 3, BLOCK C ON CITY OF PORTLAND ASSESSOR'S MAP 293.
- DEED RECORDED IN THE CUMBERLAND COUNTY REGISTRY OF DEEDS IN BOOK 31827, PAGE 271.
- SPACE AND BULK STANDARDS:

	REQUIRED	PROPOSED
MINIMUM LOT SIZE:	NONE	52,383 SF
MINIMUM STREET FRONTAGE:	20 FEET	50 FEET
FRONT YARD SETBACK:	NONE	18 FEET
REAR YARD SETBACK:	10 FEET	10 FEET
SIDE YARD SETBACK:	NONE	5 FEET
FRONT YARD MAXIMUM IMPERVIOUS SURFACE RATIO:	10 FEET	18 FEET
MAXIMUM HEIGHT OF STRUCTURES:	NONE	35%
MAXIMUM RESIDENTIAL DENSITY:	45 FEET	39 FEET
	1,500 SF/UNIT	1,746 SF/UNIT
- EXISTING CONDITIONS AND BOUNDARY INFORMATION TAKEN FROM A PLAN ENTITLED "BOUNDARY & TOPOGRAPHIC SURVEY AT 72 BISHOP STREET, PORTLAND, MAINE" PREPARED BY OWEN HASKELL, INC. DATED JULY 17, 2014.
- BEARINGS ARE BASED ON MAINE STATE PLAN COORDINATE SYSTEM MAINE WEST NAD83 AND ELEVATIONS ARE NAVD83 AS BASED ON STATIC GPS COLLECTION AND OPUS CORRECTION.
- WETLAND DELINEATION PERFORMED BY C.E.S. INC., LEWISTON MAINE, JUNE 2014. FLAGGED WETLAND AREA WAS SURVEYED BY OWEN HASKELL, INC., FALMOUTH, MAINE, JULY 2014.
- PROPOSED DWELLING UNITS: 30 (SRO) EFFICIENCY APARTMENT UNITS
- OFF-STREET PARKING REQUIREMENTS:


REQUIRED:	PROPOSED:
1/DWELLING UNIT = 30 PARKING SPACES	10 STANDARD PARKING SPACES 2 HANDICAP PARKING SPACE
- BICYCLE PARKING:

REQUIRED:	PROPOSED:
2 SPACES/5 DWELLING UNITS 12 SPACES (30 NEW DWELLING UNITS)	12 SPACES
- EXISTING IMPERVIOUS: 1,304 +/- SF (2.5% OF SITE)
PROPOSED IMPERVIOUS: 18,886 +/- SF (35% OF SITE)
- FLOOR AREA CALCULATIONS:

FLOOR:	SQ. FT.
FIRST FLOOR:	7,807.89 SF
SECOND FLOOR:	6,697.66 SF
THIRD FLOOR:	6,534.39 SF
TOTAL:	21,039.94 SF
- ALL WORK WITHIN THE ROAD RIGHT-OF-WAY AND ALL UTILITIES CONNECTING TO INFRASTRUCTURE WITHIN THE ROAD SHALL MEET CITY OF PORTLAND TECHNICAL MANUAL STANDARDS.
- THE CONTRACTOR SHALL BE HELD SOLELY RESPONSIBLE FOR UNDERTAKING THE WORK IN A SAFE AND EFFICIENT MANNER, IN ACCORDANCE WITH LOCAL, STATE AND FEDERAL SAFETY REGULATIONS. ALL WORK AREAS SHALL BE DELINEATED CLEARLY AND FENCED AS APPROPRIATE TO PREVENT UNAUTHORIZED ACCESS. THE SITE SHALL BE LEFT IN A SAFE, ORDERLY AND TIDY MANNER AT THE END OF EACH WORK DAY.
- UTILITY SERVICE CONNECTIONS SHALL CONFORM TO STANDARDS FOR INDIVIDUAL UTILITY PROVIDERS
- EXISTING WETLANDS: 14,203 SF
IMPACTED WETLANDS: 3,105 SF
- SITE LIGHTING SHALL MEET THE CITY OF PORTLAND STANDARDS AS OUTLINED IN SECTION 12 OF THE CITY OF PORTLAND TECHNICAL DESIGN STANDARDS. SITE LIGHTING SHALL ADHERE TO SECTION 12.2.5 LIGHT TRESPASS-LIGHTING SHALL NOT BE GREATER THAN 0.1 FOOT CANDLES AT THE PROPERTY LINE.
- PRIOR TO SITE CLEARING, CONTRACTOR SHALL COORDINATE WITH PROJECT LANDSCAPE ARCHITECT TO DEMARCATTE TREES FOR PROTECTION AND WETLAND AREAS TO BE PROTECTED. EXISTING TREES TO BE PRESERVED SHALL BE PROTECTED DURING CONSTRUCTION AND SHALL BE THE RESPONSIBILITY OF THE GENERAL CONTRACTOR.- SEE NOTE 10 SHEET L4

PLAN REFERENCES

- "PLAN OF LAND IN PORTLAND, MAINE FOR WESTBROOK COLLEGE, AUGUST 20, 1974 OWEN HASKELL, INC. JOB NO. 7445 P" REVISED 5/4/89
- "BOUNDARY SURVEY ATHLETIC FIELD UNIVERSITY OF NEW ENGLAND STEVENS AVENUE & BISHOP STREET PORTLAND, MAINE OCTOBER 2007 COLONIAL SURVEYING COMPANY, LLC"
- WORKING DRAWING OF MAYFIELD STREET, BISHOP STREET AND STEVENS AVENUE IN FILES OF H.I. & E.C. JORDAN - SURVEYORS
- SITE PLAN OF PROPERTY ON BISHOP STREET, PORTLAND, MAINE MADE FOR PLASMINE TECHNOLOGY, INC. OCT. 1, 1991 OWEN HASKELL, INC. JOB NO. 91163P

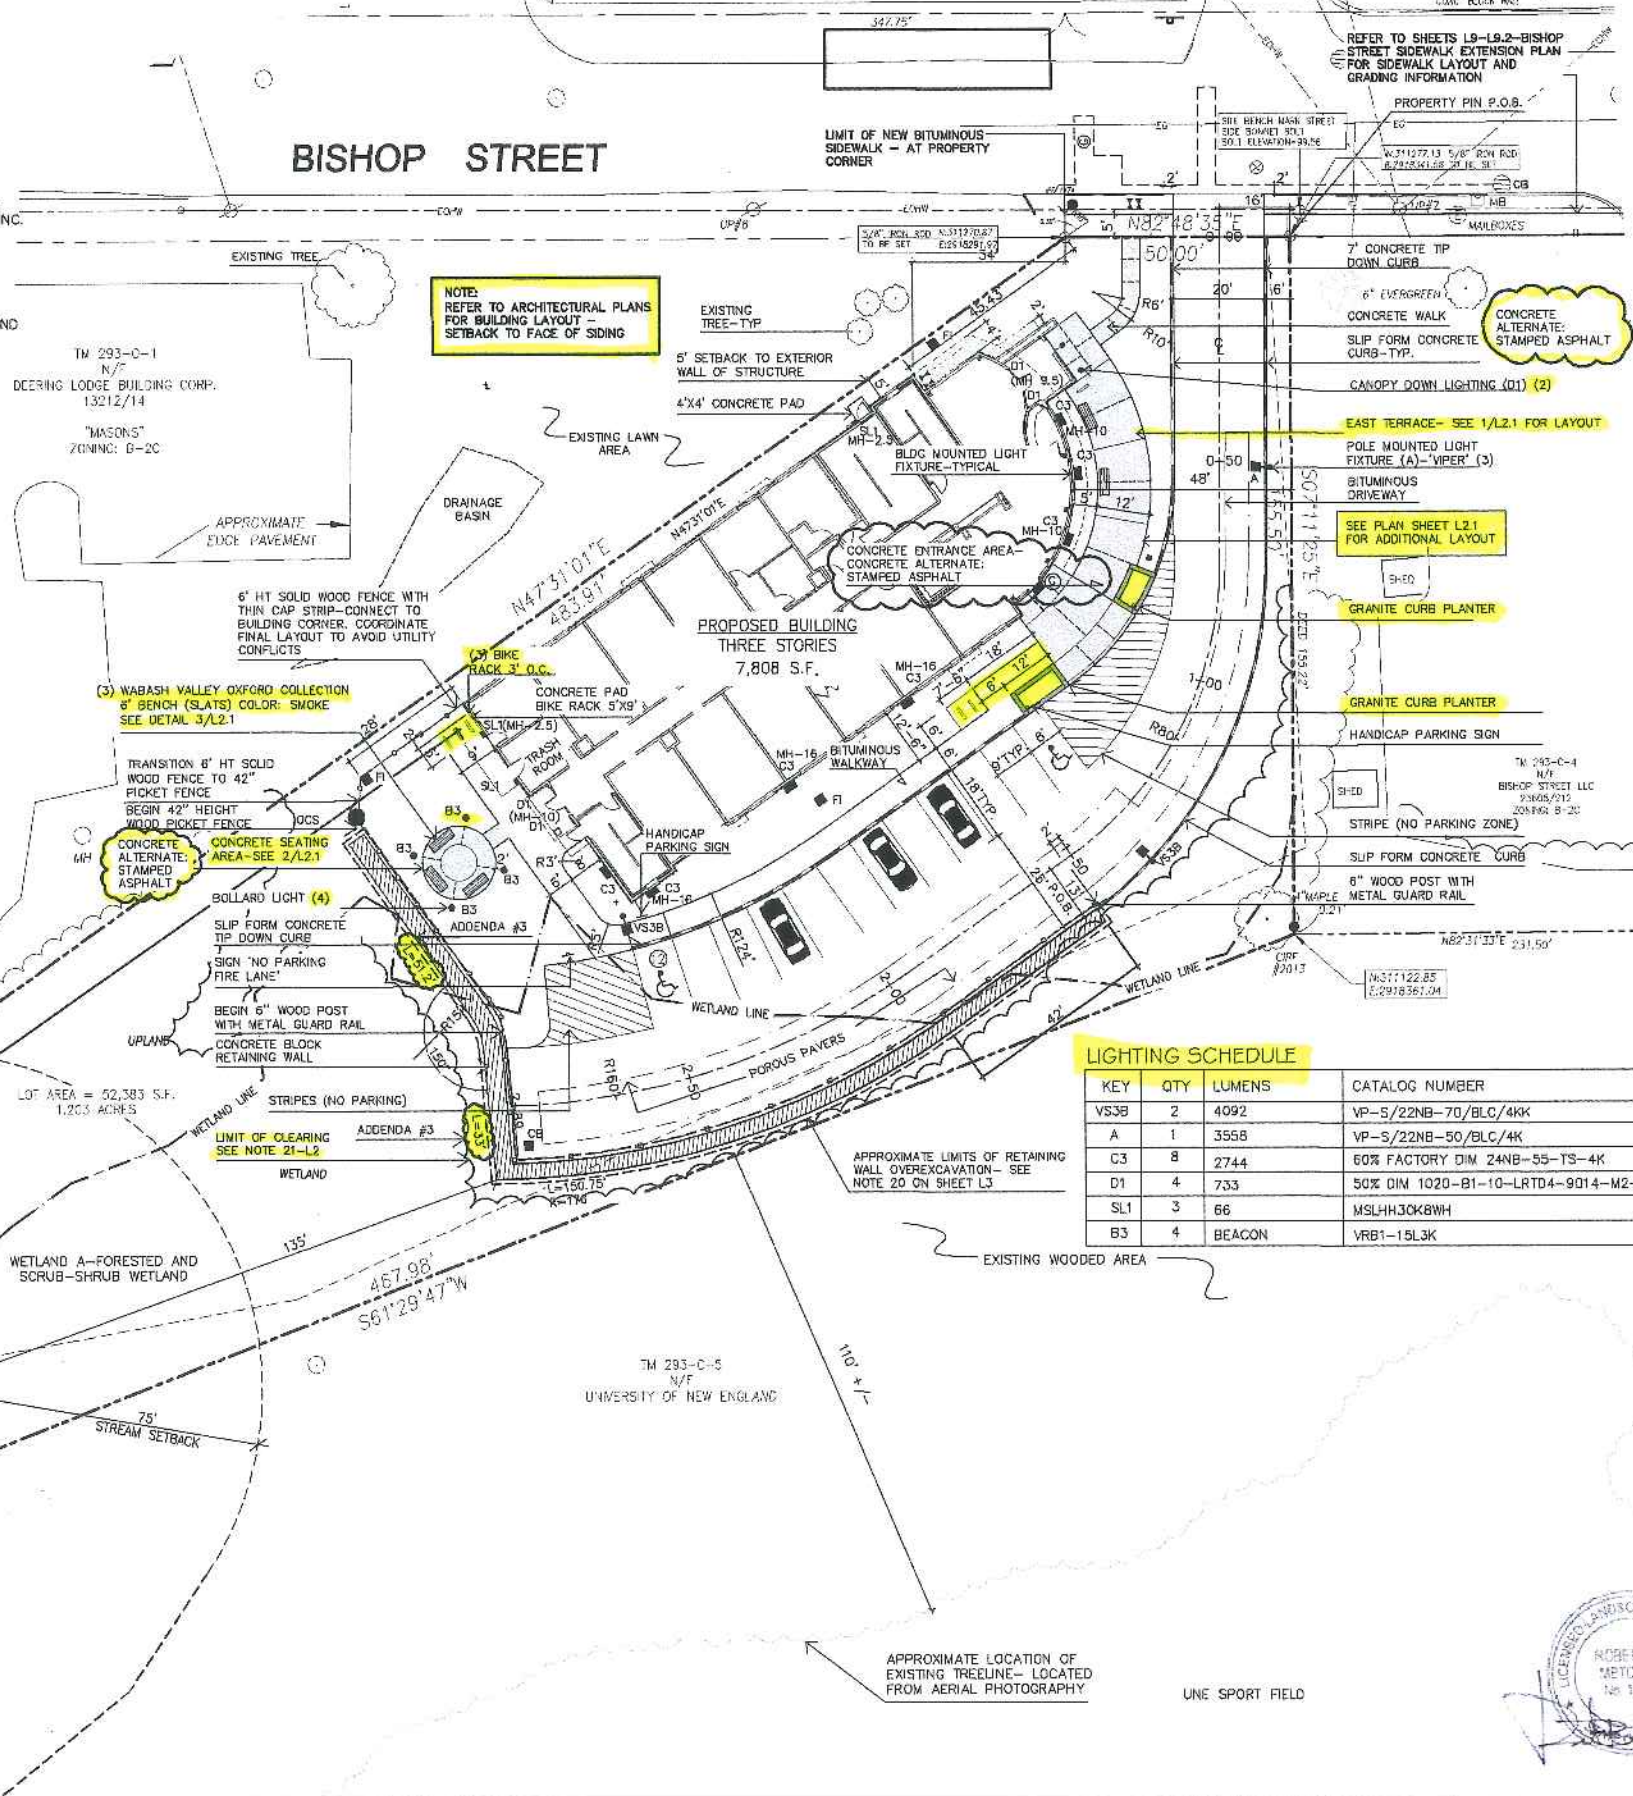

Prepared For:
Owner:
AVESTA BISHOP STREET LP
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Prepared By:
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Landscape Architects
The Staples School
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Portland, Maine 04101
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LEGEND

	EXISTING	PROPOSED
PROPERTY LINE	---	---
IRON PIPE/VAG NAIL	○ I.P.P.P.	● ▲
GRANITE MONUMENT	□	□
CATCHBASIN	CB	CB
FIELD INLET	FI	FI
HYDRANT	○	○
UTILITY POLE	○	○
FENCE	---	---
DEC. TREE	○	○
EVERGREEN TREE	○	○
LIGHT POLE	○	○
BLDG MOUNTED LIGHT	○	○
CURB	---	---
OVERHEAD WIRES	---	---
SOIL BORINGS	○	○
WATER VALVE	○	○
GAS VALVE	○	○
SIGN	○	○
WETLAND	---	---
OUTLET CONTROL STRUCTURE	○	○
WETLAND IMPACT	---	---

72 BISHOP STREET
Portland, Maine
Bishop Street

LIGHTING SCHEDULE

KEY	QTY	LUMENS	CATALOG NUMBER	MOUNTING HEIGHT
VS3B	2	4092	VP-S/22NB-70/BLC/4KK	MH-14
A	1	3558	VP-S/22NB-50/BLC/4K	MH-15
C3	8	2744	60% FACTORY DIM 24NB-55-TS-4K	
D1	4	733	50% DIM 1020-B1-10-LRT04-9014-M2-30KS-80-NCSM	
SL1	3	66	MSLHHJCK8WH	
B3	4	BEACON	YRB1-15L3K	

REFER TO ELECTRICAL ENGINEERING PLANS FOR LIGHTING SCHEDULE AND FIXTURE ORDERING INFORMATION.

Date: JANUARY 8, 2016

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Rev: 5/22/15 Addenda #3
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01/08/16

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Title: LAYOUT AND LIGHTING PLAN

Scale: 1"=20'

North:

Sheet No.: **L2**

