




**1 BRACED FRAME 1 ELEVATION**  
SF201 SCALE: 1/4" = 1'-0"

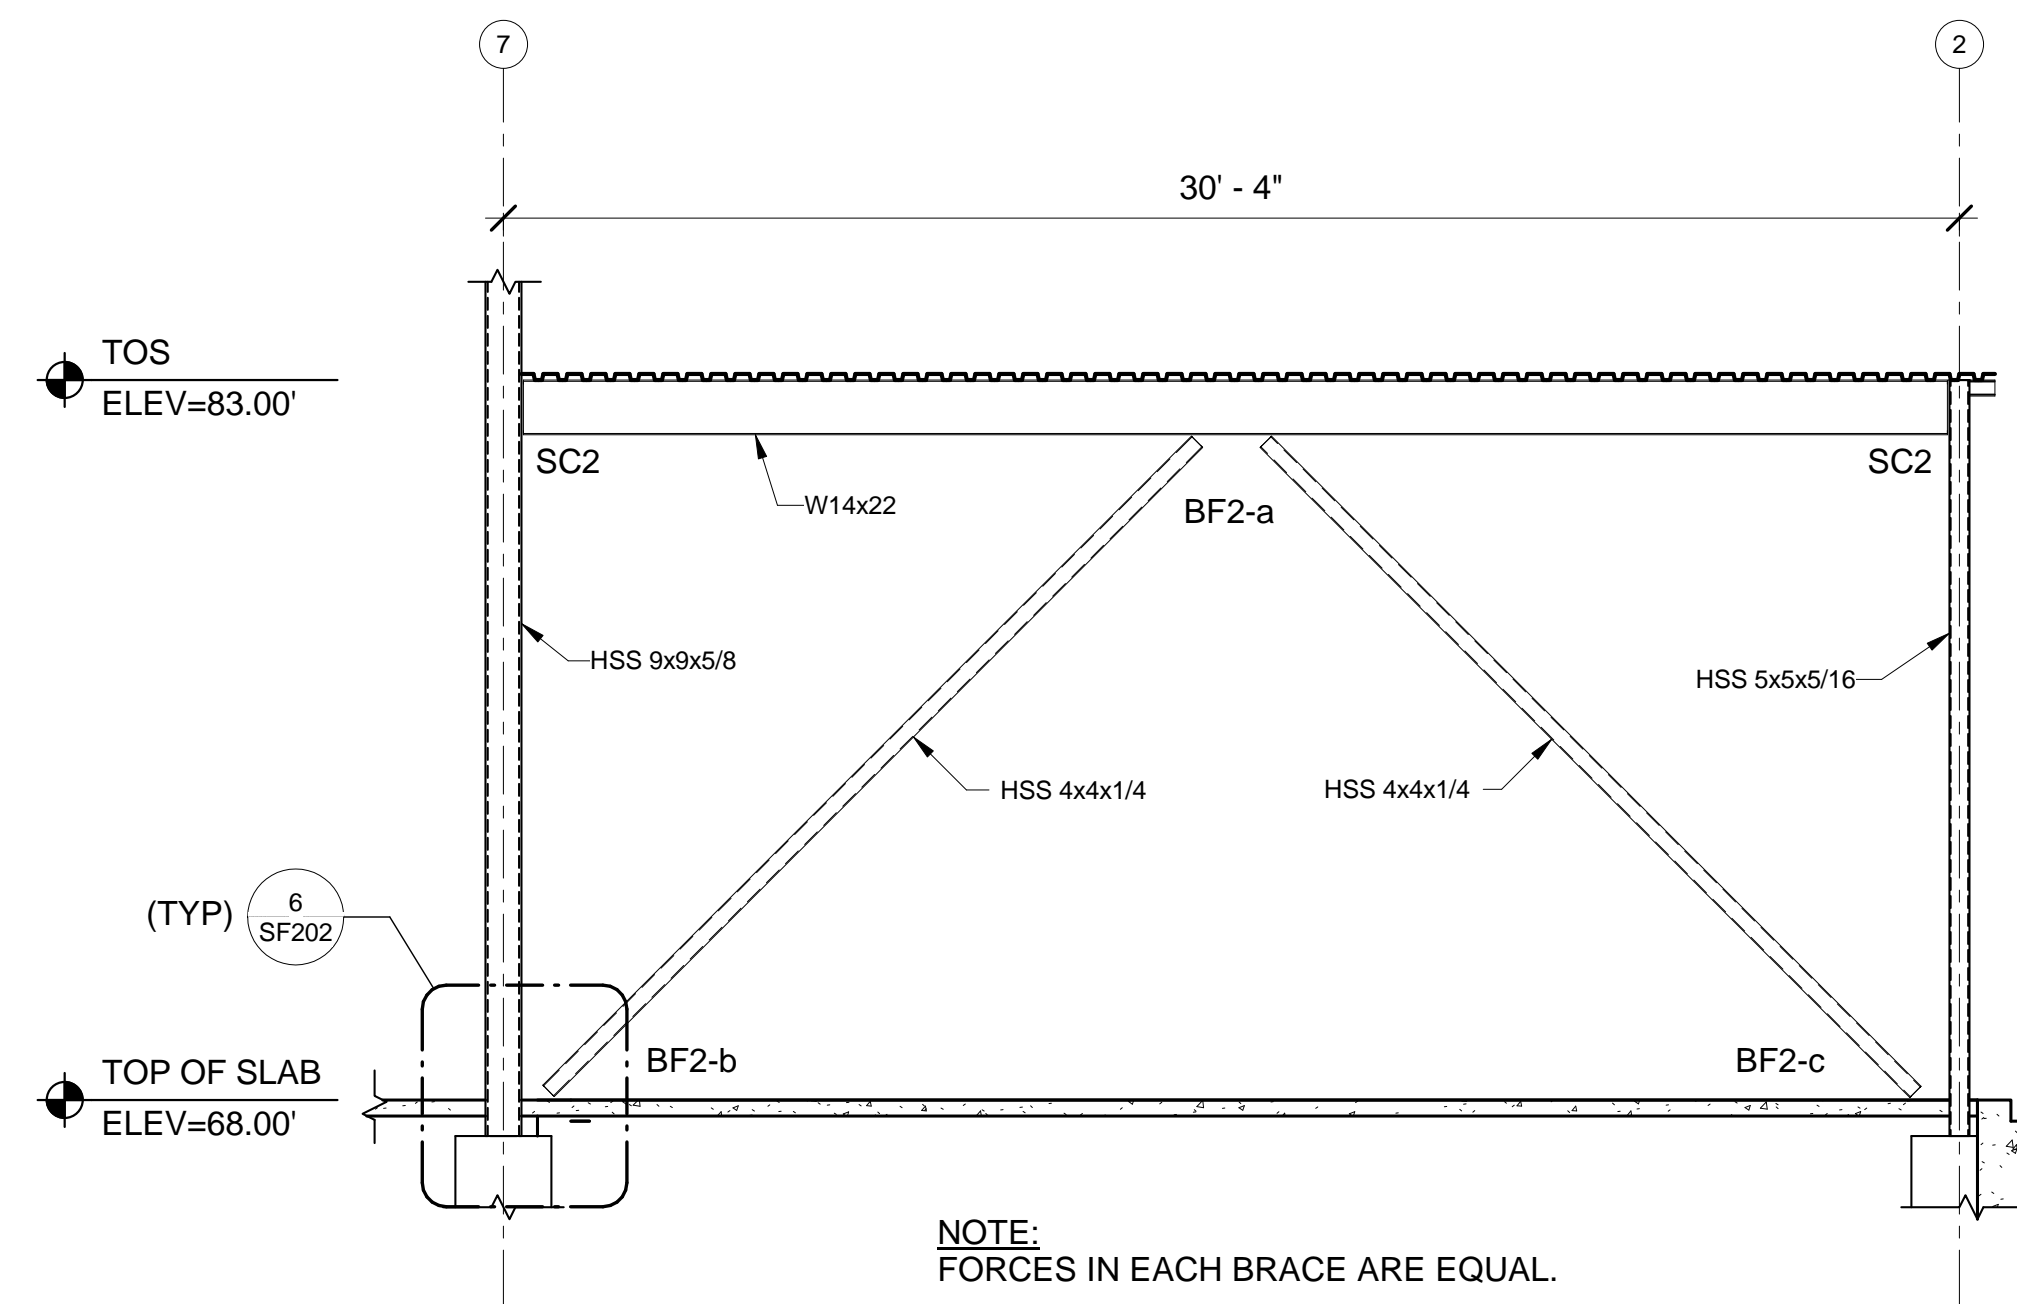


**2 BRACED FRAME 2 ELEVATION**  
SF201 SCALE: 1/4" = 1'-0"

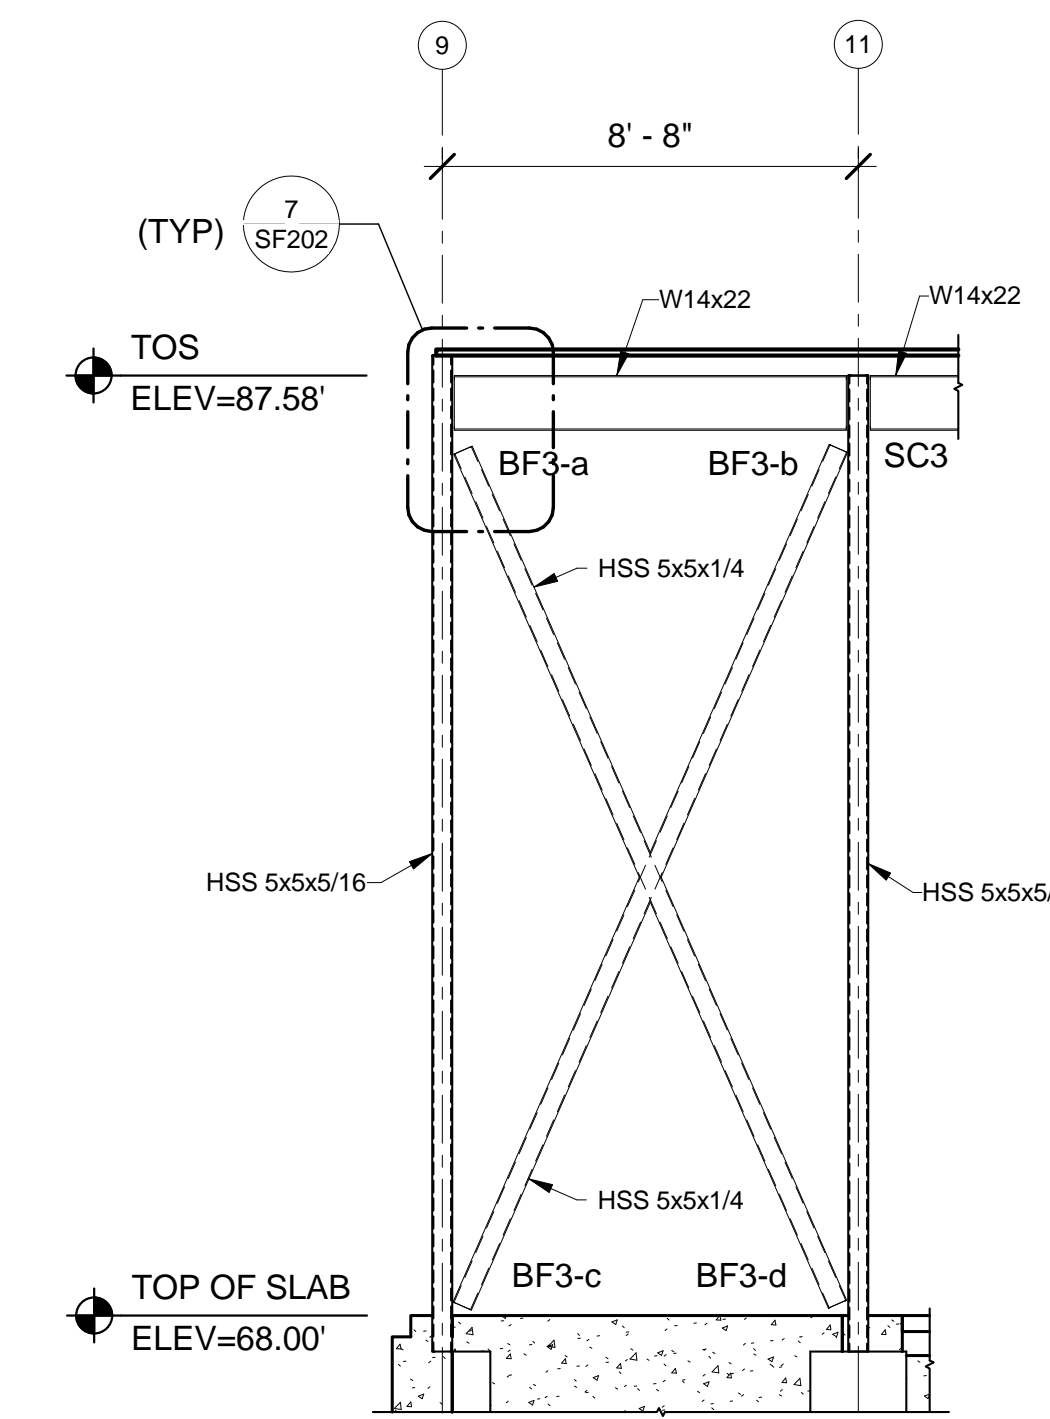


**3 BRACED FRAME 3 ELEVATION**  
SF201 SCALE: 1/4" = 1'-0"

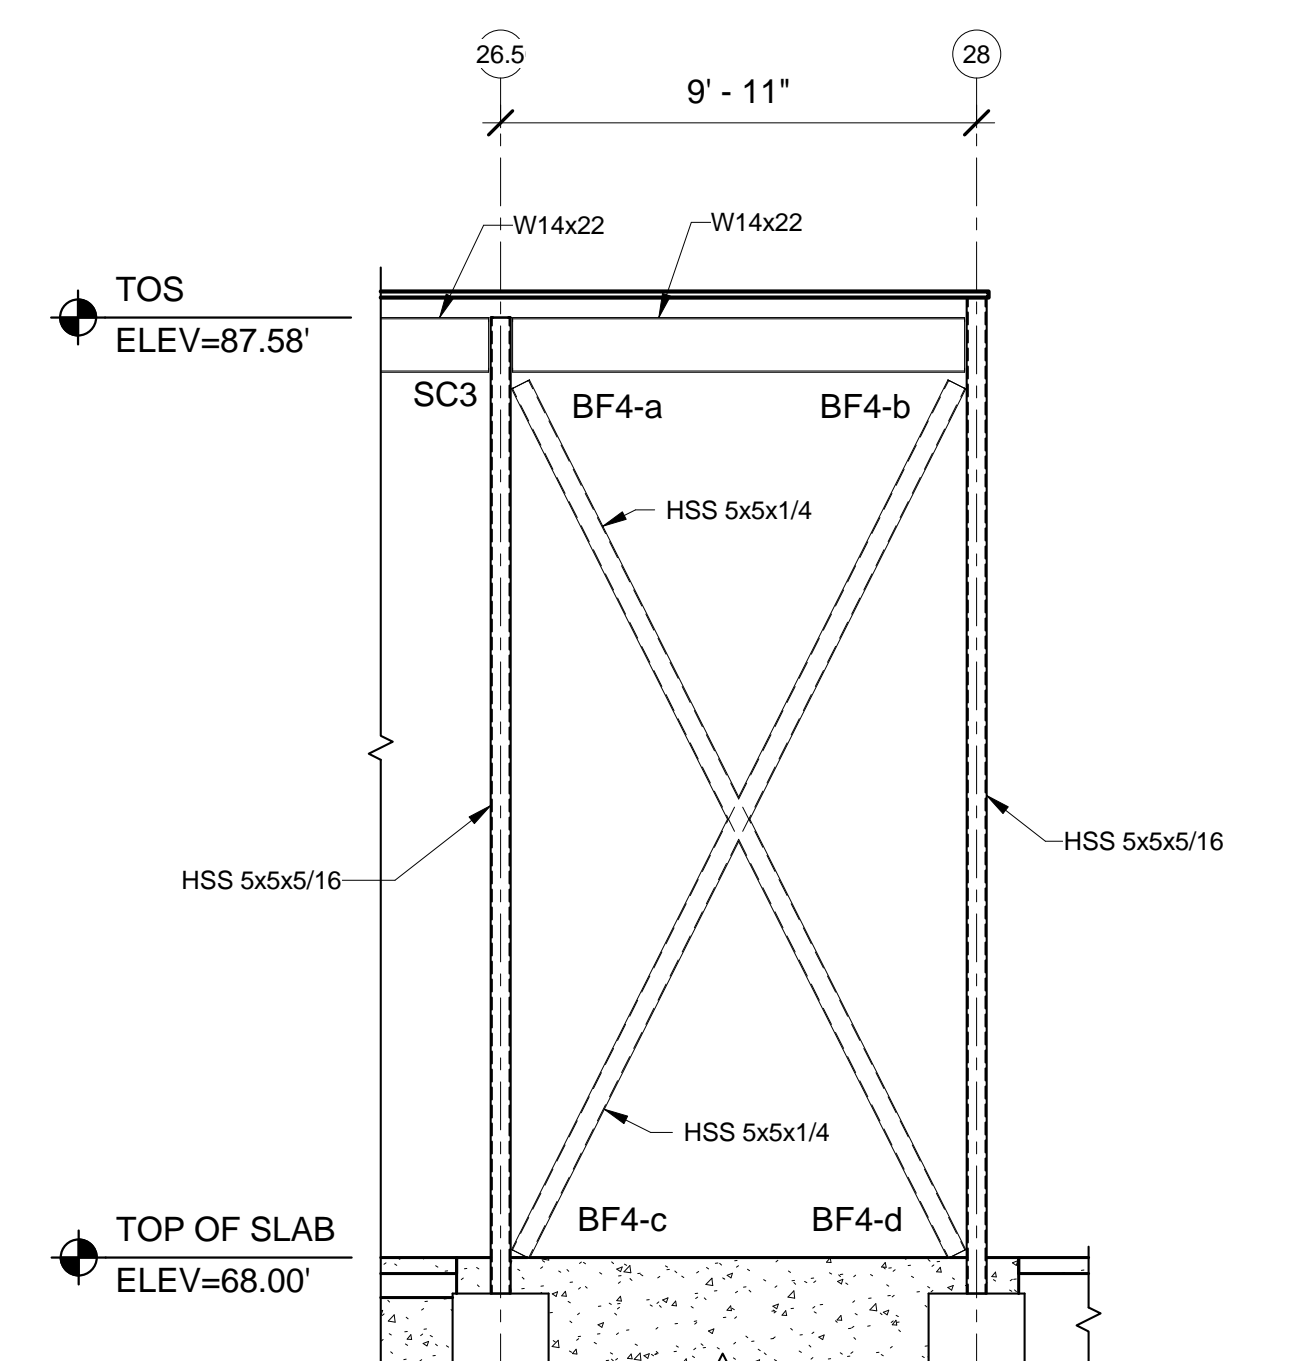


**4 BRACED FRAME 4 ELEVATION**  
SF201 SCALE: 1/4" = 1'-0"

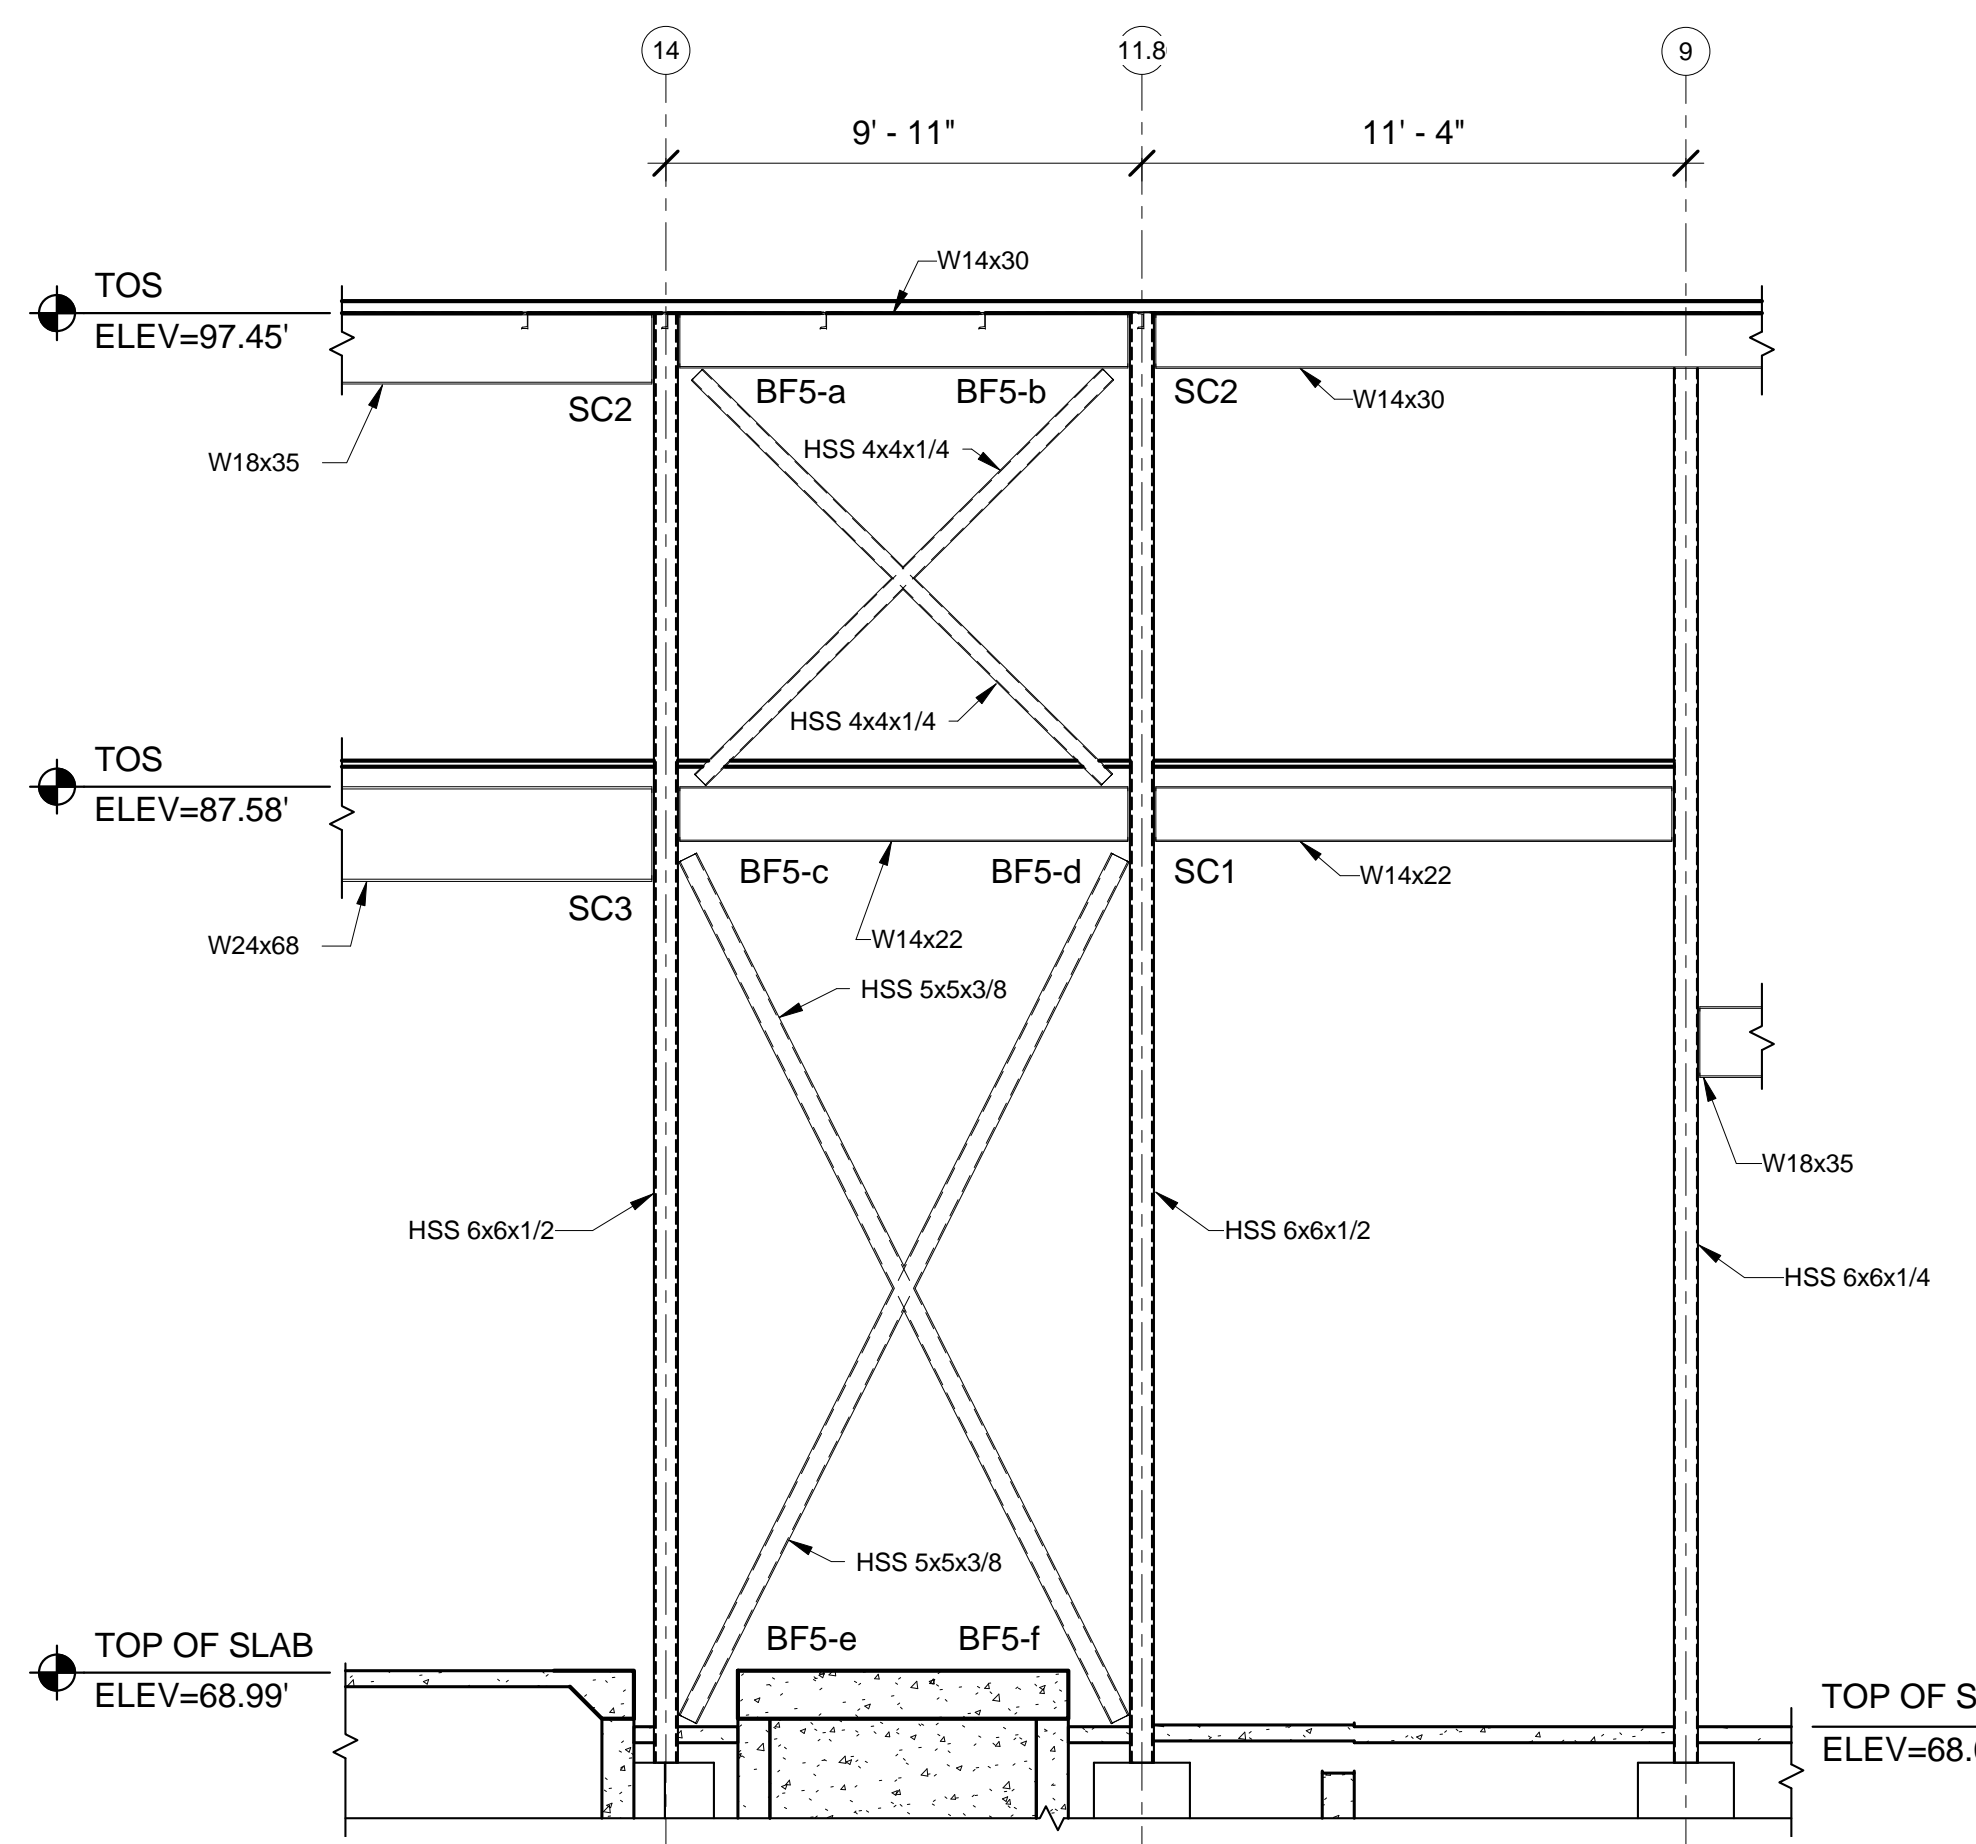


**5 BRACED FRAME 5 ELEVATION**  
SF201 SCALE: 1/4" = 1'-0"

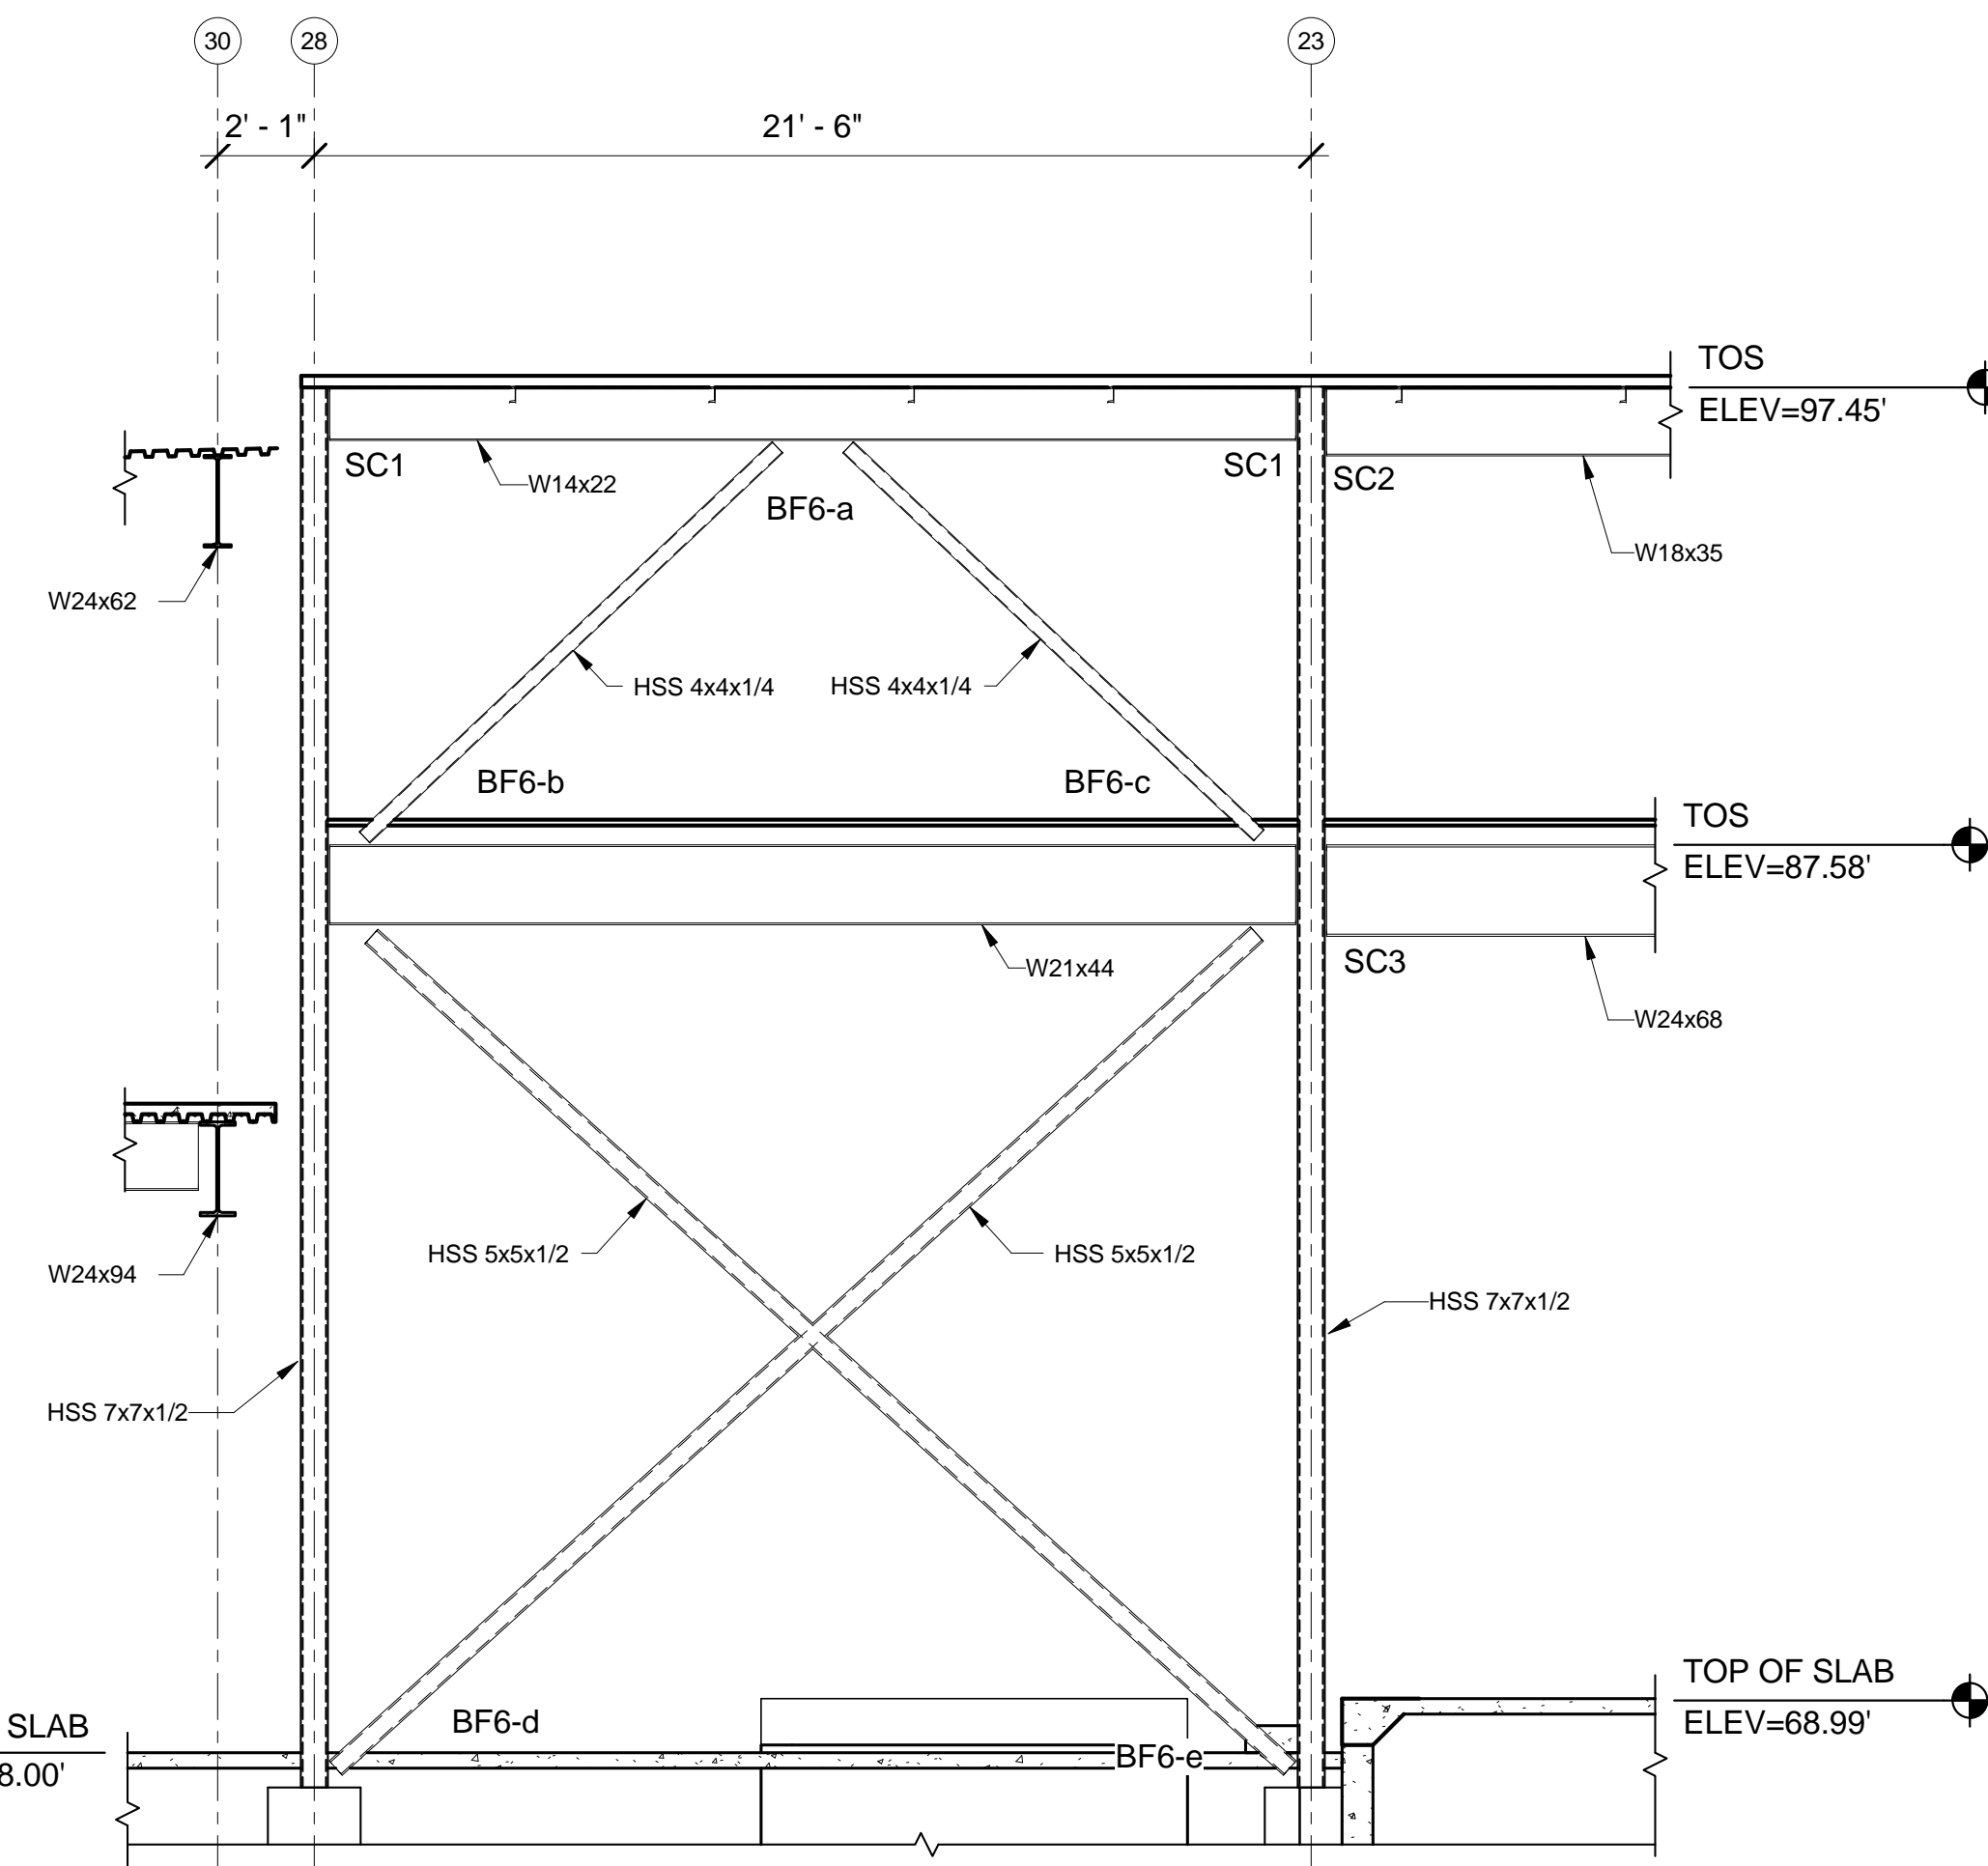

**6 BRACED FRAME 6 ELEVATION**  
SF201 SCALE: 1/4" = 1'-0"

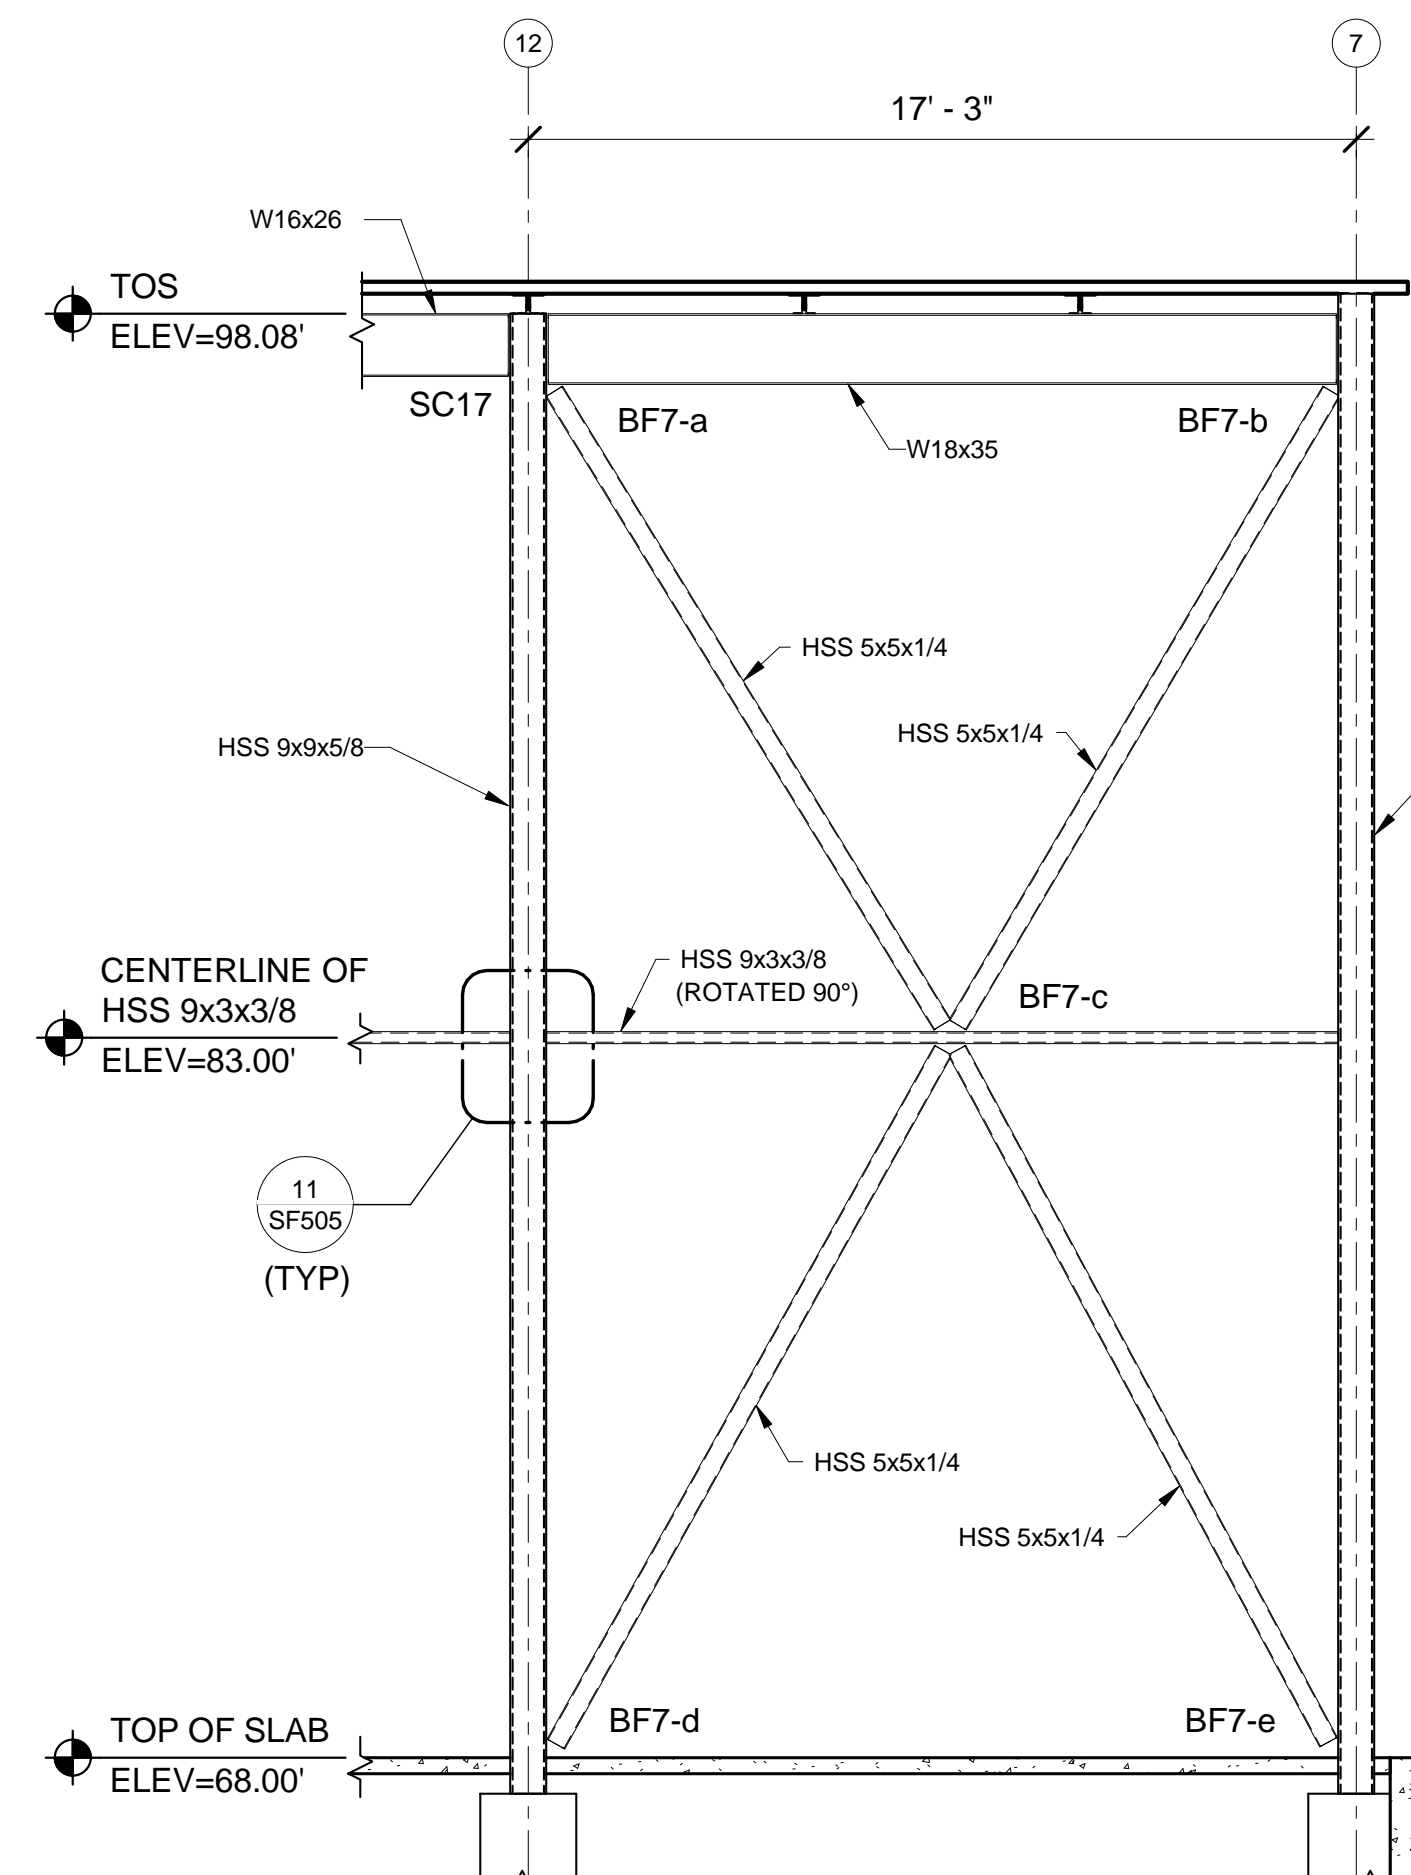


**7 BRACED FRAME 7 ELEVATION**  
SF201 SCALE: 1/4" = 1'-0"

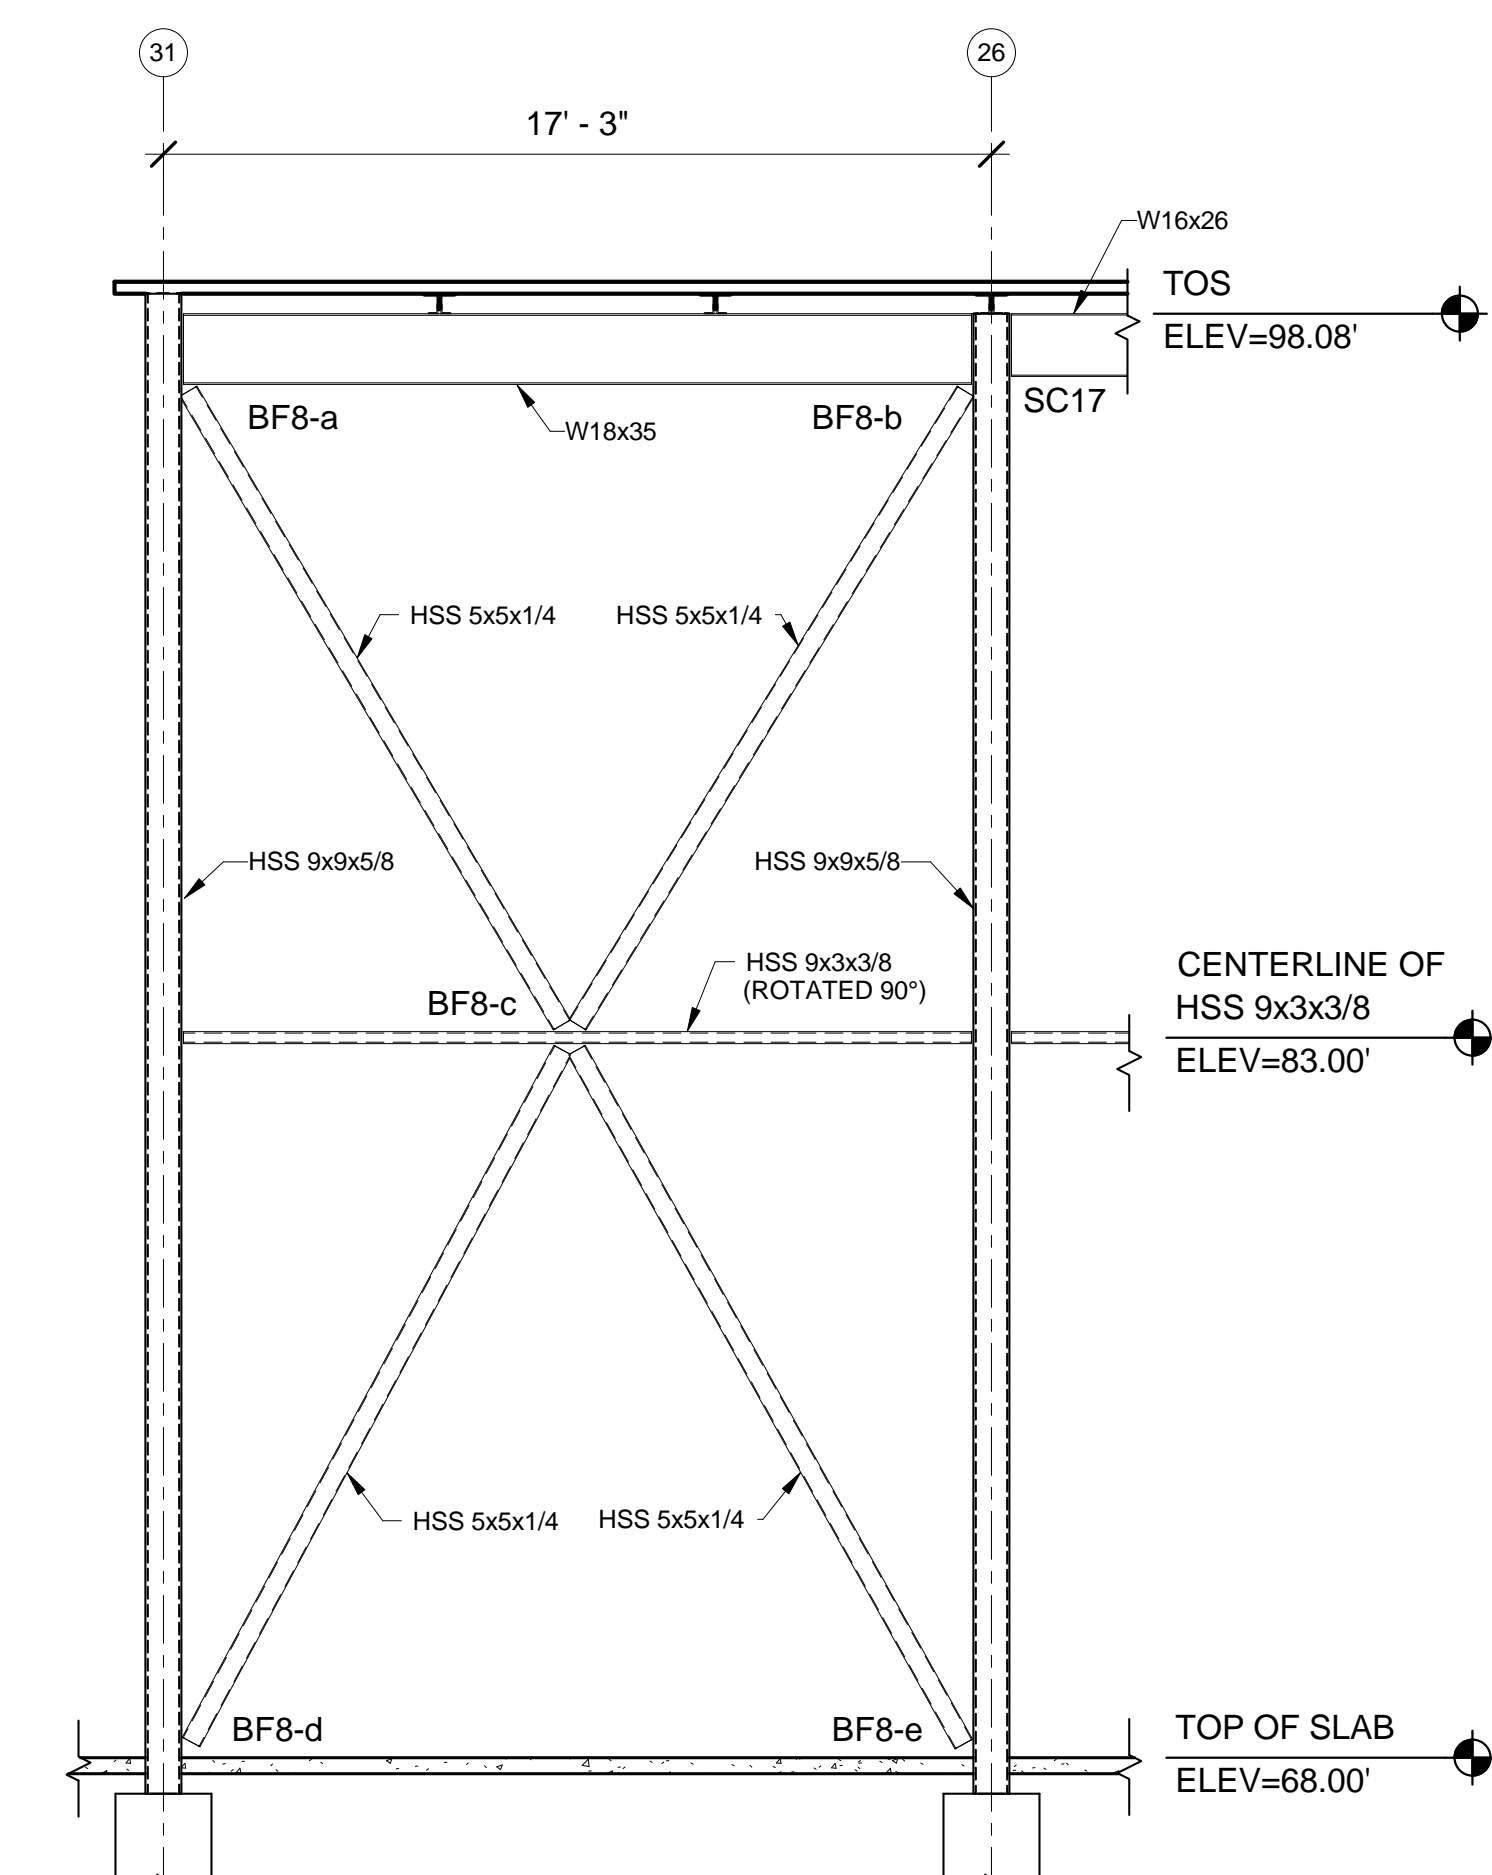

**8 BRACED FRAME 8 ELEVATION**  
SF201 SCALE: 1/4" = 1'-0"

**DRAWING NOTES:**

- REFER TO SHEET SF202 FOR BRACING CONNECTION FORCES.
- REFER TO FRAMING PLAN SHEETS SF104 AND SF105 FOR BEAM TO COLUMN CONNECTION INFORMATION.
- REFER TO SHEET SF606 FOR SEISMIC COLLECTOR CONNECTION SCHEDULE.
- CONNECTION DETAILS 5/SF202, 6/SF202 AND 7/SF202 SHOW THE GENERAL DESIGN INTENT. EXACT PLATE SIZE, THICKNESS AND WELDS TO BE DETERMINED BY CONNECTION DESIGN ENGINEER OF RECORD.

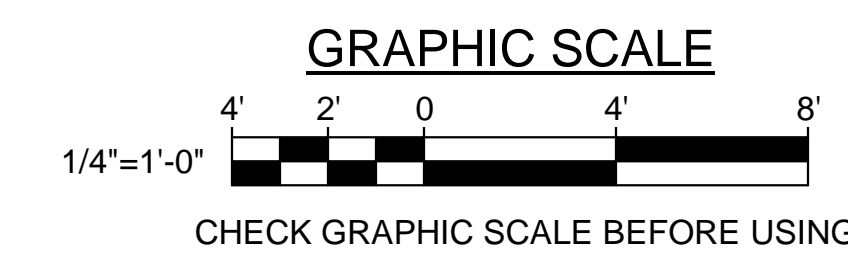

STATE OF MAINE PUBLIC SCHOOL PROJECT		DRAWING NO. SF201	
TITLE PORTLAND PUBLIC SCHOOLS NEW FRED P. HALL ELEMENTARY SCHOOL		SHEET NO.	
LOCATION 23 ORONO ROAD, PORTLAND, ME		DATE 03/17/17	
TITLE THIS DWG. BRACED FRAME ELEVATIONS 1		DRAWN BY MJC	
OAK POINT ASSOCIATES		CHECK BY DNM	
NO. DATE		REVISIONS	
101 OF 312		207.283.9192	