



1 ENLARGED STAGE PARTIAL FOUNDATION PLAN
SB403 SCALE: 1/4" = 1'-0"



NOTE:
BOTTOM OF FOOTING ELEVATION = 62.75',
UNLESS NOTED OTHERWISE.

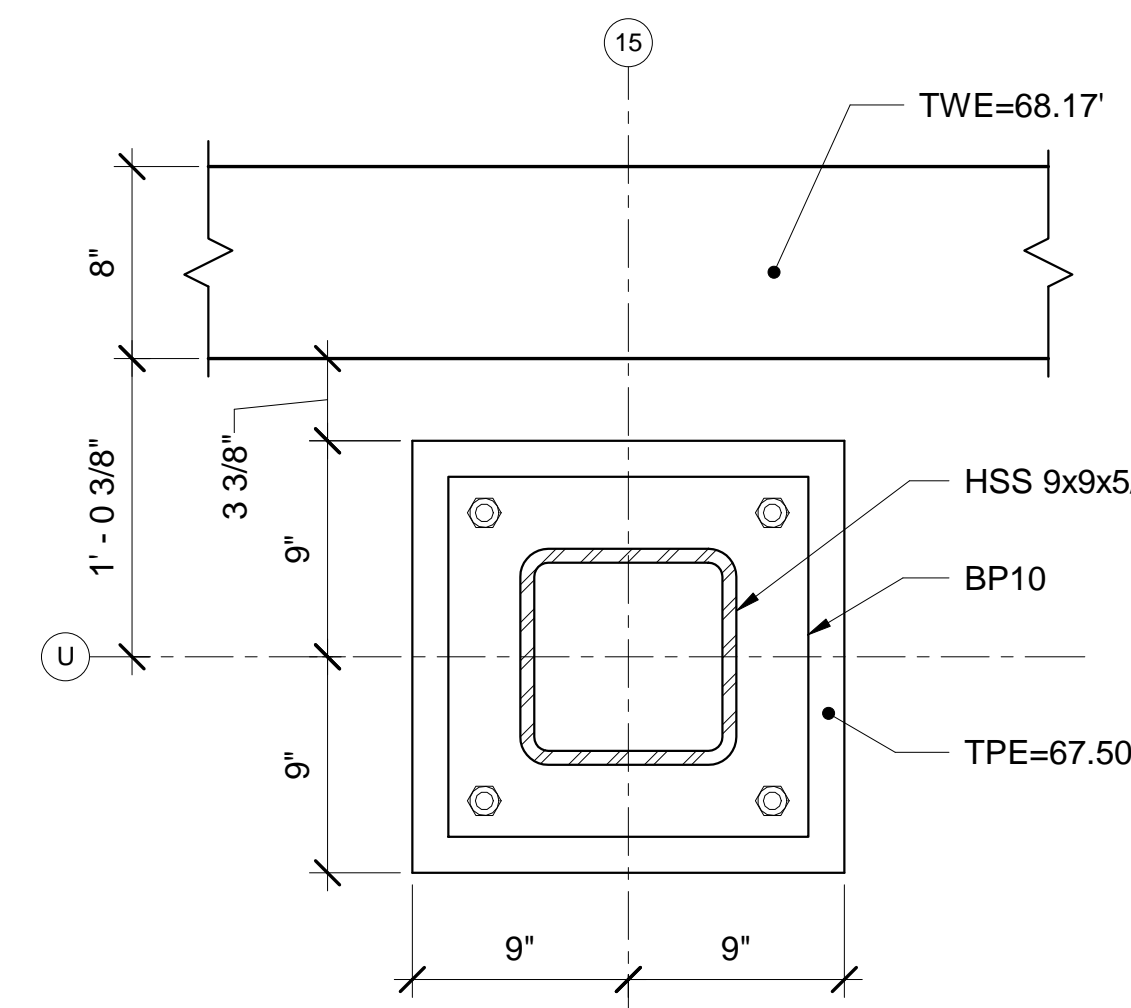


2 ENLARGED PIER PLAN AT COL LINE U/15
SB403 SCALE: 1 1/2" = 1'-0"

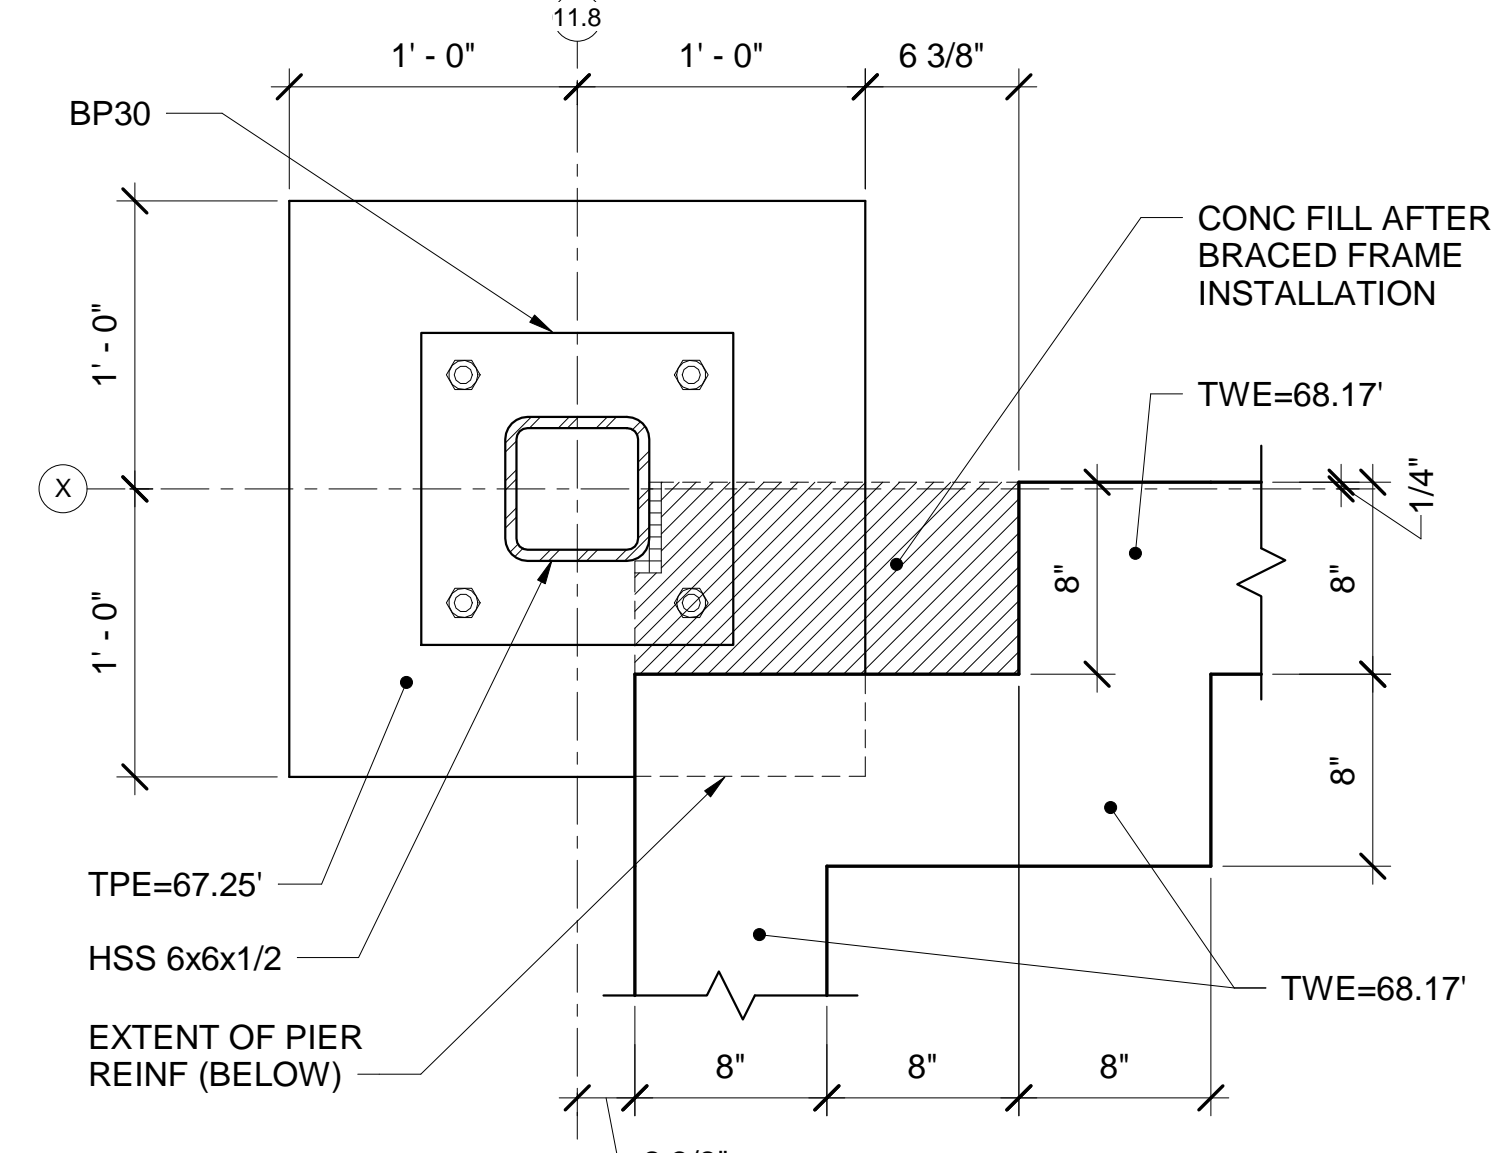


3 ENLARGED PIER PLAN AT COL LINE X/11.8
SB403 SCALE: 1 1/2" = 1'-0"

NOTES:
1. PROVIDE 1/2" PREFORMED FILLER AND SEALANT AROUND COLUMN AND BRACE PRIOR TO CONCRETE FILL.
2. TOP OF CONCRETE FILL ELEVATION = 69.17.

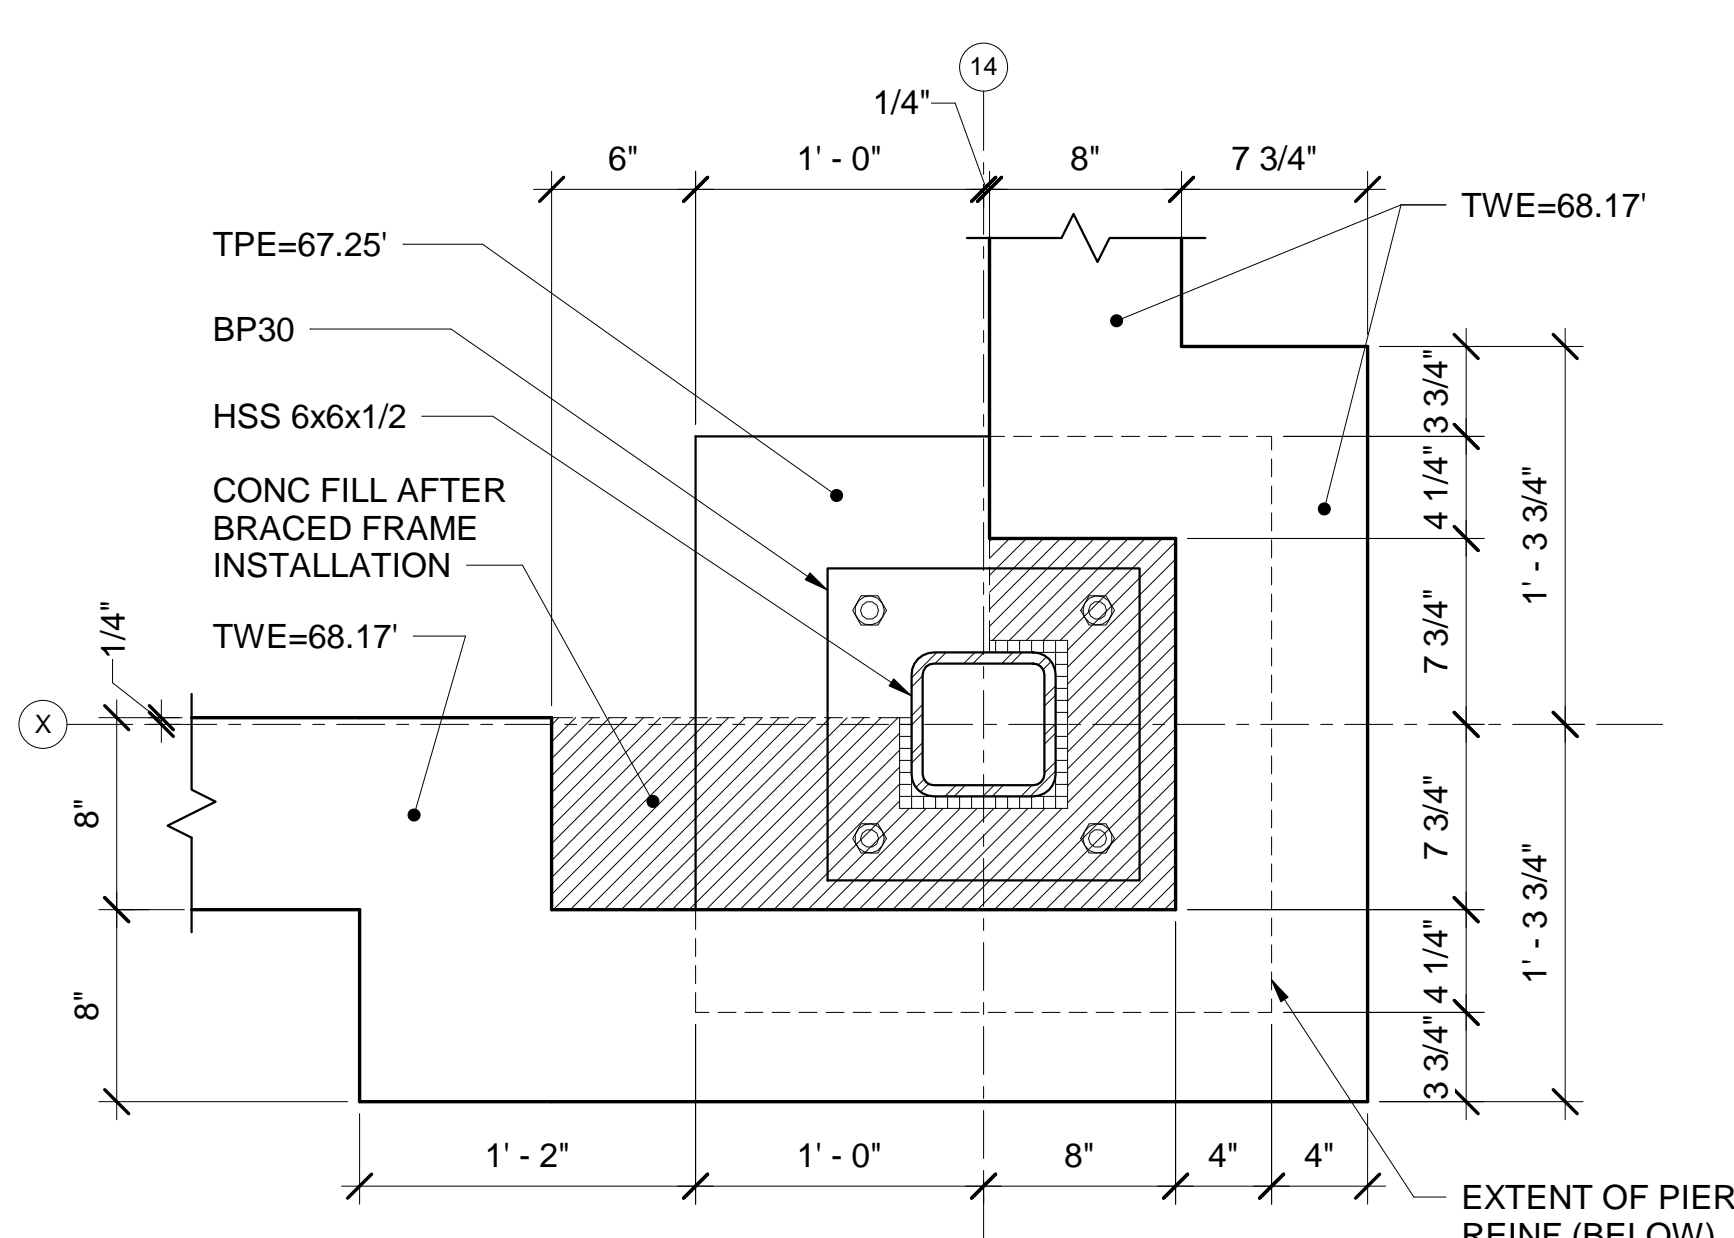


4 ENLARGED PIER PLAN AT COL LINE X/14
SB403 SCALE: 1 1/2" = 1'-0"

NOTES:
1. PROVIDE 1/2" PREFORMED FILLER AND SEALANT AROUND COLUMN AND BRACE PRIOR TO CONCRETE FILL.
2. TOP OF CONCRETE FILL ELEVATION = 69.17.

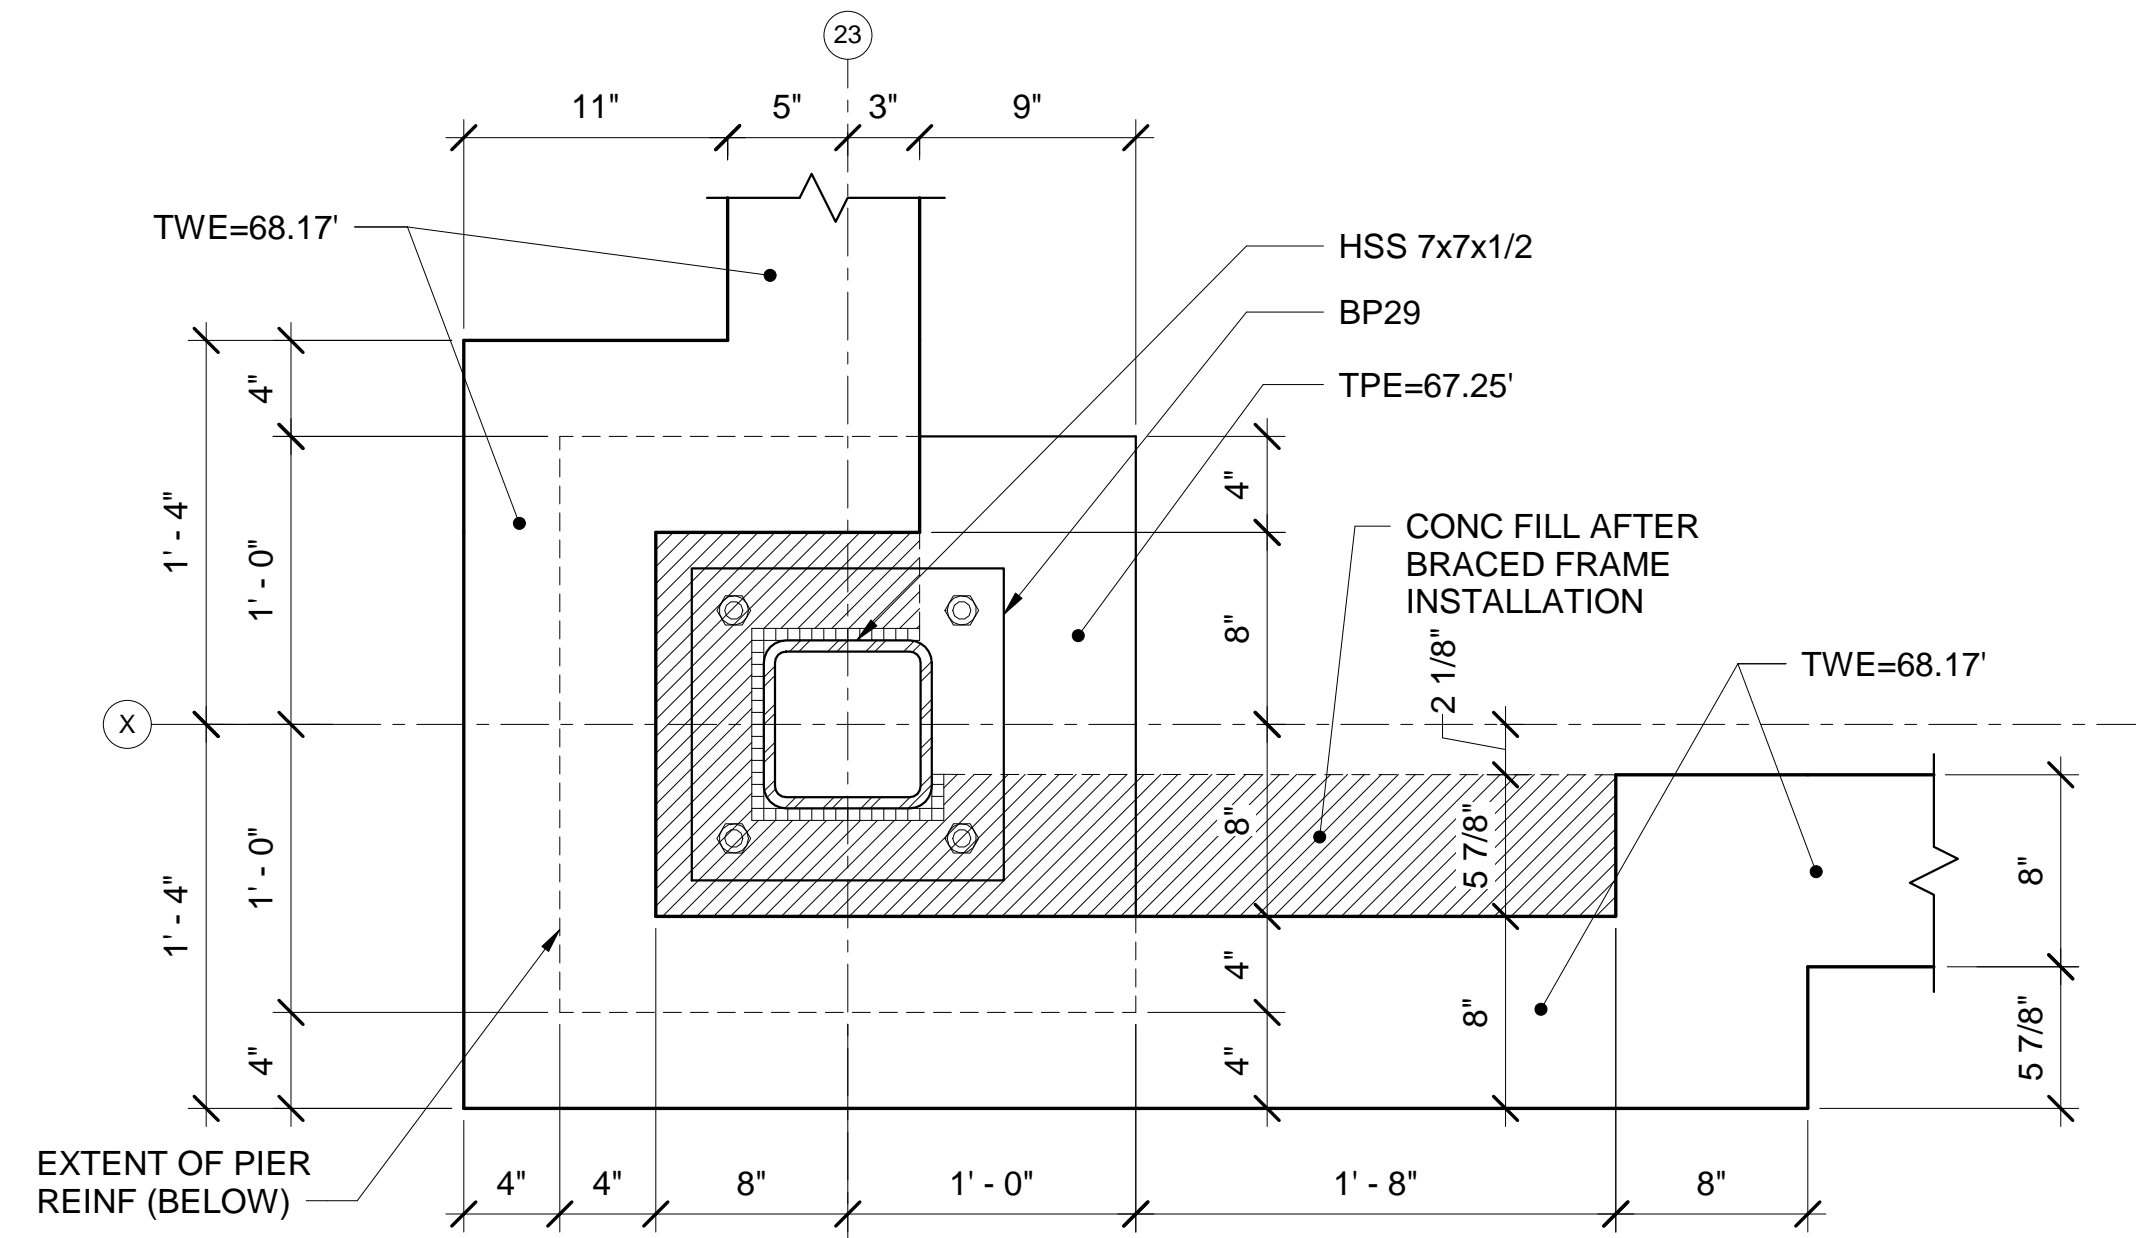


5 ENLARGED PIER PLAN AT COL LINE X/23
SB403 SCALE: 1 1/2" = 1'-0"

NOTES:
1. PROVIDE 1/2" PREFORMED FILLER AND SEALANT AROUND COLUMN AND BRACE PRIOR TO CONCRETE FILL.
2. TOP OF CONCRETE FILL ELEVATION = 69.17.

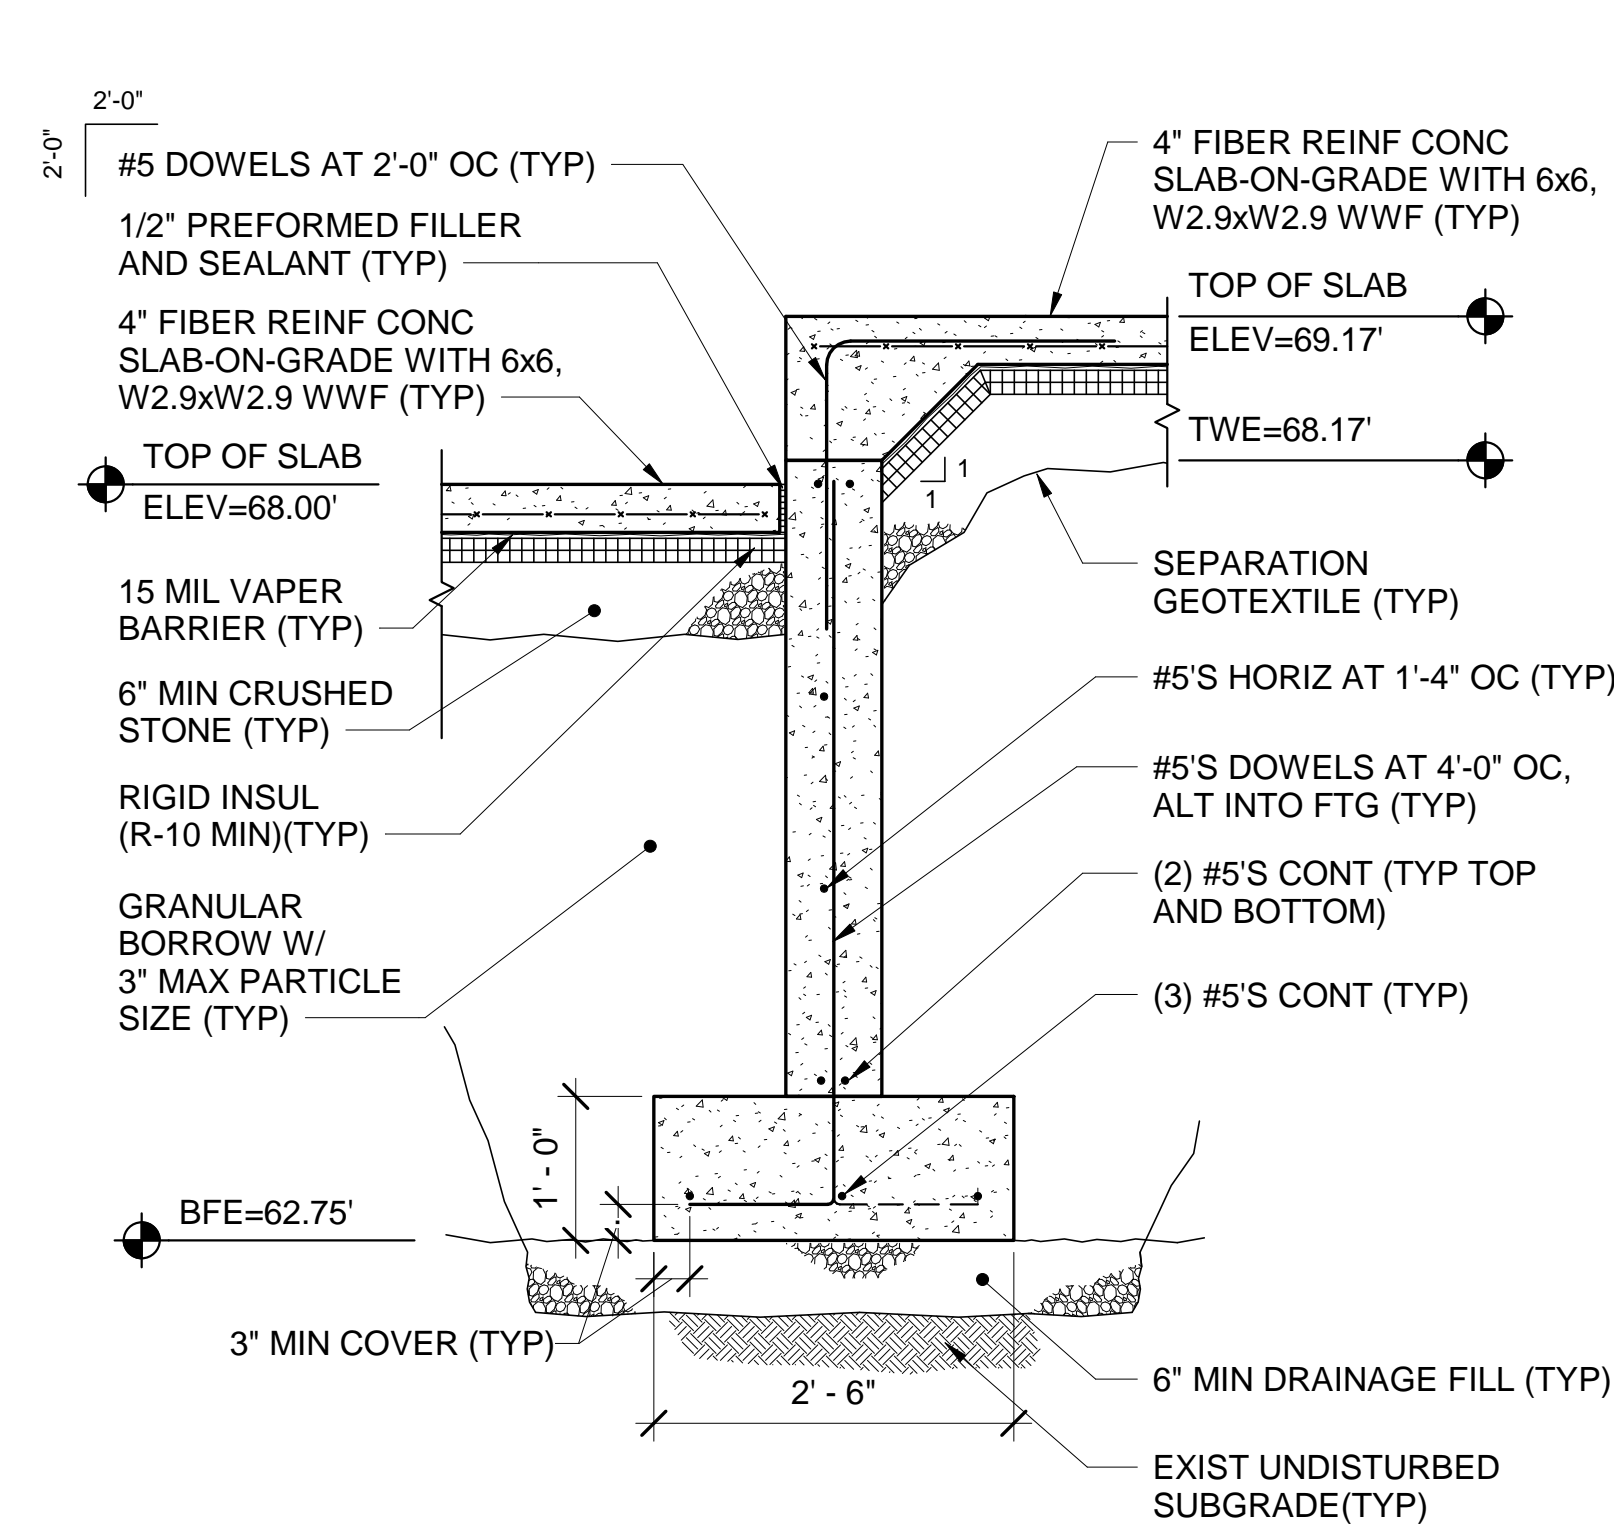

6 TYP 8" FND WALL DETAIL AT STAGE
SB403 SCALE: 3/4" = 1'-0"

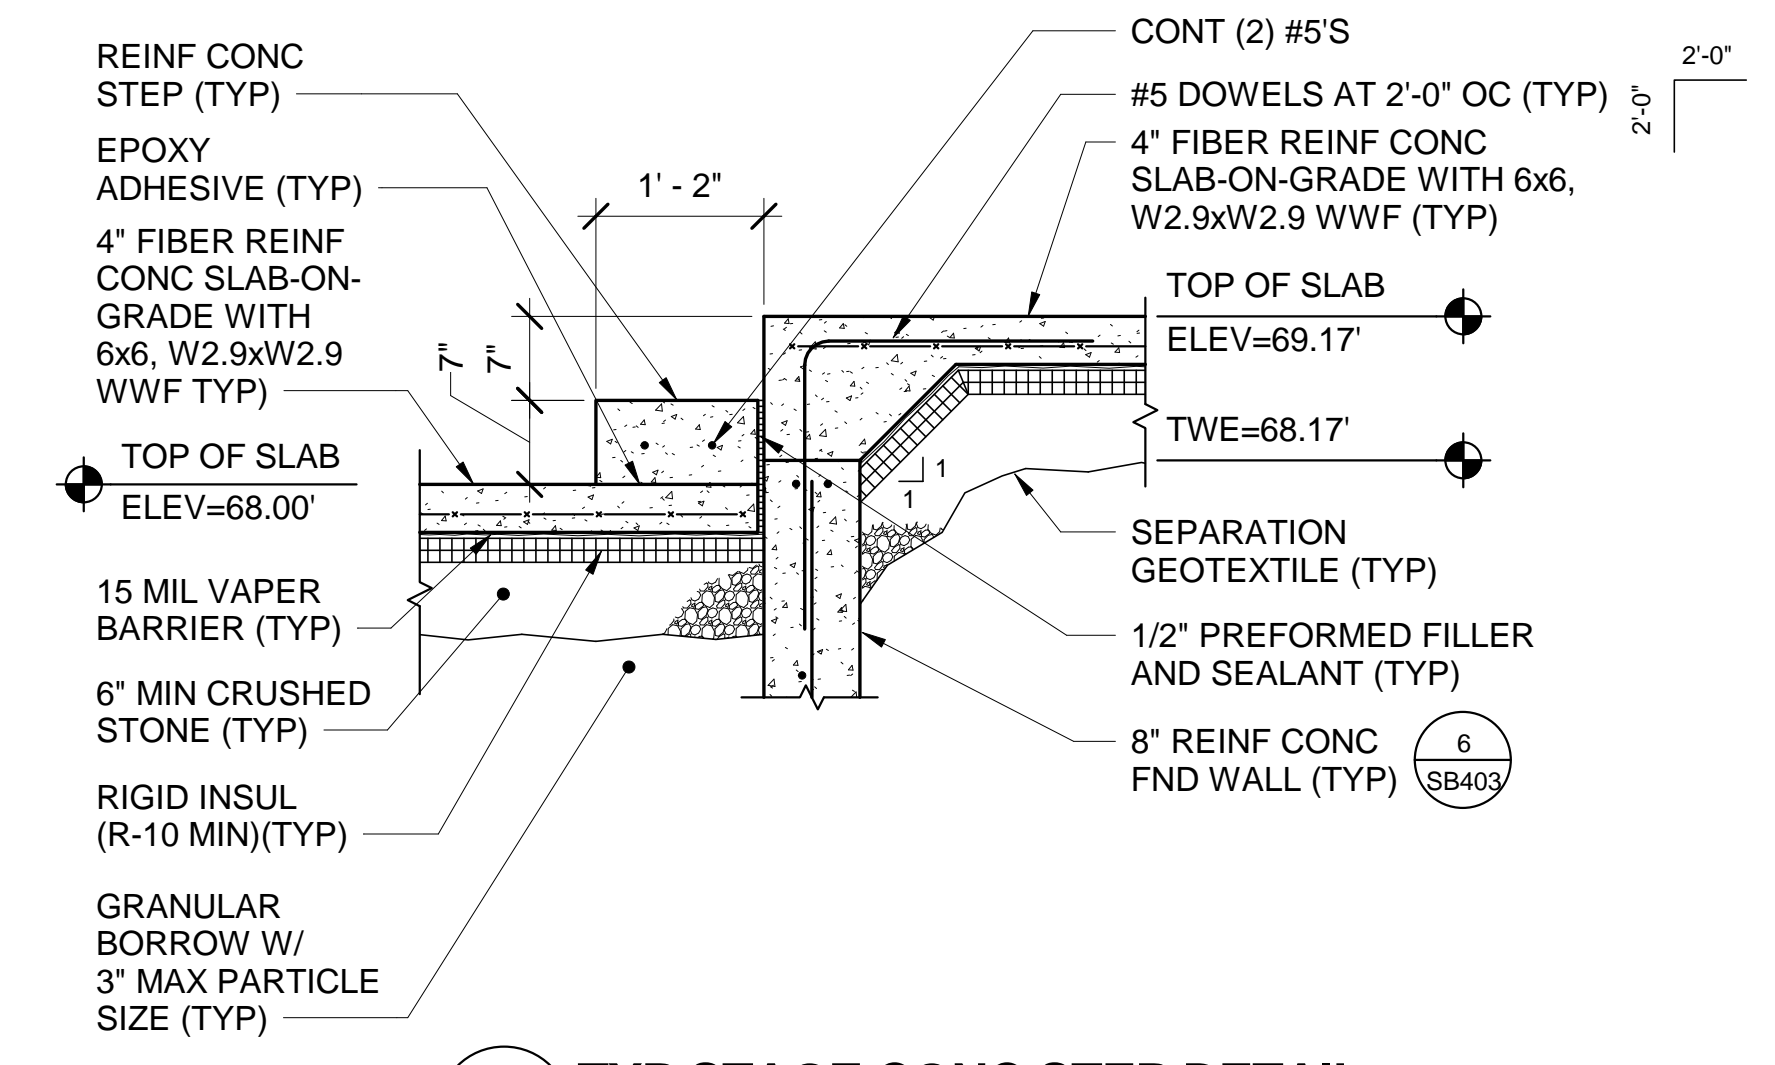


7 TYP STAGE CONC STEP DETAIL
SB403 SCALE: 3/4" = 1'-0"

DRAWING NOTES:

- REFER TO SHEET SB104 FOR SLAB CONTROL JOINTS AND EXPANSION JOINT LAYOUTS.
- REFER TO SHEET SB001 FOR FOOTING SCHEDULES.
- REFER TO SHEET SF604 FOR COLUMN BASE PLATE SCHEDULE.
- REFER TO PLUMBING DRAWINGS FOR FLOOR DRAIN LOCATIONS IN SLABS. PITCH SLAB-ON-GRADE TO FLOOR DRAINS AS REQUIRED.
- BOTTOM OF THE EXTERIOR AND INTERIOR CONTINUOUS FOUNDATION WALL FOOTINGS, EXTERIOR SPREAD FOOTINGS AND EXTERIOR COMBINED FOOTINGS SHALL BE 62.75, UNLESS NOTED OTHERWISE.
- BOTTOM OF THE ISOLATED INTERIOR COLUMN FOOTINGS SHALL BE 62.75, UNLESS NOTED OTHERWISE. REFER TO TYPICAL PIER DETAIL 7/SB501.
- TOP OF THE EXTERIOR FOUNDATION WALL SHALL BE 68.00' WITH AN INTEGRAL BRICK SHELVE ELEVATION OF 67.56', UNLESS NOTED OTHERWISE. REFER TO TYPICAL FOUNDATION WALL DETAIL 1/SB501.
- REFER TO SHEETS SB404 AND SB405 FOR ENLARGED PIER PLAN DETAILS.
- PROVIDE FOUNDATION WALL AND SLAB-ON-GRADE CONSTRUCTION JOINTS AT EACH EDGE OF CONCRETE PLACEMENT IN ACCORDANCE WITH DEALS 3/SB104 AND 5/SB502.
- REFER TO SHEET S-006 FOR COLUMN GRID SPACING.
- REFER TO SHEETS SB401 AND SB402 FOR ENLARGED MAT PLANS.
- PROVIDE CONTROL JOINTS IN FOUNDATION WALLS LOCATED BELOW BRICK VENEER CONTROL JOINTS AND AT A MAXIMUM SPACING OF 20'-0". COORDINATE WITH ARCHITECTURAL WALL ELEVATIONS FOR LOCATION OF CONTROL JOINTS. CONTROL JOINTS SHALL BE MADE BY 3/4" x 3/4" INSECTS ATTACHED TO FOUNDATION WALL FORMWORK. **KEYNOTES:** (THIS SHEET ONLY)

- 4" FIBER REINFORCED CONCRETE SLAB-ON-GRADE WITH 6x6, W2.9xW2.9 WELDED WIRE FABRIC. TOP OF SLAB ELEVATION = 68.00'.
- 4" FIBER REINFORCED CONCRETE SLAB-ON-GRADE WITH 6x6, W2.9xW2.9 WELDED WIRE FABRIC. TOP OF SLAB ELEVATION = 69.17'.
- 4" FIBER REINFORCED CONCRETE SLAB-ON-GRADE WITH 6x6, W2.9xW2.9 WELDED WIRE FABRIC. TOP OF SLAB ELEVATION = 68.84'.
- SLOPED 4" FIBER REINFORCED CONCRETE SLAB-ON-GRADE WITH 6x6, W2.9xW2.9 WELDED WIRE FABRIC. TOP OF SLAB ELEVATION VARIES.
- 8" REINFORCED CONCRETE FOUNDATION WALL. SEE DETAIL 6/SB403.
- 1'-0" x 2'-6" REINFORCED CONCRETE WALL FOOTING. SEE DETAIL 6/SB403.
- RADON PIT. SEE DETAIL 3/SB502.
- REINFORCED CONCRETE STEP. SEE DETAIL 7/SB403.
- CONCRETE FILL AROUND COLUMN/BRACED FRAME AFTER BRACED FRAME INSTALLATION. PROVIDE 1/2" PREFORMED FILLER AND SEALANT AROUND COLUMN AND BRACE. TOP OF CONCRETE FILL ELEVATION = 69.17'.
- (3) #4 DOWELS, 3'-0" LONG AT 4" ON-CENTER. LOCATE IN MIDDLE OF SLAB.

GRAPHIC SCALES

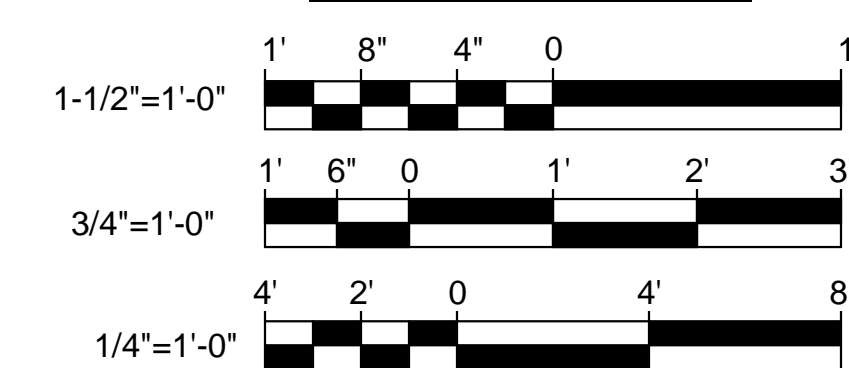

CHECK GRAPHIC SCALES BEFORE USING

		STATE OF MAINE PUBLIC SCHOOL PROJECT TITLE: PORTLAND PUBLIC SCHOOLS NEW FRED P. HALL ELEMENTARY SCHOOL LOCATION: 23 ORONO ROAD, PORTLAND, ME TITLE THIS DWG: ENLARGED PARTIAL FOUNDATION PLAN AND DETAILS	
DRAWN BY: MJC	CHECK BY: DNM	DATE: 03/17/17	
NO. DATE	DESCRIPTION	BY	NO.
	REVISIONS		