

LAYOUT & MATERIALS NOTES:

SURVEY NOTES

(1) Book and Page references are to the Cumberland County Registry of


(2) Bearings are referenced to magnetic north 1926 (see plan reference #1).

(3) This is not a Boundary Survey. Property lines shown are taken from Plan Reference 1.

**REFERENCES** 

(1) "Boundary Survey" 512 Warren Avenue for M.T.S., LLC by Owen Haskell, Inc. dated March 25, 2003.

(2) "Final Site Plan" Jokers Two, Inc. 510 Warren Avenue for Jokers Inc., by Land Use Consultants, Inc. dated 10-07-96.

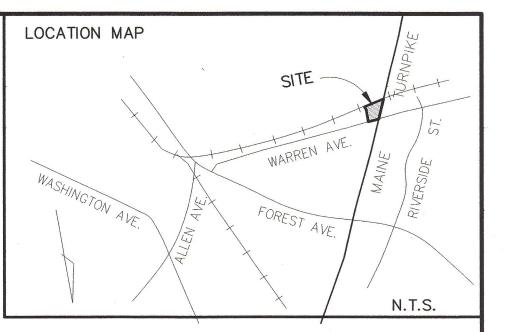

### GENERAL PROJECT NOTES:

- PRIOR TO THE START OF ANY EXCAVATION FOR THE PROJECT BOTH ON AND OFF SITE, THE CONTRACTOR SHALL NOTIFY DIGSAFE AND BE PROVIDED WITH A DIGSAFE NUMBER INDICATING THAT ALL EXISTING UTILITIES HAVE BEEN LOCATED AND MARKED
- 2. CONTRACTOR SHALL THOROUGHLY FAMILIARIZE HIMSELF WITH ALL DRAWINGS AND SITE CONDITIONS PRIOR TO BIDDING AND PRIOR TO CONSTRUCTION.
- 3. THE CONTRACTOR IS RESPONSIBLE FOR FAMILIARIZING THEMSELVES WITH THE CONDITIONS OF ALL PERMITS AND CONDUCTING ALL WORK IN ACCORDANCE WITH THESE PERMITS.
- 4. ANY DISCREPANCIES BETWEEN DRAWINGS AND SITE CONDITIONS AS WELL AS MANUFACTURER'S RECOMMENDATIONS SHALL BE REPORTED IMMEDIATELY TO THE OWNER'S REPRESENTATIVE FOR CLARIFICATION AND RESOLUTION PRIOR TO BIDDING OR CONSTRUCTION.
- 5. WHERE EXISTING CONDITIONS LIE UNDER OR ARE IMPINGED UPON BY PROPOSED BUILDINGS AND/OR SITE ELEMENTS, THE EXISTING CONDITION WILL BE REMOVED, ADJUSTED, ABANDONED AND/OR CAPPED OR DEMOLISHED, AS REQUIRED.
- 6. CONTRACTOR SHALL BE SOLELY RESPONSIBLE FOR ALL MEANS, METHODS AND TECHNIQUES EMPLOYED TO PERFORM WORK SHOWN ON THESE PLANS.
- 7. REFER TO DRAWINGS C-100 THRU C-103, C-300 THRU C-302 FOR ADDITIONAL INFORMATION.

### EXISTING CONDITIONS & DEMOLITION NOTES:

. THE LOCATIONS OF UNDERGROUND UTILITIES ARE APPROXIMATE AND NOT GUARANTEED BY THE OWNER OR THE ENGINEER. IT IS THE CONTRACTORS RESPONSIBILITY TO LOCATE ALL UTILITIES, ANTICIPATE CONFLICTS, REPAIR OR ADJUST EXISTING UTILITIES AS REQUIRED TO COMPLETE THE

- 2. THE CONTRACTOR SHALL BE RESPONSIBLE FOR ALL DEMOLITION AND OFF-SITE DISPOSAL OF MATERIALS REQUIRED TO COMPLETE THE WORK. CONTRACTOR SHALL CLEAR, GRUB AND REMOVE ALL VEGETATION AND STUMPS WITHIN THE LIMIT OF WORK UNLESS SPECIFIED TO REMAIN.
- 3. ALL MATERIALS DESIGNATED FOR REMOVAL SHALL BECOME THE PROPERTY OF THE CONTRACTOR UNLESS OTHERWISE SPECIFIED. THE CONTRACTOR SHALL DISPOSE OF ALL MATERIALS OFF-SITE IN ACCORDANCE WITH ALL LOCAL, STATE AND FEDERAL REGULATIONS, ORDINANCES AND CODES.
- 4. ANY EXISTING PROPERTY DAMAGED BY THE CONTRACTOR SHALL BE REPAIRED OR REPLACED BY THE CONTRACTOR TO MATCH ITS ORIGINAL EXISTING CONDITION AT NO CHARGE TO THE OWNER.
- 5. A TIER I NATURAL RESOURCE PROTECTION ACT PERMIT FOR FILLING APPROXIMATELY 14,060 SQUARE FEET OF WETLAND HAS BEEN APPROVED BY THE MAINE DEP AND THE ARMY CORPS. OF ENGINEERS. THE DEP PERMIT NUMBER IS L-21366-TC-A-N. THE DEP AND ARMY CORPS. PERMITS HAVE BEEN SUBMITTED TO THE CITY OF PORTLAND FOR THEIR RECORDS.
- 6. REFER TO C-100 FOR GENERAL PROJECT NOTES AND DRAWINGS C-100 THRU C-103, C-300 THRU C-302, FOR ADDITIONAL INFORMATION.

LEGEND				,	
EXISTING		PROPOSED	<u>EXISTING</u>		PROPOSED
	BUILDING		0	UTILITY POLE	B
GV ⋈	GAS VALVE		ф	LIGHT POLE TO REMAIN	<b>\$</b>
TP TP	TEST BORING			LIGHT POLE	□-•
78T 78T 78T	WETLAND STREAM			WALL MOUNTED LIGHT RELOCATED LIGHT POLE	<b>▼</b>
	PROPERTY LINE			LANDSCAPE AREA	L.A
	RIGHT-OF-WAY LINE			CATCH BASIN	■ CB
	EASEMENT LINE. PROPERTY SETBACK		T	TRANSFORMER FIRE HYDRANT	*
	BIT. CONCRETE	BITUMINOUS CONCRETE	→ <sub>\(\bar{\gamma}\)\\</sub>	CULVERT	
	BITUMINOUS CURB PRECAST CONCRETE CURB		•	SANITARY MANHOLE	● SM
	CONCRETE DOOR PAD				
	TREELINE CONCRETE BOLLARD SIGN SWALE	~~~		0' 20' 4	40'-0"


NOTE: EXISTING CONDITIONS SOLVET FERT STATES							
THIS PLAN SHALL NOT BE MODIFIED WITHOUT WRITTEN PERMISSION FROM SYTDesign CONSULTANTS, ANY ALTERATIONS, OTHERWISE, SHALL BE AT THE USER'S SOLE RISK AND WITHOUT LIABILITY TO SYTDESIGN CONSULTANTS.		8-19-03	REVISED FOR CITY OF PORTLAND SITE PLAN APPROVAL AND CONSTRUCTION	PBB	WSD	WSD	
		8-5-03	REVISED FOR CITY OF PORTLAND SITE PLAN APPROVAL AND CONSTRUCTION	PBB	WSD	WSD	
	1	7-18-03	ISSUED FOR CONSTRUCTION	PBB	WSD	WSD	
	С	7-15-03	REVISED AND RESUBMITTED FOR CITY OF PORTLAND SITE PLAN REVIEW	PBB	WSD	WSD	
	В	5-20-03	ISSUED FOR PRICING	PBB	WSD	WSD	
	Α	4-2-03	CITY OF PORTLAND SITE PLAN REVIEW	PBB	WSD	WSD	
NO REFERENCE DRAWINGS	REV	/ DATE	STATUS	BY	CHKD	APPD	

REV. DATE


REFERENCE DRAWINGS



P.O. BOX 86A, CUMBERLAND CENTER, ME. 04021 Phone: (207) 829-6994 Fax: (207) 829-2231 Email: info@sytdesign.com		FIELD BOOK #	DESIGN: PB	В	PROJECT	PORTLAND SPORTS CENTER
		FIELD BOOK PAGE	DRAWN: PB	В		512 WARREN AVENUE, PORTLAND, MAINE
		FLAT FILE	CHKD: WS	D	EXISTING CONDITIONS AND	
		INDEX NUMBER			DEMOLITION PLAN	
	CLIENT: DeStefano & Associates, Inc.	PROJECT DIR.	DATE: AP	RIL 2003	PROJ. NO.	APPROVED SITE PLAN 213-00 REV.
7	2456 LAFAYETTE ROAD, PORTSMOUTH, NH 03801	DRAWING NAME	SCALE: 1"=	= 40'	DWG. NO.	OF Zate of Approval: 3

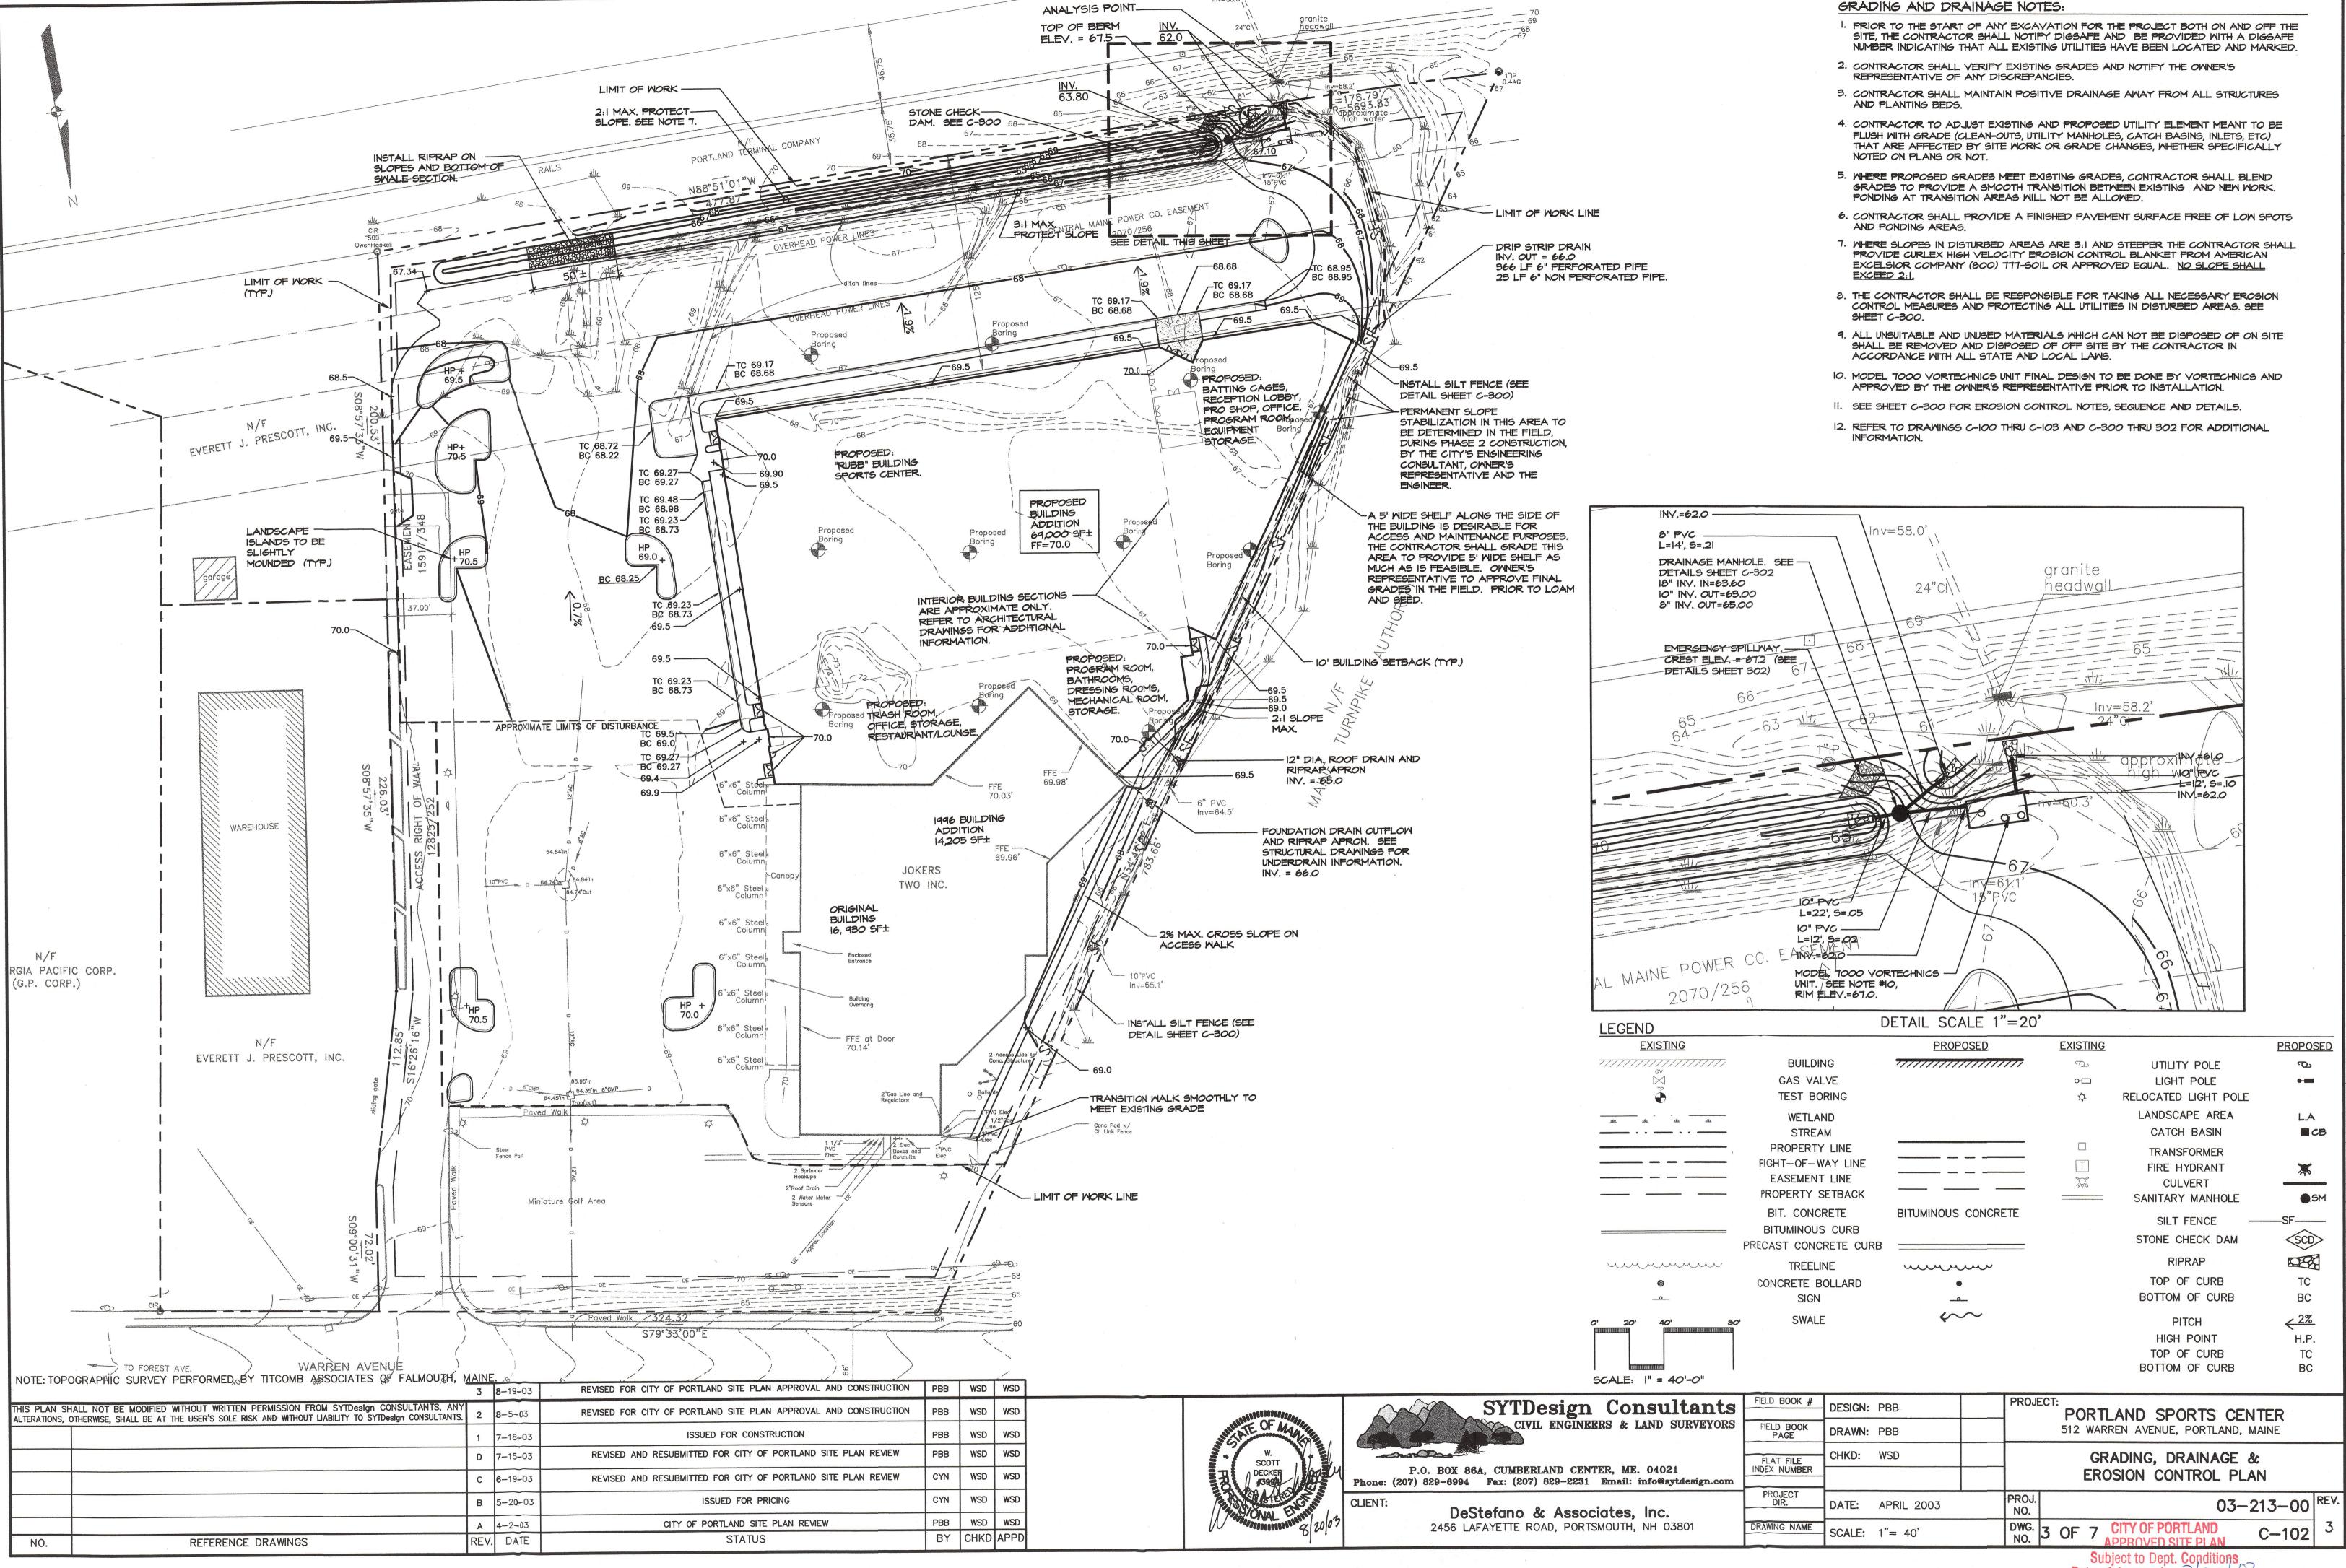

Date of Approval: \_

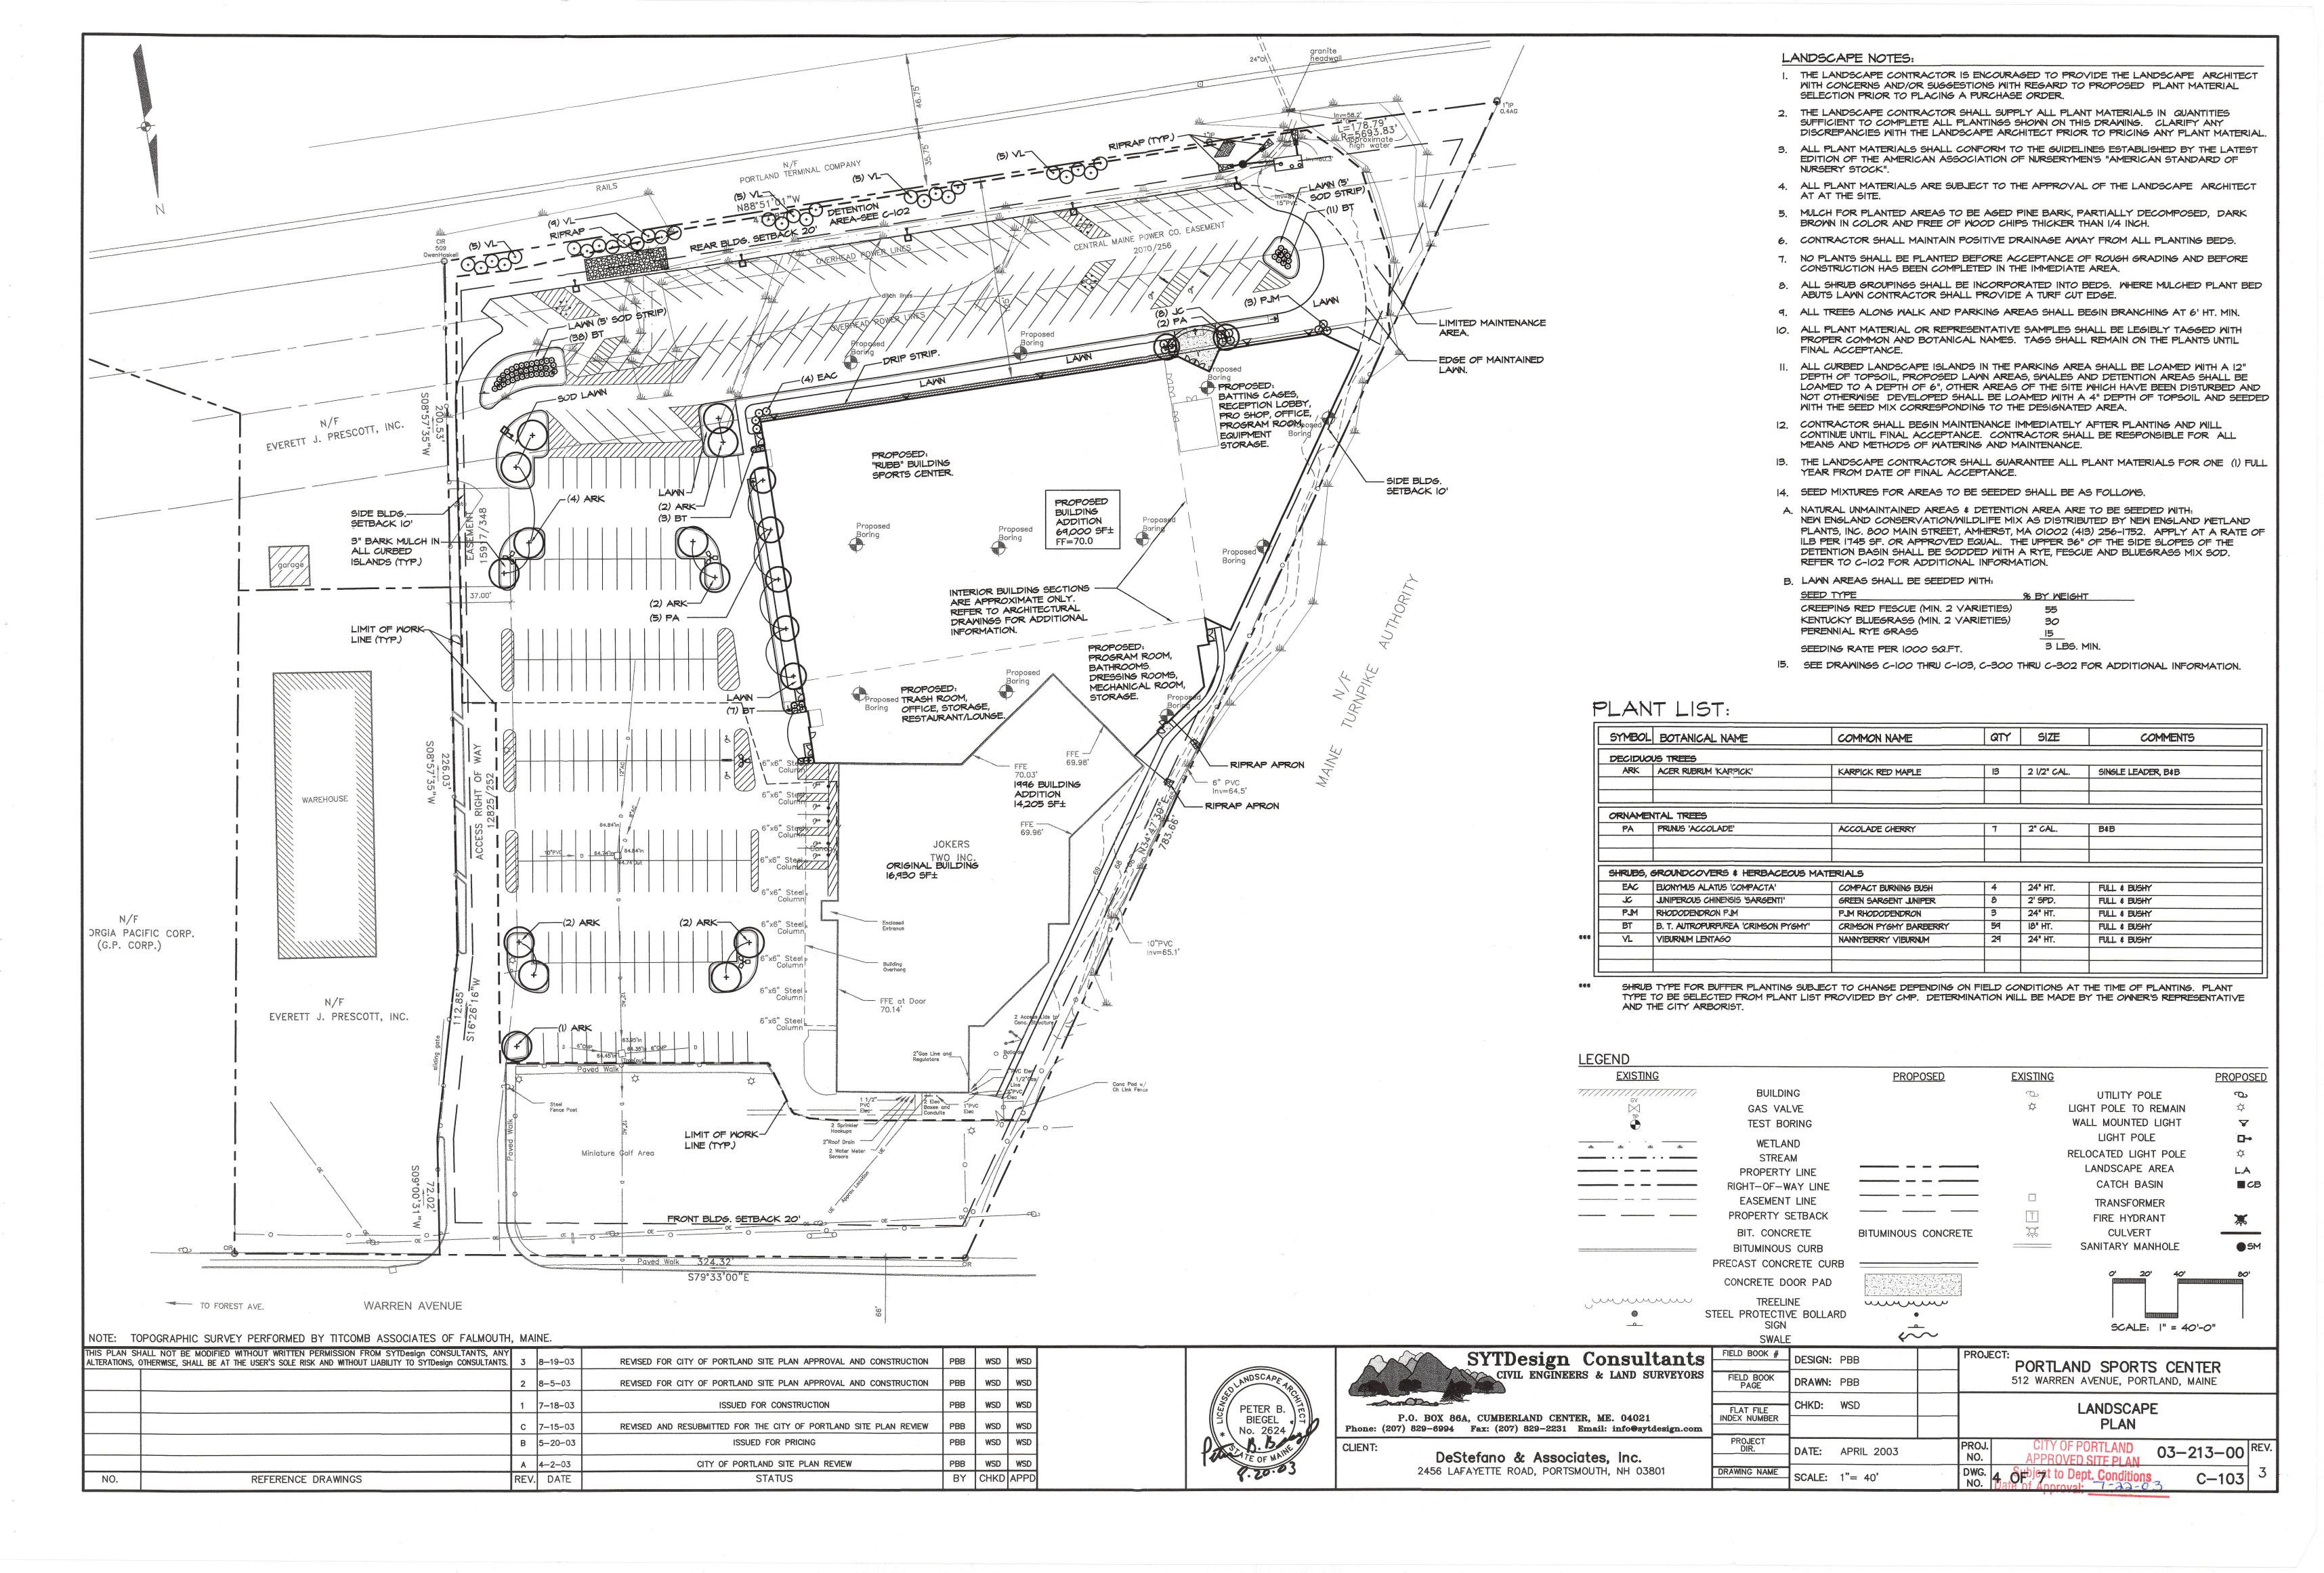

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### **EROSION CONTROL MEASURES:**

- . IT IS ANTICIPATED THAT CONSTRUCTION MAY BEGIN AS SOON AS POSSIBLE FOLLOWING RECEIPT OF NECESSARY PERMITS.
- 2. ALL SOIL EROSION AND SEDIMENT CONTROL SHALL BE DONE IN STRICT ACCORDANCE WITH THE MAINE EROSION AND SEDIMENT CONTROL HANDBOOK FOR CONSTRUCTION: BEST MANAGEMENT PRACTICES, CUMBERLAND COUNTY SOIL AND WATER CONSERVATION DISTRICT, DEPARTMENT OF ENVIRONMENTAL PROTECTION, MARCH 1991, OR AS CURRENTLY REVISED.
- 3. PRIOR TO BEGINNING CONSTRUCTION, THE STONE CONSTRUCTION ENTRANCE AND TEMPORARY SILT FENCE SHALL BE INSTALLED AS SHOWN ON THE PLANS. SILT FENCE SHALL BE INSPECTED IMMEDIATELY AFTER EACH RAINFALL AND AT LEAST DAILY DURING PROLONGED RAINFALL. ANY REQUIRED REPAIRS WILL BE MADE IMMEDIATELY. SEDIMENT DEPOSITS SHALL BE PERIODICALLY REMOVED FROM THE UPSTREAM SIDE OF THE SILT BARRIERS. THIS SEDIMENT WILL BE SPREAD AND STABILIZED IN AREAS OF THE SITE NOT SUBJECT TO EROSION. SILT FENCE SHALL BE REPLACED AS NECESSARY TO PROVIDE PROPER FILTERING ACTION.
- 4. ANY ADDITIONAL EROSION/SEDIMENTATION CONTROL DEEMED NECESSARY BY AUTHORIZED GNP CO. AND/OR DEPARTMENT ENVIRONMENTAL PROTECTION (DEP) PERSONNEL SHALL BE INSTALLED BY THE APPLICANT'S CONTRACTOR. IN ADDITION, THE APPLICANT'S CONTRACTOR SHALL BE RESPONSIBLE FOR THE REPAIR/REPLACEMENT/MAINTENANCE OF ALL EROSION CONTROL MEASURES UNTIL ALL DISTURBED AREAS ARE STABILIZED TO THE SATISFACTION OF MUNICIPAL OFFICIALS.
- 5. REMOVAL OF SOD, TREES, BUSHES AND OTHER VEGETATION AND SOIL DISTURBANCE WILL BE KEPT TO A MINIMUM WHILE ALLOWING PROPER SITE DEVELOPMENT.
- 6. GRADING OPERATIONS TEMPORARY DIVERSION BERMS AND DRAINAGE SWALES SHALL BE CONSTRUCTED AS NECESSARY. THE SITE SHALL BE BROUGHT TO APPROXIMATE FINISH GRADES AND STABILIZED WITHOUT EXTENDED DELAYS. STABILIZATION INCLUDES THE APPLICATION OF EROSION CONTROL BLANKET OR MULCH TO ALL SURFACES DESIGNATED TO BE REVEGETATED; CONSTRUCTION OF RIPRAP SURFACES, AND PLACEMENT OF GRAVEL SURFACES. SILT FENCE AND OTHER EROSION AND SEDIMENT CONTROL MEASURES SHALL BE INSTALLED AND/OR ADJUSTED TO SUIT CONSTRUCTION IMMEDIATELY AFTER A CUT OR FILL SLOPE HAS BEEN FORMED. STONE CHECK DAMS, RIPRAP INLET AND OUTLET PROTECTION, AND DITCH LININGS WILL BE INSTALLED AS THE WORK PROGRESSES. INITIAL DISTURBANCE/EXPOSURE THE FOLLOWING EROSION CONTROL MEASURES WILL BE UNDERTAKEN:
  - A. <u>FILL SLOPES, PERIMETER DISTURBANCE, AND COMPLETED CUTS</u>: SHALL BE ROUGH GRADED, AND COVERED WITH A HEAVY APPLICATION OF MULCH PRIOR TO ANY SIGNIFICANT RAINFALL EVENT AND/OR AT LEAST WEEKLY WHETHER FINISHED OR NOT.
  - B. <u>UNCOMPLETED CUTS:</u> SHALL BE ROUGH GRADED TO DRAIN TO OTHER EROSION CONTROL MEASURES PRIOR TO ANY SIGNIFICANT RAINFALL EVENT.
  - C. BUILDING AREAS AND AREAS RECEIVING SURFACING: SHALL BE GRADED TO DIRECT RUNOFF TO OTHER EROSION CONTROL MEASURES AT ALL TIMES.
- 7. RIPRAP REQUIRED AT CULVERTS AND STORM DRAIN OUTLETS SHALL CONSIST OF FIELD STONE OR ROUGH UNHEWN QUARRY STONE OF APPROXIMATELY RECTANGULAR SHAPE.
- 8. EROSION CONTROL BLANKET SHALL BE INSTALLED ON ALL PERMANENT SLOPES AND DITCHES NOT OTHERWISE PROTECTED.
- 9. IMMEDIATELY FOLLOWING FINAL GRADING ALL GRADED OR DISTURBED AREAS NOT TO BE BUILT ON OR SURFACED SHALL BE LOAMED AND SEEDED TO ESTABLISH PERMANENT VEGETATIVE COVER.

### A. TOPSOIL:

1. SPREAD TOPSOIL IN DISTURBED AREAS AS DESCRIBED ON C-103 LANDSCAPE PLAN.

# B. SOIL AMENDMENTS: (REFER TO LANDSCAPE DRAWING)

# C. SEEDING

1. TEMPORARY SEEDING — SHALL CONSIST OF THE FOLLOWING SEED MIX PROPORTIONED BY WEIGHT AND SPREAD AT A RATE AS RECOMMENDED BY THE SUPPLIER, BUT NOT LESS THAN 3/LBS. PER 1000 S.F.

- a. AROOSTOOK RYE: RECOMMENDED SEEDING DATES 9/15 THRU 11/1, RECOMMENDED APPLICATION RATE 112/LBS. PER ACRE.
- b. ANNUAL RYE GRASS: RECOMMENDED SEEDING DATES 4/1 THRU 7/1, RECOMMENDED APPLICATION RATE 40/LBS. PER ACRE.
- c. PERENNIAL RYE GRASS: RECOMMENDED SEEDING DATES 8/15 THRU 9/15, RECOMMENDED APPLICATION RATE 40/LBS. PER ACRE.
- 2. DORMANT SEEDING IF PERMANENT VEGETATED STABILIZATION CANNOT BE ESTABLISHED DUE TO THE SEASON OF THE YEAR, ALL EXPOSED AND DISTURBED AREAS NOT TO UNDERGO FURTHER DISTURBANCE SHALL HAVE DORMANT SEEDING APPLIED AND TEMPORARILY MULCHED WITH HAY AT A RATE OF 2 TONS PER ACRE TO PROTECT THE SITE. A SUITABLE BINDER SUCH AS CURASOL OR TERRATACK SHALL BE USED TO SECURE THE HAY MULCH. THE FOLLOWING METHODS MAYBE USED TO PERFORM DORMANT SEEDING:
- a. PREPARE THE SEEDBED, ADD THE REQUIRED AMOUNTS OF LIME AND FERTILIZER, THEN MULCH AND ANCHOR. AFTER THE FIRST KILLING FROST AND BEFORE SNOW FALL, BROADCAST OR HYDROSEED THE SELECTED SEED MIXTURE. DOUBLE THE REGULAR SEEDING RATES FOR THIS TYPE OF SEEDING.
- b. WHEN SOIL CONDITIONS PERMIT, BETWEEN THE FIRST KILLING FROST AND BEFORE SNOW FALL, PREPARE THE SEEDBED, LIME AND FERTILIZE, APPLY THE SELECTED SEED MIXTURE AND MULCH AND ANCHOR. DOUBLE THE REGULAR SEEDING RATES FOR THIS TYPE OF SEEDING.
- c. DORMANT SEEDING NEEDS TO BE ANCHORED EXTREMELY WELL ON SLOPES, DITCH BASES AND AREAS OF CONCENTRATED FLOWS.
- d. DORMANT SEEDING REQUIRES INSPECTION AND RESEEDING AS NEEDED IN THE SPRING. ALL AREAS WHERE COVER IS INADEQUATE MUST BE IMMEDIATELY RESEEDED AND MULCHED AS SOON AS POSSIBLE.
- 3. PERMANENT SEEDING- REFER TO C-103 LANDSCAPE PLAN.


THIS PLAN SHALL NOT BE MODIFIED WITHOUT WRITTEN PERMISSION FROM SYTDesign CONSULTANTS, ANY


ALTERATIONS, OTHERWISE, SHALL BE AT THE USER'S SOLE RISK AND WITHOUT LIABILITY TO SYTDESIGN CONSULTANTS.

REFERENCE DRAWINGS


C. MULCHING OR INSTALLATION OF EROSION CONTROL BLANKET SHALL BE DONE IN CONJUNCTION WITH ALL SEEDING. IMMEDIATELY AFTER SEEDBED PREPARATION; LIMING, FERTILIZATION, AND SEEDING, HAY, STRAW OR WOOD FIBER CELLULOSE SHALL BE SPREAD UNIFORMLY. THE MULCH MAY BE ANCHORED IN PLACE BY UNIFORMLY APPLYING AN ACCEPTABLE MULCH BINDER.

- 10. IF GERMINATION IS UNSUCCESSFUL (LESS THAN 75 PERCENT CATCH) WITHIN 30 DAYS OF SEEDING OR THERE IS UNSATISFACTORY GROWTH IN THE NEXT YEAR, THE APPLICANT SHALL RESEED THE AREA IN ACCORDANCE WITH THE SEEDING SPECIFICATIONS LISTED ABOVE.
- 11. AREAS WHICH ARE TO BE BUILT ON OR SURFACED, SHALL RECEIVE A THICK LAYER OF HAY MULCH TO PROTECT THE SURFACE DURING SPRING RUNOFF CONDITIONS.
- 12. THE SITE SHALL BE CLEANED OF EXCESS MATERIAL, TRASH AND DEBRIS. TEMPORARY EROSION/SEDIMENTATION CONTROL DEVICES SHALL BE REMOVED. SEDIMENTS SHALL BE DISTRIBUTED WITHIN AREAS NOT SUBJECT TO EROSION, THEN SEEDED AND MULCHED.
- 13. WINTER CONDITIONS A. SILT FENCE IN LIEU OF PROVIDING THE 4" x 4" TRENCH FOR FROZEN GROUND, STONY SOIL, THE PRESENCE OF LARGE ROOTS, OR OTHER PROHIBITIVE CONDITIONS, THE BOTTOM 8" 12" OF THE FABRIC MAY BE LAID ON EXISTING GRADE AND BACK FILLED WITH STONE ANCHORING MATERIAL, AS SHOWN ON THE DRAWINGS.

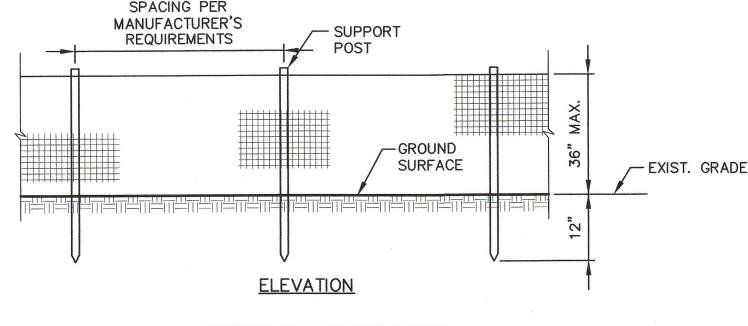

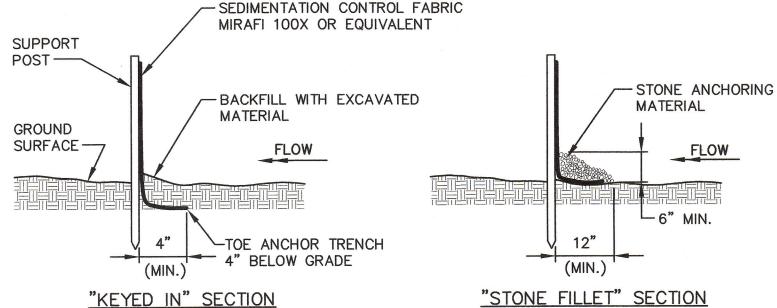

# SILTATION FENCE

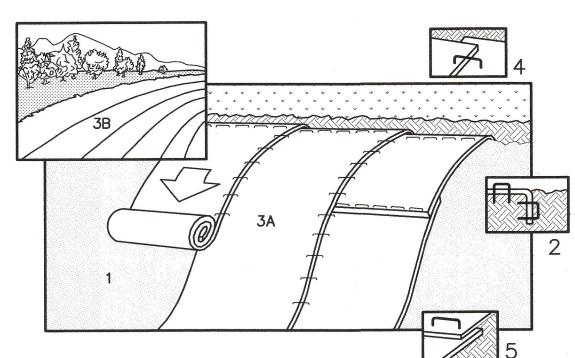

- NOTE: REFER TO GENERAL STAPLE PATTERN GUIDE FOR CORRECT STAPLE PATTERN RECOMMENDATIONS FOR SLOPE INSTALLATIONS.
- 1. PREPARE SOIL BEFORE INSTALLING BLANKETS, INCLUDING APPLICATION OF LIME, FERTILIZER, AND SEED. NOTE: WHEN USING CELL—O—SEED DO NOT SEED PREPARED AREA. CELL—O—SEED MUST BE INSTALLED WITH PAPER SIDE DOWN.
- 2. BEGIN AT THE TOP OF THE SLOPE BY ANCHORING THE BLANKET IN 6" DEEP X 6" WIDE TRENCH. BACKFILL AND COMPACT THE TRENCH AFTER STAPLING.
- 3. ROLL THE BLANKETS (A.) DOWN OR (B.) HORIZONTALLY ACROSS THE SLOPE.
- 4. THE EDGES OF PARALLEL BLANKETS MUST BE STAPLED WITH APPROXIMATELY 2" OVERLAP.
- 5. WHEN BLANKETS MUST BE SPLICED DOWN THE SLOPE, PLACE BLANKETS END OVER END (SHINGLE STYLE) WITH APPROXIMATELY 4" OVERLAP. STAPLE THROUGH OVERLAPPED AREA, APPROXIMATELY 12" APART.

# EROSION CONTROL BLANKET

N.T.S.


(SLOPE INSTALLATION)

PBB | WSD | WSD


### CONSTRUCTION SEQUENCE:

IT IS ANTICIPATED THAT CONSTRUCTION WILL COMMENCE UPON RECEIPT OF ALL NECESSARY PERMITS AND APPROVALS. THE FOLLOWING OUTLINES THE PRELIMINARY CONSTRUCTION SEQUENCE.

- 1. JULY 2003 CLEAR VEGETATION AND INSTALL TEMPORARY EROSION CONTROL MEASURES.
- 2. GRUB SITE/REMOVE AND STOCKPILE TOPSOIL.
- 3. COMMENCE BUILDING CONSTRUCTION.
- 4. INSTALL STORM DRAINS AND OTHER UTILITIES.
- 5. EXCAVATION AND SUBGRADE CONSTRUCTION OF DRIVES AND PARKING AREAS.
- 6. PLACEMENT OF GRAVEL.
- 7. OCTOBER 2003 SITE STABILIZATION (BITUMINOUS PAVEMENT / LOAM, SEED AND MULCH). REMOVE TEMPORARY EROSION CONTROL MEASURES AFTER ALL DISTURBED AREAS ARE STABILIZED (75 % VIGOROUS GROWTH IN VEGETATED AREAS).
- 8. 2004 COMMENCE PHASE 2 BUILDING CONSTRUCTION.
- 9. 2004 PHASE 2 SITE STABILIZATION (BITUMINOUS PAVEMENT / LOAM, SEED AND MULCH). REMOVE TEMPORARY EROSION CONTROL MEASURES AFTER ALL DISTURBED AREAS ARE STABILIZED (75 % VIGOROUS GROWTH IN VEGETATED AREAS).

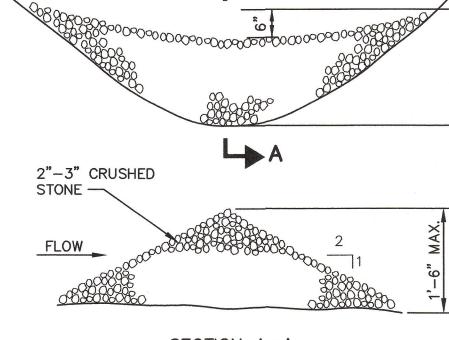


SECTION A-A

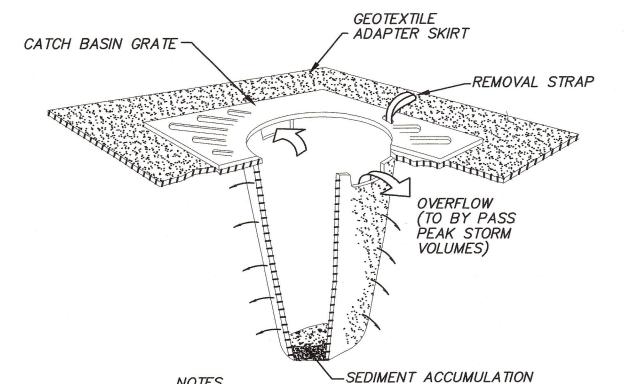


1. CATCH BASIN PROTECTION TO BE "SILTSTACK" (BY ACF ENVIRONMENTAL) OR "STREAM GUARD" (BY FOSS ENVIRONMENTAL SERVICES).

- 2. INSERT TO BE EMPTIED IN AN APPROVED MANNER WHEN IT IS 1/2 FULL OF SEDIMENT.
- 3. INSPECT INSERT AFTER ALL RAINFALL EVENTS, REPAIR AND MAINTAIN AS REQUIRED.

# TEMPORARY INLET PROTECTION

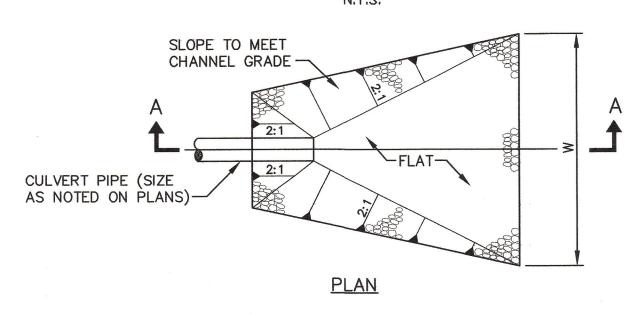


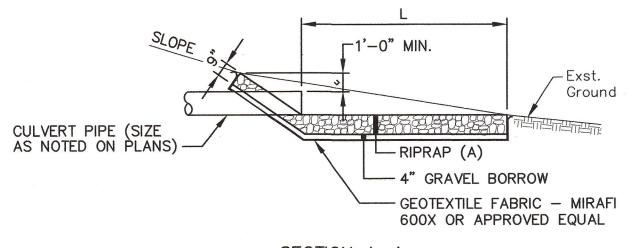

# SECTION A—A DIAMETER L W A D<sub>50</sub> 12" 6' 4' 8" 3" \*\*\* 15" 6' 4' 12" 4" \*\*\* RIPRAP USED FOR THE DETENTION POND OUTLET SHALL BE D50 = 9".

# RIPRAP INLET/OUTLET PROTECTION

N.T.S.

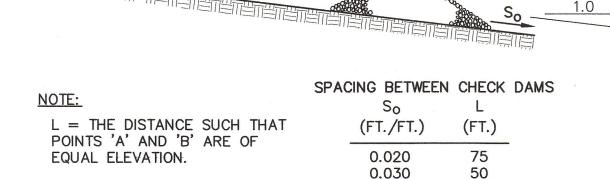

# STONE CHECK DAM DETAIL

0.040

0.050

0.080


0.100

CRITICAL POINTS

A. OVERLAPS AND SEAMS

B. PROJECTED WATER LINE


NOTE: HORIZONTAL STAPLE SPACING SHOULD BE ALTERED IF NECESSARY TO ALLOW STAPLES TO SECURE THE CRITICAL POINTS ALONG THE CHANNEL SURFACE.

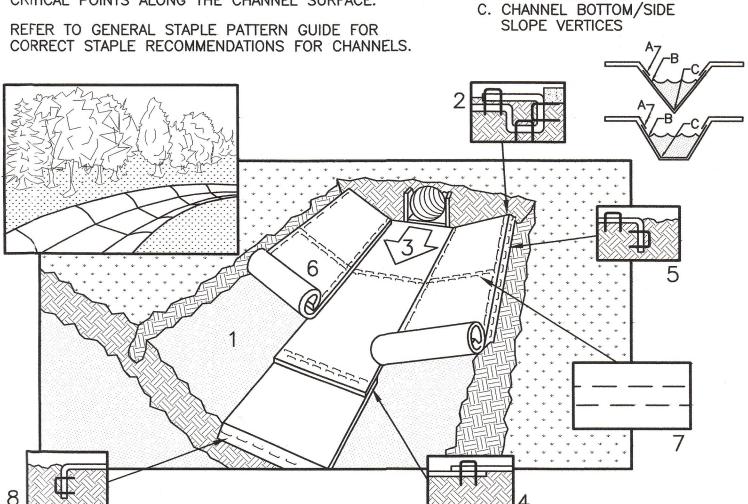

- 1. PREPARE SOIL BEFORE INSTALLING BLANKETS, INCLUDING APPLICATION OF LIME, FERTILIZER, AND SEED.
- 2. BEGIN AT THE TOP OF THE CHANNEL BY ANCHORING THE BLANKET IN A 6" DEEP x 6" WIDE TRENCH. BACKFILL AND COMPACT THE TRENCH AFTER STAPLING.
- 3. ROLL CENTER BLANKET IN DIRECTION OF WATER FLOW ON BOTTOM OF CHANNEL.
- 4. PLACE BLANKETS END OVER END (SHINGLE STYLE) WITH A 6" OVERLAP. USE A DOUBLE ROW OF STAGGERED STAPLES 4" APART TO SECURE BLANKETS.
- 5. FULL LENGTH EDGE OF BLANKETS AT TOP OF SIDE SLOPES MUST BE ANCHORED IN 6" DEEP x6" WIDE TRENCH. BACKFILL AND COMPACT THE TRENCH AFTER STAPLING.
- 6. BLANKETS ON SIDE SLOPES MUST BE OVERLAPPED 4" OVER THE CENTER BLANKET AND STAPLED (2" FOR C350 MATTING).
- 7. IN HIGH FLOW CHANNEL APPLICATIONS, A STAPLE CHECK SLOT IS RECOMMENDED AT 30'-40' INTERVALS. USE A ROW OF STAPLES 4" APART OVER ENTIRE WIDTH OF THE CHANNEL. PLACE A SECOND ROW 4" BELOW THE FIRST ROW IN A STAGGERED PATTERN.
- 8. THE TERMINAL END OF THE BLANKETS MUST BE ANCHORED IN A 6" DEEP X 6" WIDE TRENCH. BACKFILL AND COMPACT THE TRENCH AFTER STAPLING.

# EROSION CONTROL BLANKET (CHANNEL INSTALLATION)

Onsultants FIELD BOOK # DESIGN: PBB PROJ

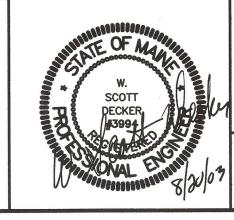

SYTDe	esign (	cons	ultants
CIVIL	ENGINEERS	& LAN	D SURVEYORS

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2456 LAFAYETTE ROAD, PORTSMOUTH, NH 03801

FELD BOOK #	DESIGN: PBB	PROJECT: PORTLAND SPORTS CENTER				
FIELD BOOK PAGE	DRAWN: PBB		512 WARREN AVENUE, PORTLAND, MAINE			
FLAT FILE DEX NUMBER	CHKD: SWD	ER	ROSION AND SEDIMENTATION CONTROL NOTES & DETAILS			
PROJECT DIR.	DATE: APRIL 2003	PROJ. NO.	03-213-00			
RAWING NAME	SCALE: AS NOTED	DWG. NO.	5 OFTY 70F PORTLAND C-300			

REVISED FOR CITY OF PORTLAND SITE PLAN APPROVAL AND CONSTRUCTION PBB | WSD | WSD PBB | WSD | WSD 7-18-03 ISSUED FOR CONSTRUCTION REVISED AND RESUBMITTED FOR CITY OF PORTLAND SITE PLAN REVIEW PBB | WSD | WSD PBB | WSD | WSD ISSUED FOR PRICING B 5-20-03 CITY OF PORTLAND SITE PLAN REVIEW PBB | WSD | WSD A 4-2-03 BY CHKD APPE REV. DATE STATUS

3 8-19-03 REVISED FOR CITY OF PORTLAND SITE PLAN APPROVAL AND CONSTRUCTION

Subject to Dept. Conditions
Date of Approval: 7/32/03

NO.

