

© 2015 RYAN SENATORE ARCHITECTURE

BATTERIES AND BULBS FIT-UP
 BRIGHTON AVENUE
 PORTLAND, MAINE



RYAN SENATORE ARCHITECTURE
 565 CONGRESS STREET
 PORTLAND, MAINE 04101
 207-650-6414
 senatorearchitecture.com

CONSULTANTS:

REVISIONS:

DATE: DECEMBER 22, 2015

PROJECT No.

DRAWN BY:

CHECKED BY: RJS

SCALE: AS NOTED

SHEET TITLE:

LIFE SAFETY PLAN
 DOOR SCHEDULE

A1-1

DOOR SCHEDULE


NOTES:
 1. EXTERIOR DOOR JAMBS TO BE SEALED TO THEIR ROUGH OPENINGS USING LOW EXPANDING FOAM, BACKER ROD OR CAULKING.
 2. ALL EXTERIOR DOORS TO BE WEATHER STRIPPED

GLAZING SCHEDULE	
KEY	GLAZING TYPE
GL-1	INSULATED CLEAR TEMPERED GLAZING
GL-2	FIRE RATED INSULATED GLAZING
GL-3	CLEAR TEMPERED GLASS
GL-4	CLEAR INSULATED TEMPERED GLASS
GL-5	FIRE RATED GLAZING

1 DOOR TYPES
 3/4" = 1'-0"

DOOR SCHEDULE														
DOOR NO.	DOOR				FRAME					GENERAL				
	TYPE	SIZE	MATERIAL		INSULATED	TYPE	MATERIAL	THRESHOLD	DETAILS	CLOSER	FIRE RATING (MINUTES)	HARDWARE KEY	REMARKS	
	WIDTH	HEIGHT	THICKNESS					HEAD	JAMB	SILL				
100.1	C	3'-0"	7'-0"	-	STL	CLR	-	STL	-	-	-	Y	-	EASY SWING HIGH IMPACT DOUBLE ACTION TRAFFIC DOOR. BALANCE CLOSER. REFER TO SPECIFICATION
104.1	B	3'-0"	7'-0"	1-3/4"	WD	PTD	-	STL	-	-	-	-	-	
106.1	A	4'-0"	7'-0"	1-3/4"	STL	PTD	Y	2	STL	AL	-	-	Y	THERMALLY BROKEN EXTERIOR DOOR AND FRAME, WITH PANIC HARDWARE, WELDED STEEL FRAME WITH 4" HEAD

2 REFLECTED CEILING PLAN
 3/4" = 1'-0"

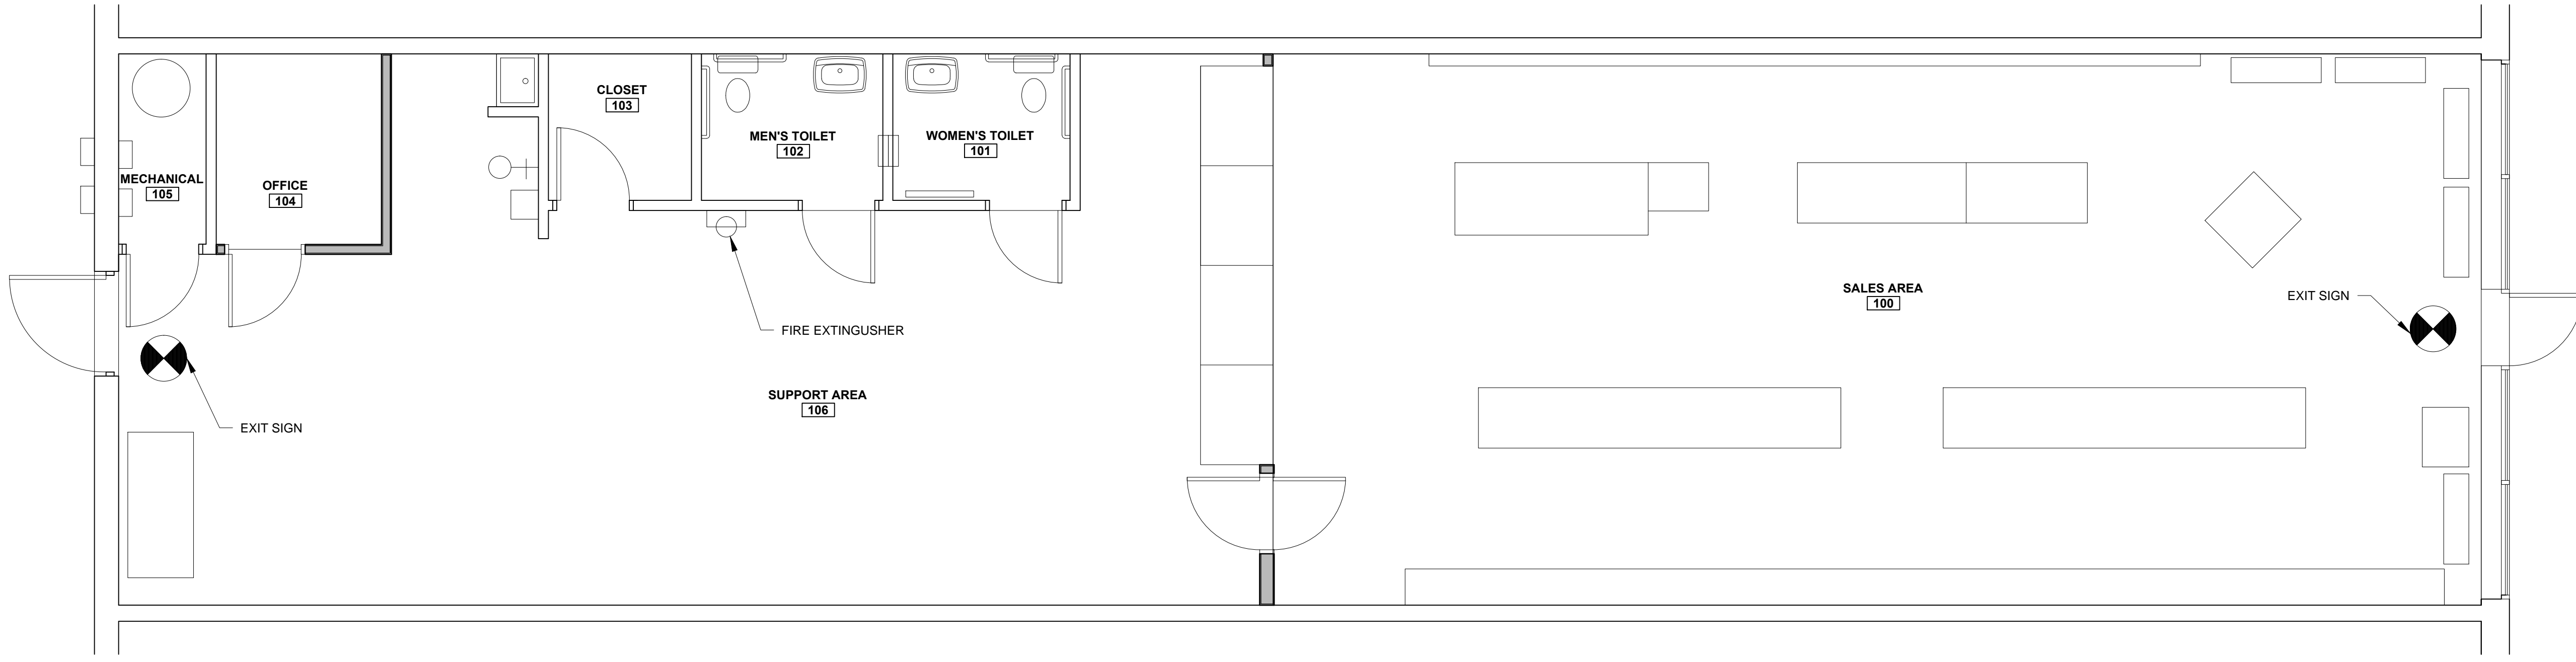

1 LIFE SAFETY PLAN
 3/4" = 1'-0"